

1 FIRE COMPARTMENT - GROUND FLOOR



FIRE COMPARTMENT LEGEND: GROUND FLOOR

FIRE COMPARTMENT 1
FIRE COMPARTMENT 2
FIRE COMPARTMENT 3
FIRE COMPARTMENT 4
FIRE COMPARTMENT 5
FIRE COMPARTMENT 6
LEVEL 1
FIRE COMPARTMENT 7
FIRE COMPARTMENT 8
LEVEL 2
FIRE COMPARTMENT 9
FIRE COMPARTMENT 10
WALLS TO ACHIEVE FRL 120/120/120
WALLS TO ACHIEVE FRL 90/90/90 or -/90/90

WALLS TO ACHIEVE FRL 60/60/60 or -/60/60

WALLS TO ACHIEVE FRL 60/60/60 in SPANDREL ZONE _____

DISCLAIMER:

ALL DIMENSIONS SHOWN ON DRAWINGS ARE IN MILLIMETRES UNLESS OTHERWISE NOTED AND SHOULD BE VERIFIED ON SITE BEFORE COMMENCING BUILDING WORKS. DO NOT SCALE THIS DRAWING. THESE ARCHITECTURAL DRAWINGS ARE TO BE READ IN CONJUNCTION WITH THE BUILDING SPECIFICATION, TECHNICAL SHEETS AND CONSULTANT DRAWINGS. ANY DISCREPANCIES ARE TO BE REFERRED TO THE PROJECT ARCHITECT FOR CLARIFICATION PRIOR TO WORK COMMENCING.

Issue					
No.	Date	Description	Chkd		
1	14.09.2023	Issue for 100% Design Development	EK		
А	06.10.2023	Issue for Construction	EK		
В	04.12.2023	Issue for Construction	EK		
С	21.12.2023	Issue for Draft CC4	EK		
D	22.01.2024	Issue for CC4	EK		

Architect **NBRS**

61 2 9922 2344 nbrsarchitecture.com Any form of replication of this drawing in full or in part without the written permission of NBRS+PARTNERS Pty Ltd constitutes an infringement of the copyright. Nominated Architect: Andrew Duffin NSW 5602

ABN 16 002 247 565 NBRS & Partners Pty Ltd VIC 51197 Project

Melonba Education Campus


Cnr Elara Boulevard and Kaluta Avenue, Melonba. Lot 30 DP 1237735 for

SINSW

Drawing Title

OVERALL GF FIRE COMPARTMENT PLAN

FOR CONSTRUCTION

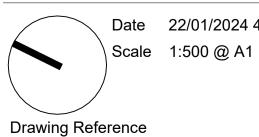

Date 22/01/2024 4:54:21 PM



© 2024

MM-NBRS-00-ZZ-DR-A-0240 D 0 5m 10m 15m 20m 25m 30m 35m 40m 1:500




56.28 No. 23000435 / 4

CROWN DEVELOPMENT APPROVED PLANS

I certify that the work completed in accordance with these plans and specifications will comply with the technical provisions of the State's building laws and the Environmental Planning and Assessment Act 1979 No. 203

MBC Corporate Accreditation RBC00029 22 Feb 2024

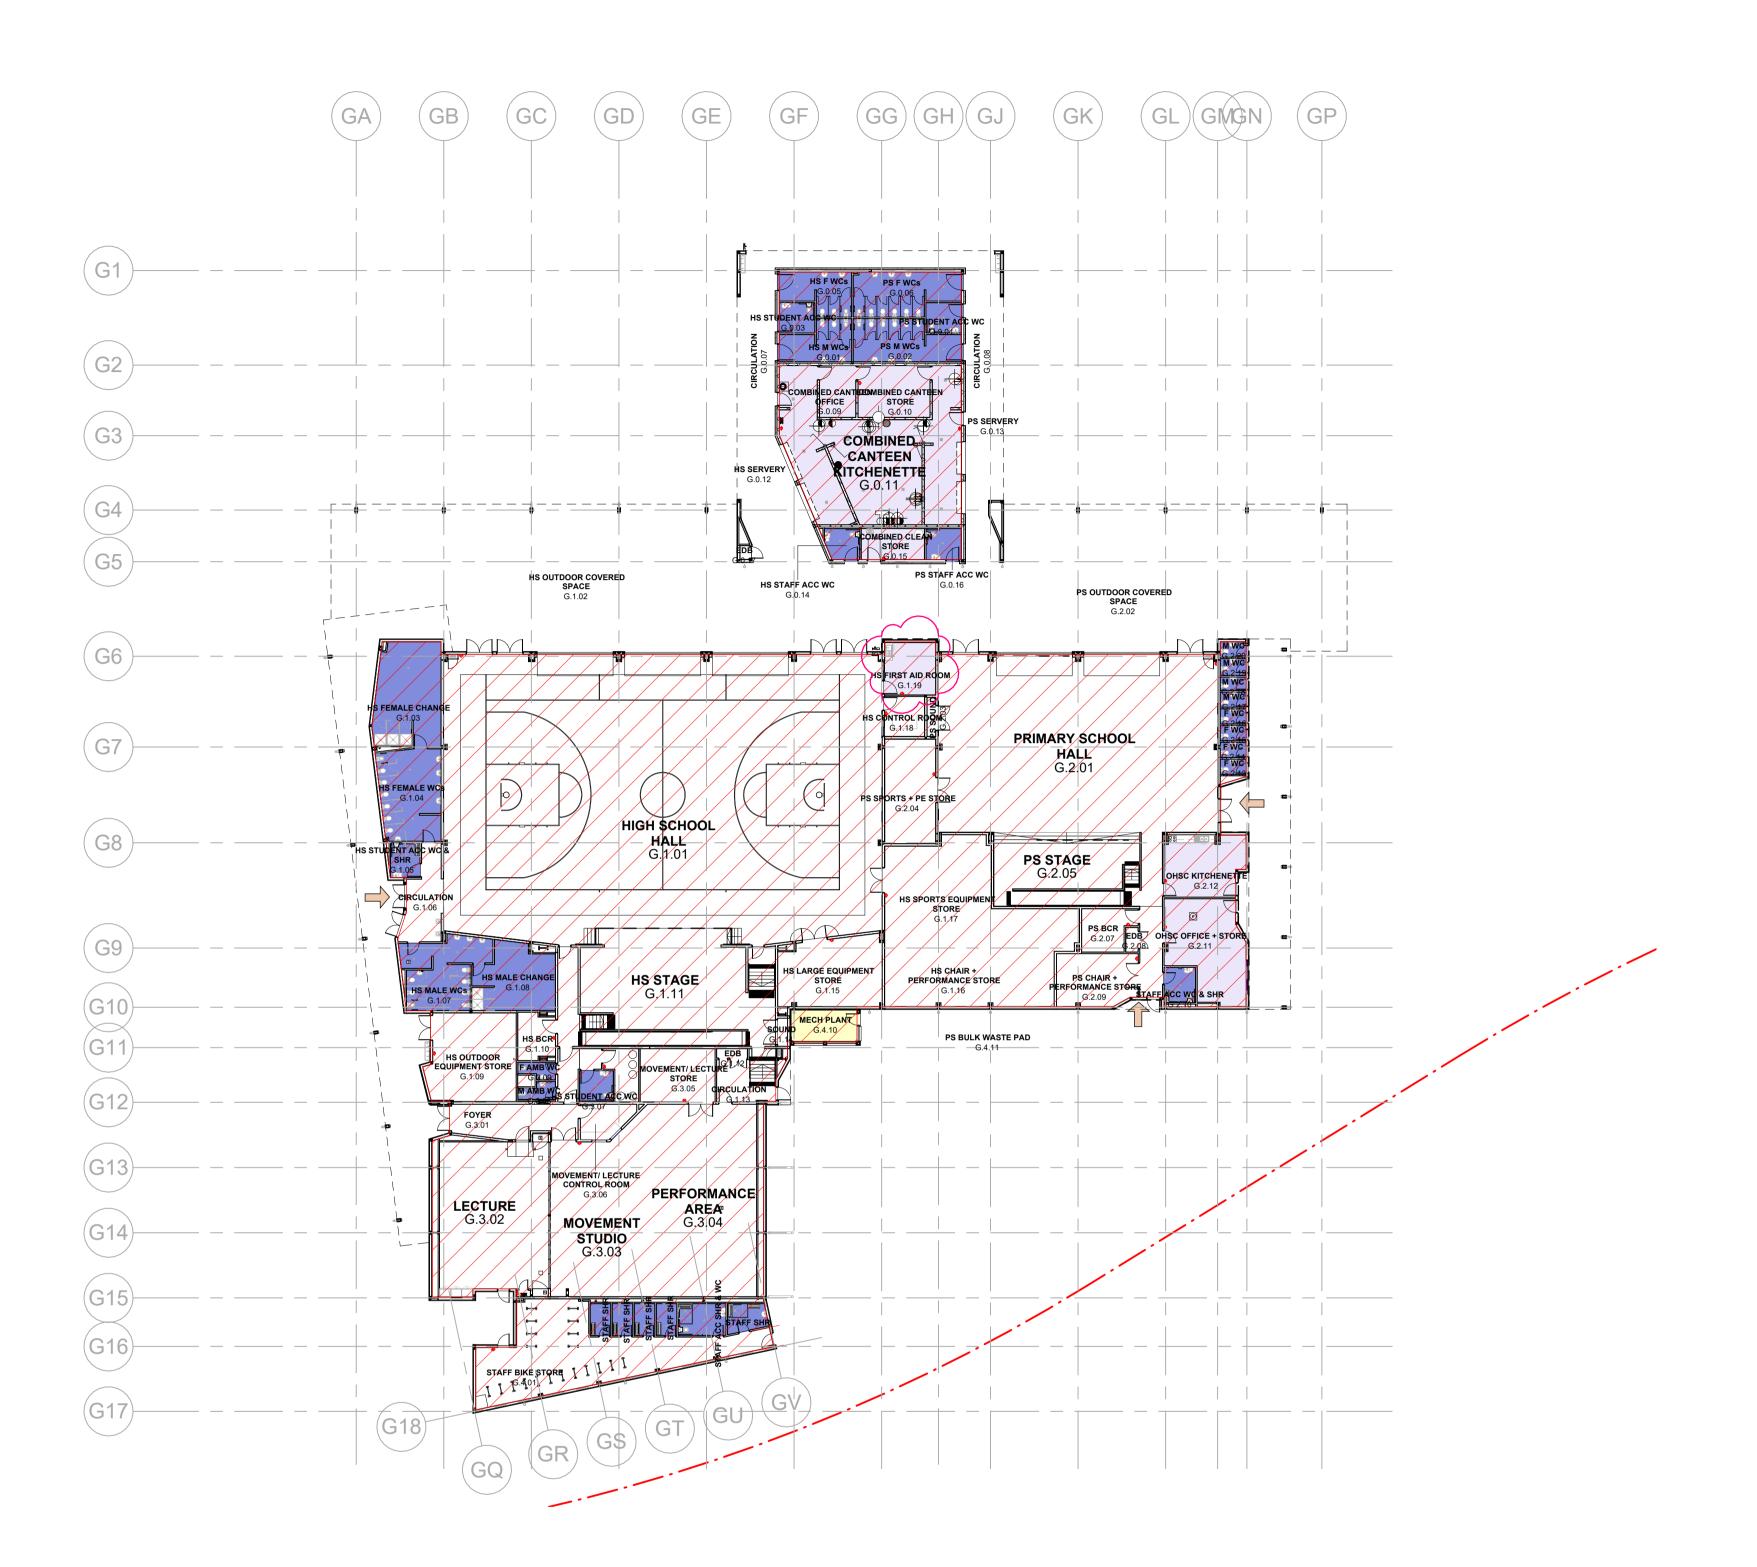



....

WPM02 WATERPROOFING MEMBRANE -RETAINING WALLS AND LIFTS - TORCH ON

WPM01 WATERPROOFING MEMBRANE -SLAB UNDERLAY - VAPOUR BARRIER

WPM04 WATERPROOFING MEMBRANE -WET AREAS WITH TILED FINISH

UNDER SCREED WITH CONCRETE FINISH

WPM05 WATERPROOFING MEMBRANE -

TRAFFICABLE + UV RESISTANT TOP OF SLAB ROLL ON APPLICATION

WPM09 - MOISTURE BARRIER UNDER VINYL FLOOR FINISH

WPM10 - CHEMICAL RESISTANT SLAB SEALER FINISH TOP OF SLAB ROLL ON APPLICATION

GENERAL NOTES:

SUBSTRATE TO BE TESTED AND MOISTURE CONTENT CONFIRMED AS ACCEPTABLE PRIOR TO INSTALLATION OF FLOOR FINISHES



LOCATION PLAN

GENERAL NOTES

ROOM TAGS REFERENCE NEW HUB EFSG NUMBERS. REFER TO THE AREA SCHEDULES (0000 SERIES) TO RECONCILE EFSG WEBSITE INFORMATION.

PROVIDE GALVANISED SURFACE MOUNTED CONDUIT TO LIGHT FITTINGS THAT ARE MOUNTED TO THE UNDERSIDE OF CONCRETE SLAB AND UNDER CEILING TYPE CLG16 & CLG11.

REFER TO MECHANICAL & ELECTRICAL SERVICES DOCUMENTATION FOR THE QUANTITY & TYPES OF FITTINGS & FIXTURES. ALL EXPOSED STEEL TO EXTERNAL AREAS TO BE HOT DIPPED GALVANISED.

REFER TO CIVIL AND LANDSCAPE ARCH DOCUMENTS FOR EXTERNAL WORKS.

DISCLAIMER

ALL DIMENSIONS SHOWN ON DRAWINGS ARE IN MILLIMETRES UNLESS OTHERWISE NOTED AND SHOULD BE VERIFIED ON SITE BEFORE COMMENCING BUILDING WORKS. DO NOT SCALE THIS DRAWING. THESE ARCHITECTURAL DRAWINGS ARE TO BE READ IN CONJUNCTION WITH THE BUILDING SPECIFICATION, TECHNICAL SHEETS AND CONSULTANT DRAWINGS. ANY DISCREPANCIES ARE TO BE REFERRED TO THE PROJECT ARCHITECT FOR CLARIFICATION PRIOR TO WORK COMMENCING.

Issue

lssu	е		
No.	Date	Description	Chkd
1	17.08.2023	Issue for 80% Design Development	EK
2	14.09.2023	Issue for 100% Design Development	EK
3	11.10.2023	Waterproofing Update	EK
4	23.11.2023	Issue for Coordination	DJ
5	21.12.2023	Issue for Draft CC4	TP
А	22.01.2024	Issue for CC4	DJ



Sydney 61 2 9922 2344 nbrsarchitecture.com Any form of replication of this drawing in full or in part without the written permission of NBRS+PARTNERS Pty Ltd constitutes an infringement of the copyright.

Nominated Architect:© 2023Andrew Duffin NSW 5602© 2023NBRS & Partners Pty Ltd VIC 51197ABN 16 002 247 565Project

Melonba Education Campus

Cnr Elara Boulevard and Kaluta Avenue, Melonba. Lot 30 DP 1237735 for


SINSW


at

Drawing Title


OVERALL GF WATERPROOFING PLAN - WEST ZONE

FOR CONSTRUCTION

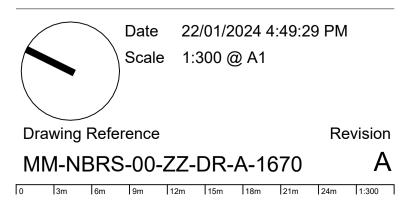

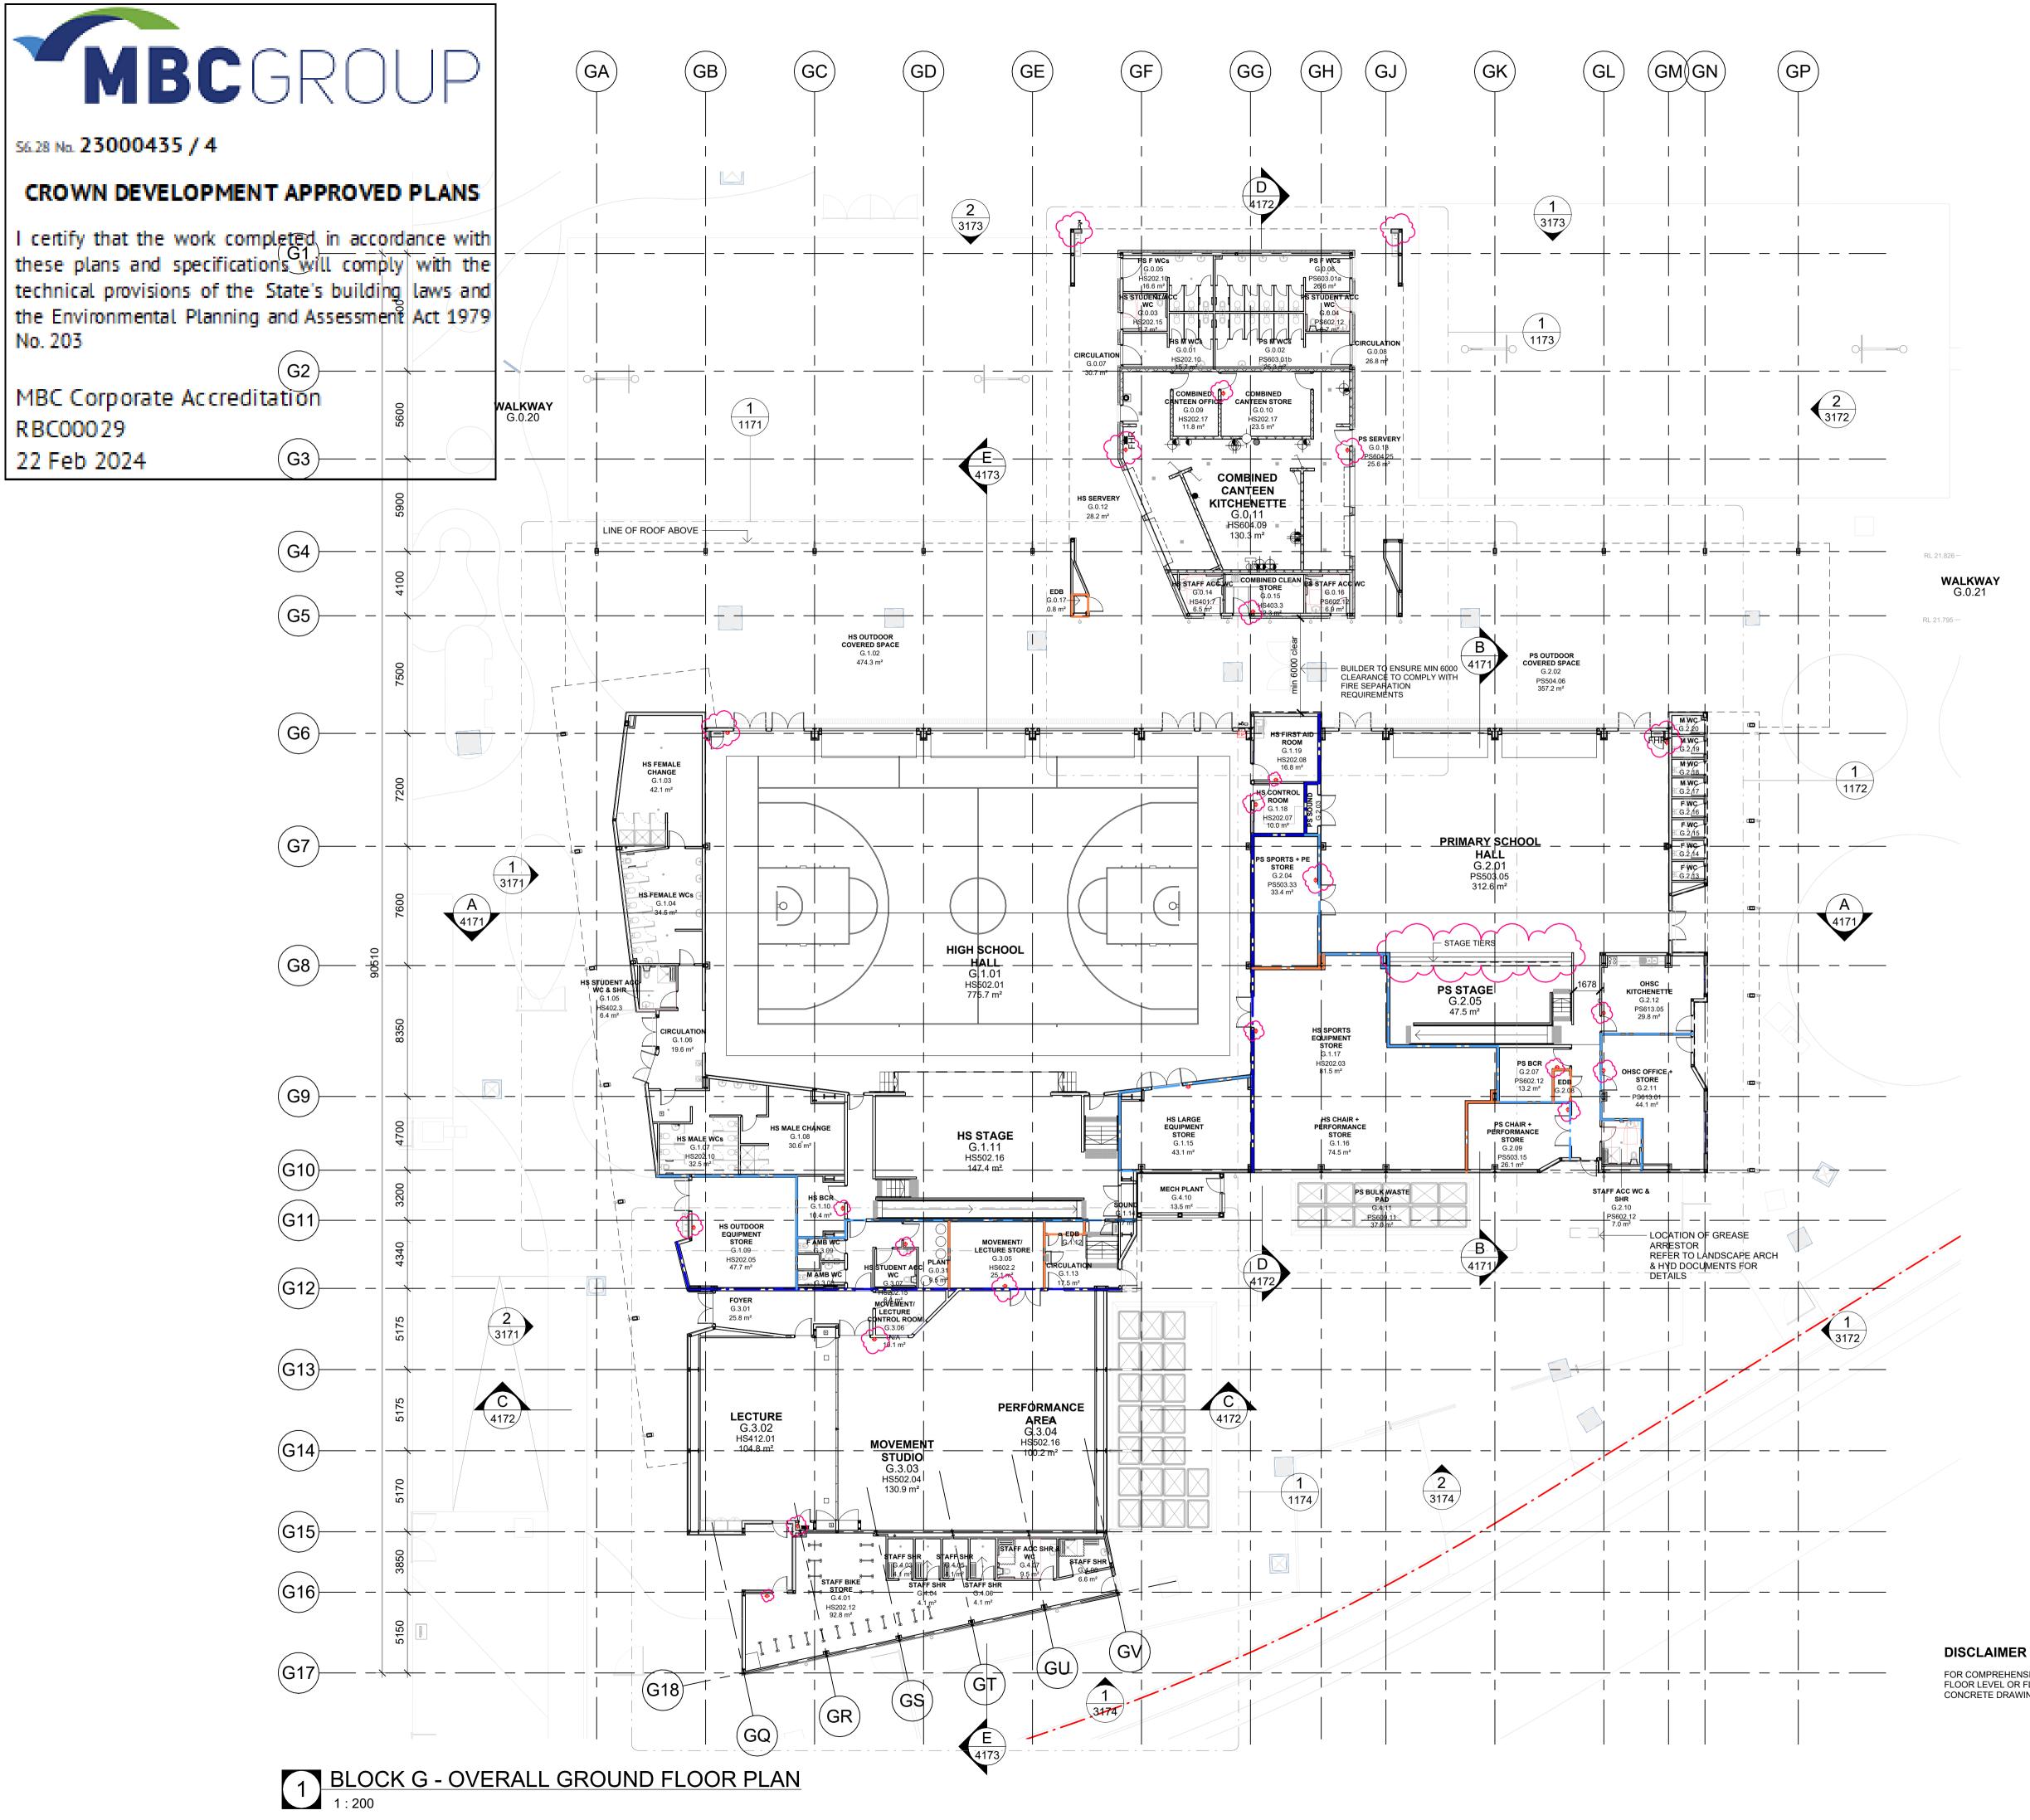



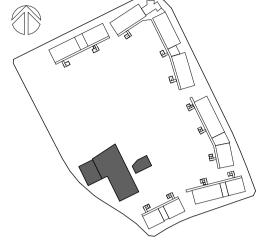

LEGEND FRL WALLS

FRL 60/60/60 (EFSG) TO FRL CEILING FRL 90/90/90 TO U/S ROOF

FRL 60/60/60 (NCC) TO U/S ROOF

GENERAL NOTES

ROOM TAGS REFERENCE NEW HUB EFSG NUMBERS. REFER TO THE AREA SCHEDULES (0000 SERIES) TO RECONCILE EFSG WEBSITE INFORMATION.

PROVIDE GALVANISED SURFACE MOUNTED CONDUIT TO LIGHT FITTINGS THAT ARE MOUNTED TO THE UNDERSIDE OF CONCRETE SLAB AND UNDER CEILING TYPE CLG16 & CLG11.

REFER TO MECHANICAL & ELECTRICAL SERVICES DOCUMENTATION FOR THE QUANTITY & TYPES OF FITTINGS & FIXTURES.

ALL EXPOSED STEEL TO EXTERNAL AREAS TO BE HOT DIPPED GALVANISED.

REFER TO CIVIL AND LANDSCAPE ARCH DOCUMENTS FOR EXTERNAL WORKS.

DISCLAIMER

Iss

ALL DIMENSIONS SHOWN ON DRAWINGS ARE IN MILLIMETRES UNLESS OTHERWISE NOTED AND SHOULD BE VERIFIED ON SITE BEFORE COMMENCING BUILDING WORKS. DO NOT SCALE THIS DRAWING. THESE ARCHITECTURAL DRAWINGS ARE TO BE READ IN CONJUNCTION WITH THE BUILDING SPECIFICATION, TECHNICAL SHEETS AND CONSULTANT DRAWINGS. ANY DISCREPANCIES ARE TO BE REFERRED TO THE PROJECT ARCHITECT FOR CLARIFICATION PRIOR TO WORK COMMENCING.

u	е	
	Date	Description
	14.09.2023	Issue for 10
	20.09.2023	Issue with [

Bato	Beeenpaen	onna
14.09.2023	Issue for 100% Design Development	EK
20.09.2023	Issue with DDA Updates	EK
02.11.2023	Issue for Coordination	DJ
10.11.2023	Issue for Coordination	DJ
23.11.2023	Issue for Coordination	DJ
04.12.2023	Issue for Coordination	DJ
21.12.2023	Issue for Draft CC4	TP
18.01.2024	Issue for CC4	DJ

Chkd



NBRS 61 2 9922 2344

nbrsarchitecture.com Any form of replication of this drawing in full or in part without the written permission of NBRS+PARTNERS Pty Ltd constitutes an infringement of the copyright. Nominated Architect: Andrew Duffin NSW 5602 © 2023 ABN 16 002 247 565 NBRS & Partners Pty Ltd VIC 51197

Project

Melonba Education Campus

Cnr Elara Boulevard and Kaluta Avenue, Melonba. Lot 30 DP 1237735 for


SINSW


Drawing Title

BLOCK G - OVERALL GROUND FLOOR PLAN

FOR COMPREHENSIVE INFORMATION ON STRUCTURAL FINISH FLOOR LEVEL OR FLOOR FINISH TYPE REFER TO ARCHITECTURAL CONCRETE DRAWINGS OR FLOOR FINISH DRAWINGS.

FOR CONSTRUCTION

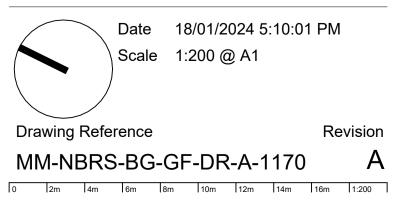

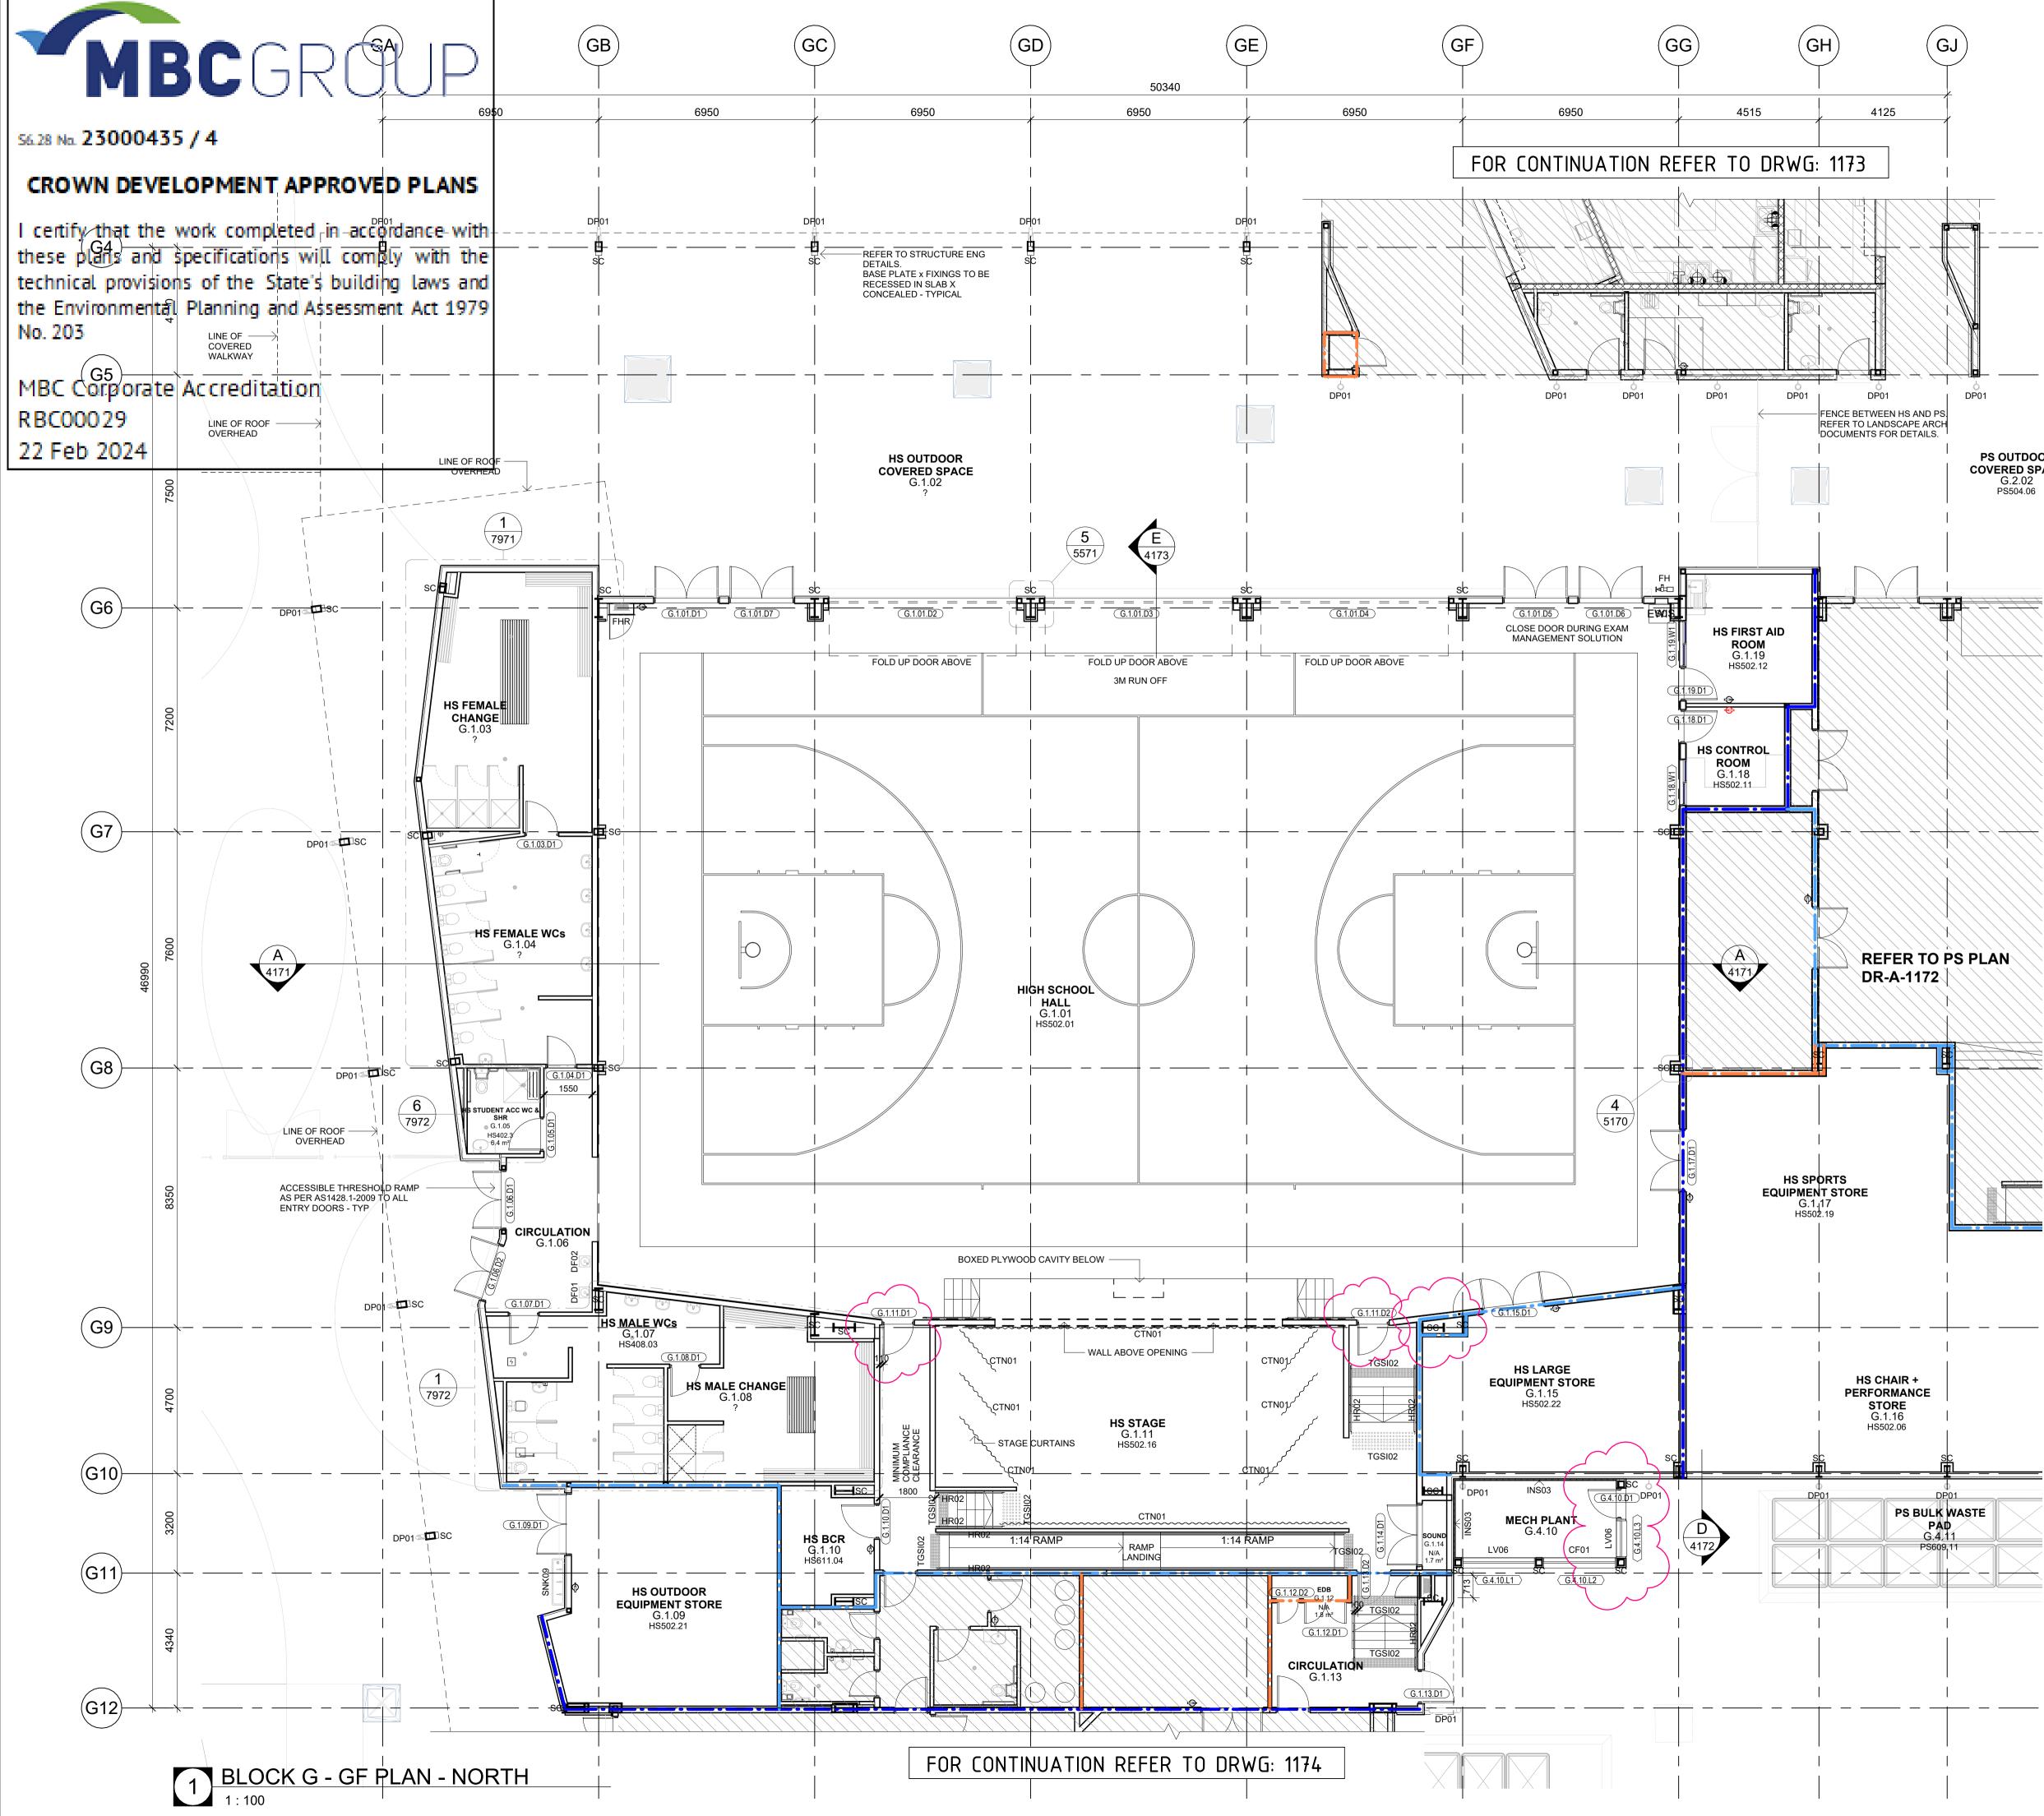





OR




S

G

172



LOCATION PLAN

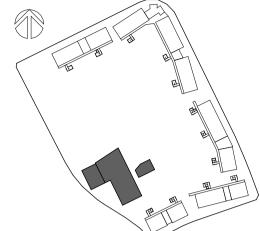

DESCRIPTION
CONCRETE FL - BROOMED FINISH
DRINKING FOUNTAIN
DRINKING FOUNTAIN - ACCESSIBLE
DOWNPIPE 150 OD WITH 2100H GAL CHS SLEEVE
FIRE HYDRANT - REFER TO ENG. DOCUMENTATION
FIRE HOSE REEL - REFER TO ENG. DOCUMENTATION
DOUBLE HANDRAIL FIXED TO WALL OR BALUSTRADE
INSULATION - ACOUSTIC BLOCKS
ACOUSTIC LOUVRES - 300
STEEL COLUMN - REFER TO ENG. DOCUMENTATION
SINK TYPE 08 - BUBBLER
TACTILE GROUND SURFACE INDICATOR

DISCLAIMER

FOR COMPREHENSIVE INFORMATION ON STRUCTURAL FINISH FLOOR LEVEL OR FLOOR FINISH TYPE REFER TO ARCHITECTURAL CONCRETE DRAWINGS OR FLOOR FINISH DRAWINGS.

GENERAL NOTES

ROOM TAGS REFERENCE NEW HUB EFSG NUMBERS. REFER TO THE AREA SCHEDULES (0000 SERIES) TO RECONCILE EFSG WEBSITE INFORMATION.

PROVIDE GALVANISED SURFACE MOUNTED CONDUIT TO LIGHT FITTINGS THAT ARE MOUNTED TO THE UNDERSIDE OF CONCRETE SLAB AND UNDER CEILING TYPE CLG16 & CLG11.

REFER TO MECHANICAL & ELECTRICAL SERVICES DOCUMENTATION FOR THE QUANTITY & TYPES OF FITTINGS & FIXTURES.

ALL EXPOSED STEEL TO EXTERNAL AREAS TO BE HOT DIPPED GALVANISED.

REFER TO CIVIL AND LANDSCAPE ARCH DOCUMENTS FOR EXTERNAL



LEGEND FRL WALLS

FRL 60/60/60 (EFSG) TO FRL CEILING FRL 90/90/90 TO U/S ROOF FRL 60/60/60 (NCC) TO U/S ROOI

DISCLAIMER

ALL DIMENSIONS SHOWN ON DRAWINGS ARE IN MILLIMETRES UNLESS OTHERWISE NOTED AND SHOULD BE VERIFIED ON SITE BEFORE COMMENCING BUILDING WORKS. DO NOT SCALE THIS DRAWING. THESE ARCHITECTURAL DRAWINGS ARE TO BE READ IN CONJUNCTION WITH THE BUILDING SPECIFICATION, TECHNICAL SHEETS AND CONSULTANT DRAWINGS. ANY DISCREPANCIES ARE TO BE REFERRED TO THE PROJECT ARCHITECT FOR CLARIFICATION PRIOR TO WORK COMMENCING.

Issue

issu	ISSUE				
No.	Date	Description	Chkd		
4	02.11.2023	Issue for Coordination	DJ		
5	10.11.2023	Issue for Coordination	DJ		
6	23.11.2023	Issue for Coordination	DJ		
7	04.12.2023	Issue for Coordination	DJ		
8	15.12.2023	Issue for Coordination	TP		
9	21.12.2023	Issue for Draft CC4	TP		
А	18.01.2024	Issue for CC4	DJ		
В	25.01.2024	Issue for CC4			

Architect



Any form of replication of this drawing in full or in part without the written permission of NBRS+PARTNERS Pty Ltd constitutes an infringement of the copyright. Nominated Architect: Andrew Duffin NSW 5602 © 2023 ABN 16 002 247 565 NBRS & Partners Pty Ltd VIC 51197 Project

nbrsarchitecture.com

Melonba Education Campus


Cnr Elara Boulevard and Kaluta Avenue, Melonba. Lot 30 DP 1237735 for


SINSW

Drawing Title


BLOCK G - GF PLAN - NORTH



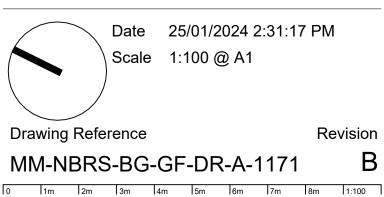

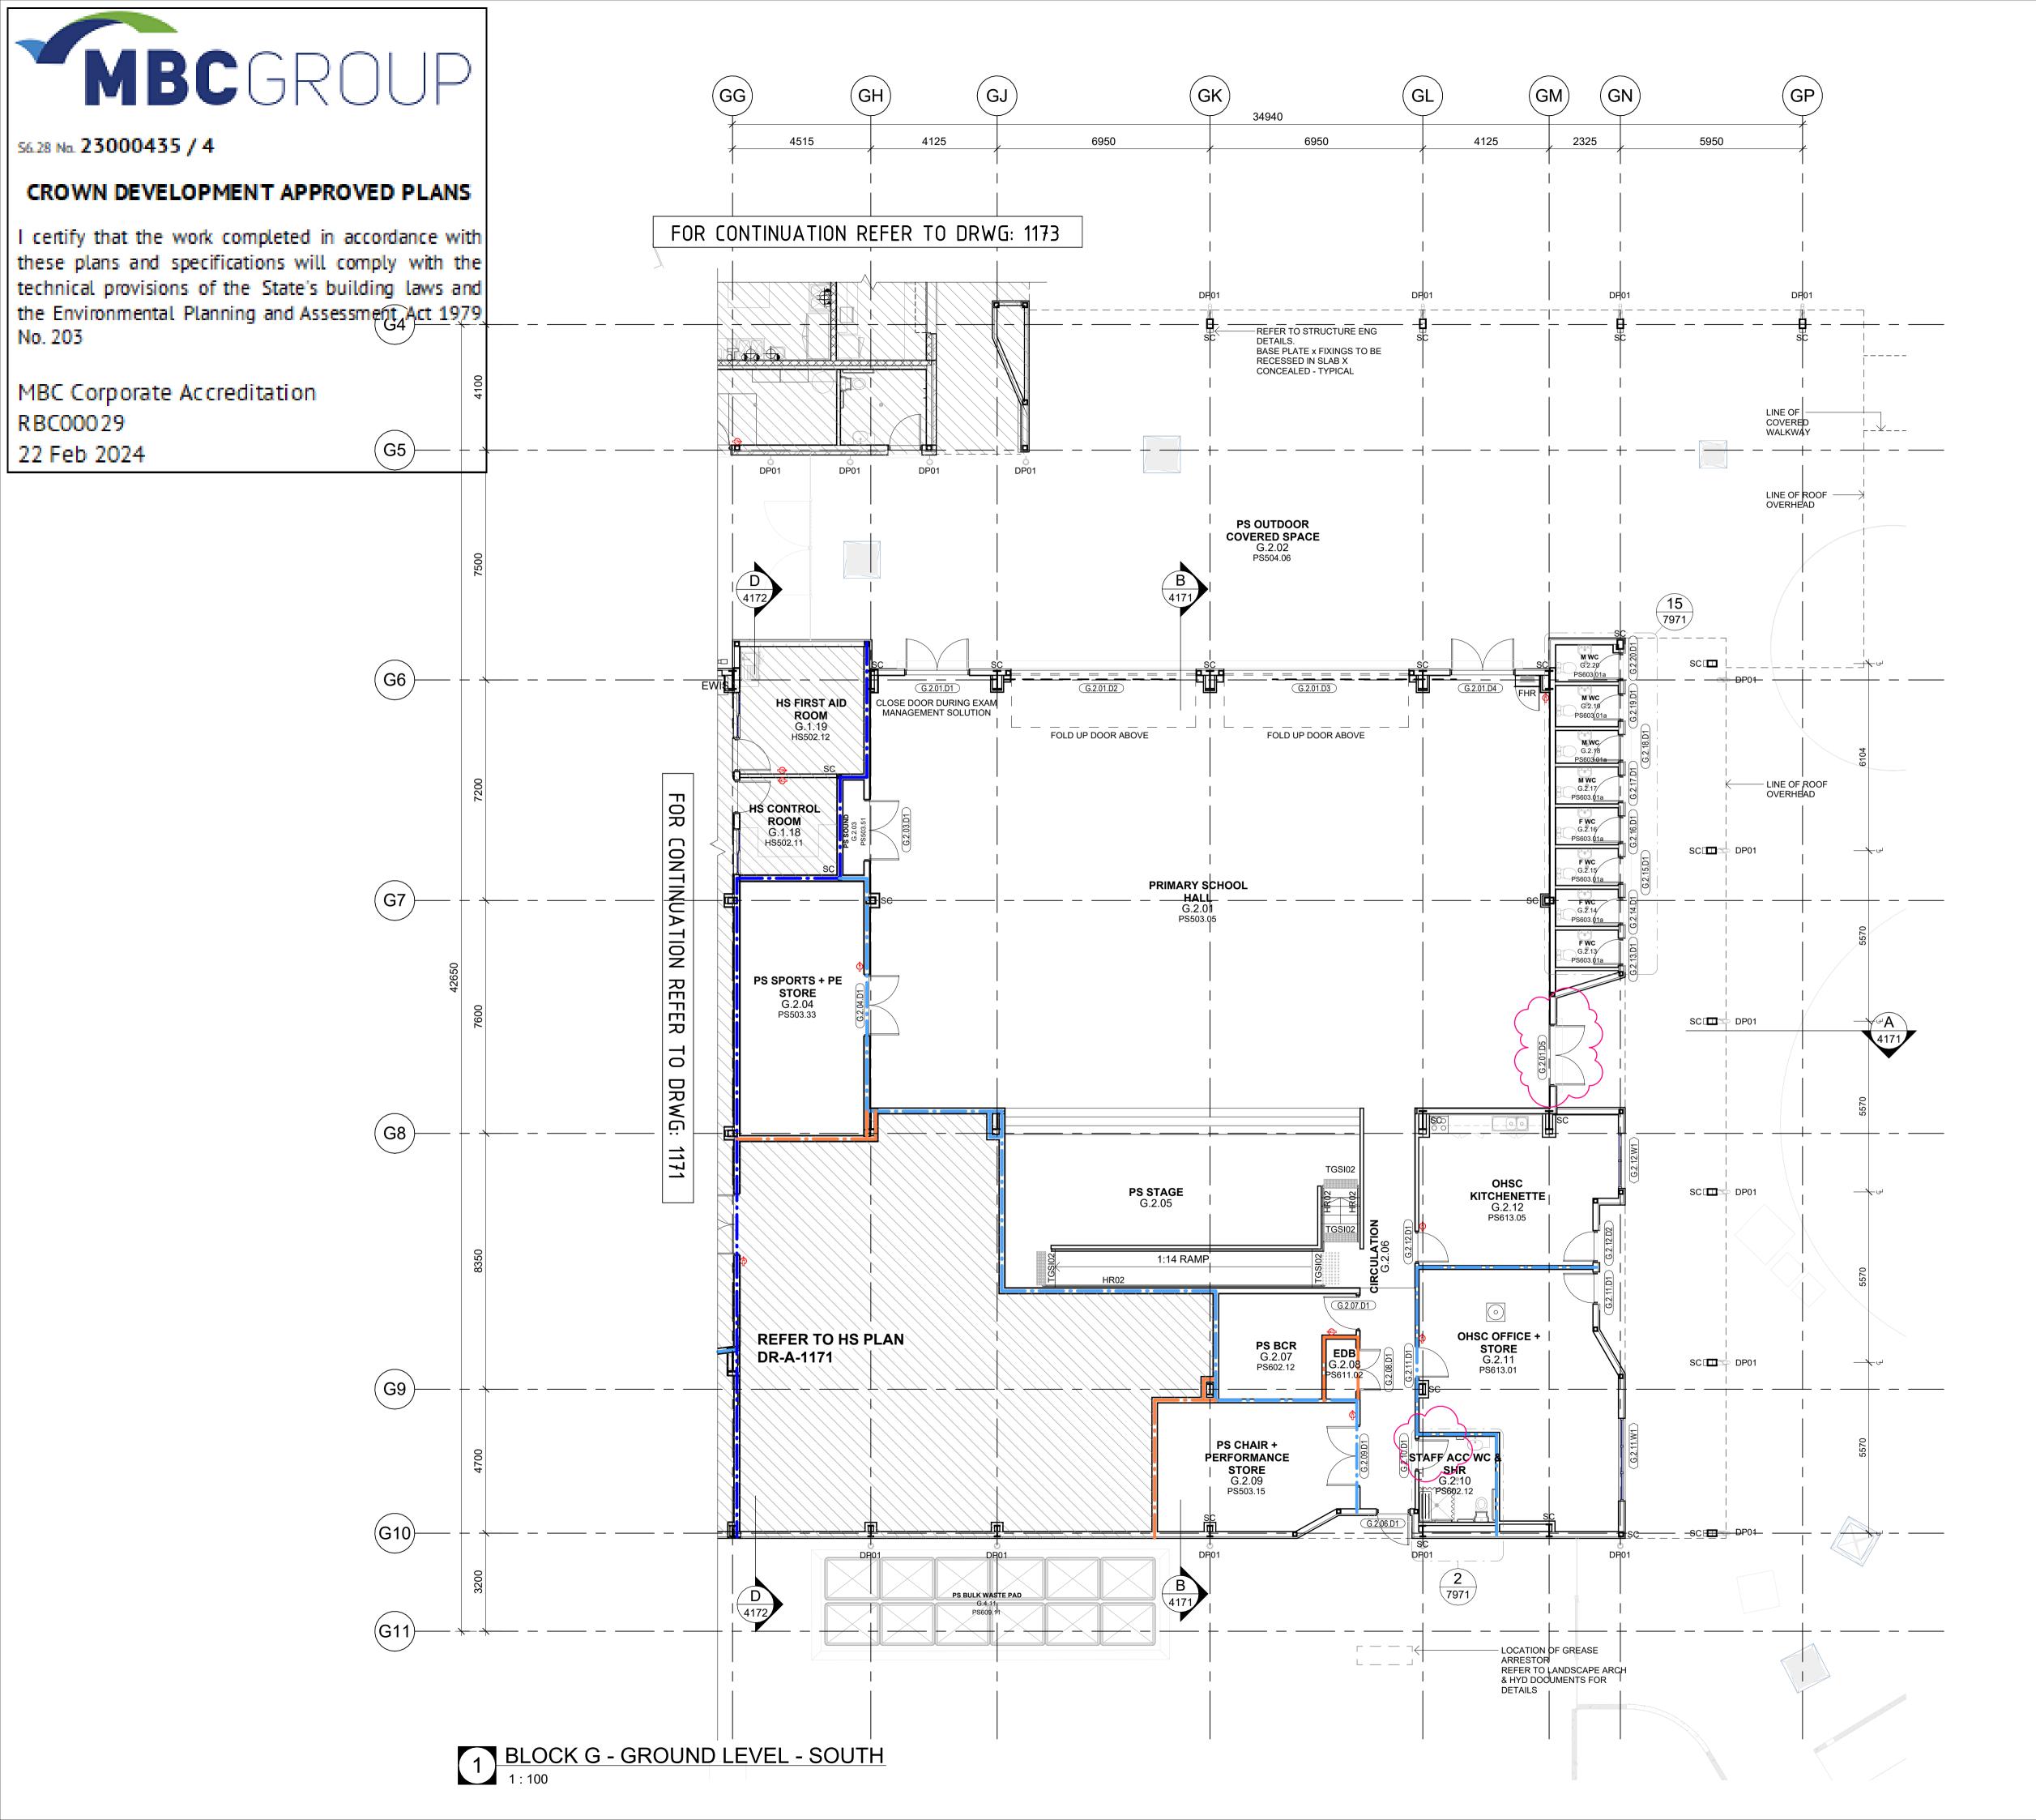



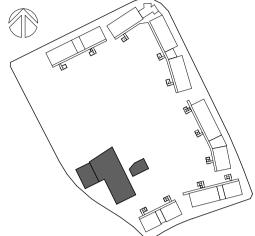

CODE **DP01** FHR

HR02

TGSI02

SC

DESCRIPTION

DOWNPIPE 150 OD WITH 2100H GAL CHS SLEEVE FIRE HOSE REEL - REFER TO ENG. DOCUMENTATION DOUBLE HANDRAIL FIXED TO WALL OR BALUSTRADE STEEL COLUMN - REFER TO ENG. DOCUMENTATION TACTILE GROUND SURFACE INDICATOR

DISCLAIMER

FOR COMPREHENSIVE INFORMATION ON STRUCTURAL FINISH FLOOR LEVEL OR FLOOR FINISH TYPE REFER TO ARCHITECTURAL CONCRETE DRAWINGS OR FLOOR FINISH DRAWINGS.

GENERAL NOTES

ROOM TAGS REFERENCE NEW HUB EFSG NUMBERS. REFER TO THE AREA SCHEDULES (0000 SERIES) TO RECONCILE EFSG WEBSITE INFORMATION.

PROVIDE GALVANISED SURFACE MOUNTED CONDUIT TO LIGHT FITTINGS THAT ARE MOUNTED TO THE UNDERSIDE OF CONCRETE SLAB AND UNDER CEILING TYPE CLG16 & CLG11.

REFER TO MECHANICAL & ELECTRICAL SERVICES DOCUMENTATION FOR THE QUANTITY & TYPES OF FITTINGS & FIXTURES.

ALL EXPOSED STEEL TO EXTERNAL AREAS TO BE HOT DIPPED GALVANISED.

REFER TO CIVIL AND LANDSCAPE ARCH DOCUMENTS FOR EXTERNAL LEGEND FRL WALLS



FRL 60/60/60 (EFSG) TO FRL CEILING FRL 90/90/90 TO U/S ROOF FRL 60/60/60 (NCC) TO U/S ROOF

DISCLAIMER:

ALL DIMENSIONS SHOWN ON DRAWINGS ARE IN MILLIMETRES UNLESS OTHERWISE NOTED AND SHOULD BE VERIFIED ON SITE BEFORE COMMENCING BUILDING WORKS. DO NOT SCALE THIS DRAWING. THESE ARCHITECTURAL DRAWINGS ARE TO BE READ IN CONJUNCTION WITH THE BUILDING SPECIFICATION, TECHNICAL SHEETS AND CONSULTANT DRAWINGS. ANY DISCREPANCIES ARE TO BE REFERRED TO THE PROJECT ARCHITECT FOR CLARIFICATION PRIOR TO WORK COMMENCING.

ssue	

No.	, Date	Description	Chkd
INO.	Date	Description	Спка
2	14.09.2023	Issue for 100% Design Development	EK
3	02.11.2023	Issue for Coordination	DJ
4	10.11.2023	Issue for Coordination	DJ
5	23.11.2023	Issue for Coordination	DJ
6	04.12.2023	Issue for Coordination	DJ
7	21.12.2023	Issue for Draft CC4	TP
А	18.01.2024	Issue for CC4	DJ
В	25.01.2024	Issue for CC4	







Andrew Duffin NSW 5602 © 2023 ABN 16 002 247 565 NBRS & Partners Pty Ltd VIC 51197 Project

Melonba Education Campus

Cnr Elara Boulevard and Kaluta Avenue, Melonba. Lot 30 DP 1237735 for

SINSW

Drawing Title

BLOCK G - GF PLAN - SOUTH



Date 25/01/2024 2:31:25 PM Scale 1:100 @ A1 Drawing Reference Revision MM-NBRS-BG-GF-DR-A-1172 В 0 1m 2m 3m 4m 5m 6m 7m 8m 1:100


MBCGROUP

56.28 No. 23000435 / 4

CROWN DEVELOPMENT APPROVED PLANS

I certify that the work completed in accordance with these plans and specifications will comply with the technical provisions of the State's building days and the Environmental Planning and Assessment Act 1979 No. 203

MBC Corporate Accreditation RBC00029 22 Feb 2024

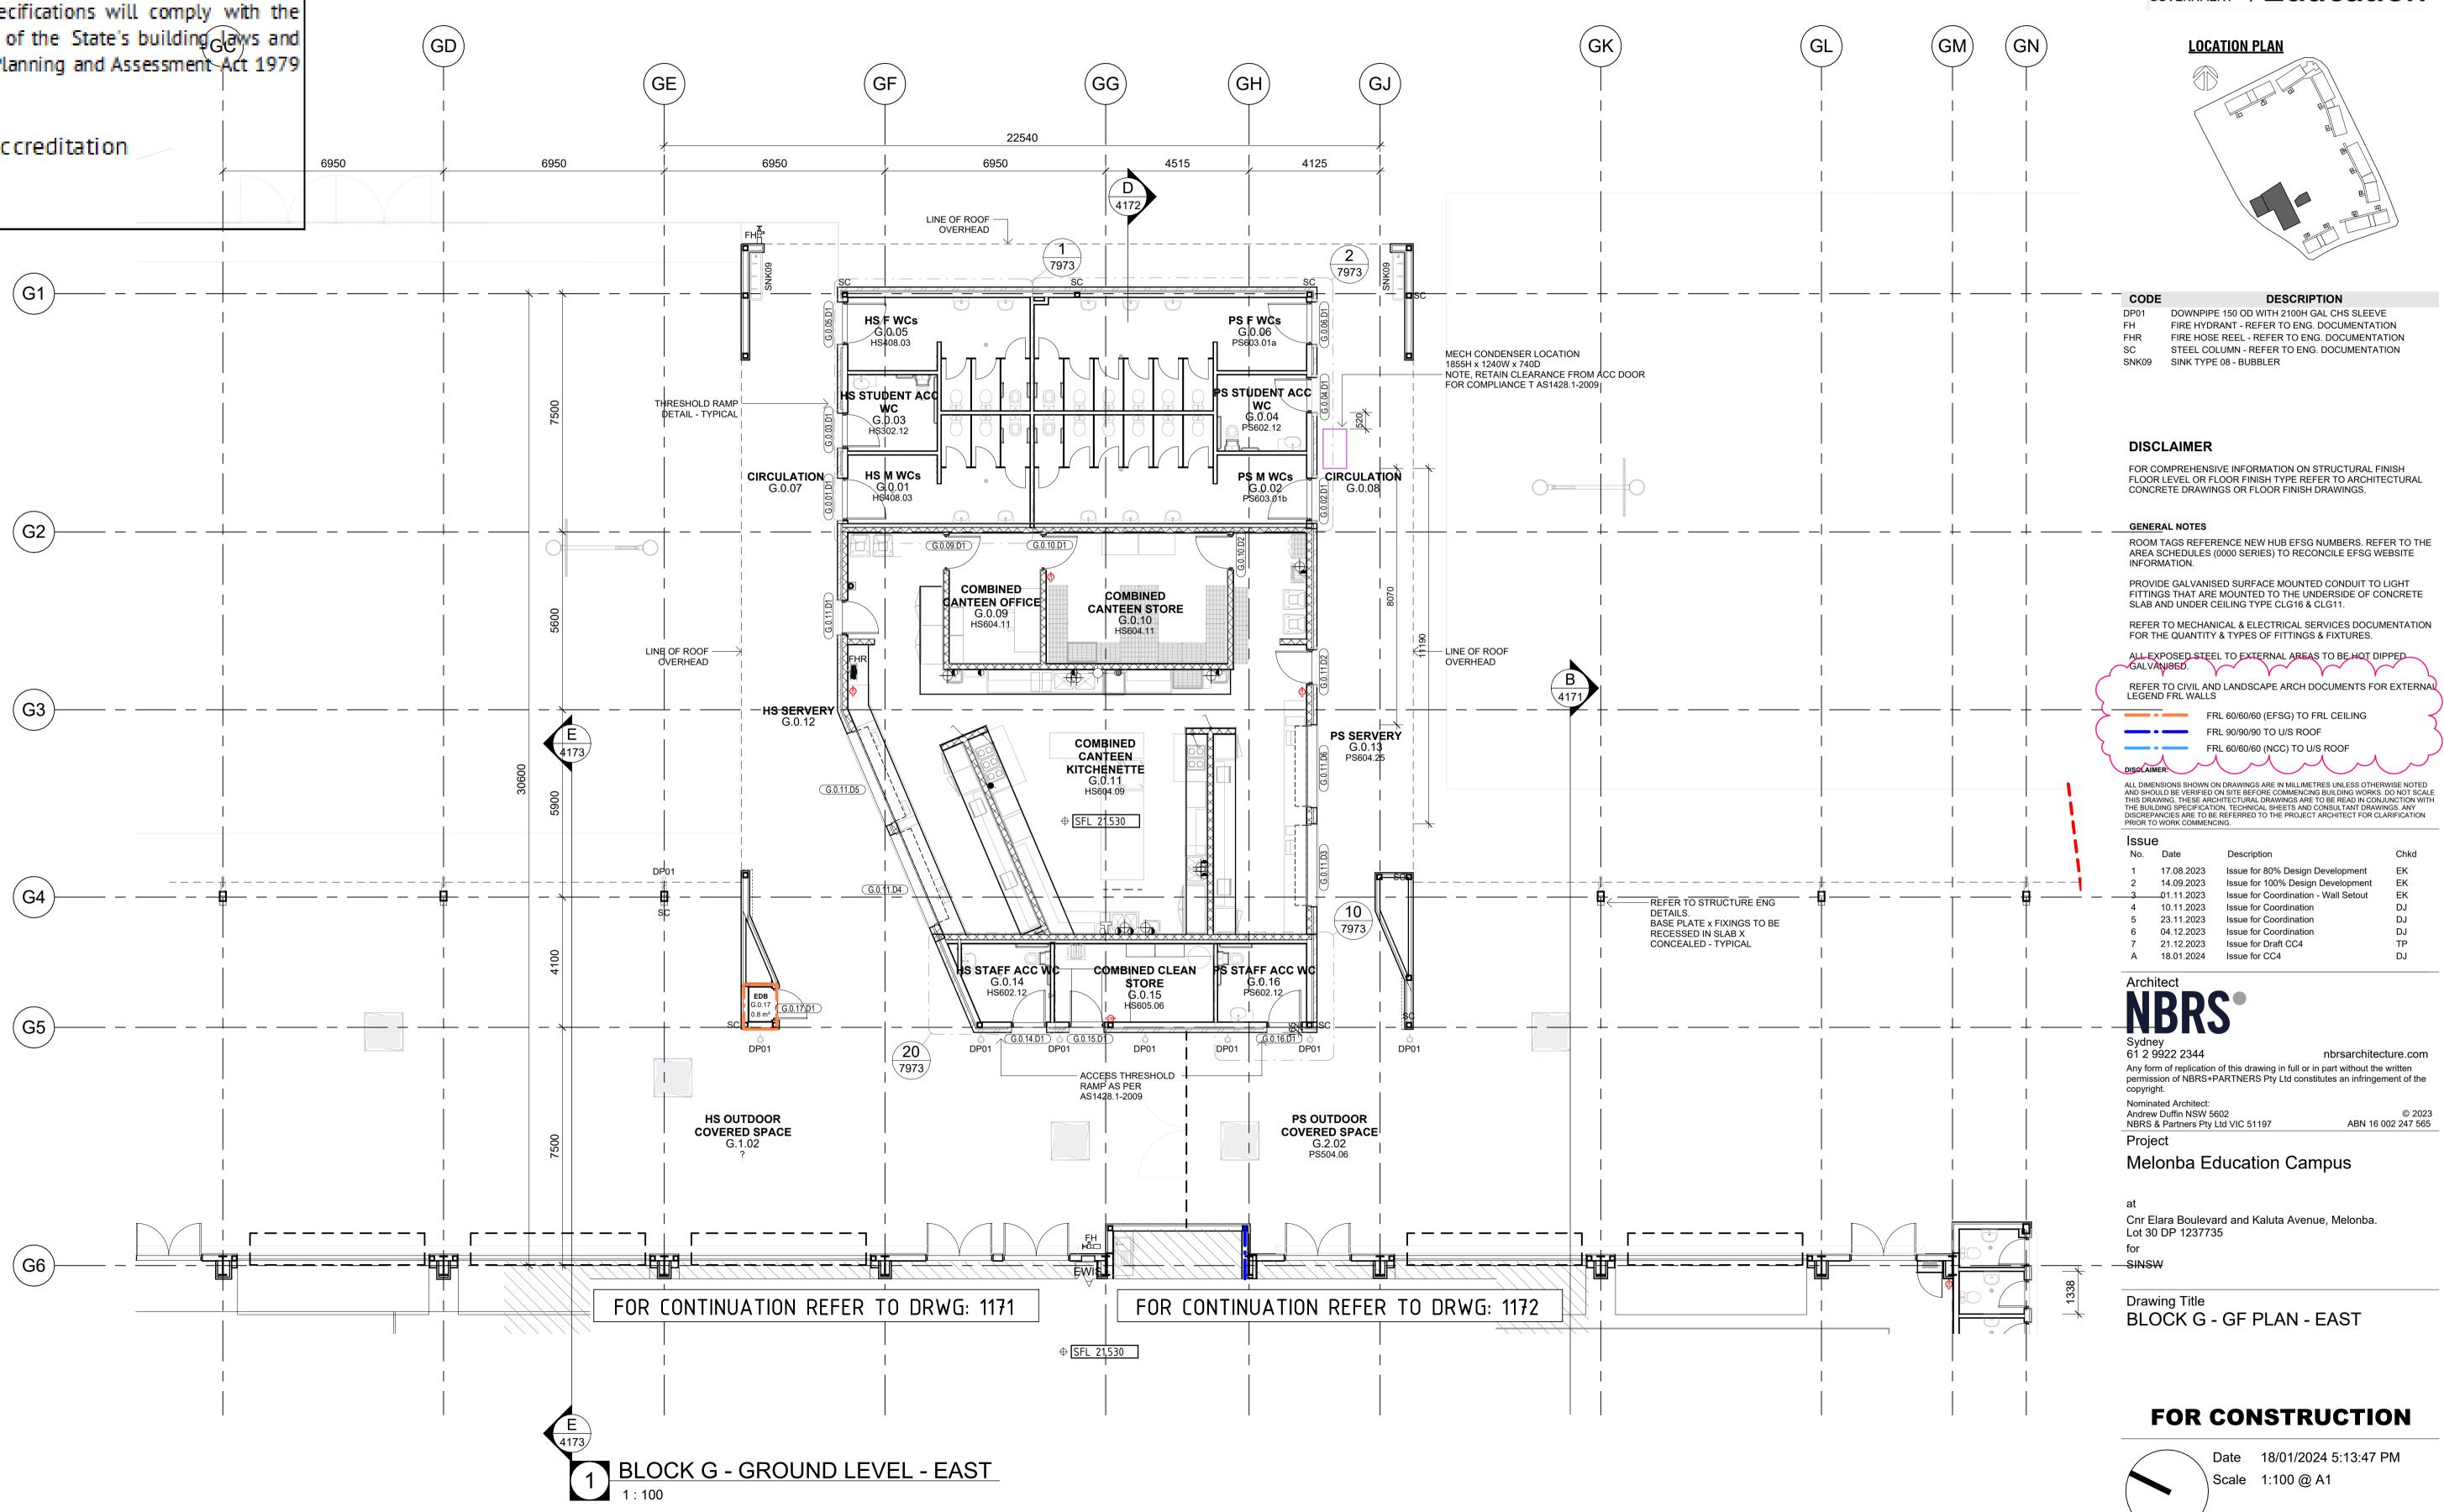




Drawing Reference Revision MM-NBRS-BG-GF-DR-A-1173 Α 0 1m 2m 3m 4m 5m 6m 7m 8m 1:100

MBCGROUP

56.28 No. 23000435 / 4


CROWN DEVELOPMENT APPROVED PLANS

I certify that the work completed in accordance with these plans and specifications will comply with the technical provisions of the State's building laws and the Environmental Planning and Assessments Act 1979-No. 203

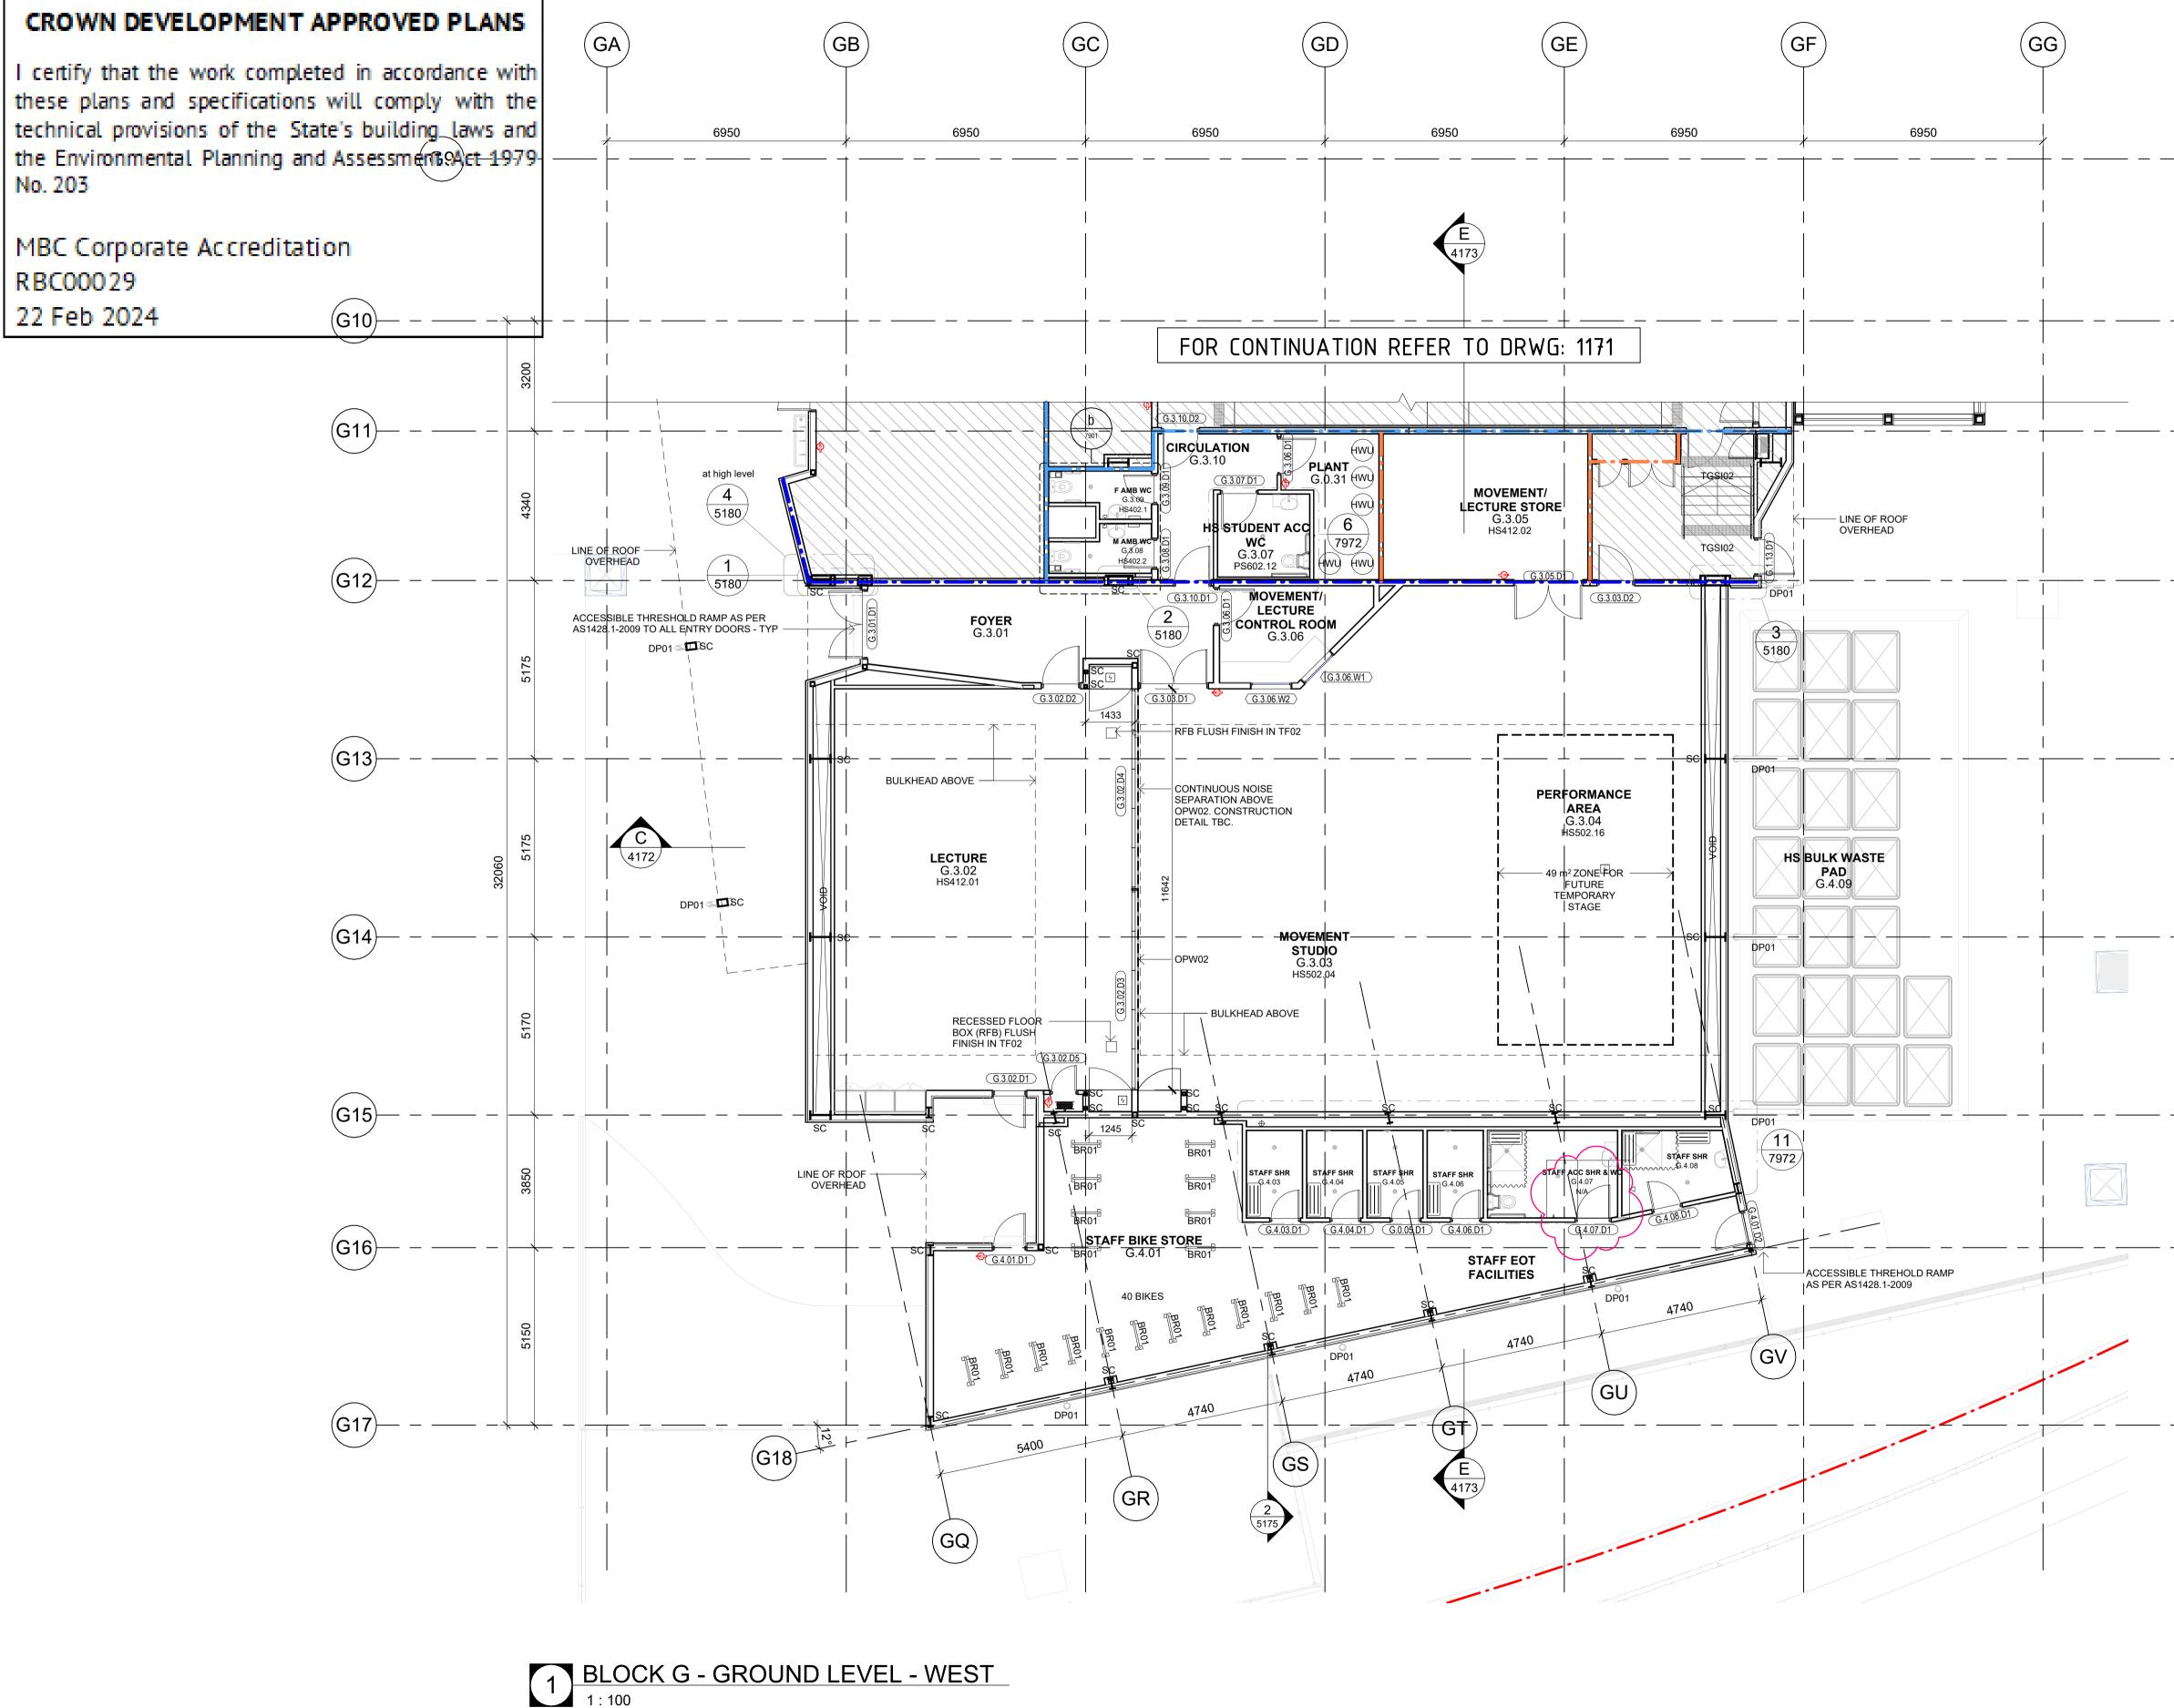



LOCATION PLAN

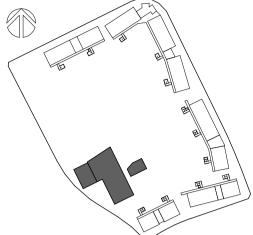

CODE	DESCRIPTION
BR01	BIKE RACK
DP01	DOWNPIPE 150 OD WITH 2100H GAL CHS SLEEVE
HWU	HOT WATER UNIT
SC	STEEL COLUMN - REFER TO ENG. DOCUMENTATION
TGSI02	TACTILE GROUND SURFACE INDICATOR

DISCLAIMER

FOR COMPREHENSIVE INFORMATION ON STRUCTURAL FINISH FLOOR LEVEL OR FLOOR FINISH TYPE REFER TO ARCHITECTURAL CONCRETE DRAWINGS OR FLOOR FINISH DRAWINGS.

GENERAL NOTES

ROOM TAGS REFERENCE NEW HUB EFSG NUMBERS. REFER TO THE AREA SCHEDULES (0000 SERIES) TO RECONCILE EFSG WEBSITE INFORMATION.

PROVIDE GALVANISED SURFACE MOUNTED CONDUIT TO LIGHT FITTINGS THAT ARE MOUNTED TO THE UNDERSIDE OF CONCRETE SLAB AND UNDER CEILING TYPE CLG16 & CLG11.

REFER TO MECHANICAL & ELECTRICAL SERVICES DOCUMENTATION FOR THE QUANTITY & TYPES OF FITTINGS & FIXTURES.

ALL EXPOSED STEEL TO EXTERNAL AREAS TO BE HOT DIPPED GALVANISED.

REFER TO CIVIL AND LANDSCAPE ARCH DOCUMENTS FOR EXTERNAL LEGEND FRL WALLS



FRL 60/60/60 (EFSG) TO FRL CEILING • • FRL 90/90/90 TO U/S ROOF FRL 60/60/60 (NCC) TO U/S ROOI

DISCLAIMER

ALL DIMENSIONS SHOWN ON DRAWINGS ARE IN MILLIMETRES UNLESS OTHERWISE NOTED AND SHOULD BE VERIFIED ON SITE BEFORE COMMENCING BUILDING WORKS. DO NOT SCALE THIS DRAWING, THESE ARCHITECTURAL DRAWINGS ARE TO BE READ IN CONJUNCTION WITH THE BUILDING SPECIFICATION, TECHNICAL SHEETS AND CONSULTANT DRAWINGS. ANY DISCREPANCIES ARE TO BE REFERRED TO THE PROJECT ARCHITECT FOR CLARIFICATION PRIOR TO WORK COMMENCING.

c	c		۵	
Э	Э	u	C	

320.09.2023Issue with DDA UpdatesEK402.11.2023Issue for CoordinationDJ510.11.2023Issue for CoordinationDJ623.11.2023Issue for CoordinationDJ704.12.2023Issue for CoordinationDJ821.12.2023Issue for Draft CC4TPA18.01.2024Issue for CC4DJ	33uc	•		
402.11.2023Issue for CoordinationDJ510.11.2023Issue for CoordinationDJ623.11.2023Issue for CoordinationDJ704.12.2023Issue for CoordinationDJ821.12.2023Issue for Draft CC4TPA18.01.2024Issue for CC4DJ	No.	Date	Description	Chkd
510.11.2023Issue for CoordinationDJ623.11.2023Issue for CoordinationDJ704.12.2023Issue for CoordinationDJ821.12.2023Issue for Draft CC4TPA18.01.2024Issue for CC4DJ	3	20.09.2023	Issue with DDA Updates	EK
623.11.2023Issue for CoordinationDJ704.12.2023Issue for CoordinationDJ821.12.2023Issue for Draft CC4TPA18.01.2024Issue for CC4DJ	4	02.11.2023	Issue for Coordination	DJ
7 04.12.2023 Issue for Coordination DJ 8 21.12.2023 Issue for Draft CC4 TP A 18.01.2024 Issue for CC4 DJ	5	10.11.2023	Issue for Coordination	DJ
8 21.12.2023 Issue for Draft CC4 TP A 18.01.2024 Issue for CC4 DJ	6	23.11.2023	Issue for Coordination	DJ
A 18.01.2024 Issue for CC4 DJ	7	04.12.2023	Issue for Coordination	DJ
	8	21.12.2023	Issue for Draft CC4	TP
B 25.01.2024 Issue for CC4	A	18.01.2024	Issue for CC4	DJ
	В	25.01.2024	Issue for CC4	





61 2 9922 2344 nbrsarchitecture.com Any form of replication of this drawing in full or in part without the written permission of NBRS+PARTNERS Pty Ltd constitutes an infringement of the copyright.

Nominated Architect: Andrew Duffin NSW 5602 © 2023 ABN 16 002 247 565 NBRS & Partners Pty Ltd VIC 51197 Project

Melonba Education Campus


Cnr Elara Boulevard and Kaluta Avenue, Melonba. Lot 30 DP 1237735 for


SINSW


Drawing Title

BLOCK G - GF PLAN - WEST



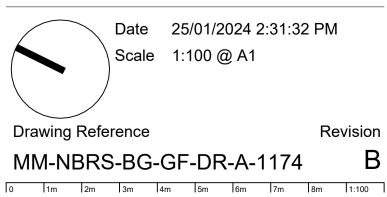


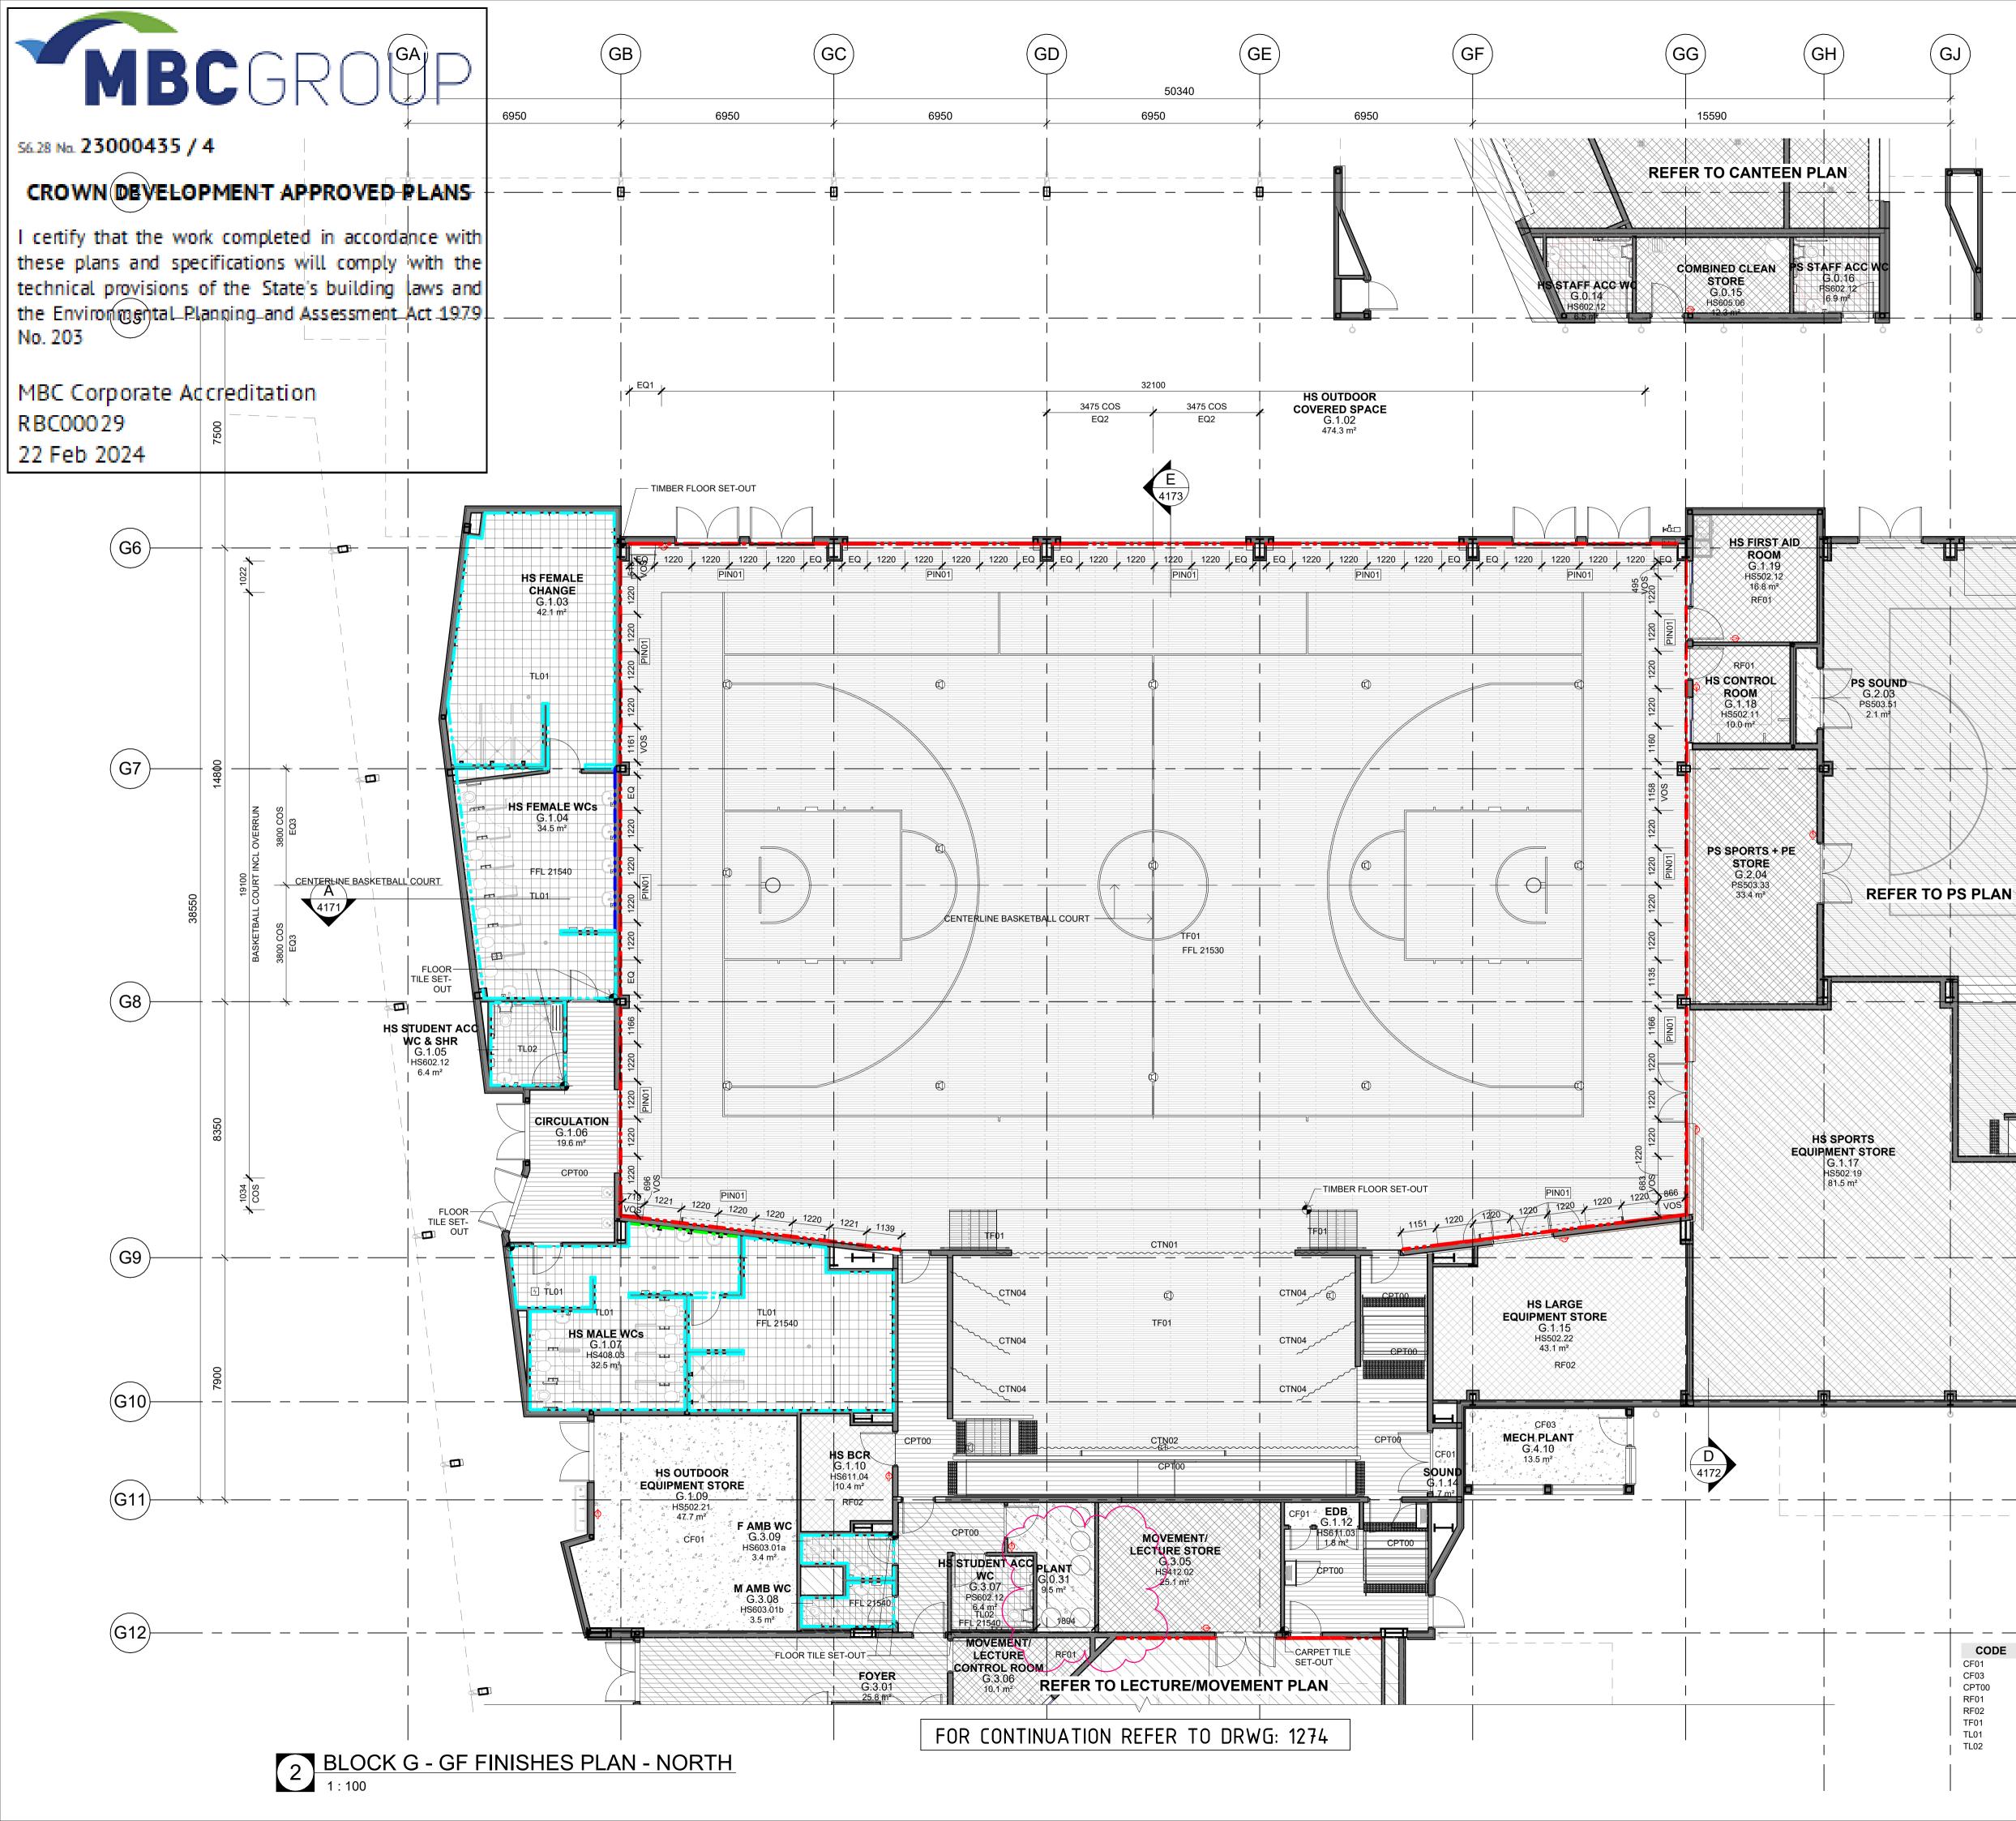


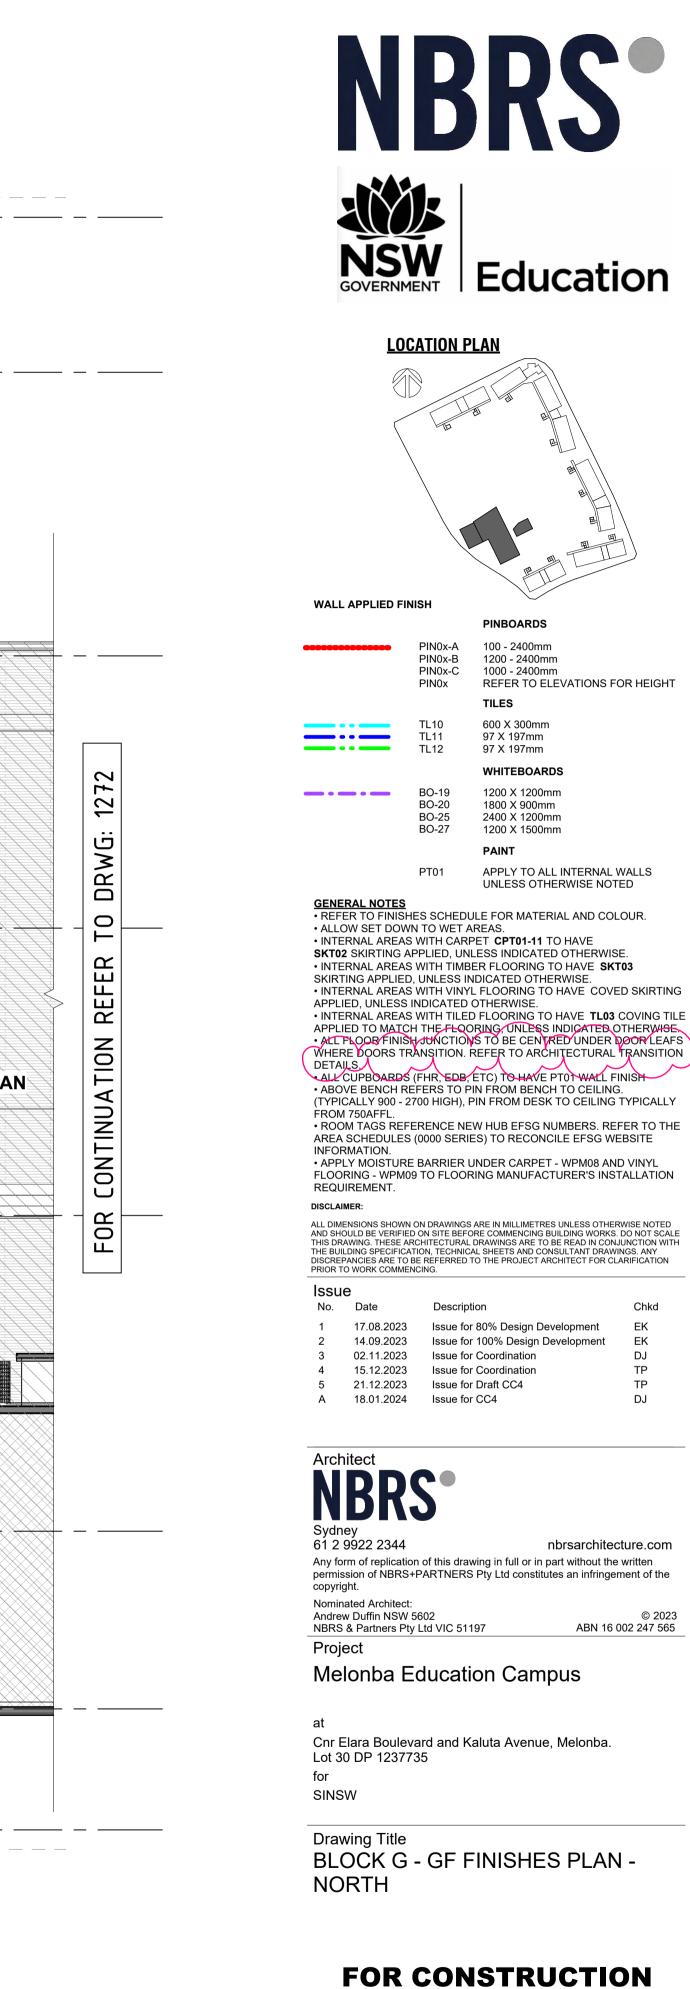

DE DESCRIPTION CONCRETE FL - BROOMED FINISH CONCRETE FL - STEEL TROWELED MAT TYPE 1 RESILIENT FINISH TYPE 01 RESILIENT FINISH TYPE 02 SPRUNG TIMBER FLOOR TILING TYPE 01 (FLOOR) TILING TYPE 02 (FLOOR)

Date 18/01/2024 5:13:27 PM

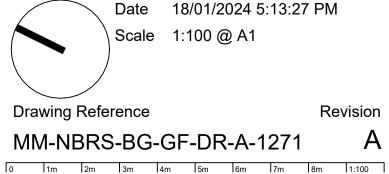

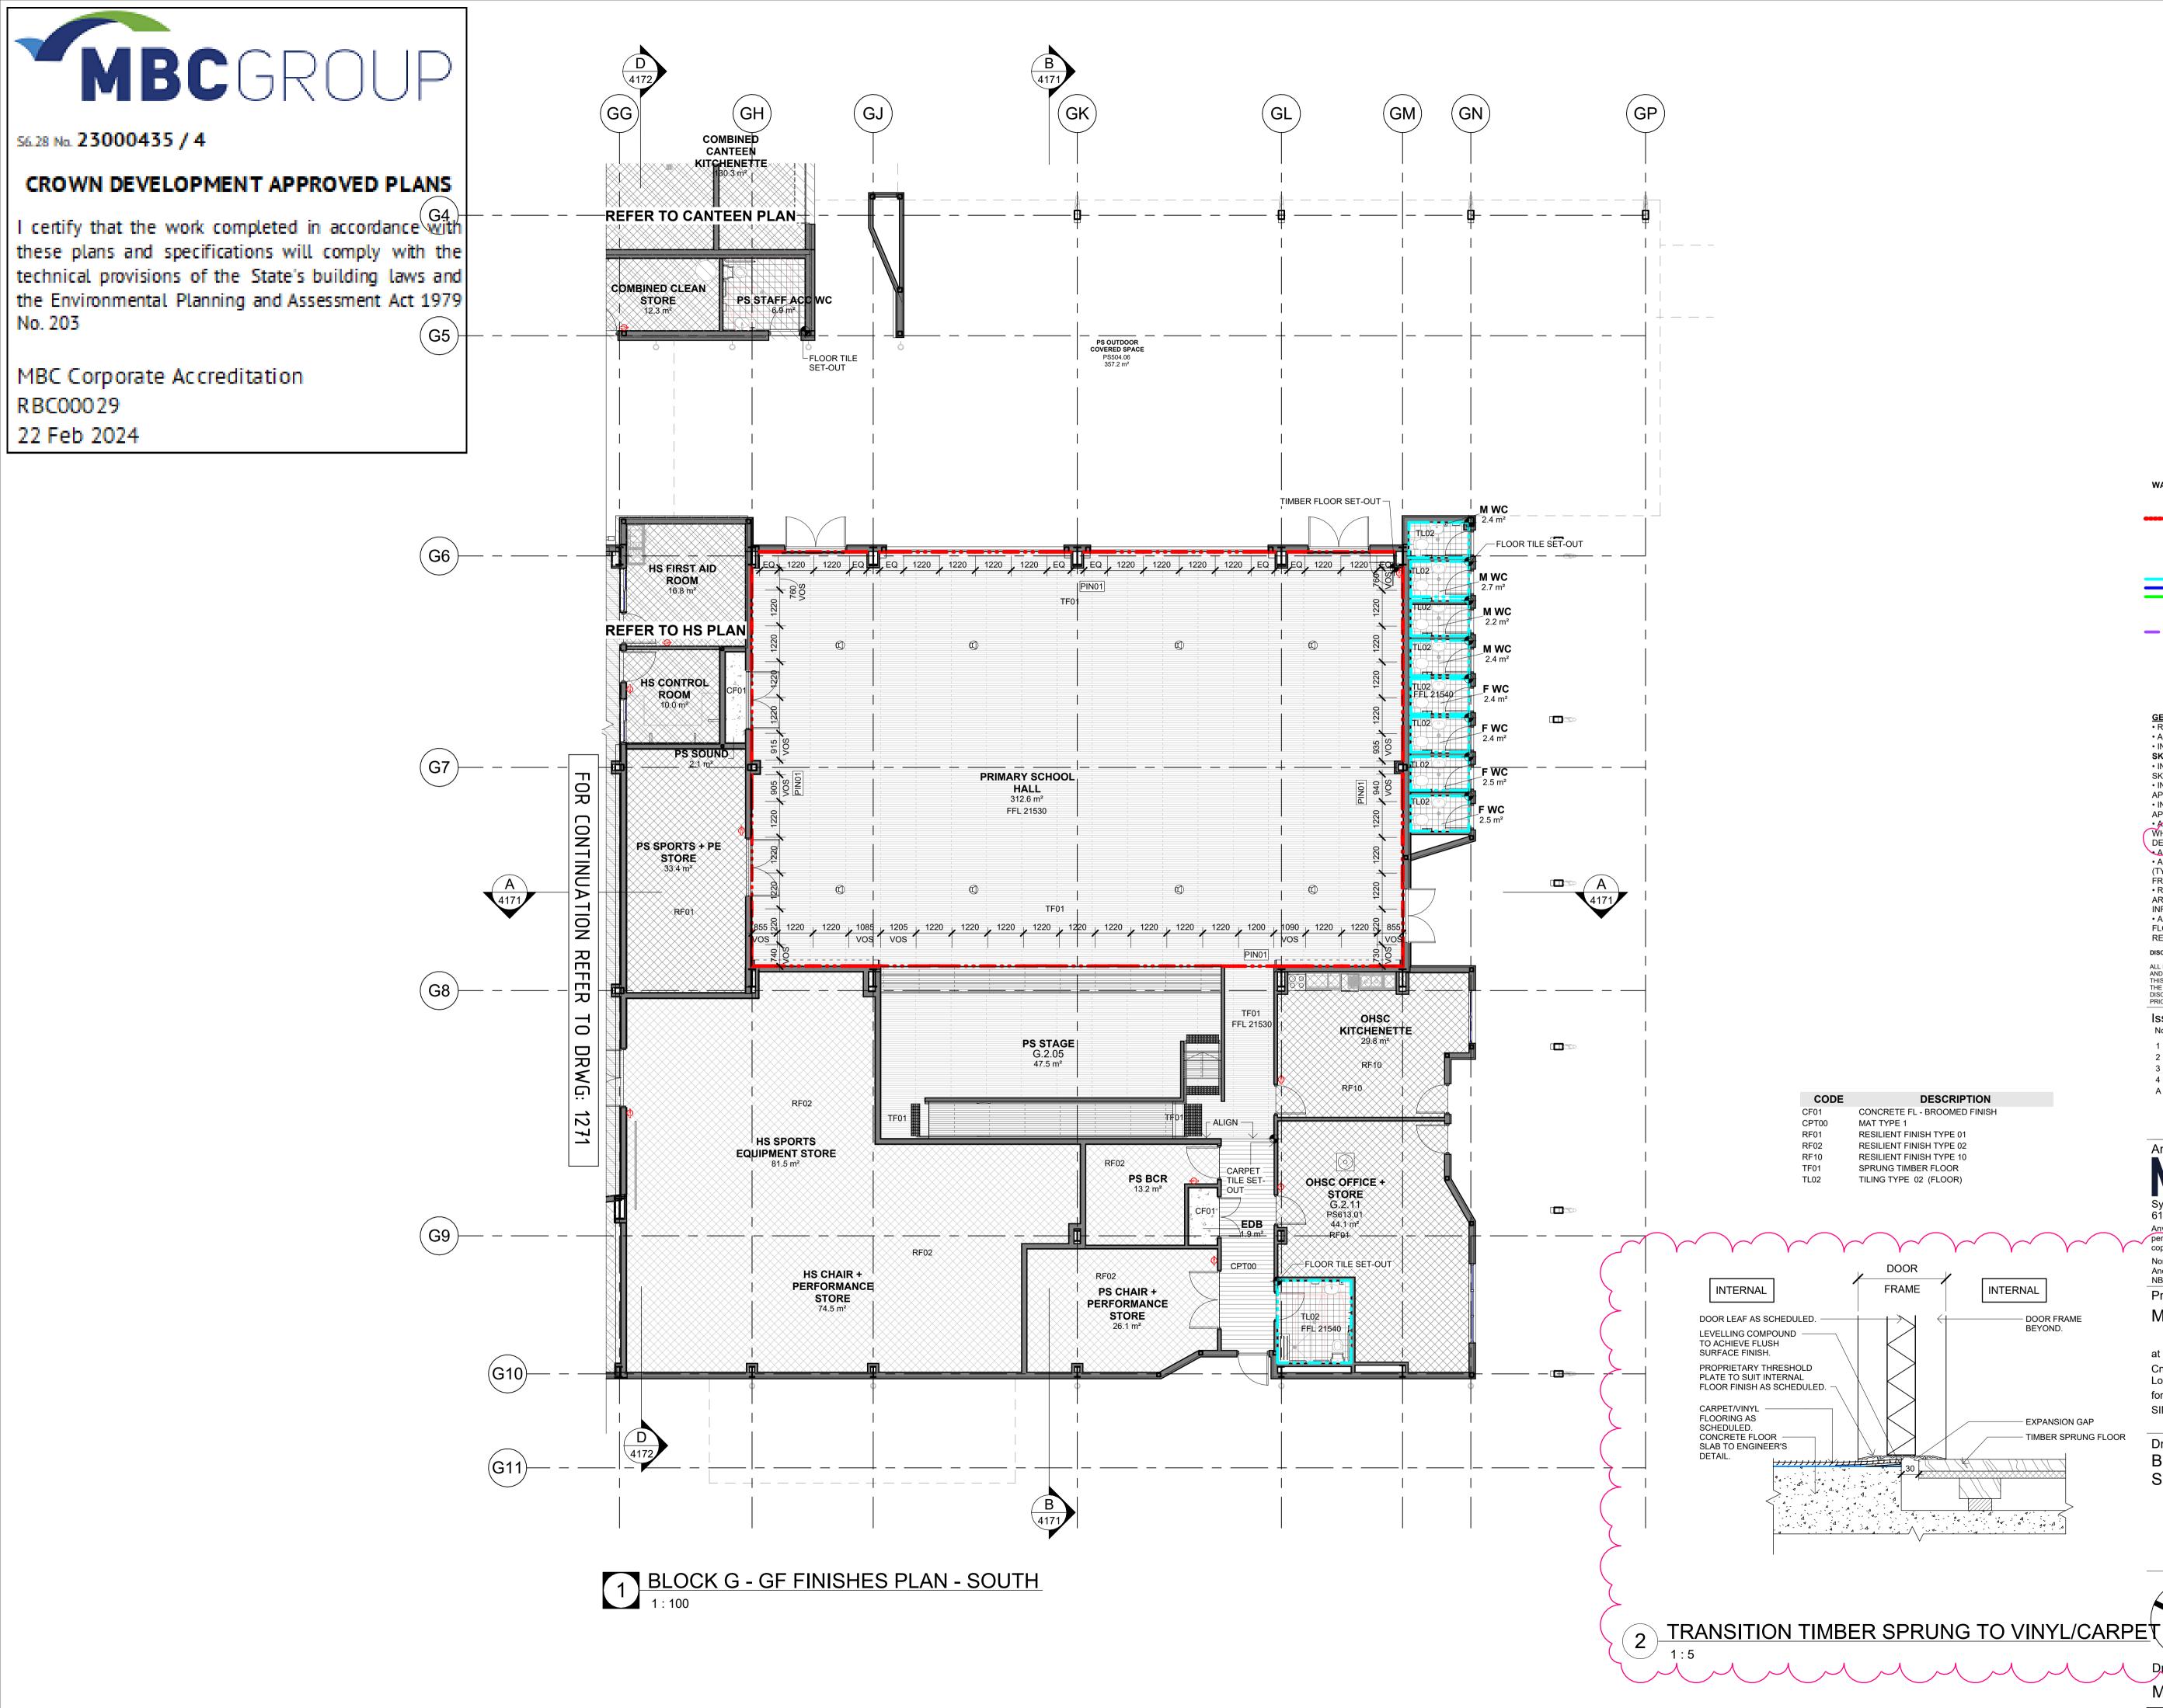



LOCATION PLAN WALL APPLIED FINISH 100 - 2400mm PIN0x-A PIN0x-B 1200 - 2400mm PIN0x-C 1000 - 2400mm REFER TO ELEVATIONS FOR HEIGHT PIN0x TILES TL10 600 X 300mm TL11 97 X 197mm ----TL12 97 X 197mm WHITEBOARDS 1200 X 1200mm BO-19 ____ BO-20 1800 X 900mm BO-25 2400 X 1200mm BO-27 1200 X 1500mm PAINT APPLY TO ALL INTERNAL WALLS PT01 UNLESS OTHERWISE NOTED GENERAL NOTES • REFER TO FINISHES SCHEDULE FOR MATERIAL AND COLOUR • ALLOW SET DOWN TO WET AREAS. • INTERNAL AREAS WITH CARPET CPT01-11 TO HAVE SKT02 SKIRTING APPLIED, UNLESS INDICATED OTHERWISE • INTERNAL AREAS WITH TIMBER FLOORING TO HAVE SKT03 SKIRTING APPLIED, UNLESS INDICATED OTHERWISE. INTERNAL AREAS WITH VINYL FLOORING TO HAVE COVED SKIRTING APPLIED, UNLESS INDICATED OTHERWISE. • INTERNAL AREAS WITH TILED FLOORING TO HAVE TL03 COVING TILE APPLIED TO MATCH THE FLOORING, UNLESS INDICATED OTHERWISE. • ALL FLOOP FINISH JUNCTIONS TO BE CENTRED UNDER DOOR LEAFS WHERE DOORS TRANSITION. REFER TO ARCHITECTURAL TRANSITION DETAILS ALL CUPBOARDS (FHR, EDB, ETC) TO HAVE PTOT WALL FINISH • ABOVE BENCH REFERS TO PIN FROM BENCH TO CEILING. (TYPICALLY 900 - 2700 HIGH), PIN FROM DESK TO CEILING TYPICALLY FROM 750AFFL • ROOM TAGS REFERENCE NEW HUB EFSG NUMBERS. REFER TO THE AREA SCHEDULES (0000 SERIES) TO RECONCILE EFSG WEBSITE INFORMATION • APPLY MOISTURE BARRIER UNDER CARPET - WPM08 AND VINYL FLOORING - WPM09 TO FLOORING MANUFACTURER'S INSTALLATION REQUIREMENT. DISCLAIMER: ALL DIMENSIONS SHOWN ON DRAWINGS ARE IN MILLIMETRES UNLESS OTHERWISE NOTED AND SHOULD BE VERIFIED ON SITE BEFORE COMMENCING BUILDING WORKS. DO NOT SCALE THIS DRAWING. THESE ARCHITECTURAL DRAWINGS ARE TO BE READ IN CONJUNCTION WITH THE BUILDING SPECIFICATION, TECHNICAL SHEETS AND CONSULTANT DRAWINGS. ANY DISCREPANCIES ARE TO BE REFERRED TO THE PROJECT ARCHITECT FOR CLARIFICATION PRIOR TO WORK COMMENCING. lssue No. Date Description Chko 17.08.2023 Issue for 80% Design Development ΕK 14.09.2023 Issue for 100% Design Development ΕK 02.11.2023 Issue for Coordination DJ 4 21.12.2023 Issue for Draft CC4 TP 18.01.2024 Issue for CC4 DJ Architect NBRS nbrsarchitecture.com 61 2 9922 2344 Any form of replication of this drawing in full or in part without the written permission of NBRS+PARTNERS Pty Ltd constitutes an infringement of the copyright. Nominated Architect: Andrew Duffin NSW 5602 © 2023 ABN 16 002 247 565 NBRS & Partners Pty Ltd VIC 51197 Project Melonba Education Campus - DOOR FRAME BEYOND. Cnr Elara Boulevard and Kaluta Avenue, Melonba. Lot 30 DP 1237735 for SINSW - EXPANSION GAP TIMBER SPRUNG FLOOR Drawing Title BLOCK G - GF FINISHES PLAN -SOUTH A. A. A. A. A. A. FOR CONSTRUCTION Date 18/01/2024 5:13:19 PM Scale 1:100 @ A1

DESCRIPTION CONCRETE FL - BROOMED FINISH MAT TYPE 1 **RESILIENT FINISH TYPE 01 RESILIENT FINISH TYPE 02 RESILIENT FINISH TYPE 10** SPRUNG TIMBER FLOOR


TILING TYPE 02 (FLOOR)

DOOR FRAME INTERNAL

Revision

MM-NBRS-BG-GF-DR-A-1272 Α 0 1m 2m 3m 4m 5m 6m 7m 8m 1:100

Drawing Reference

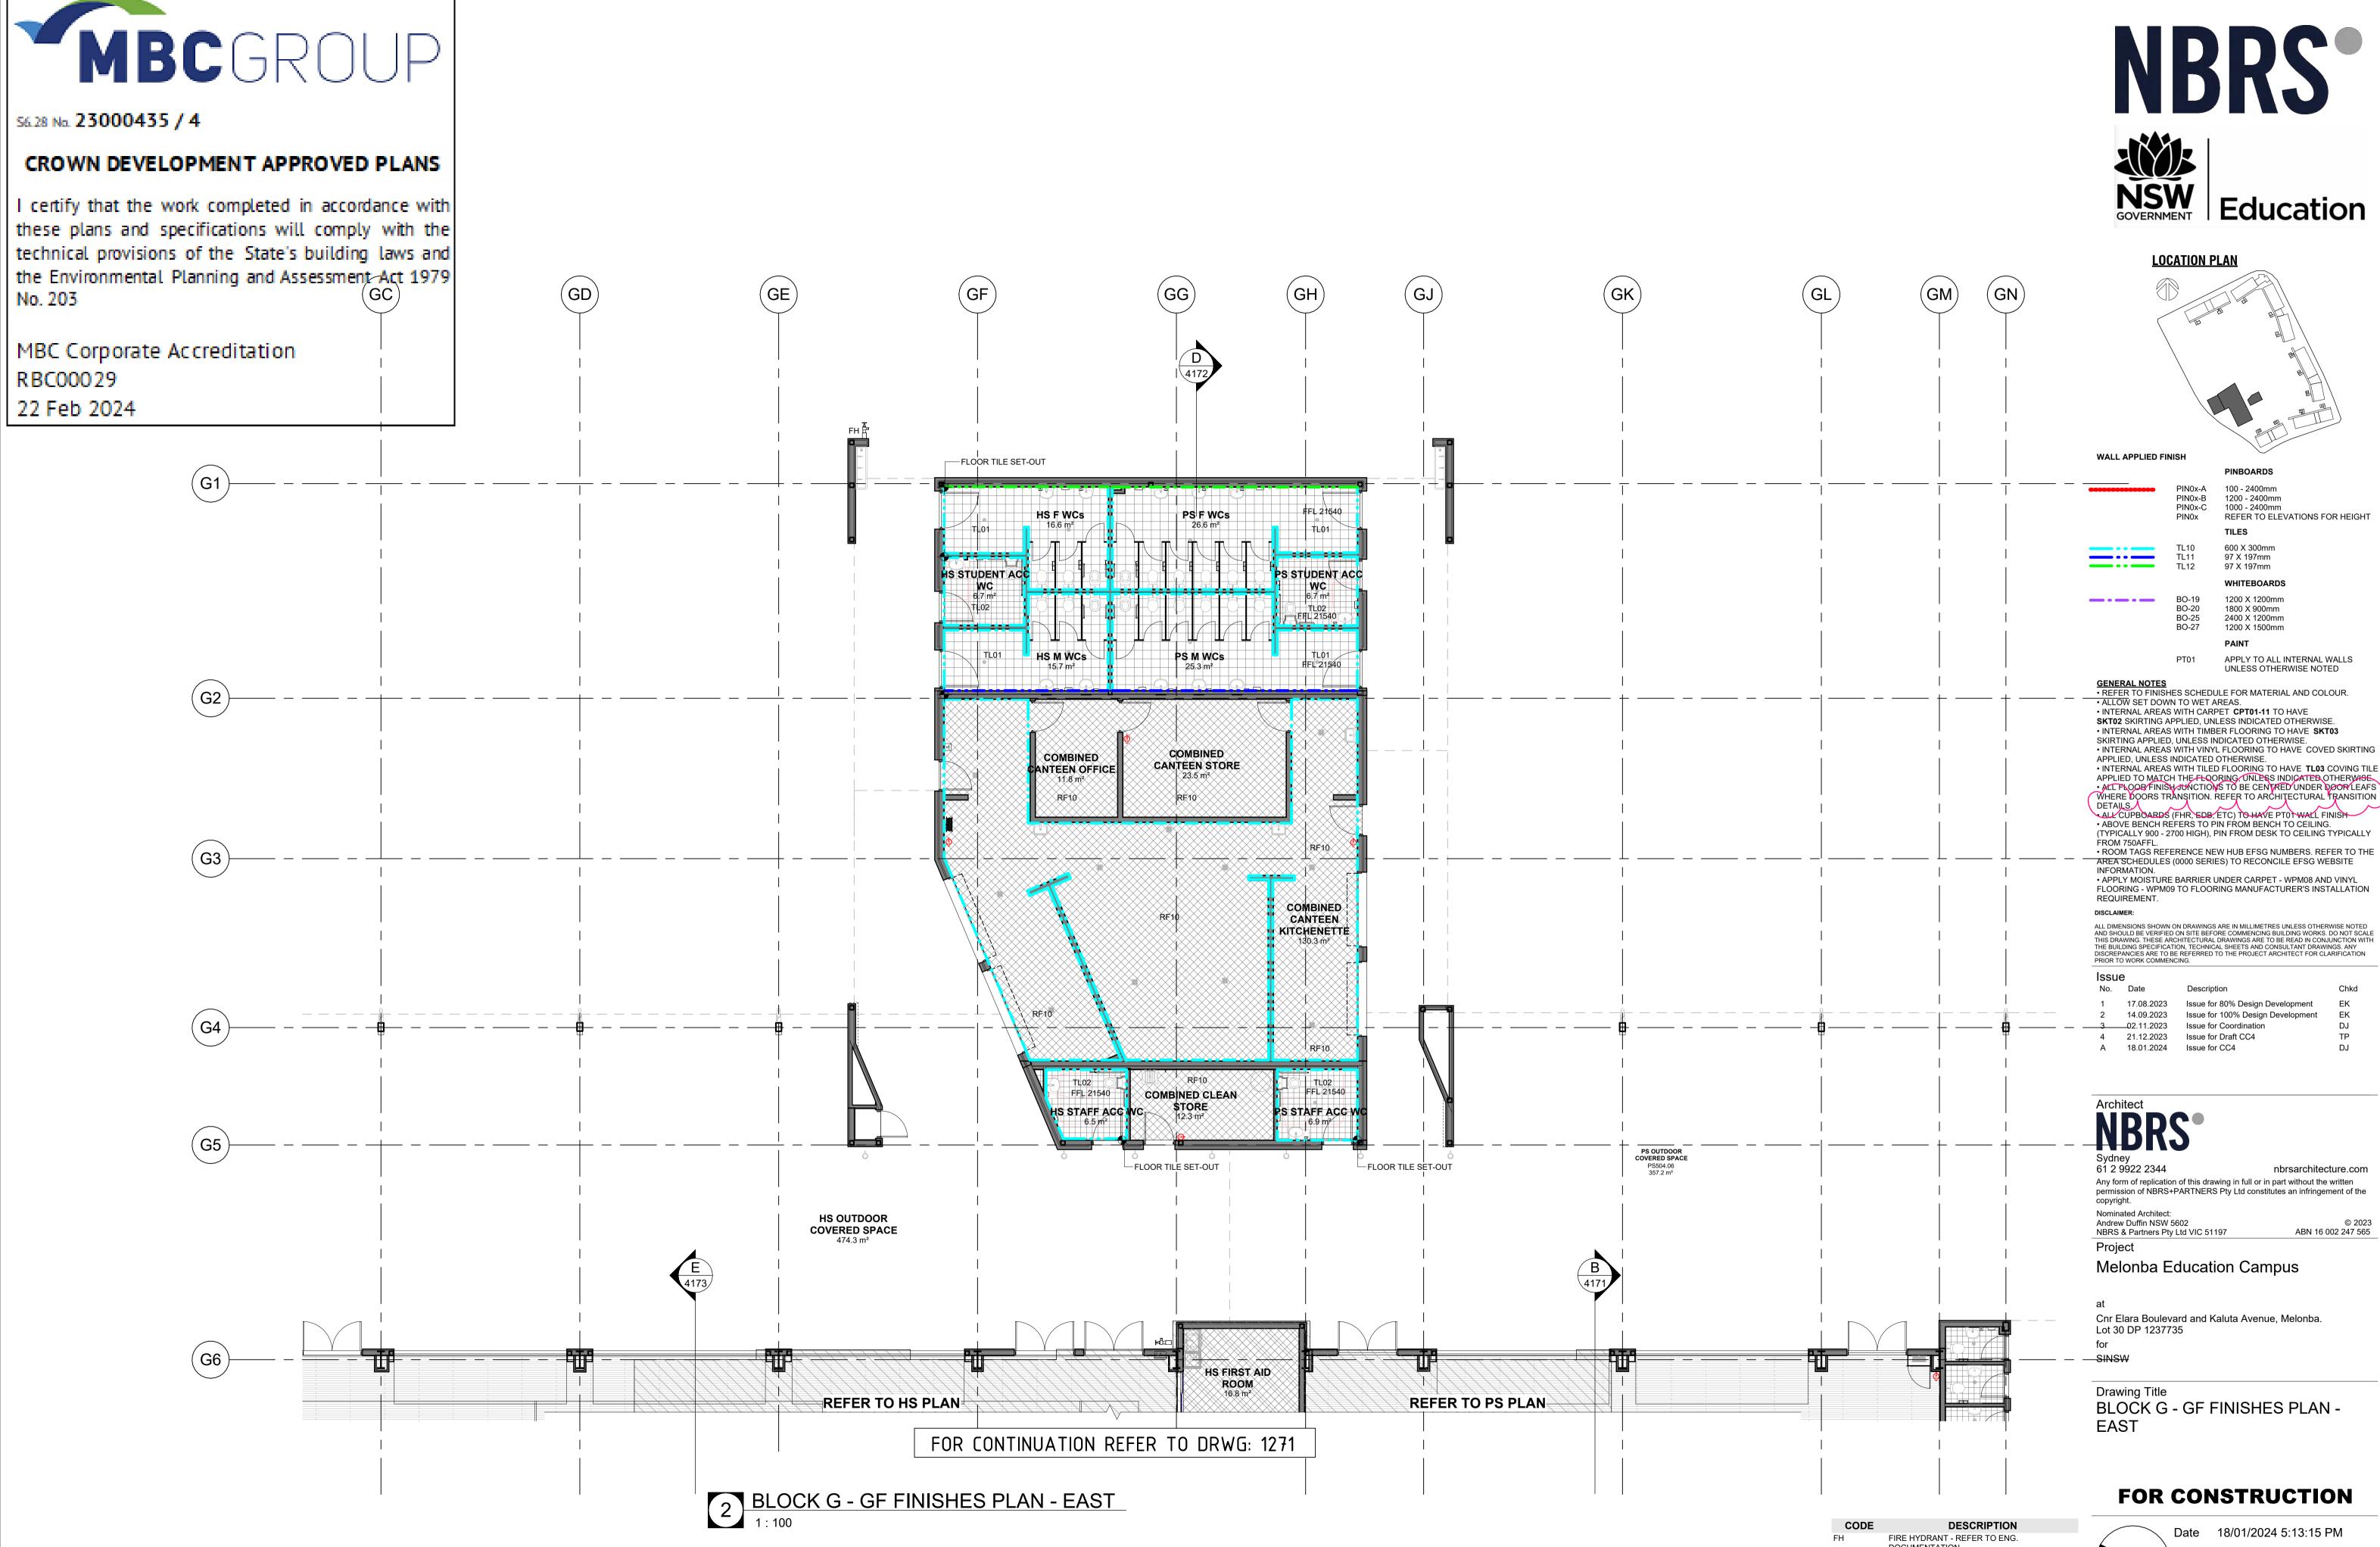




DOCUMENTATION **RESILIENT FINISH TYPE 10** TILING TYPE 01 (FLOOR) TILING TYPE 02 (FLOOR)

RF10

TL01

TL02

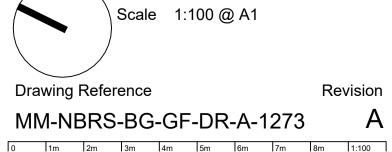




56.28 No. 23000435 / 4

CROWN DEVELOPMENT APPROVED PLANS

I certify that the work completed in accordance with these plans and specifications will comply with the technical provisions of the State's building laws and the Environmental Planning and Assessment Act 1979 No. 203

MBC Corporate Accreditation RBC00029 22 Feb 2024

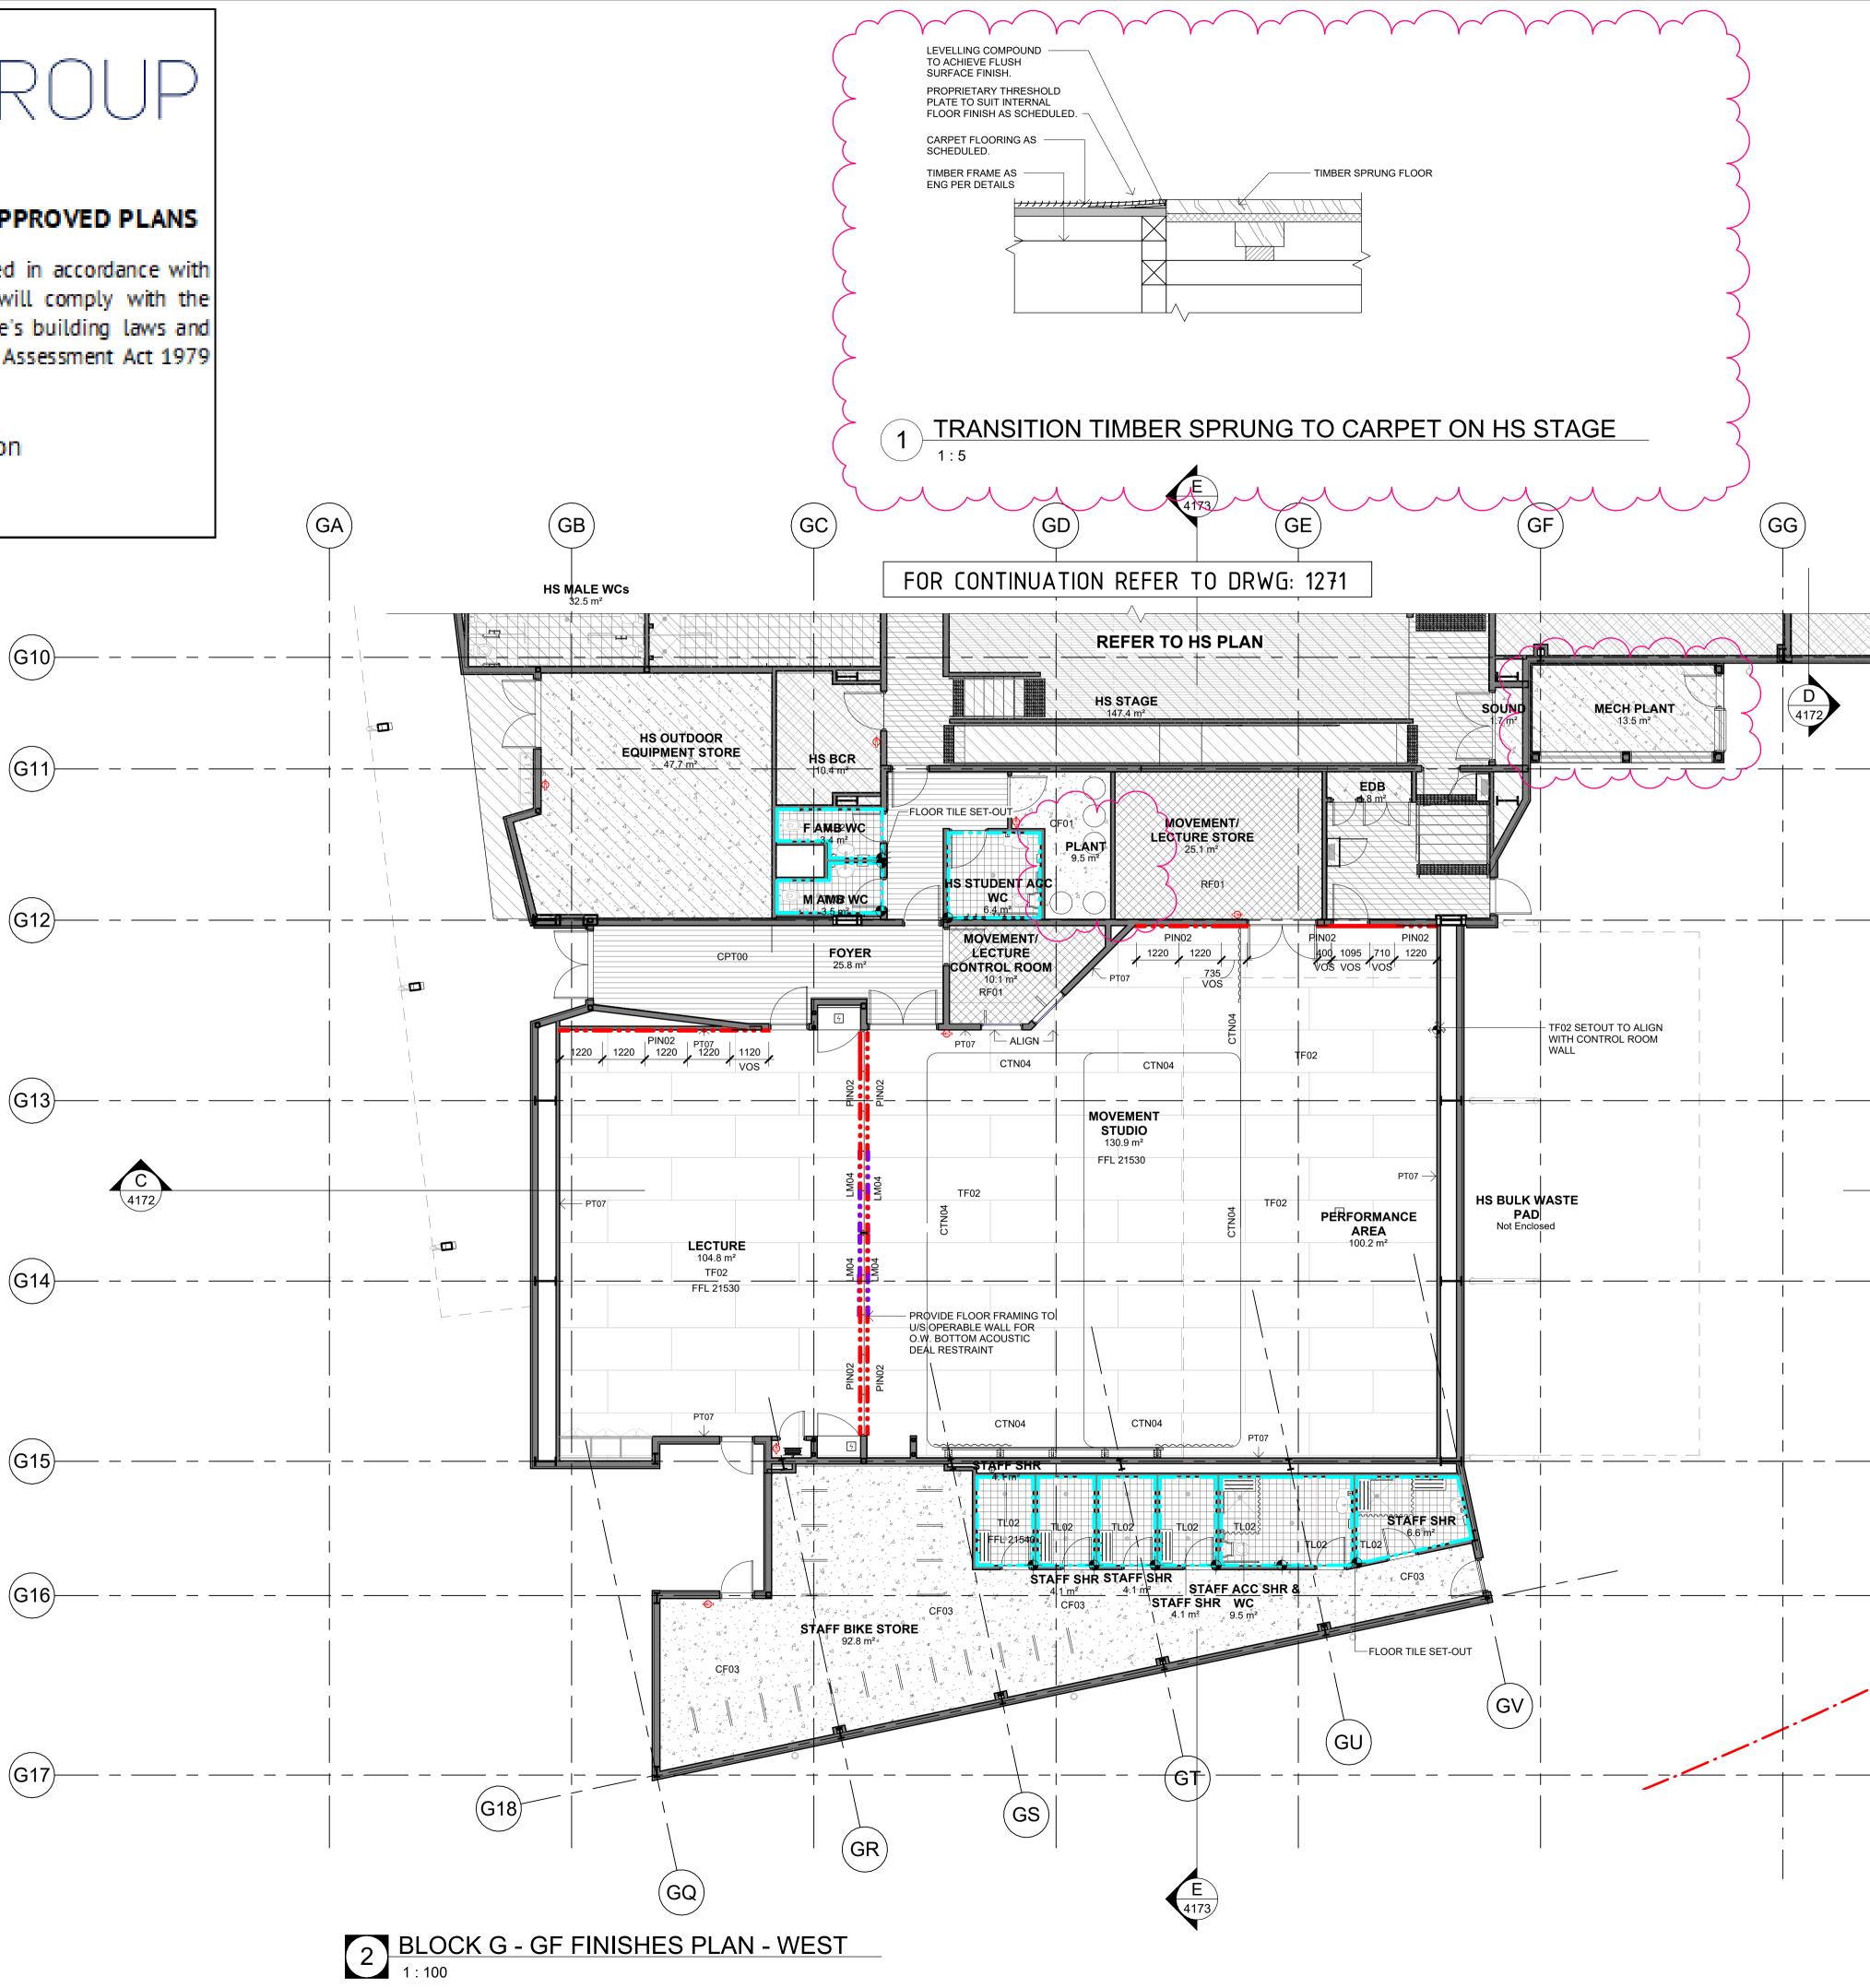



LOCATION PLAN

	NISH	
		PINBOARDS
		INDOARDO
*******	PIN0x-A PIN0x-B PIN0x-C	100 - 2400mm 1200 - 2400mm 1000 - 2400mm

PIN0x-C PIN0x	1000 - 2400mm REFER TO ELEVATIONS FOR HEIGHT
	TILES
TL10 TL11 TL12	600 X 300mm 97 X 197mm 97 X 197mm
	WHITEBOARDS
BO-19 BO-20 BO-25 BO-27	1200 X 1200mm 1800 X 900mm 2400 X 1200mm 1200 X 1500mm
	PAINT
PT01	APPLY TO ALL INTERNAL WALLS

GENERAL NOTES

- REFER TO FINISHES SCHEDULE FOR MATERIAL AND COLOL • ALLOW SET DOWN TO WET AREAS.
- INTERNAL AREAS WITH CARPET CPT01-11 TO HAVE SKT02 SKIRTING APPLIED, UNLESS INDICATED OTHERWISE.
- INTERNAL AREAS WITH TIMBER FLOORING TO HAVE SKT03 SKIRTING APPLIED, UNLESS INDICATED OTHERWISE.
- INTERNAL AREAS WITH VINYL FLOORING TO HAVE COVED SKIRTING APPLIED, UNLESS INDICATED OTHERWISE. • INTERNAL AREAS WITH TILED FLOORING TO HAVE TL03 COVING TILE

UNLESS OTHERWISE NOTED

- APPLIED TO MATCH THE FLOORING, UNLESS INDICATED OTHERWISE. • ALL FLOOR FINISH JUNCTIONS TO BE CENTRED UNDER DOOR LEAFS WHERE DOORS TRANSITION. REFER TO ARCHITECTURAL TRANSITION DETAILS. ALL CUPBOARDS (FHR, EDB, ETC) TO HAVE PTOT WALL FINISH
- ABOVE BENCH REFERS TO PIN FROM BENCH TO CEILING. (TYPICALLY 900 - 2700 HIGH), PIN FROM DESK TO CEILING TYPICALLY FROM 750AFFL • ROOM TAGS REFERENCE NEW HUB EFSG NUMBERS. REFER TO THE
- AREA SCHEDULES (0000 SERIES) TO RECONCILE EFSG WEBSITE INFORMATION • APPLY MOISTURE BARRIER UNDER CARPET - WPM08 AND VINYL
- FLOORING WPM09 TO FLOORING MANUFACTURER'S INSTALLATION REQUIREMENT. DISCLAIMER:

ALL DIMENSIONS SHOWN ON DRAWINGS ARE IN MILLIMETRES UNLESS OTHERWISE NOTED AND SHOULD BE VERIFIED ON SITE BEFORE COMMENCING BUILDING WORKS. DO NOT SCALE THIS DRAWING. THESE ARCHITECTURAL DRAWINGS ARE TO BE READ IN CONJUNCTION WITH THE BUILDING SPECIFICATION, TECHNICAL SHEETS AND CONSULTANT DRAWINGS. ANY DISCREPANCIES ARE TO BE REFERRED TO THE PROJECT ARCHITECT FOR CLARIFICATION PRIOR TO WORK COMMENCING.

Issue

No.	Date	Description	Chkd
1 2 3 4 5 A	17.08.2023 14.09.2023 20.09.2023 02.11.2023 21.12.2023 18.01.2024	Issue for 80% Design Development Issue for 100% Design Development Issue with DDA Updates Issue for Coordination Issue for Draft CC4 Issue for CC4	EK EK DJ TP DJ

Architect NRRS

61 2 9922 2344

nbrsarchitecture.com Any form of replication of this drawing in full or in part without the written permission of NBRS+PARTNERS Pty Ltd constitutes an infringement of the copyright. Nominated Architect: Andrew Duffin NSW 5602 © 2023

ABN 16 002 247 565 NBRS & Partners Pty Ltd VIC 51197 Project

Melonba Education Campus


Cnr Elara Boulevard and Kaluta Avenue, Melonba. Lot 30 DP 1237735 for

SINSW

Drawing Title

BLOCK G - GF FINISHES PLAN -WEST



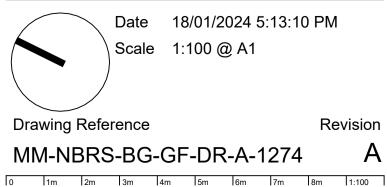

\4172/

(GH)



CTN04


LM04 PIN02

RF01

TF02

TL02

DESCRIPTION CONCRETE FL - BROOMED FINISH CONCRETE FL - STEEL TROWELED MAT TYPE 1 CURTAIN - THEATRE BLACKOUT LAMINATE FINISH TYPE 4 PINBOARD - BASIC **RESILIENT FINISH TYPE 01** TIMBER FLOOR SYSTEM TILING TYPE 02 (FLOOR)

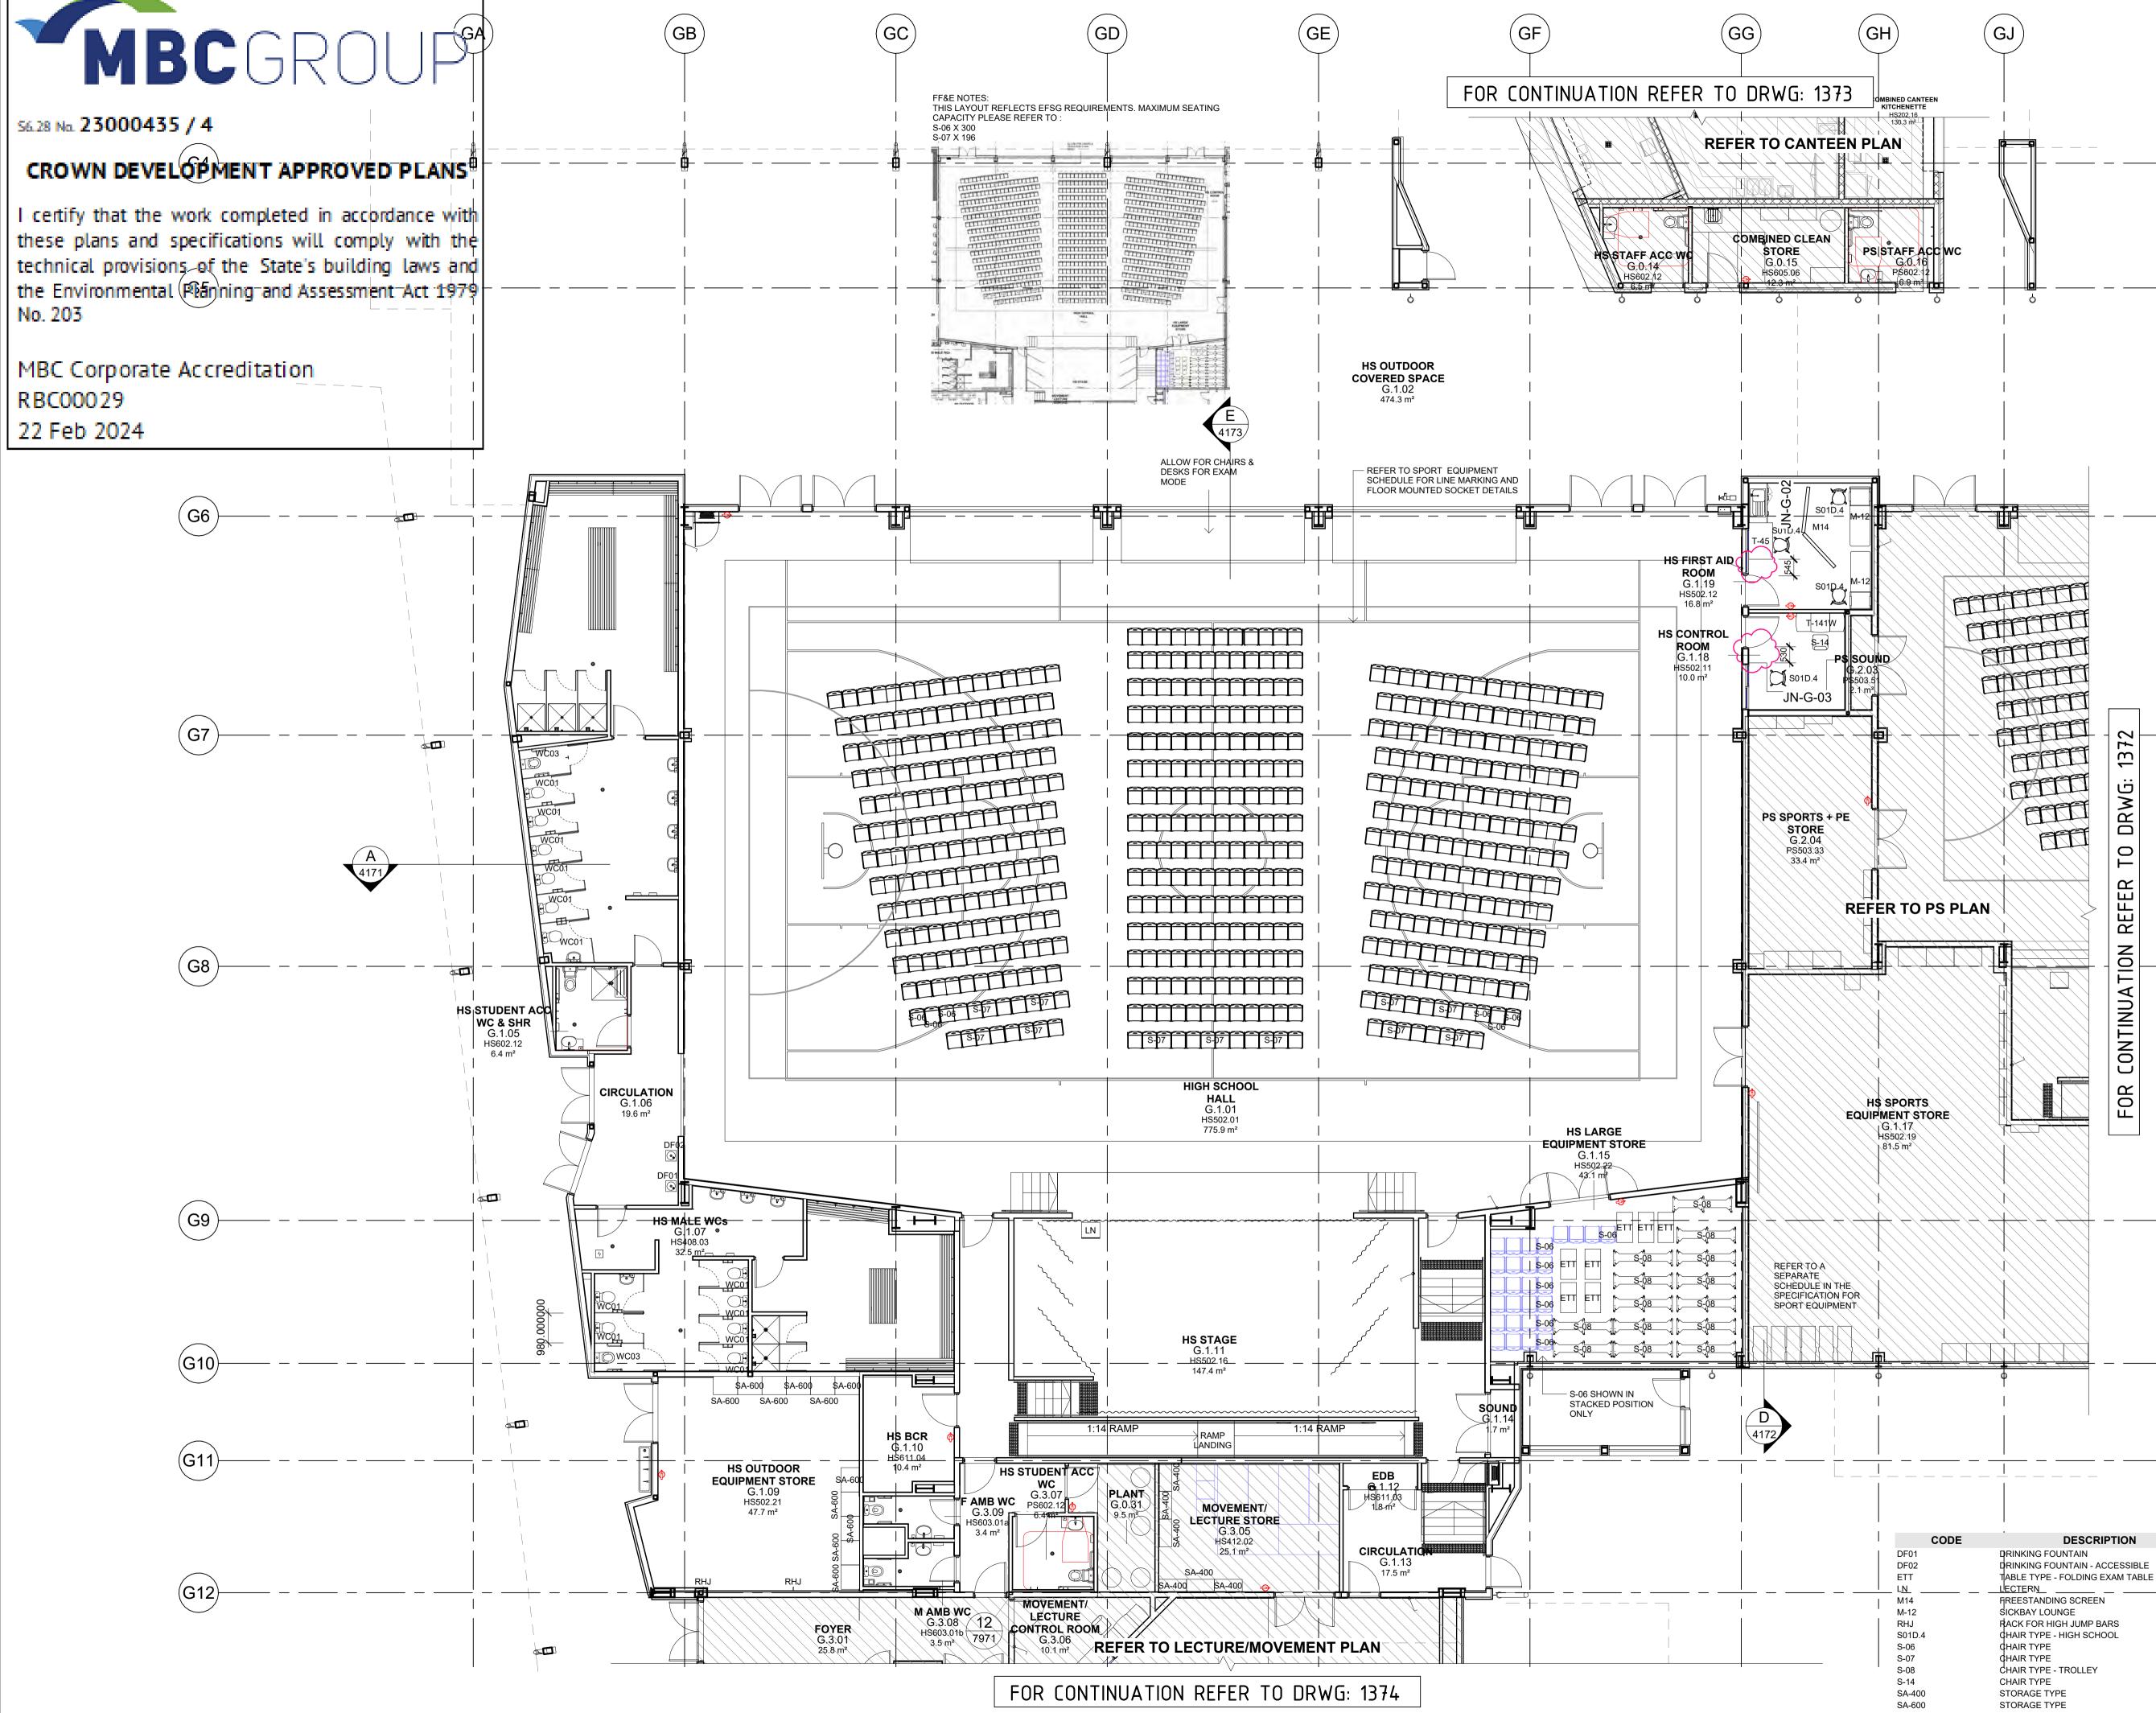

2 BLOCK G - GF FURNITURE PLAN - NORTH


T-45 T-141W WC01

WC03

AMBULANT TOILET SUITE



LOCATION PLAN

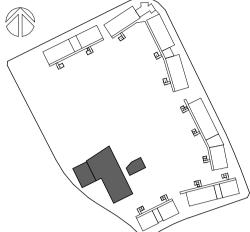

GENERAL NOTES

ROOM TAGS REFERENCE NEW HUB EFSG NUMBERS. REFER TO THE AREA SCHEDULES (0000 SERIES) TO RECONCILE EFSG WEBSITE INFORMATION.

PROVIDE GALVANISED SURFACE MOUNTED CONDUIT TO LIGHT FITTINGS THAT ARE MOUNTED TO THE UNDERSIDE OF CONCRETE SLAB AND UNDER CEILING TYPE CLG16 & CLG11.

REFER TO MECHANICAL & ELECTRICAL SERVICES DOCUMENTATION FOR THE QUANTITY & TYPES OF FITTINGS & FIXTURES.

ALL EXPOSED STEEL TO EXTERNAL AREAS TO BE HOT DIPPED GALVANISED.

REFER TO CIVIL AND LANDSCAPE ARCH DOCUMENTS FOR EXTERNA WORKS

FFE DISCLAIMER

1. ARCHITECTURAL DRAWINGS & MODEL ILLUSTRATE THE INTENDED COORDINATION OF STRUCTURES & SERVICES. DESIGN FINALISATION IS SUBJECT TO FUTURE COORDINATION WITH THE CONTRACTOR

2. REFER TO MECHANICAL & ELECTRICAL SERVICES DOCUMENTATION FOR THE QUANTITY & TYPES OF FITTINGS & FIXTURES

3. REFER TO THE RELEVANT ARCHITECTURAL & HYDRAULICS SERVICES DOCUMENTATION FOR THE QUANTITY & TYPES PLUMBING FITTINGS & FIXTURES.

DISCLAIMER

ALL DIMENSIONS SHOWN ON DRAWINGS ARE IN MILLIMETRES UNLESS OTHERWISE NOTED AND SHOULD BE VERIFIED ON SITE BEFORE COMMENCING BUILDING WORKS. DO NOT SCALE THIS DRAWING. THESE ARCHITECTURAL DRAWINGS ARE TO BE READ IN CONJUNCTION WITH THE BUILDING SPECIFICATION, TECHNICAL SHEETS AND CONSULTANT DRAWINGS. ANY DISCREPANCIES ARE TO BE REFERRED TO THE PROJECT ARCHITECT FOR CLARIFICATION PRIOR TO WORK COMMENCING.

lssu	е		
No.	Date	Description	Chkd
1	17.08.2023	Issue for 80% Design Development	EK
2	14.09.2023	Issue for 100% Design Development	EK
3	02.11.2023	Issue for Coordination	DJ
4	21.12.2023	Issue for Draft CC4	TP
А	18.01.2024	Issue for CC4	DJ
В	25.01.2024	Issue for CC4	

Architect **NBRS**

61 2 9922 2344 Any form of replication of this drawing in full or in part without the written permission of NBRS+PARTNERS Pty Ltd constitutes an infringement of the copyright.

Nominated Architect: Andrew Duffin NSW 5602 NBRS & Partners Pty Ltd VIC 51197 ABN 16 002 247 565 Project

nbrsarchitecture.com

Melonba Education Campus

Cnr Elara Boulevard and Kaluta Avenue, Melonba. Lot 30 DP 1237735 for

SINSW

Drawing Title

BLOCK G - GF FURNITURE PLAN -NORTH

PRINKING FOUNTAIN		
PRINKING FOUNTAIN - ACCESSIBLE		
TABLE TYPE - FOLDING EXAM TABLE TROLLEY	FOR CONCERNATI	
<u>LECTERN</u>	FOR CONSTRUCTI	UN
FIREESTANDING SCREEN		
ŚICKBAY LOUNGE		
RACK FOR HIGH JUMP BARS	Date 25/01/2024 2:33:10	PM
CHAIR TYPE - HIGH SCHOOL		
CHAIR TYPE	Scale 1:100 @ A1	
CHAIR TYPE		
CHAIR TYPE - TROLLEY		
CHAIR TYPE		
STORAGE TYPE		
STORAGE TYPE	Drawing Reference	Revision
TABLE TYPE - ADJUSTABLE	Brawing Reference	
TABLE TYPE	MM-NBRS-BG-GF-DR-A-1371	R
GENERAL TOILET SUITE		D

2m

3m

4m

5m

7m




56.28 No. 23000435 / 4

CROWN DEVELOPMENT APPROVED PLANS

I certify that the work completed in accordance with these plans and specifications will comply with the technical provisions of the State's building laws and the Environmental Planning and Assessment Act 1979 No. 203

MBC Corporate Accreditation RBC00029 22 Feb 2024

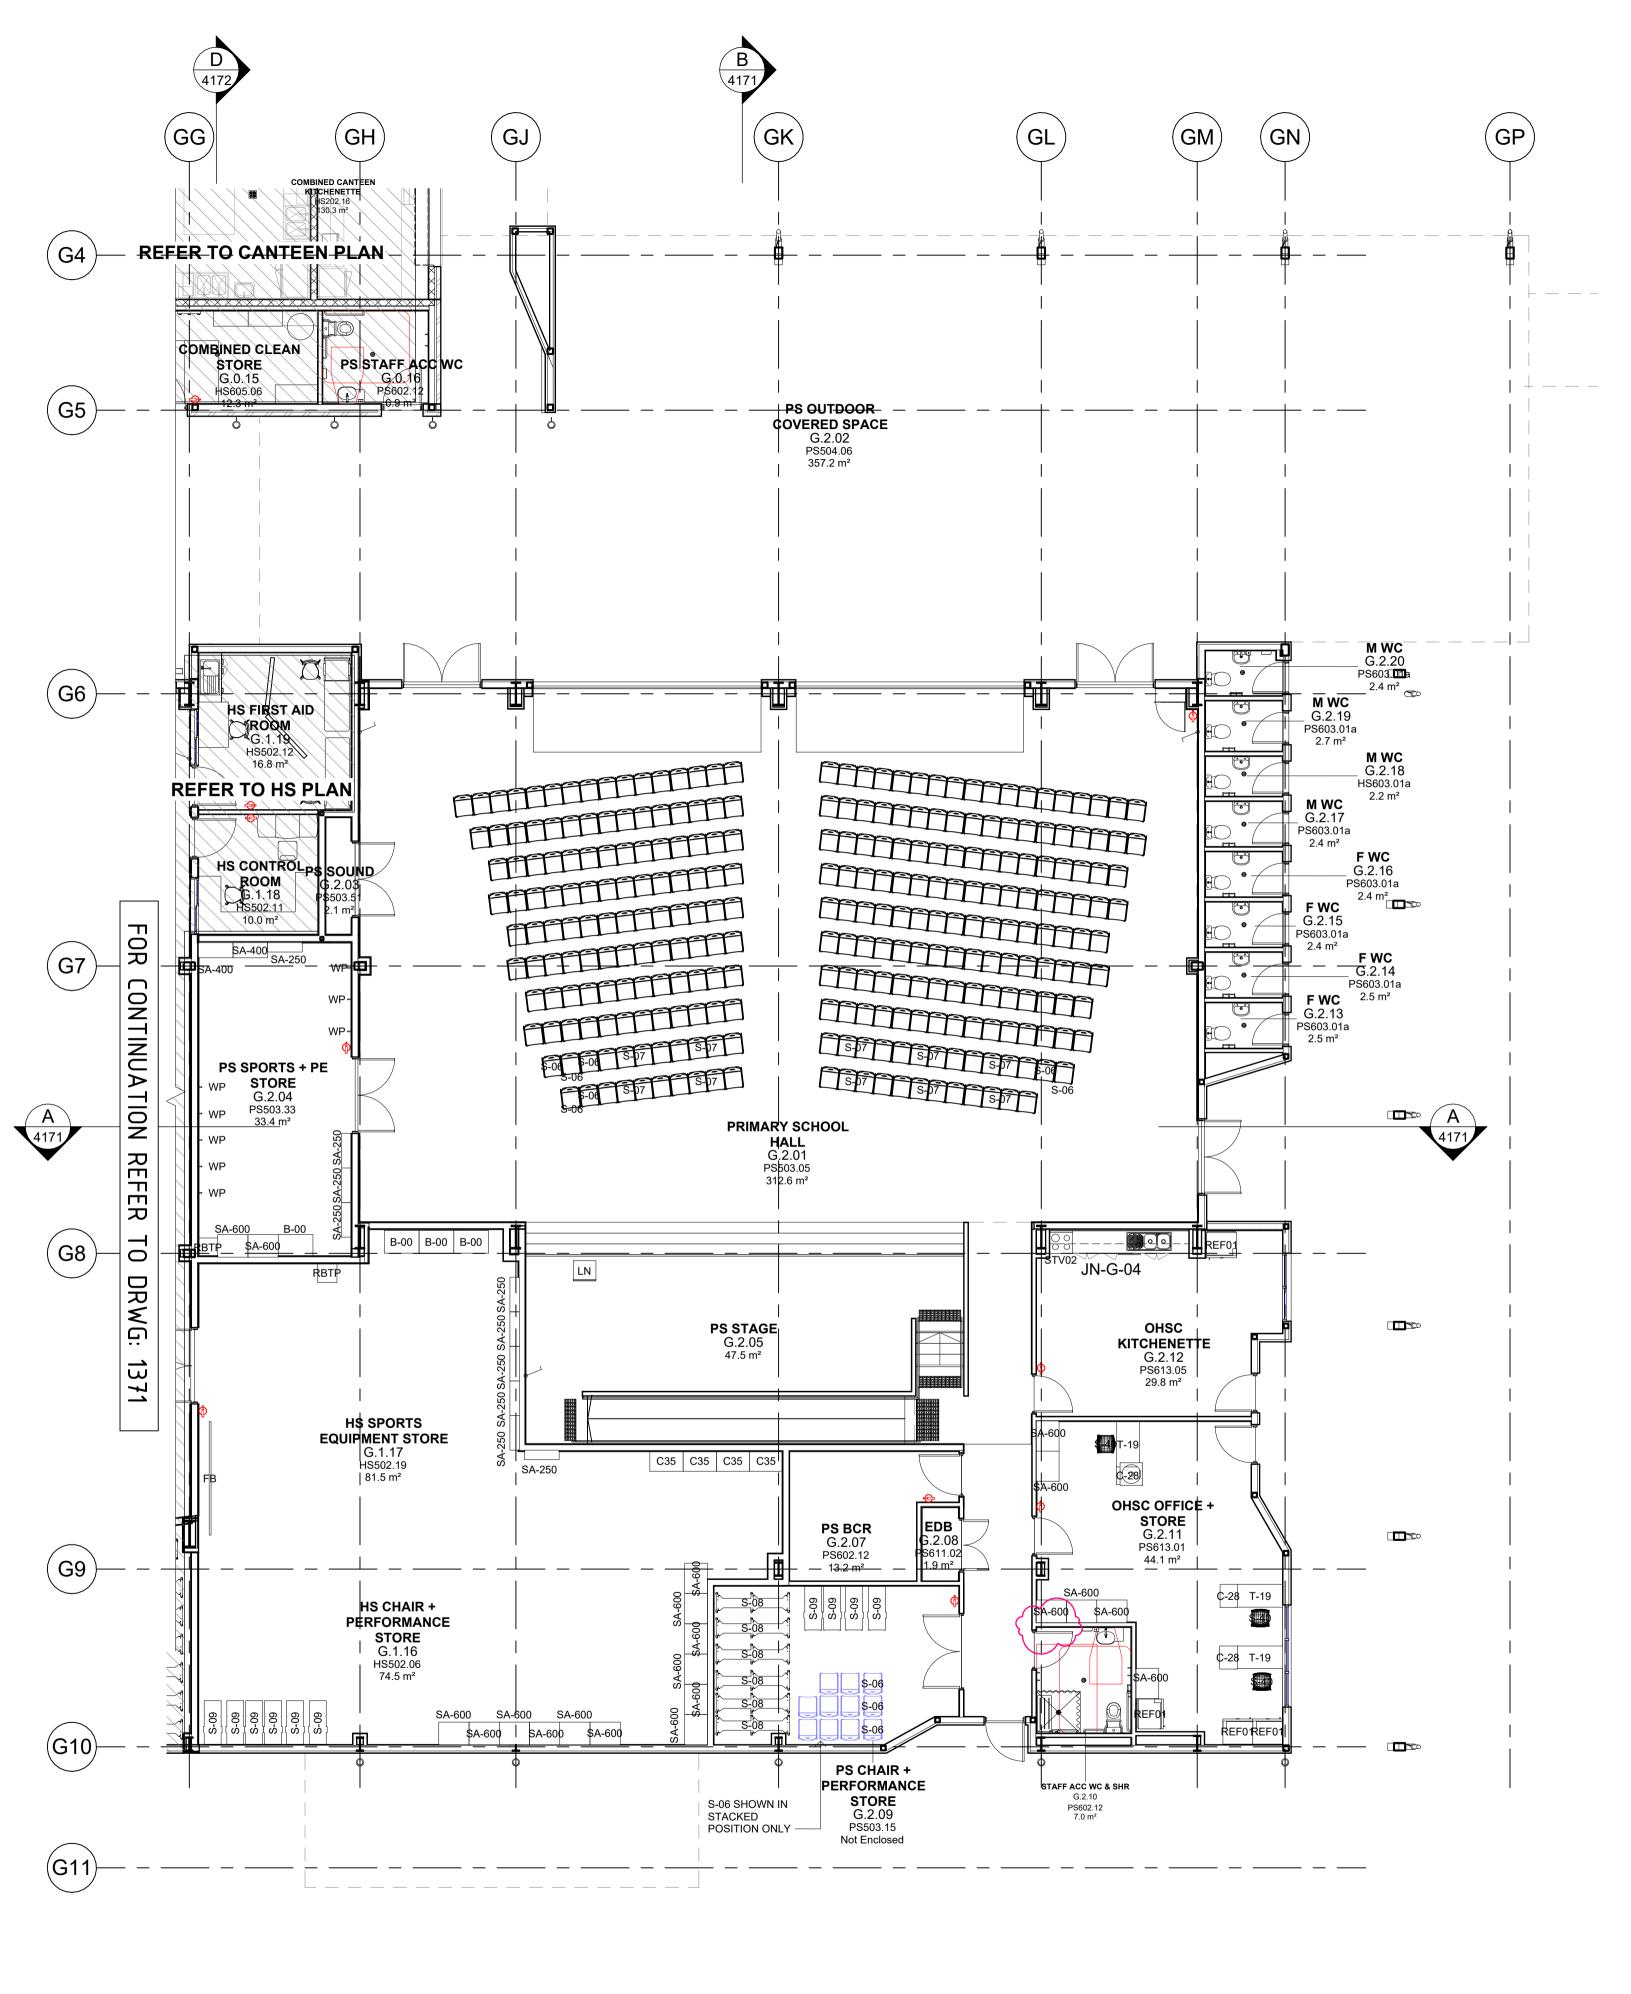


1 BLOCK G - GF FURNITURE PLAN - SOUTH

WP

CODE



LOCATION PLAN

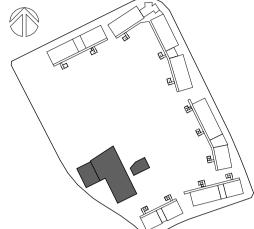

GENERAL NOTES

ROOM TAGS REFERENCE NEW HUB EFSG NUMBERS. REFER TO THE AREA SCHEDULES (0000 SERIES) TO RECONCILE EFSG WEBSITE INFORMATION.

PROVIDE GALVANISED SURFACE MOUNTED CONDUIT TO LIGHT FITTINGS THAT ARE MOUNTED TO THE UNDERSIDE OF CONCRETE SLAB AND UNDER CEILING TYPE CLG16 & CLG11.

REFER TO MECHANICAL & ELECTRICAL SERVICES DOCUMENTATION FOR THE QUANTITY & TYPES OF FITTINGS & FIXTURES. ALL EXPOSED STEEL TO EXTERNAL AREAS TO BE HOT DIPPED

GALVANISED.

REFER TO CIVIL AND LANDSCAPE ARCH DOCUMENTS FOR EXTERNAL WORKS.

FFE DISCLAIMER

1. ARCHITECTURAL DRAWINGS & MODEL ILLUSTRATE THE INTENDED COORDINATION OF STRUCTURES & SERVICES. DESIGN FINALISATION IS SUBJECT TO FUTURE COORDINATION WITH THE CONTRACTOR.

2. REFER TO MECHANICAL & ELECTRICAL SERVICES DOCUMENTATION FOR THE QUANTITY & TYPES OF FITTINGS & FIXTURES.

3. REFER TO THE RELEVANT ARCHITECTURAL & HYDRAULICS SERVICES DOCUMENTATION FOR THE QUANTITY & TYPES PLUMBING FITTINGS & FIXTURES.

DISCLAIMER

ALL DIMENSIONS SHOWN ON DRAWINGS ARE IN MILLIMETRES UNLESS OTHERWISE NOTED AND SHOULD BE VERIFIED ON SITE BEFORE COMMENCING BUILDING WORKS. DO NOT SCALE THIS DRAWING. THESE ARCHITECTURAL DRAWINGS ARE TO BE READ IN CONJUNCTION WITH THE BUILDING SPECIFICATION, TECHNICAL SHEETS AND CONSULTANT DRAWINGS. ANY DISCREPANCIES ARE TO BE REFERRED TO THE PROJECT ARCHITECT FOR CLARIFICATION PRIOR TO WORK COMMENCING.

lssu	-		
No.	Date	Description	Chkd
1	17.08.2023	Issue for 80% Design Development	EK
2	14.09.2023	Issue for 100% Design Development	EK
3	15.12.2023	Issue for Coordination	TP
4	21.12.2023	Issue for Draft CC4	TP
А	18.01.2024	Issue for CC4	DJ
В	25.01.2024	Issue for CC4	



Sydney61 2 9922 2344Any form of replication of this drawing in full or in part without the written
permission of NBRS+PARTNERS Pty Ltd constitutes an infringement of the
copyright.Nominated Architect:

Andrew Duffin NSW 5602 © 2023 NBRS & Partners Pty Ltd VIC 51197 ABN 16 002 247 565 Project

Melonba Education Campus

at


Cnr Elara Boulevard and Kaluta Avenue, Melonba. Lot 30 DP 1237735 for

SINSW

Drawing Title


BLOCK G - GF FURNITURE PLAN -SOUTH

FOR CONSTRUCTION

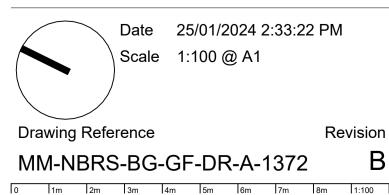

DESCRIPTION STORAGE TYPE

STORAGE TYPE FLOOR BATTENS LECTERN RACK FOR BATS - PRIMARY SCHOOL REFRIGERATOR CHAIR TYPE CHAIR TYPE CHAIR TYPE - TROLLEY CHAIR TYPE STORAGE TYPE STORAGE TYPE STORAGE TYPE FREESTANDING STOVE TABLE TYPE WALL PEG

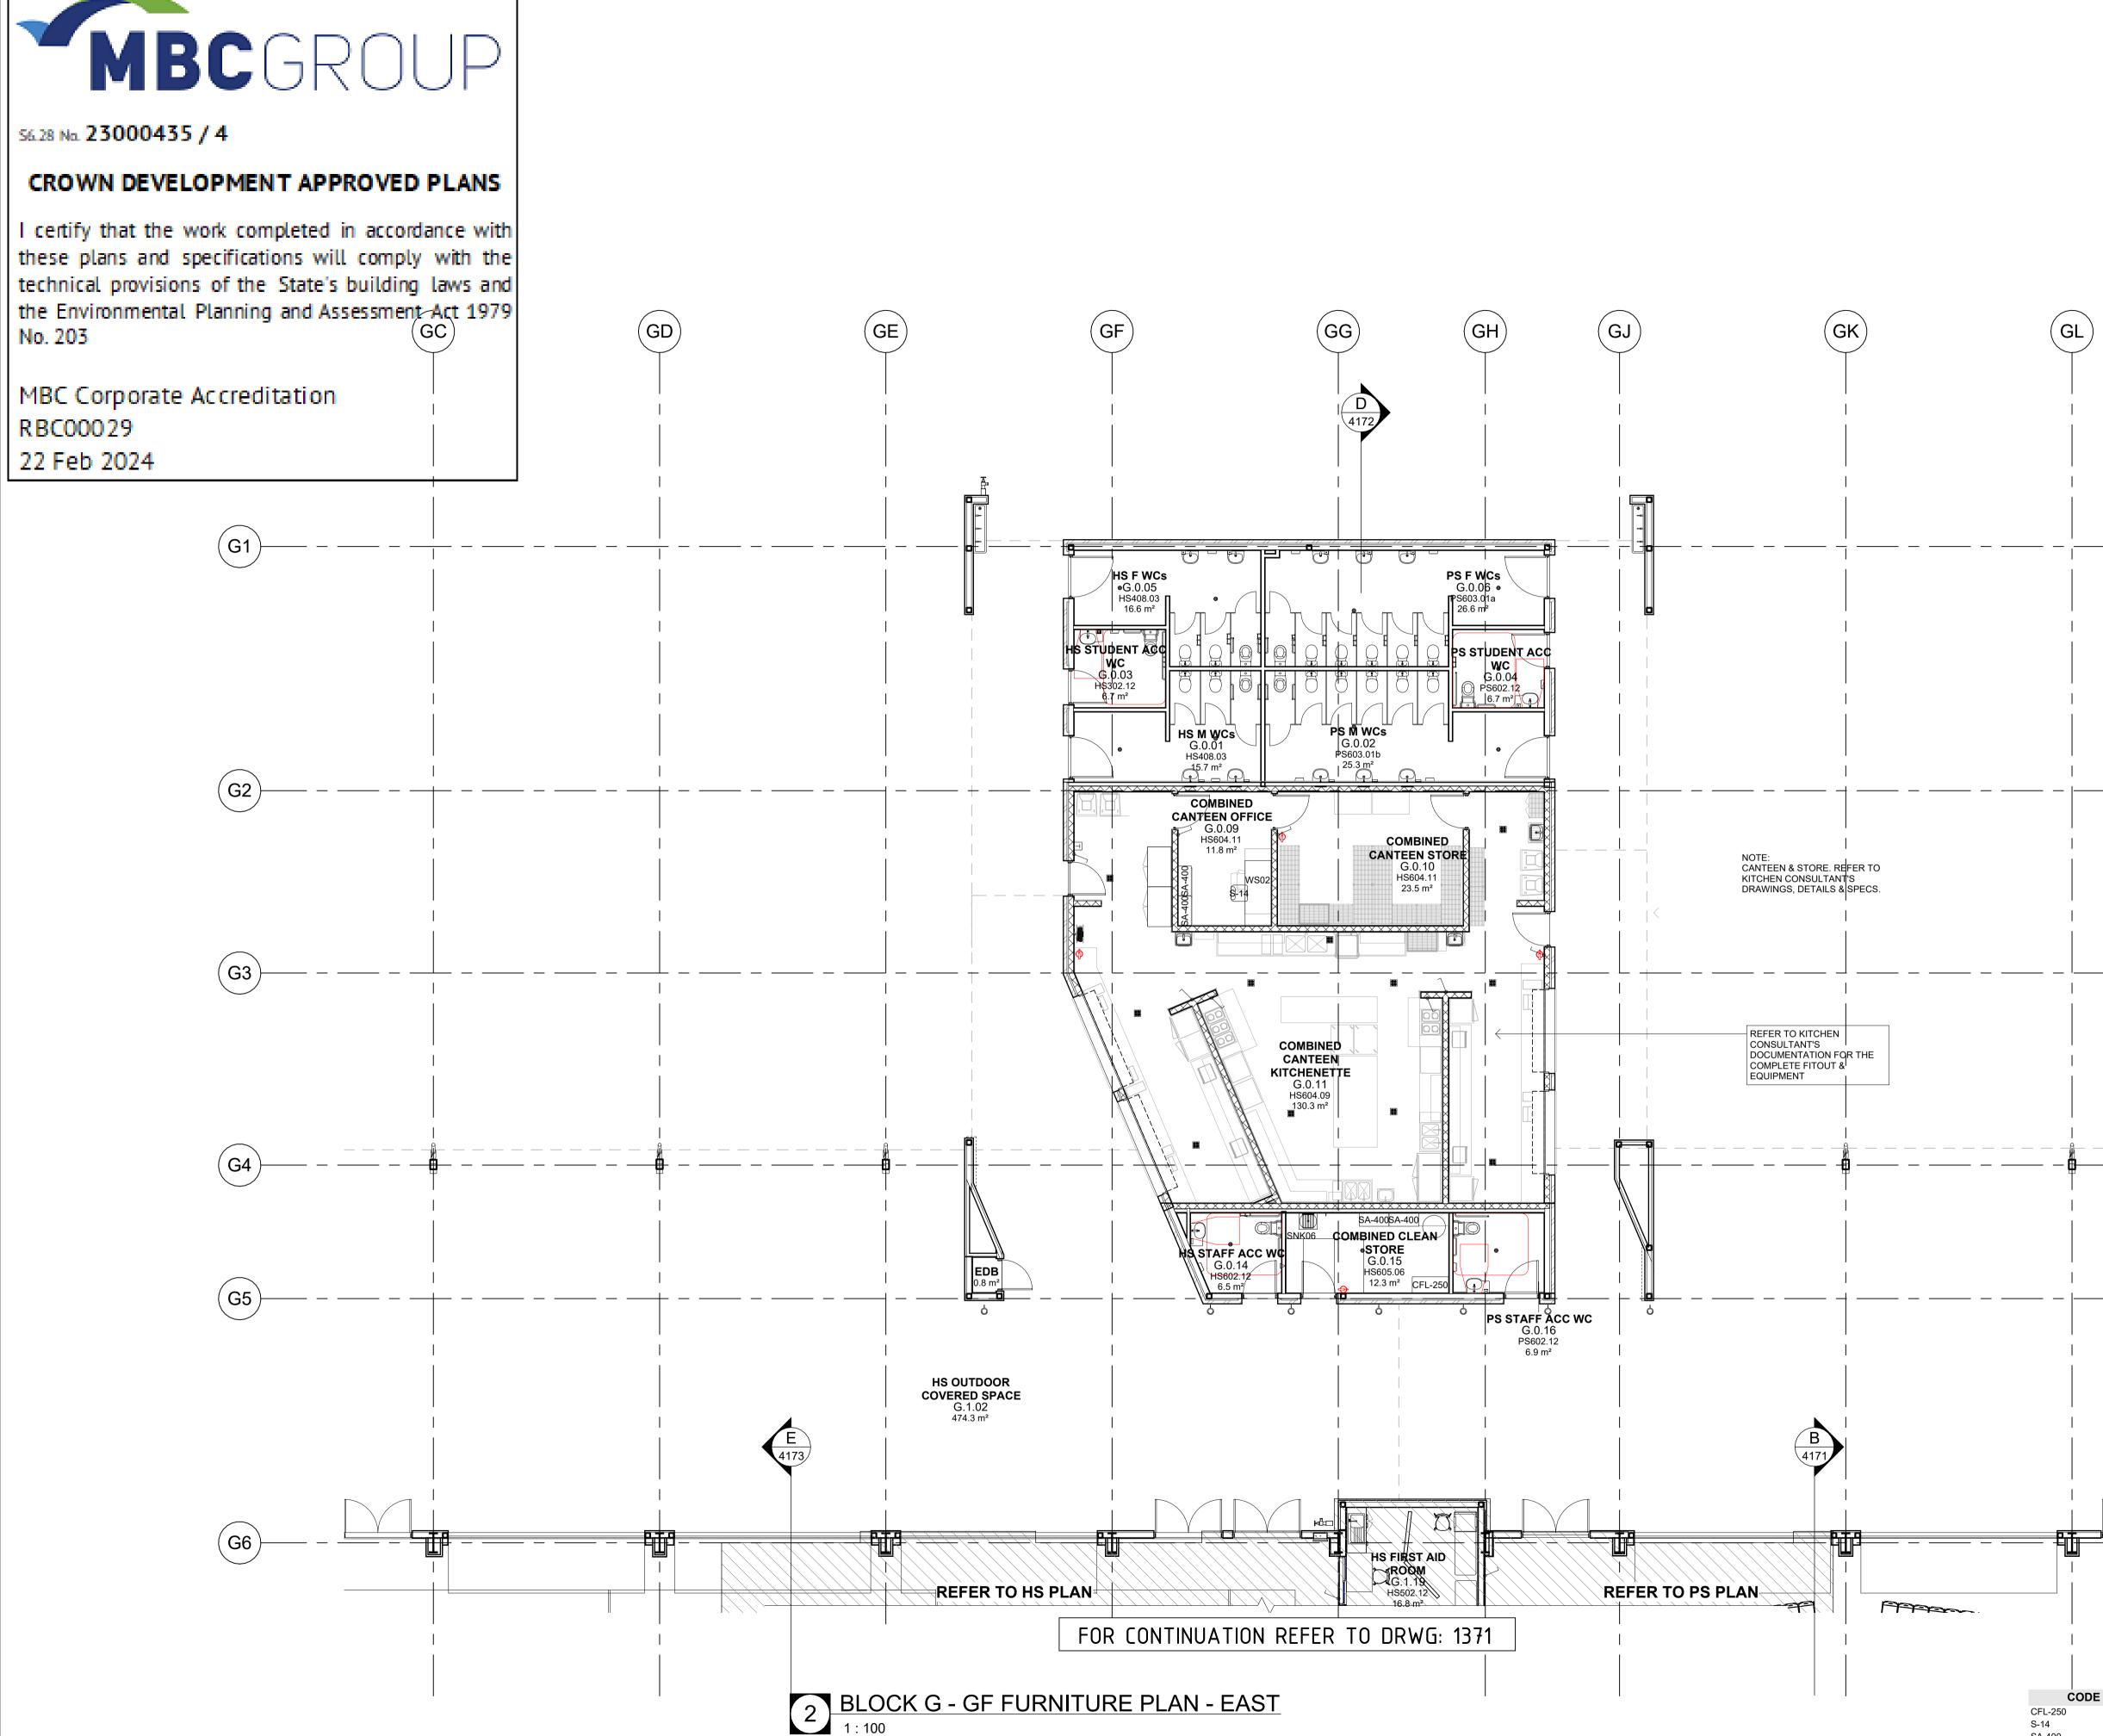


SA-400 SNK06

WS02



LOCATION PLAN

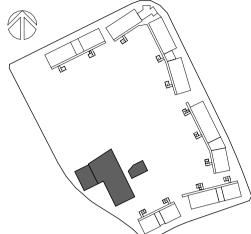

GENERAL NOTES

ROOM TAGS REFERENCE NEW HUB EFSG NUMBERS. REFER TO THE AREA SCHEDULES (0000 SERIES) TO RECONCILE EFSG WEBSITE INFORMATION.

PROVIDE GALVANISED SURFACE MOUNTED CONDUIT TO LIGHT FITTINGS THAT ARE MOUNTED TO THE UNDERSIDE OF CONCRETE SLAB AND UNDER CEILING TYPE CLG16 & CLG11.

REFER TO MECHANICAL & ELECTRICAL SERVICES DOCUMENTATION FOR THE QUANTITY & TYPES OF FITTINGS & FIXTURES. ALL EXPOSED STEEL TO EXTERNAL AREAS TO BE HOT DIPPED

GALVANISED. REFER TO CIVIL AND LANDSCAPE ARCH DOCUMENTS FOR EXTERNA

WORKS

FFE DISCLAIMER

1. ARCHITECTURAL DRAWINGS & MODEL ILLUSTRATE THE INTENDED COORDINATION OF STRUCTURES & SERVICES. DESIGN FINALISATION IS SUBJECT TO FUTURE COORDINATION WITH THE CONTRACTOR.

2. REFER TO MECHANICAL & ELECTRICAL SERVICES DOCUMENTATION FOR THE QUANTITY & TYPES OF FITTINGS & FIXTURES.

3. REFER TO THE RELEVANT ARCHITECTURAL & HYDRAULICS SERVICES DOCUMENTATION FOR THE QUANTITY & TYPES PLUMBING FITTINGS & FIXTURES.

DISCLAIMER

ALL DIMENSIONS SHOWN ON DRAWINGS ARE IN MILLIMETRES UNLESS OTHERWISE NOTED AND SHOULD BE VERIFIED ON SITE BEFORE COMMENCING BUILDING WORKS. DO NOT SCALE THIS DRAWING. THESE ARCHITECTURAL DRAWINGS ARE TO BE READ IN CONJUNCTION WITH THE BUILDING SPECIFICATION, TECHNICAL SHEETS AND CONSULTANT DRAWINGS. ANY DISCREPANCIES ARE TO BE REFERRED TO THE PROJECT ARCHITECT FOR CLARIFICATION PRIOR TO WORK COMMENCING.

lssu _{No.}	e Date	Description	Chkd
1 2 3 4 A	17.08.2023 14.09.2023 15.12.2023 21.12.2023 18.01.2024	Issue for 80% Design Development Issue for 100% Design Development Issue for Coordination Issue for Draft CC4 Issue for CC4	EK EK TP TP DJ

Architect **NBRS**

61 2 9922 2344 Any form of replication of this drawing in full or in part without the written permission of NBRS+PARTNERS Pty Ltd constitutes an infringement of the copyright.

Nominated Architect: Andrew Duffin NSW 5602 © 2023 ABN 16 002 247 565 NBRS & Partners Pty Ltd VIC 51197 Project

nbrsarchitecture.com

Melonba Education Campus


Cnr Elara Boulevard and Kaluta Avenue, Melonba. Lot 30 DP 1237735 for

SINSW

Drawing Title


BLOCK G - GF FURNITURE PLAN -EAST

FOR CONSTRUCTION

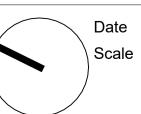

Drawing Reference

18/01/2024 5:11:27 PM Scale 1:100 @ A1

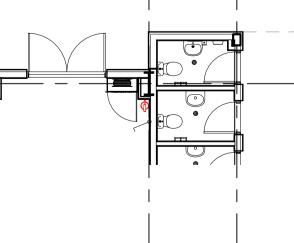

(GM)

(GN)

DESCRIPTION STORAGE TYPE CHAIR TYPE STORAGE TYPE SINK TYPE 06 - CLEANERS WORKSTATION TYPE

Revision

MM-NBRS-BG-GF-DR-A-1373 Α 0 1m 2m 3m 4m 5m 6m 7m 8m 1:100




56.28 No. 23000435 / 4

CROWN DEVELOPMENT APPROVED PLANS


I certify that the work completed in accordance with these plans and specifications will comply with the technical provisions of the State's building laws and the Environmental Planning and Assessment Act 1979 No. 203

MBC Corporate Accreditation RBC00029 22 Feb 2024

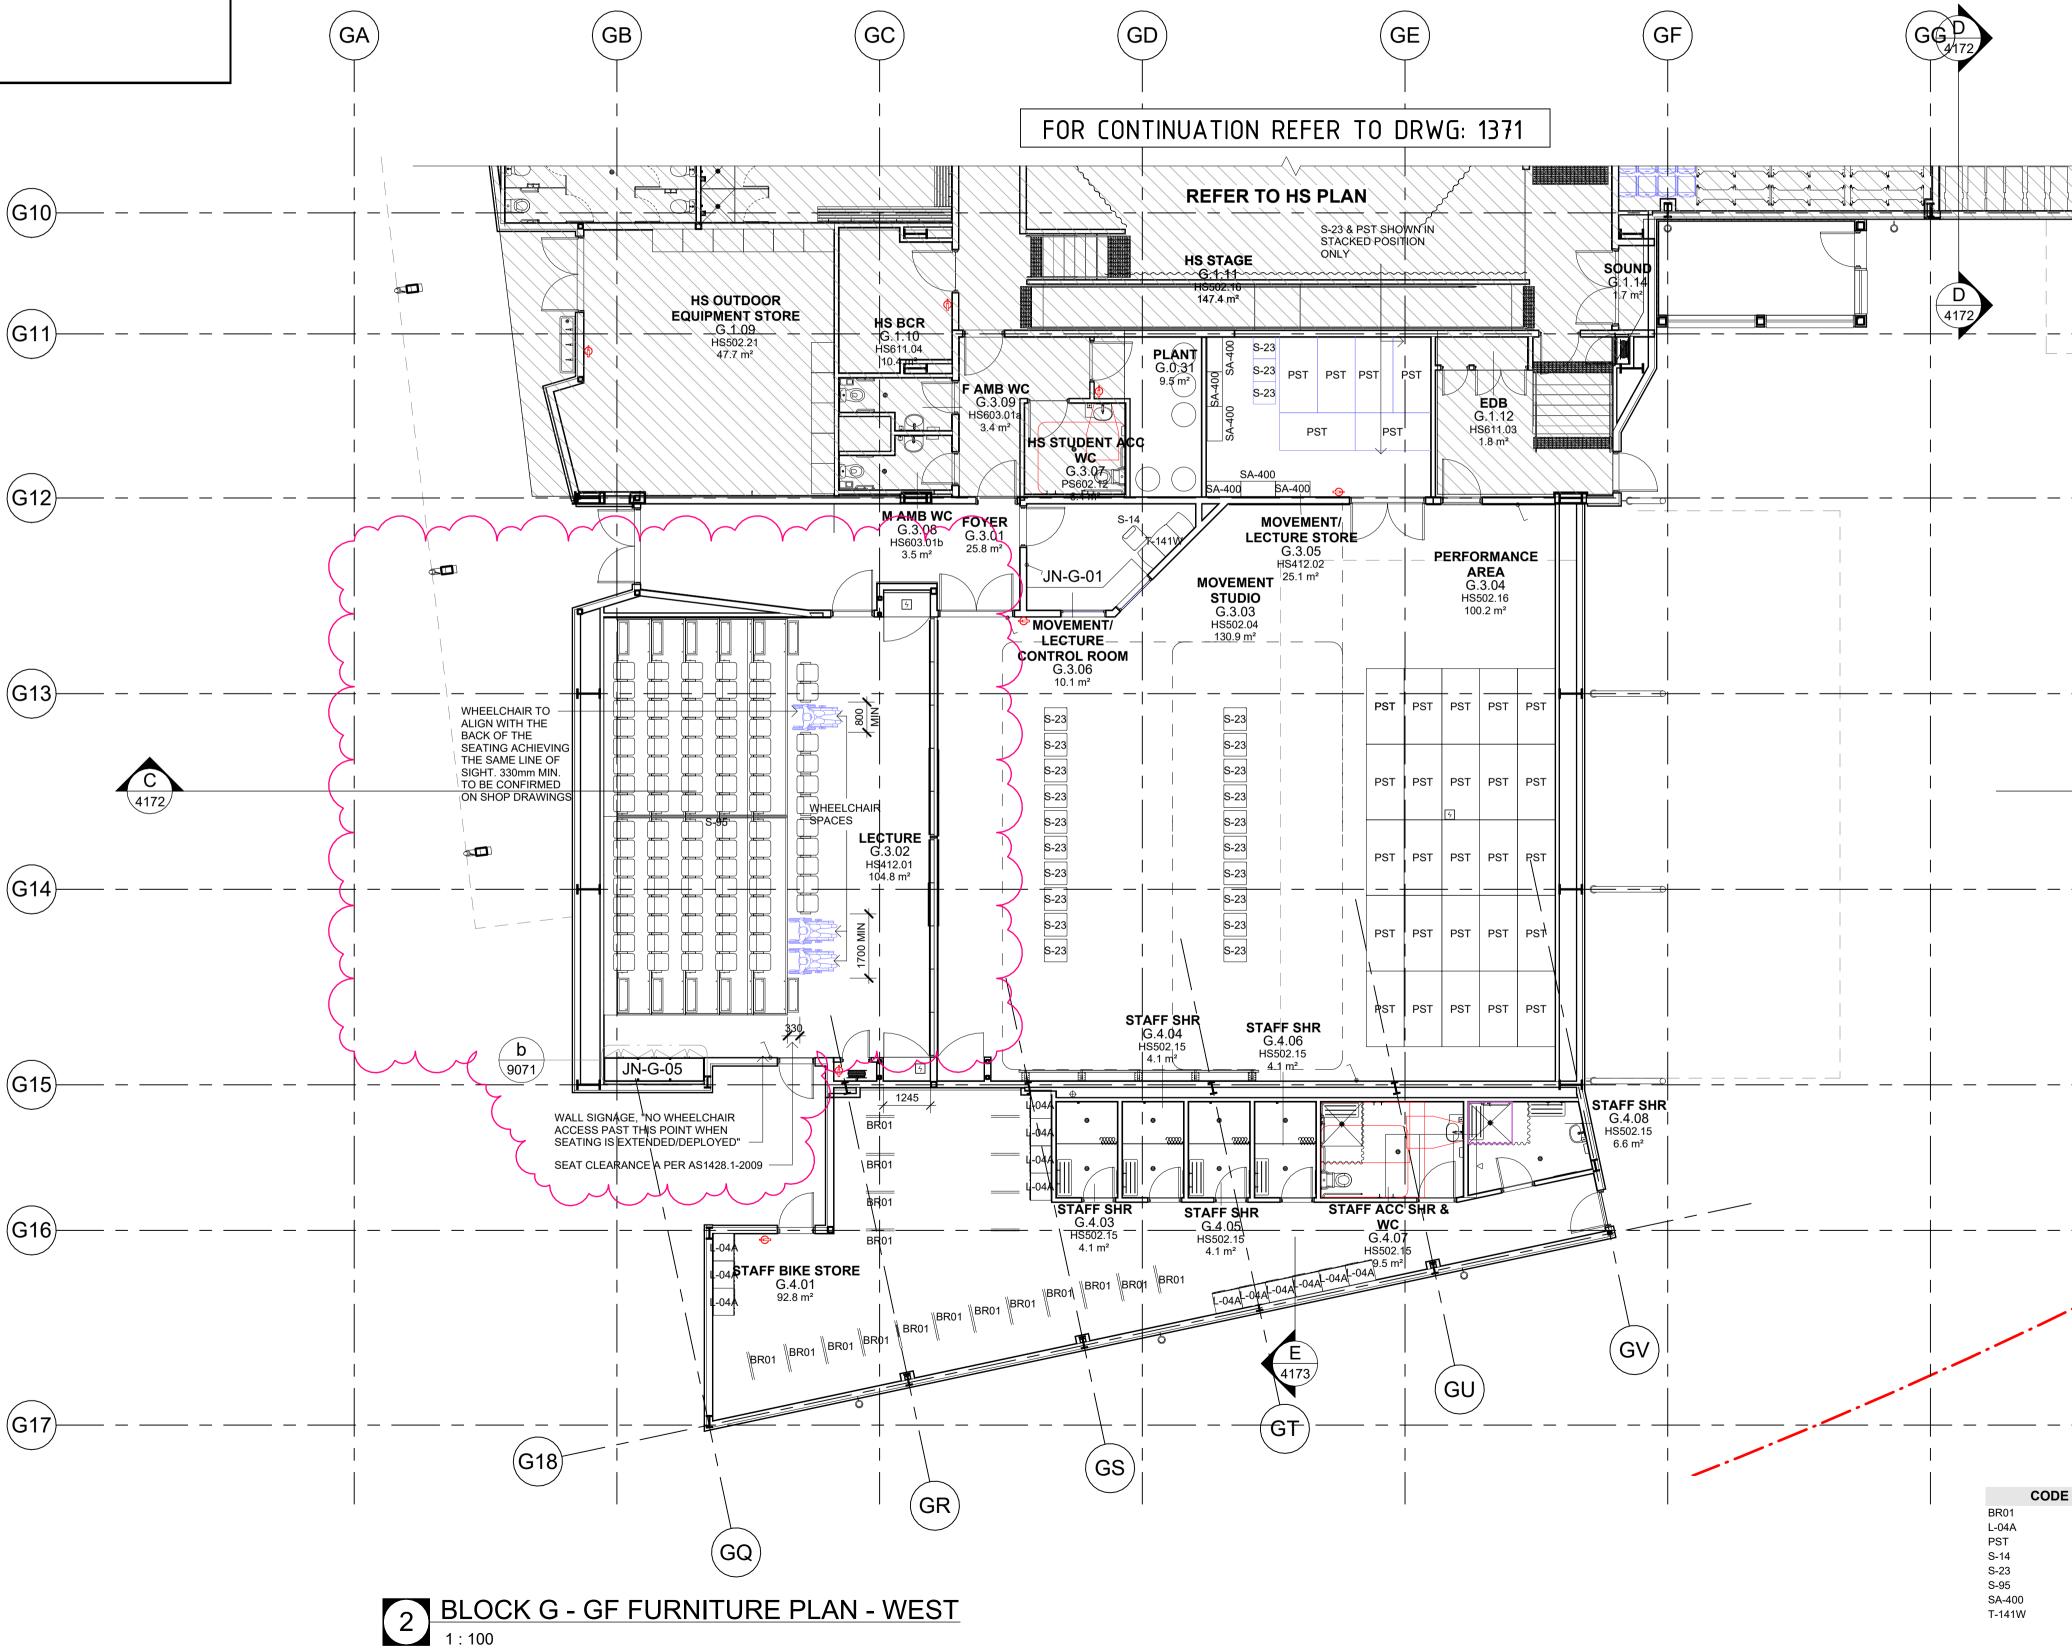



LOCATION PLAN

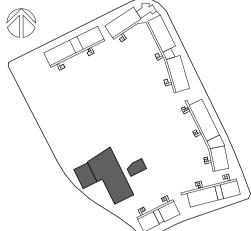

GENERAL NOTES

(GH

ROOM TAGS REFERENCE NEW HUB EFSG NUMBERS. REFER TO THE AREA SCHEDULES (0000 SERIES) TO RECONCILE EFSG WEBSITE INFORMATION.

PROVIDE GALVANISED SURFACE MOUNTED CONDUIT TO LIGHT FITTINGS THAT ARE MOUNTED TO THE UNDERSIDE OF CONCRETE SLAB AND UNDER CEILING TYPE CLG16 & CLG11.

REFER TO MECHANICAL & ELECTRICAL SERVICES DOCUMENTATION FOR THE QUANTITY & TYPES OF FITTINGS & FIXTURES. ALL EXPOSED STEEL TO EXTERNAL AREAS TO BE HOT DIPPED

GALVANISED.

REFER TO CIVIL AND LANDSCAPE ARCH DOCUMENTS FOR EXTERNAL WORKS

FFE DISCLAIMER

1. ARCHITECTURAL DRAWINGS & MODEL ILLUSTRATE THE INTENDED COORDINATION OF STRUCTURES & SERVICES. DESIGN FINALISATION IS SUBJECT TO FUTURE COORDINATION WITH THE CONTRACTOR.

2. REFER TO MECHANICAL & ELECTRICAL SERVICES DOCUMENTATION FOR THE QUANTITY & TYPES OF FITTINGS & FIXTURES.

3. REFER TO THE RELEVANT ARCHITECTURAL & HYDRAULICS SERVICES DOCUMENTATION FOR THE QUANTITY & TYPES PLUMBING FITTINGS & FIXTURES.

DISCLAIMER

(C)

\4172/

ALL DIMENSIONS SHOWN ON DRAWINGS ARE IN MILLIMETRES UNLESS OTHERWISE NOTED AND SHOULD BE VERIFIED ON SITE BEFORE COMMENCING BUILDING WORKS. DO NOT SCALE THIS DRAWING, THESE ARCHITECTURAL DRAWINGS ARE TO BE READ IN CONJUNCTION WITH THE BUILDING SPECIFICATION, TECHNICAL SHEETS AND CONSULTANT DRAWINGS. ANY DISCREPANCIES ARE TO BE REFERRED TO THE PROJECT ARCHITECT FOR CLARIFICATION PRIOR TO WORK COMMENCING.

-			
lssu _{No.}	e Date	Description	Chkd
INO.	Date	Description	Cliku
1	17.08.2023	Issue for 80% Design Development	EK
2	14.09.2023	Issue for 100% Design Development	EK
3	20.09.2023	Issue with DDA Updates	EK
4	15.12.2023	Issue for Coordination	TP
5	21.12.2023	Issue for Draft CC4	TP
А	18.01.2024	Issue for CC4	DJ
В	25.01.2024	Issue for CC4	

Architect NBRS

61 2 9922 2344 Any form of replication of this drawing in full or in part without the written permission of NBRS+PARTNERS Pty Ltd constitutes an infringement of the copyright.

Nominated Architect: Andrew Duffin NSW 5602 © 2023 ABN 16 002 247 565 NBRS & Partners Pty Ltd VIC 51197 Project

Melonba Education Campus

Cnr Elara Boulevard and Kaluta Avenue, Melonba. Lot 30 DP 1237735 for

SINSW

Drawing Title

BLOCK G - GF FURNITURE PLAN -WEST

FOR CONSTRUCTION

Drawing Reference

Date 25/01/2024 2:33:30 PM Scale 1:100 @ A1


Revision

nbrsarchitecture.com


В MM-NBRS-BG-GF-DR-A-1374 0 1m 2m 3m 4m 5m 6m 7m 8m 1:100

DESCRIPTION **BIKE RACK**

STORAGE TYPE - STAFF PORTABLE STAGE CHAIR TYPE UTILITY BLOCK CHAIR TYPE - RETRACTABLE STORAGE TYPE TABLE TYPE

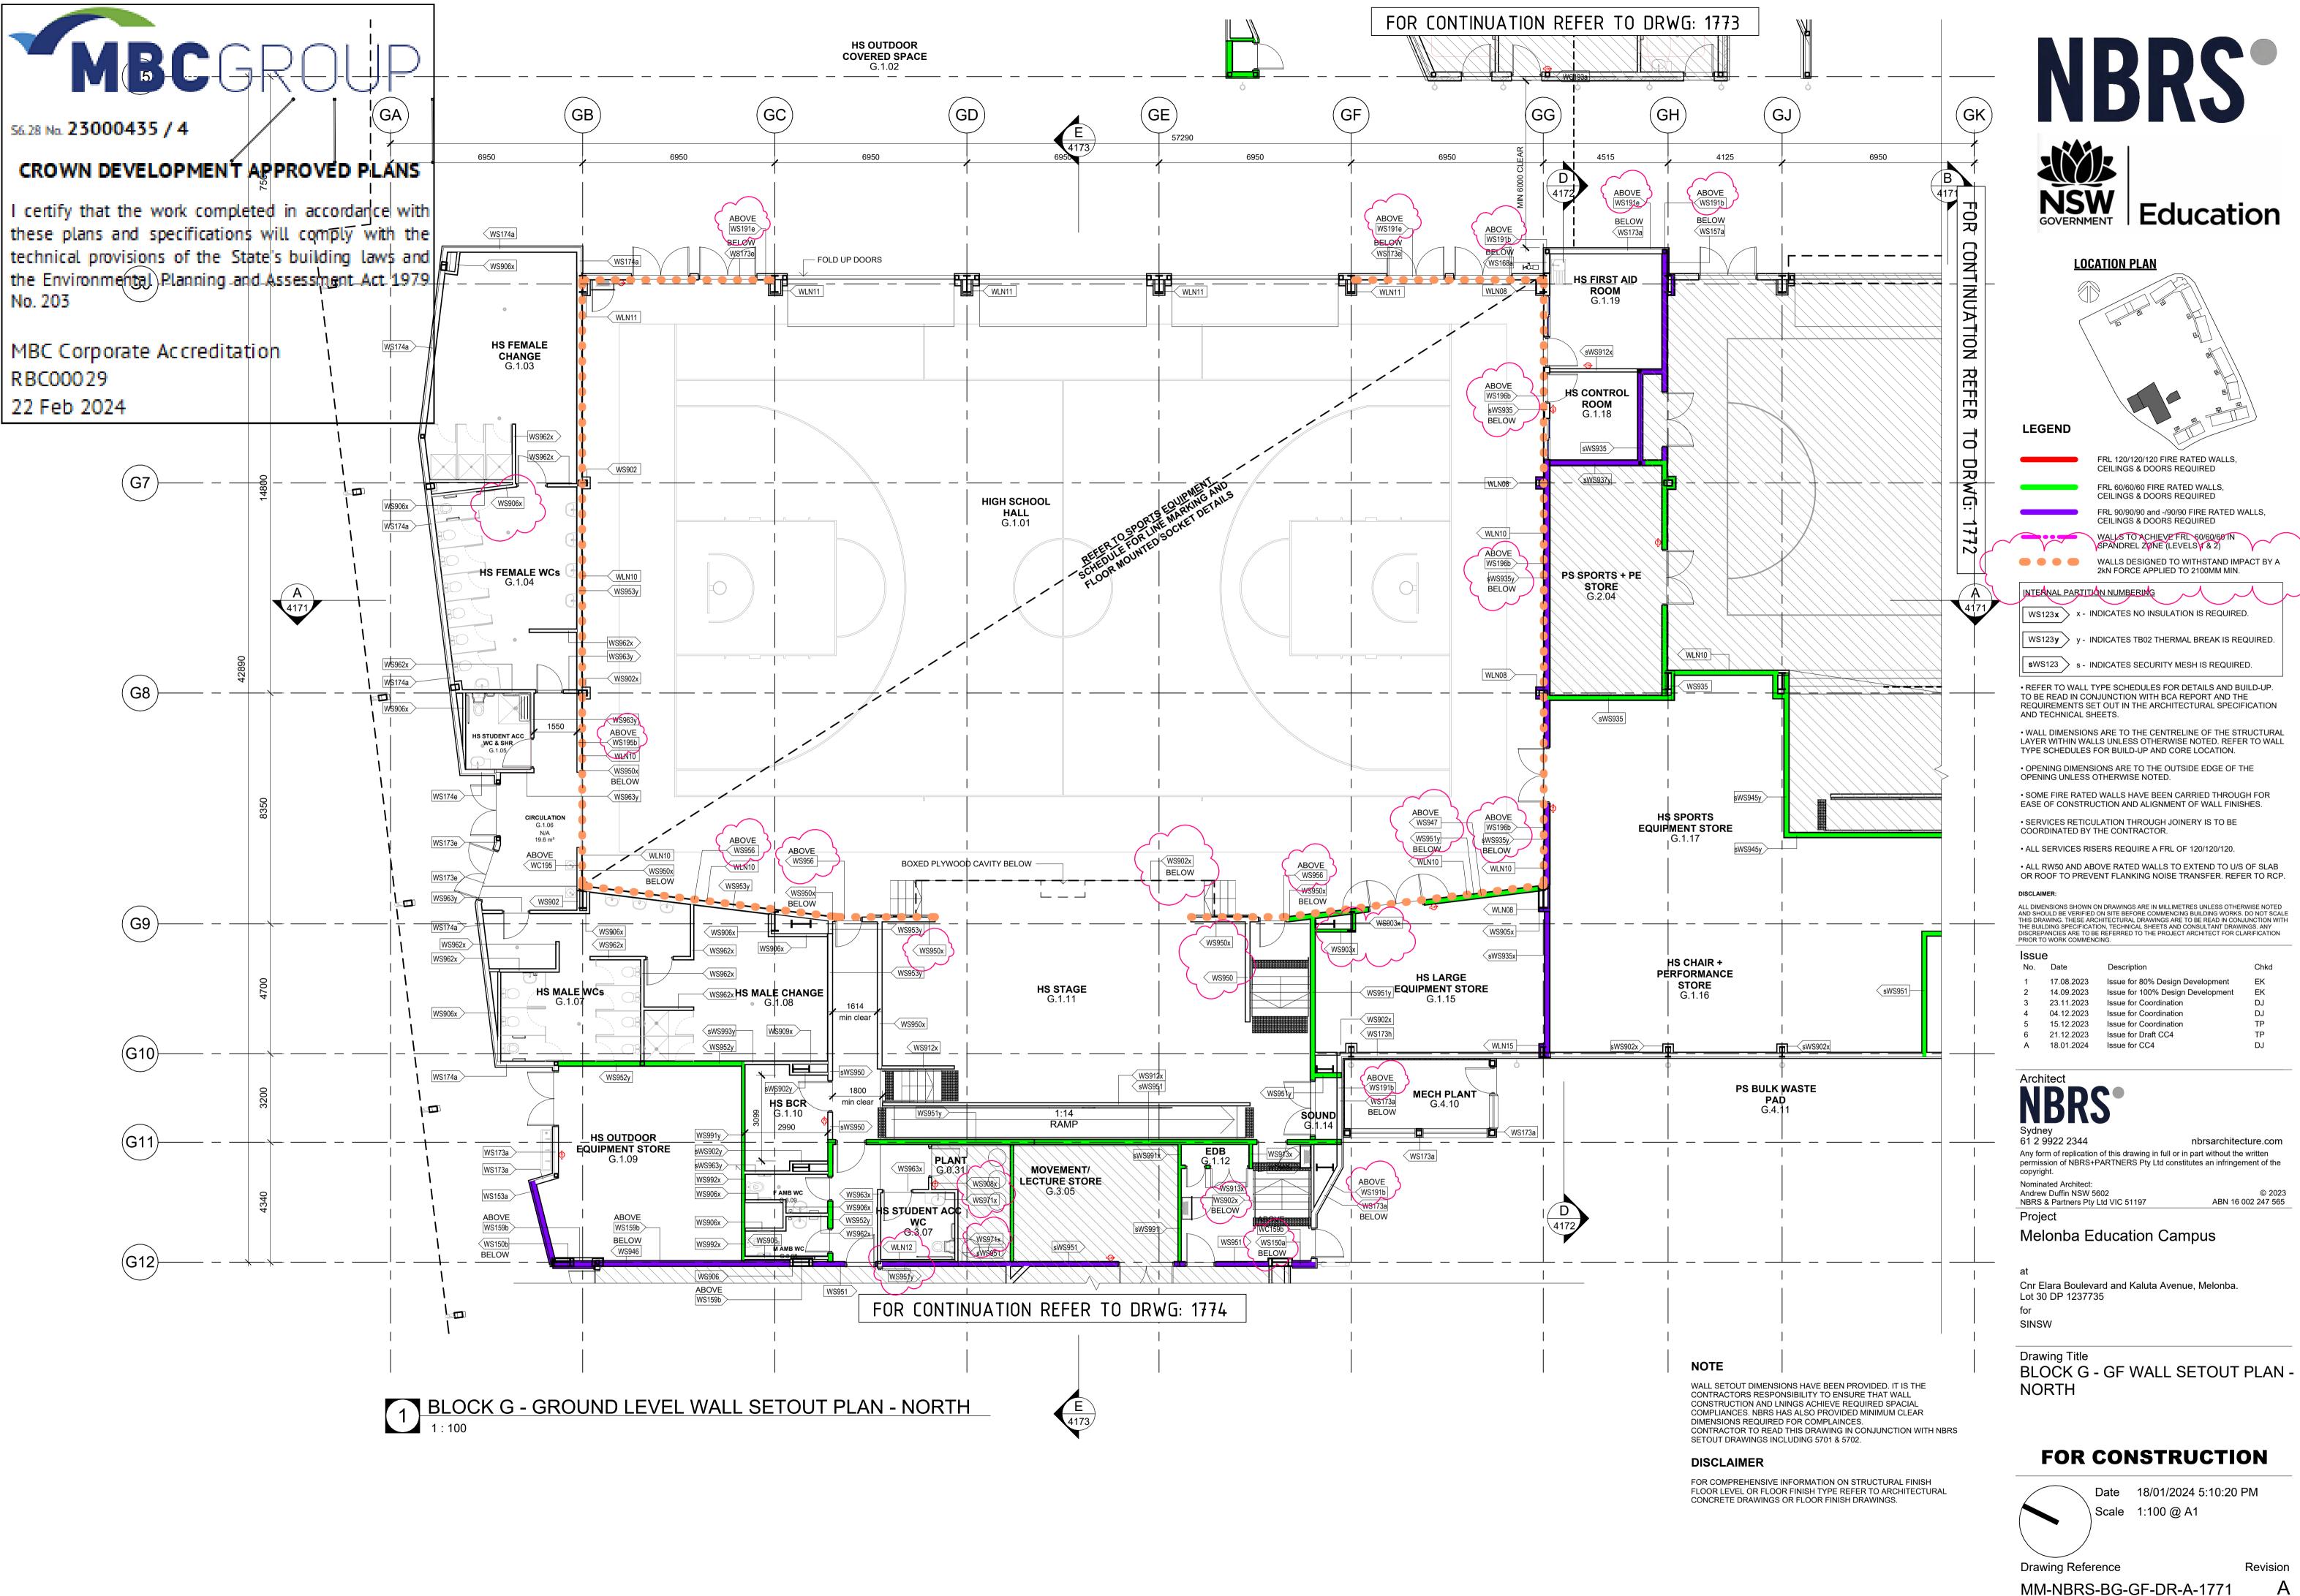

0 1m 2m 3m 4m 5m 6m 7m 8m 1:100

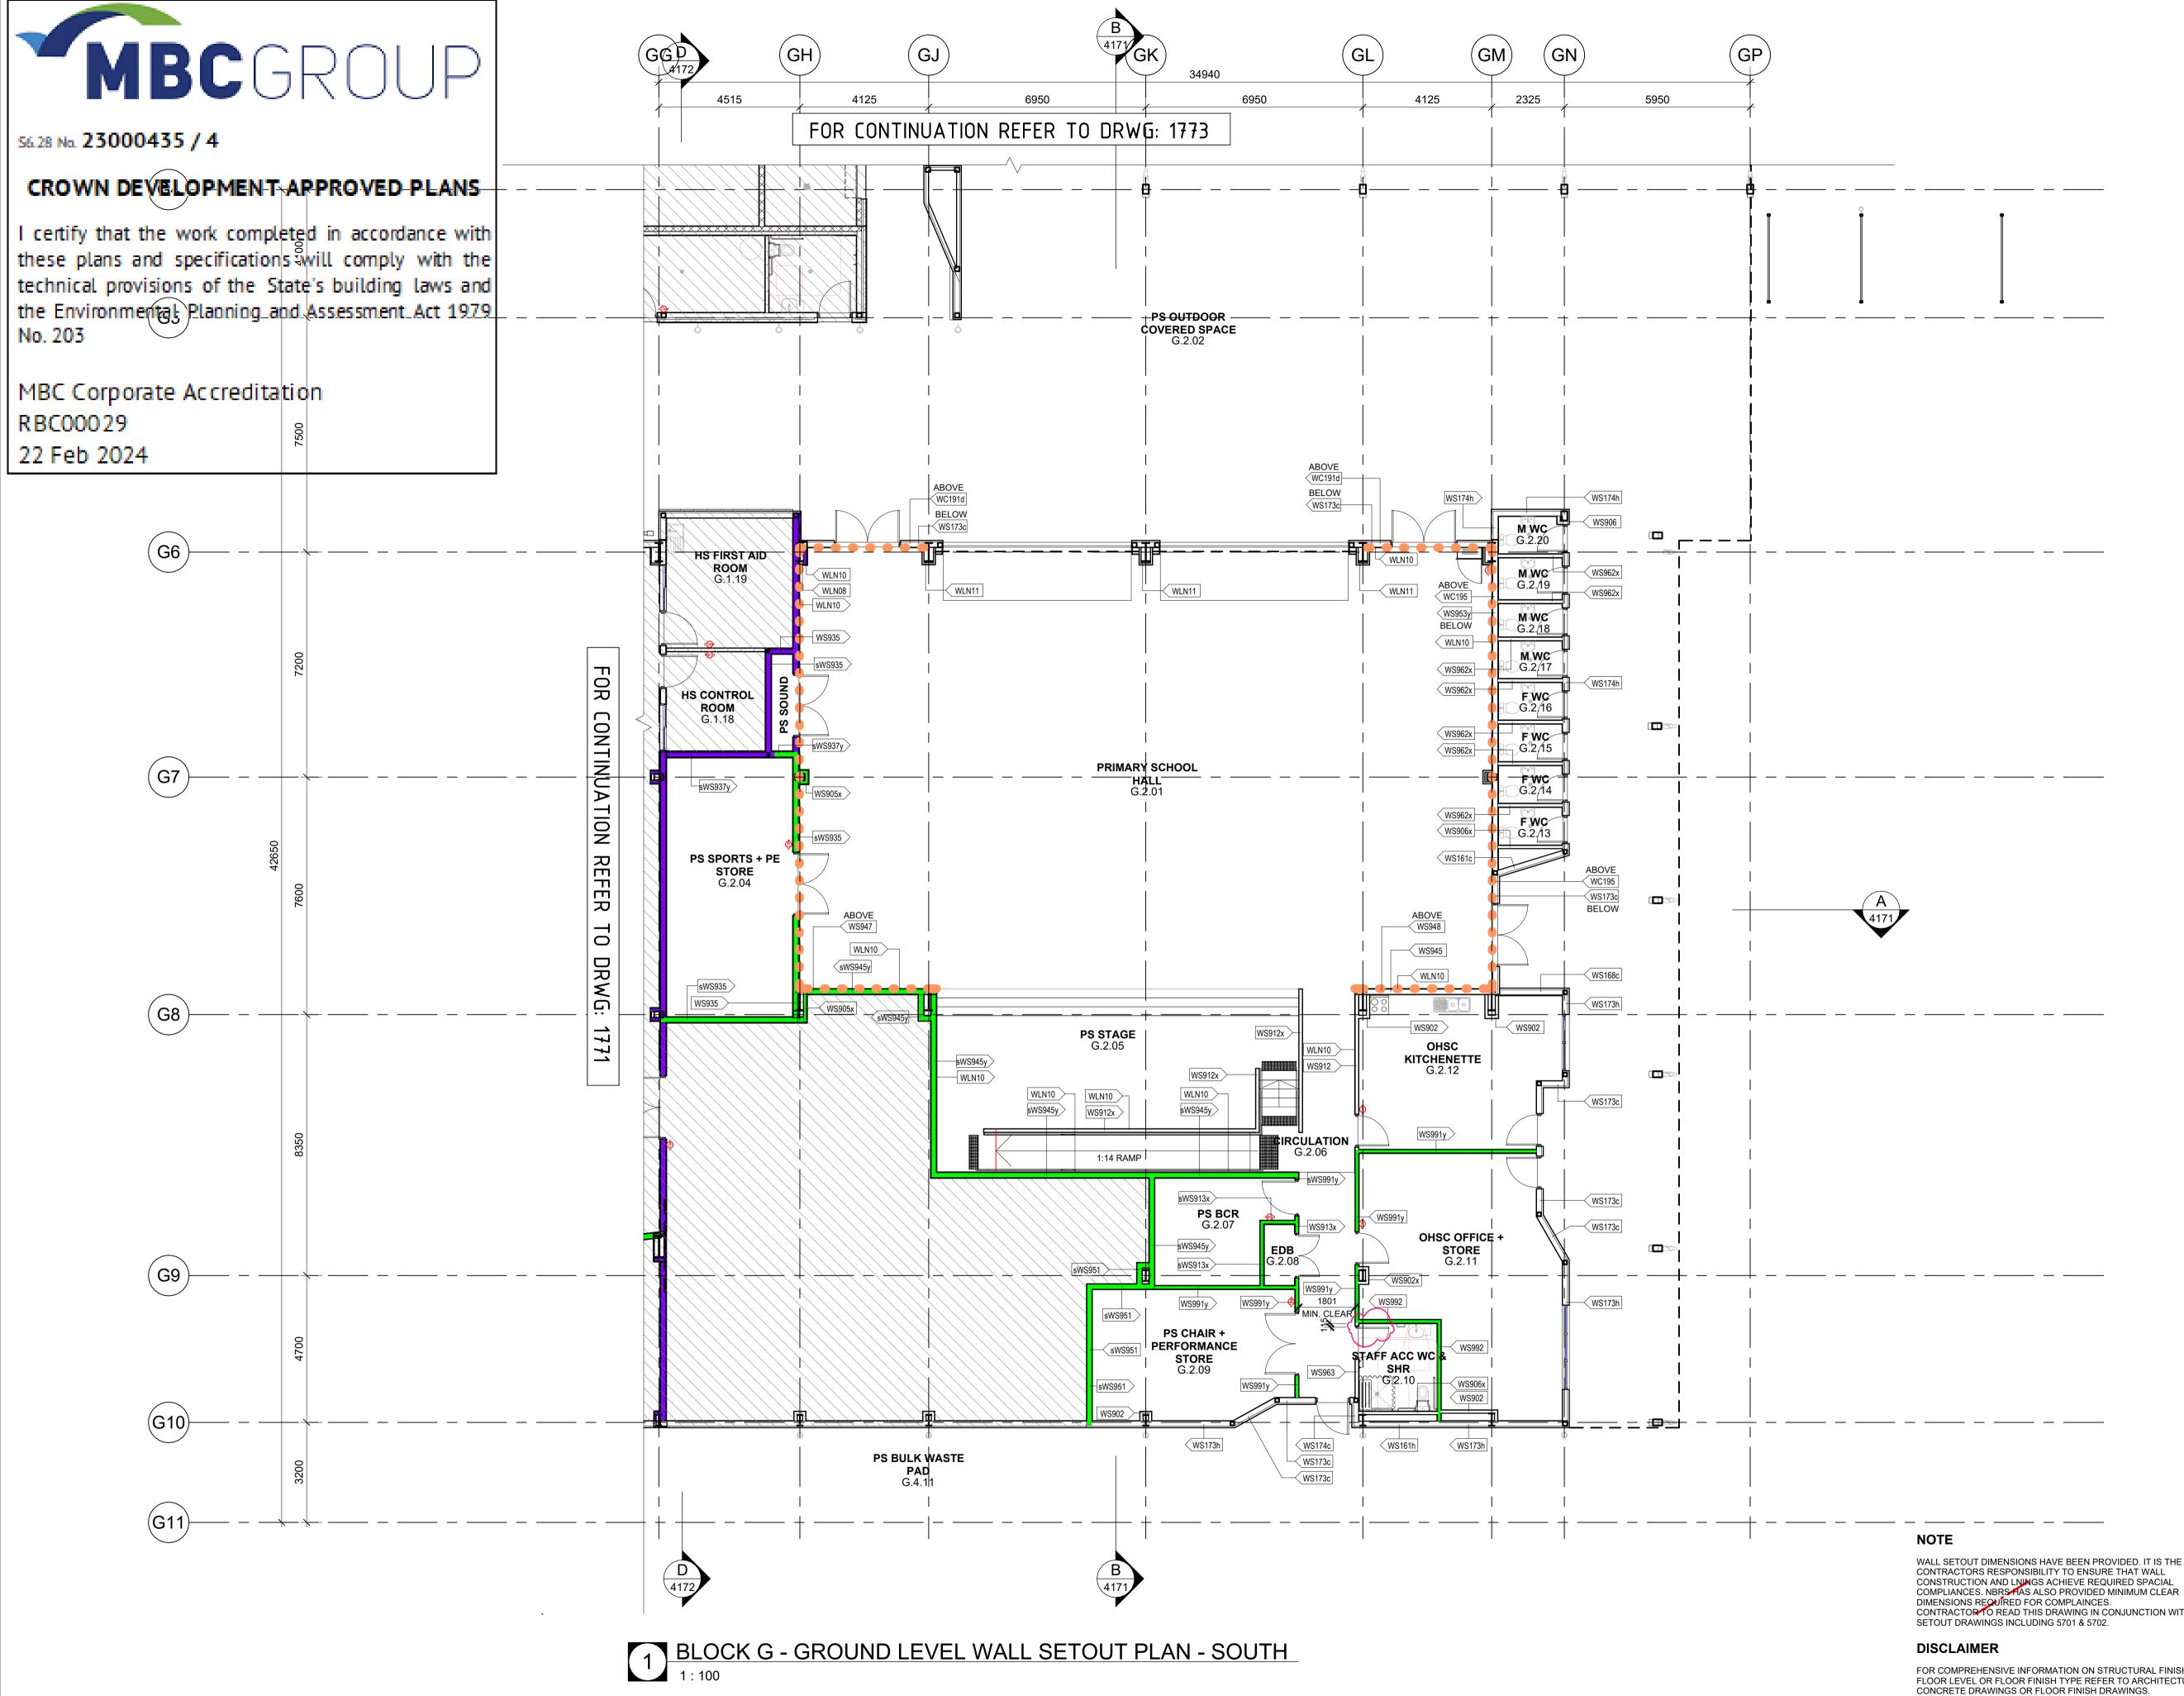

FOR COMPREHENSIVE INFORMATION ON STRUCTURAL FINISH FLOOR LEVEL OR FLOOR FINISH TYPE REFER TO ARCHITECTURAL CONCRETE DRAWINGS OR FLOOR FINISH DRAWINGS.



LOCATION PLAN

D	

LEGEND

WALLS DESIGNED TO WITHSTAND IMPACT BY 2kN FORCE APPLIED TO 2100MM MIN.
 WALLS TO ACHIEVE FRL 60/60/60 IN SPANDREL ZONE (LEVELS 1 & 2)
FRL 90/90/90 and -/90/90 FIRE RATED WALLS, CEILINGS & DOORS REQUIRED
 FRL 60/60/60 FIRE RATED WALLS, CEILINGS & DOORS REQUIRED
FRL 120/120/120 FIRE RATED WALLS, CEILINGS & DOORS REQUIRED
\checkmark

INTERNAL PARTITION NUMBERING

× - INDICATES NO INSULATION IS REQUIRED. WS123x >

WS123**y** - INDICATES TB02 THERMAL BREAK IS REQUIRED.

sWS123 > s - INDICATES SECURITY MESH IS REQUIRED.

REFER TO WALL TYPE SCHEDULES FOR DETAILS AND BUILD-UP TO BE READ IN CONJUNCTION WITH BCA REPORT AND THE REQUIREMENTS SET OUT IN THE ARCHITECTURAL SPECIFICATION AND TECHNICAL SHEETS.

• WALL DIMENSIONS ARE TO THE CENTRELINE OF THE STRUCTURAL LAYER WITHIN WALLS UNLESS OTHERWISE NOTED. REFER TO WALL TYPE SCHEDULES FOR BUILD-UP AND CORE LOCATION.

• OPENING DIMENSIONS ARE TO THE OUTSIDE EDGE OF THE OPENING UNLESS OTHERWISE NOTED.

• SOME FIRE RATED WALLS HAVE BEEN CARRIED THROUGH FOR EASE OF CONSTRUCTION AND ALIGNMENT OF WALL FINISHES.

• SERVICES RETICULATION THROUGH JOINERY IS TO BE COORDINATED BY THE CONTRACTOR

• ALL SERVICES RISERS REQUIRE A FRL OF 120/120/120.

• ALL RW50 AND ABOVE RATED WALLS TO EXTEND TO U/S OF SLAB OR ROOF TO PREVENT FLANKING NOISE TRANSFER. REFER TO RCP

DISCLAIMER

ALL DIMENSIONS SHOWN ON DRAWINGS ARE IN MILLIMETRES UNLESS OTHERWISE NOTED AND SHOULD BE VERIFIED ON SITE BEFORE COMMENCING BUILDING WORKS. DO NOT SCALE THIS DRAWING. THESE ARCHITECTURAL DRAWINGS ARE TO BE READ IN CONJUNCTION WITH THE BUILDING SPECIFICATION, TECHNICAL SHEETS AND CONSULTANT DRAWINGS. ANY DISCREPANCIES ARE TO BE REFERRED TO THE PROJECT ARCHITECT FOR CLARIFICATION PRIOR TO WORK COMMENCING.

su	е	
0.	Date	Description
	17.08.2023	Issue for 80% Design De
	14.09.2023	Issue for 100% Design E
	23.11.2023	Issue for Coordination



61 2 9922 2344

nbrsarchitecture.com Any form of replication of this drawing in full or in part without the written permission of NBRS+PARTNERS Pty Ltd constitutes an infringement of the copyright. Nominated Architect: Andrew Duffin NSW 5602 © 2023 ABN 16 002 247 565 NBRS & Partners Pty Ltd VIC 51197

Project

Melonba Education Campus

Cnr Elara Boulevard and Kaluta Avenue, Melonba. Lot 30 DP 1237735 for

SINSW

Drawing Title

BLOCK G - GF WALL SETOUT PLAN -SOUTH

FOR CONSTRUCTION

MM-NBRS-BG-GF-DR-A-1772

0 1m 2m 3m 4m 5m 6m 7m 8m 1:100

Drawing Reference

Date 25/01/2024 2:33:38 PM Scale 1:100 @ A1

Revision

CONTRACTORS RESPONSIBILITY TO ENSURE THAT WALL CONSTRUCTION AND LNINGS ACHIEVE REQUIRED SPACIAL COMPLIANCES. NBRS HAS ALSO PROVIDED MINIMUM CLEAR DIMENSIONS REQUIRED FOR COMPLAINCES.

CONTRACTOR TO READ THIS DRAWING IN CONJUNCTION WITH NBRS SETOUT DRAWINGS INCLUDING 5701 & 5702.


MBCGROUP

56.28 No. 23000435 / 4

CROWN DEVELOPMENT APPROVED PLANS

I certify that the work completed in accordance with these plans and specifications will comply with the technical provisions of the State's building days and the Environmental Planning and Assessment Act 1979 No. 203

MBC Corporate Accreditation RBC00029 22 Feb 2024

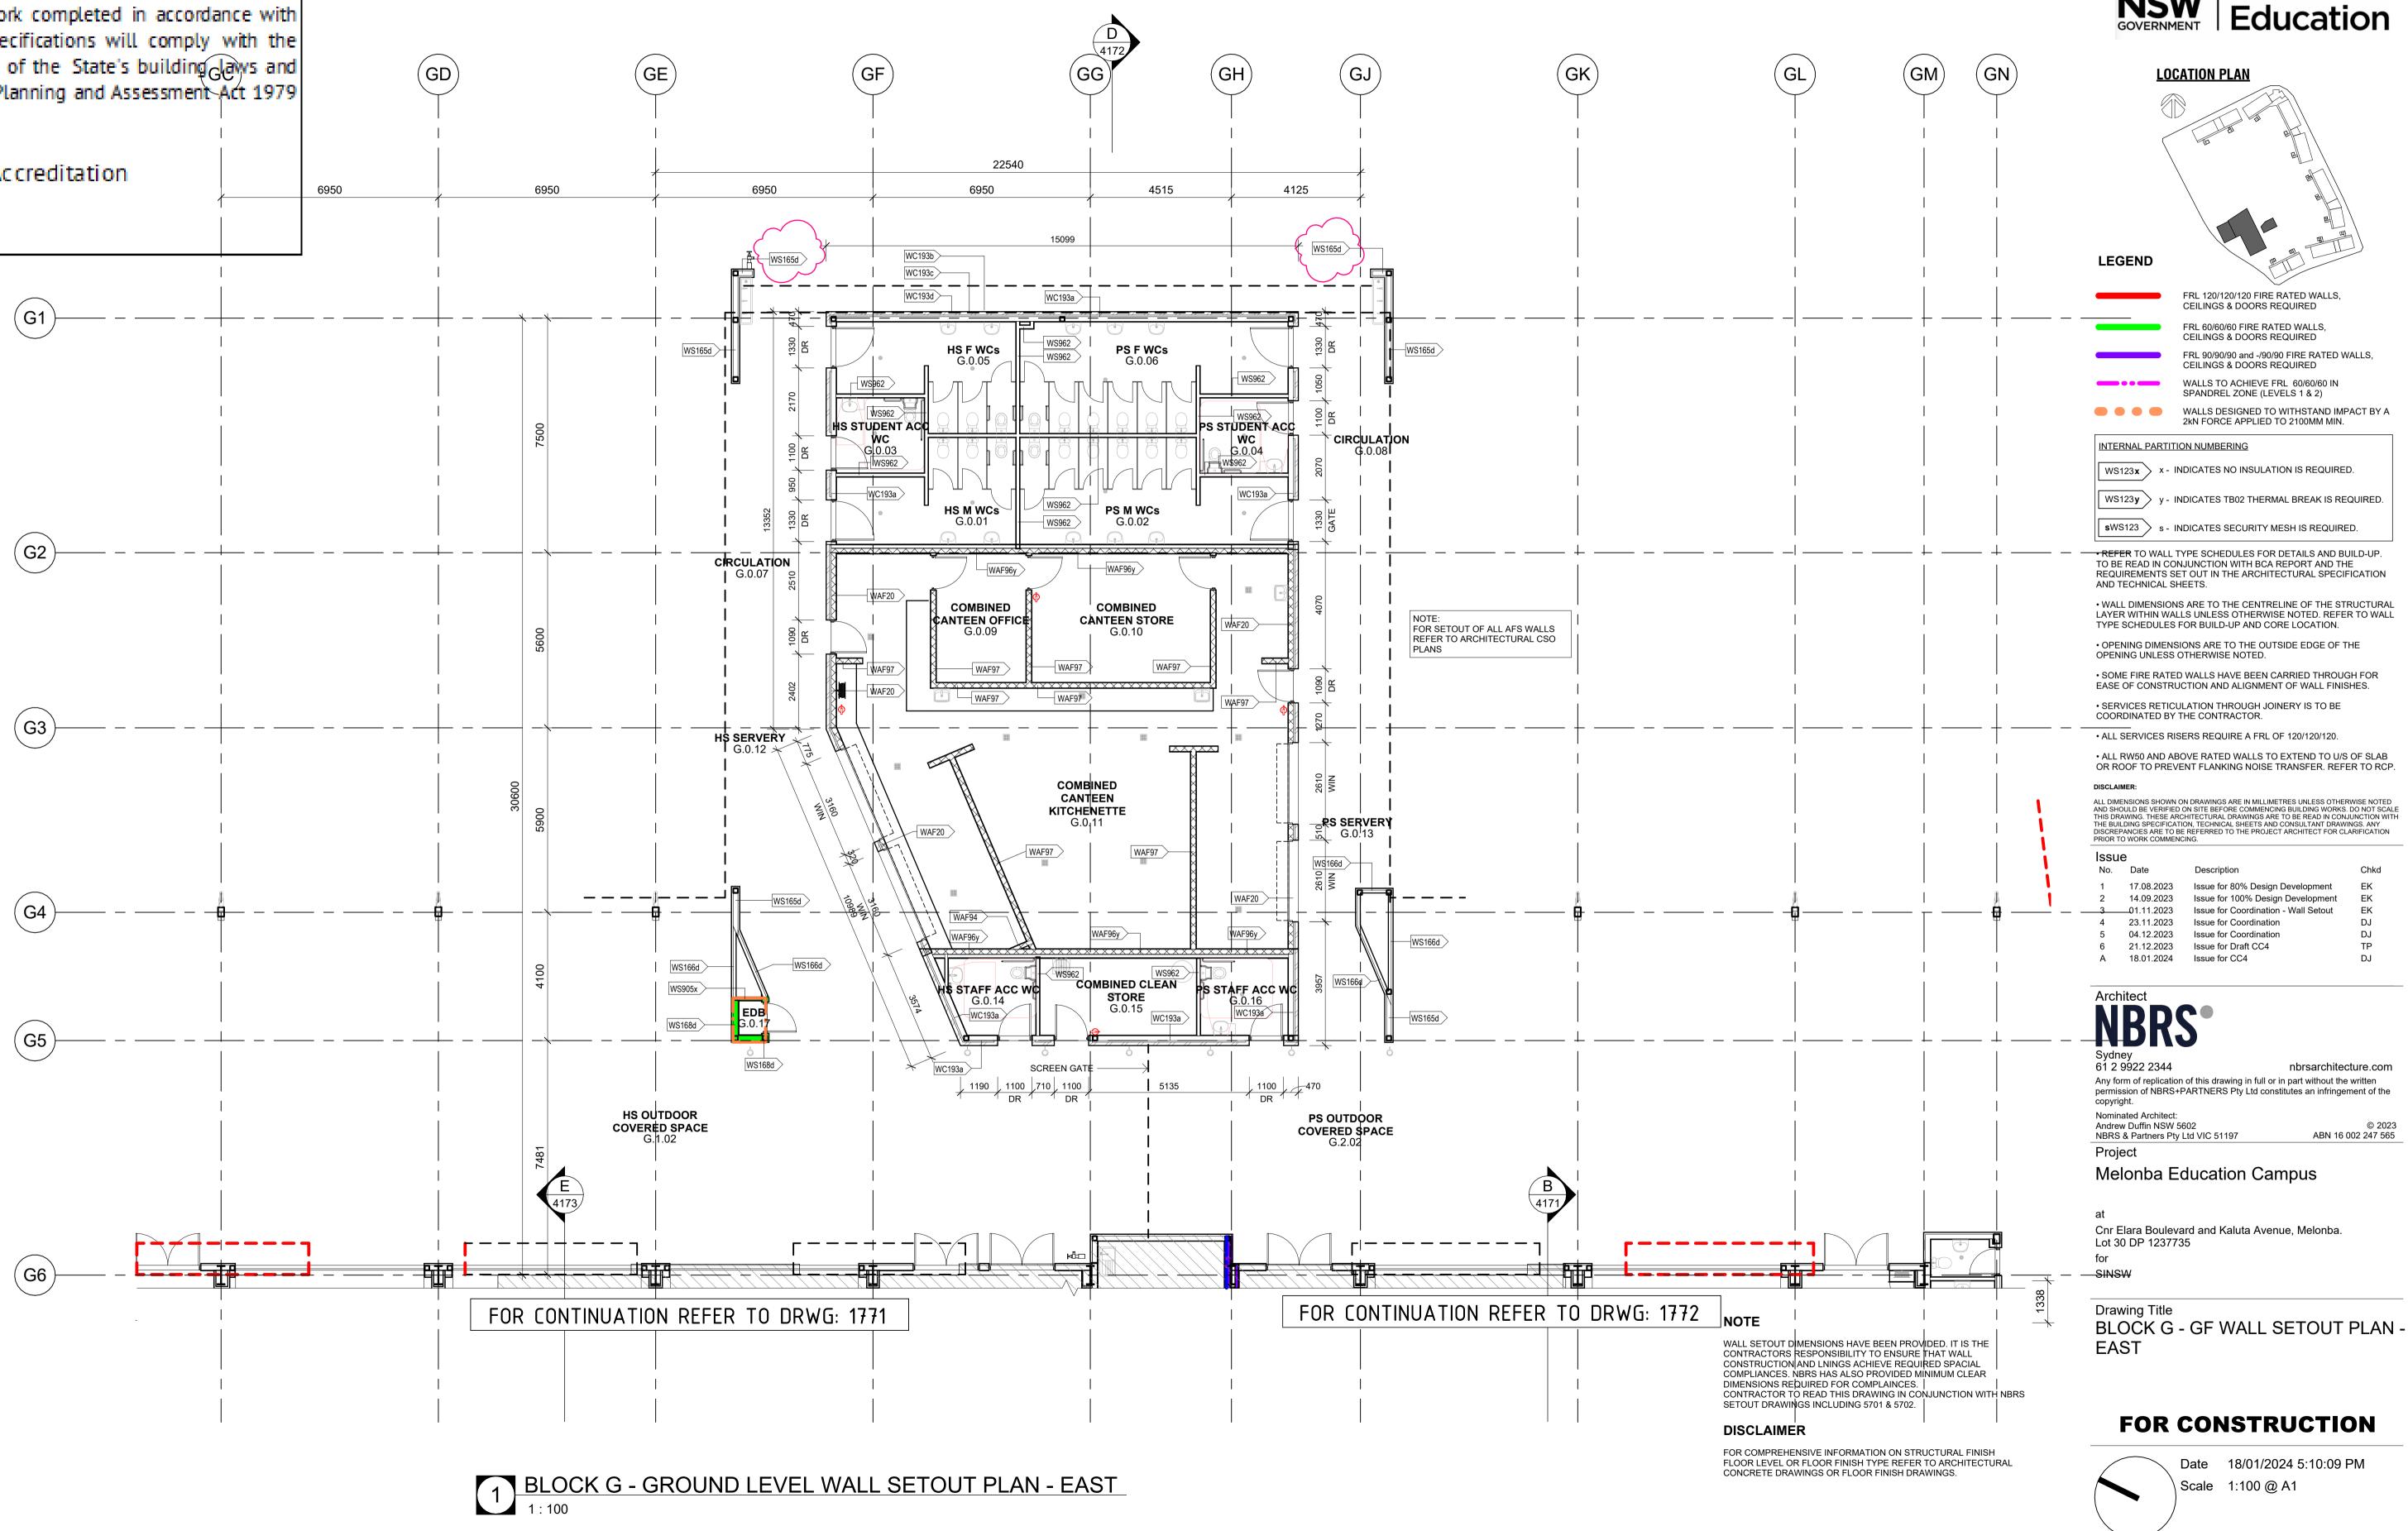






Revision

Drawing Reference

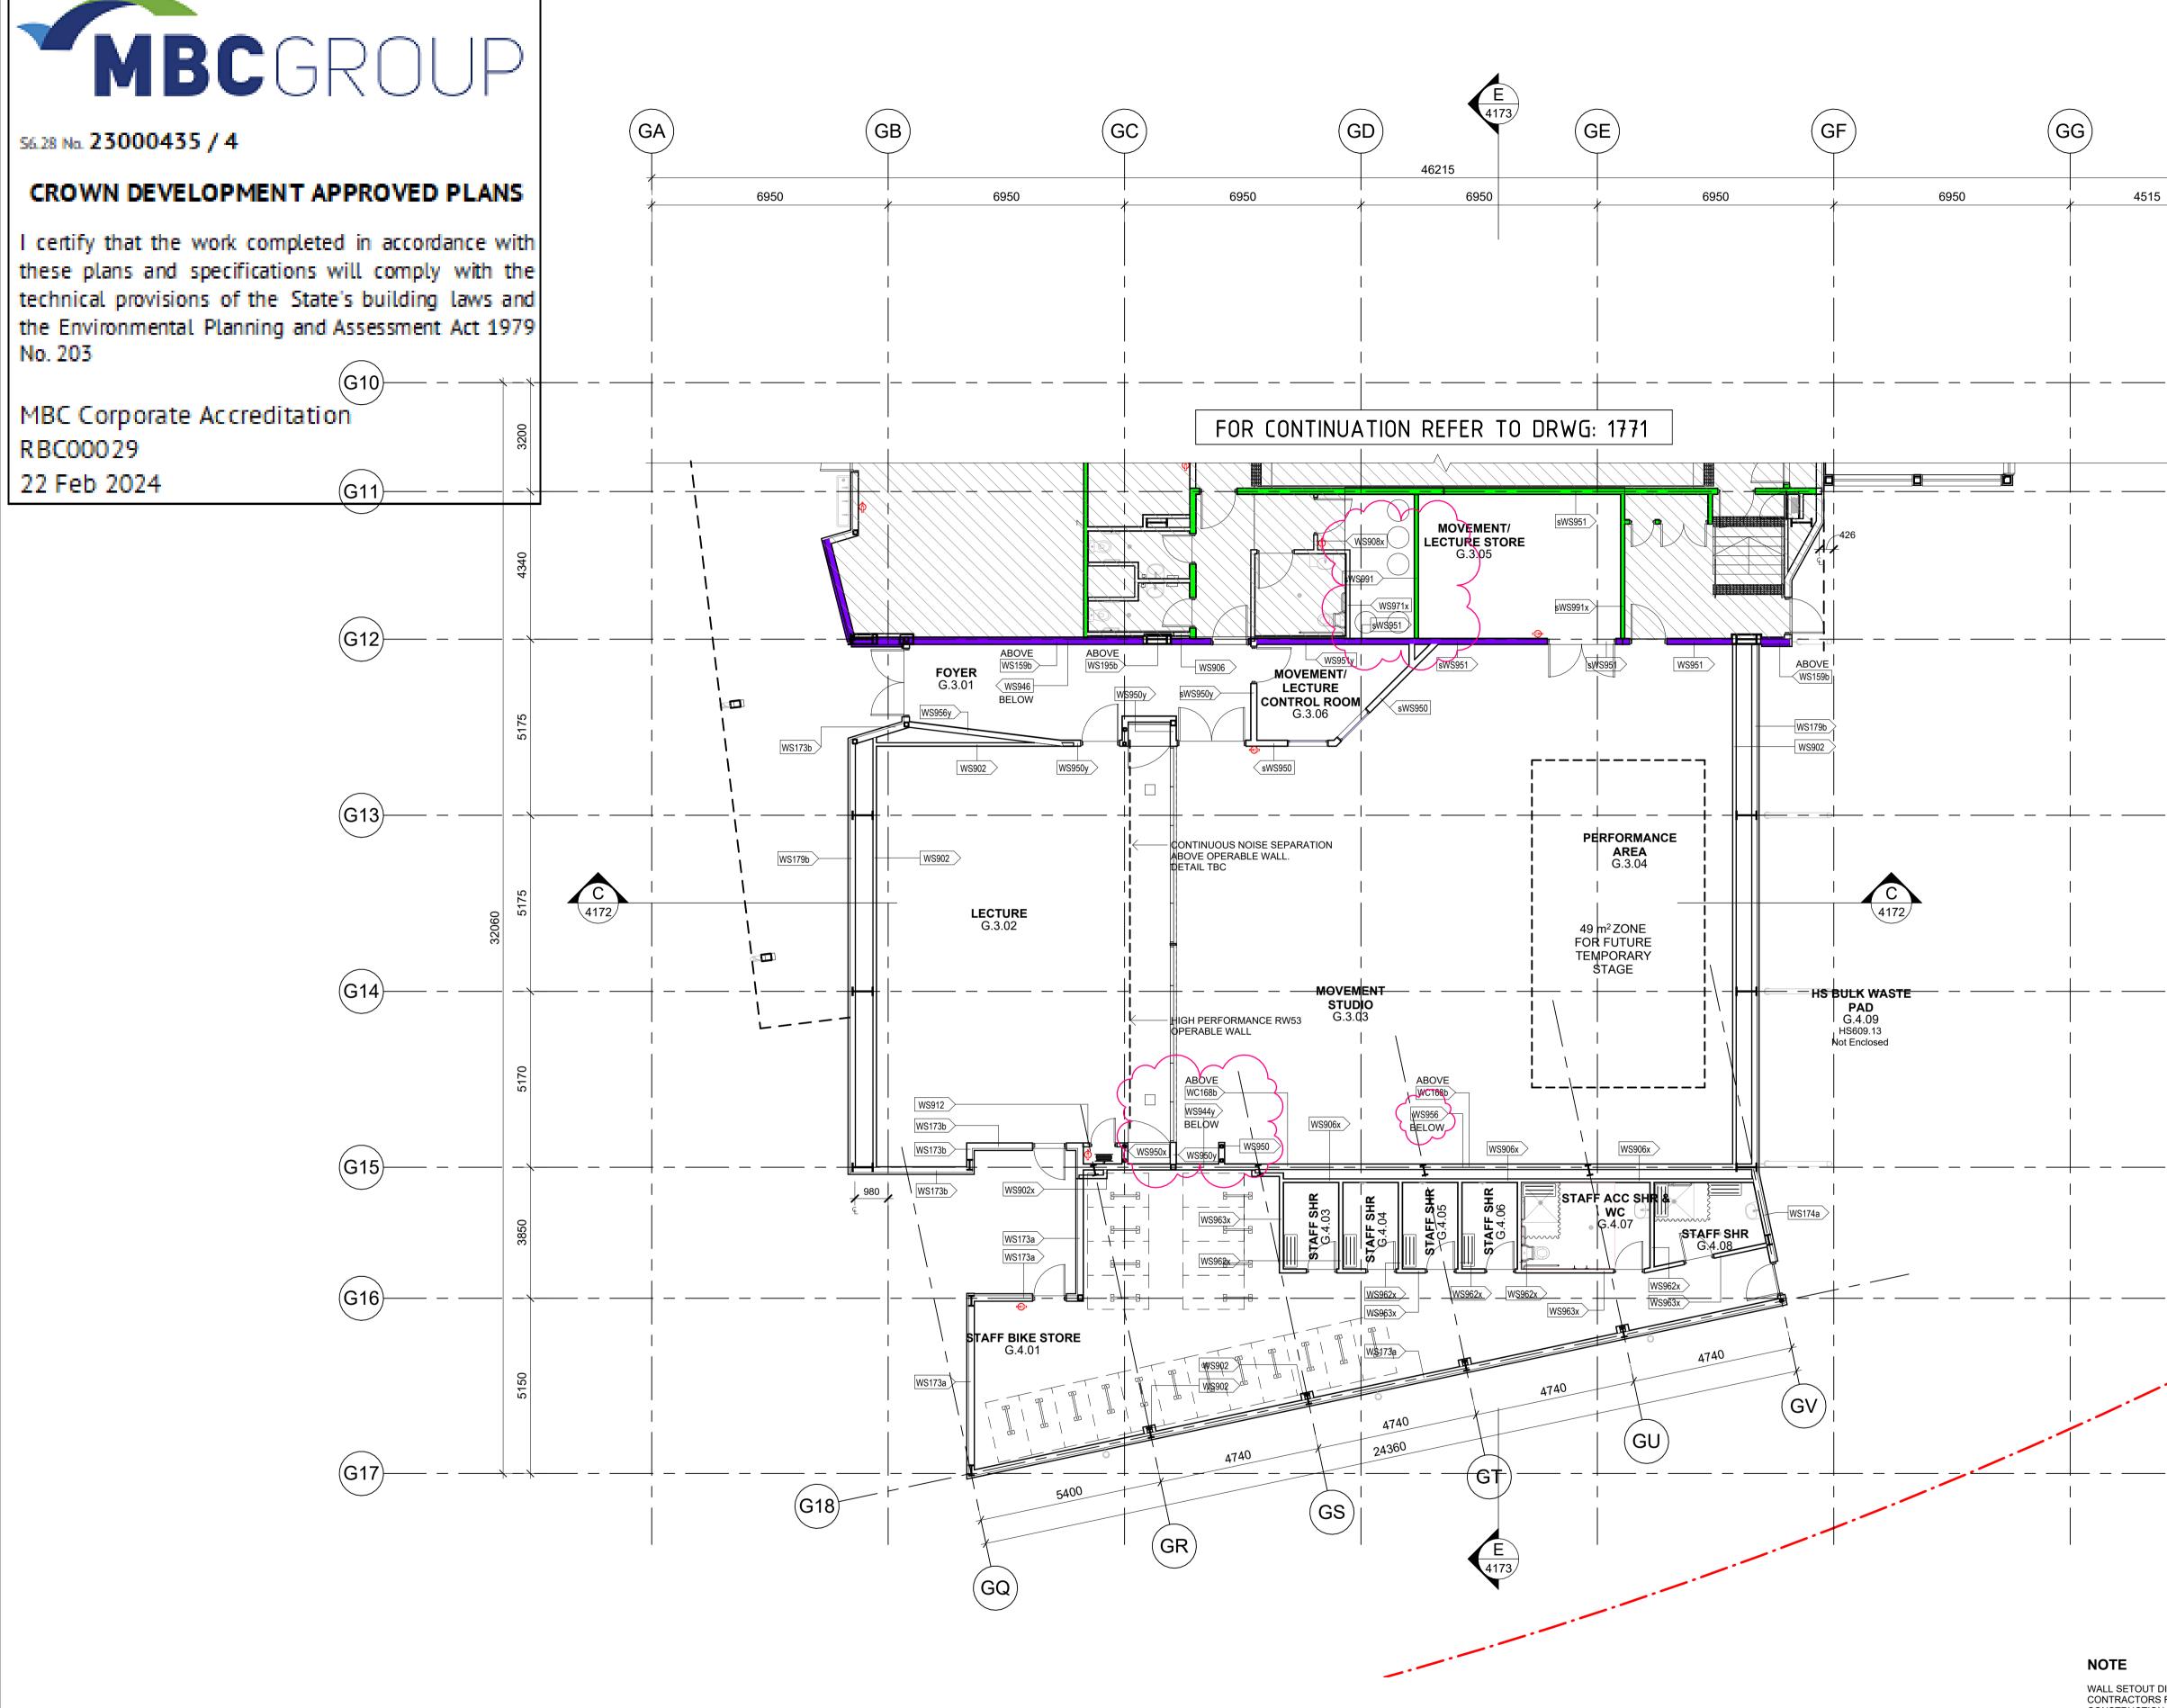

1 BLOCK G - GROUND LEVEL WALL SETOUT PLAN - WEST

DISCLAIMER



LOCATION PLAN 123

LEGEND	
	FRL 120/120/120 FIRE RATED WALLS, CEILINGS & DOORS REQUIRED
	FRL 60/60/60 FIRE RATED WALLS, CEILINGS & DOORS REQUIRED
	FRL 90/90/90 and -/90/90 FIRE RATED WALLS, CEILINGS & DOORS REQUIRED

	WALLS TO ACHIEVE FRL 60/60/60 IN SPANDREL ZONE (LEVELS 1 & 2)
•••	WALLS DESIGNED TO WITHSTAND IMPACT BY A 2kN FORCE APPLIED TO 2100MM MIN.

INTERNAL PARTITION NUMBERING

WS123x × - INDICATES NO INSULATION IS REQUIRED.

y - INDICATES TB02 THERMAL BREAK IS REQUIRED. WS123**y** 🔪

sWS123 > s - INDICATES SECURITY MESH IS REQUIRED.

REFER TO WALL TYPE SCHEDULES FOR DETAILS AND BUILD-UP. TO BE READ IN CONJUNCTION WITH BCA REPORT AND THE REQUIREMENTS SET OUT IN THE ARCHITECTURAL SPECIFICATION AND TECHNICAL SHEETS.

• WALL DIMENSIONS ARE TO THE CENTRELINE OF THE STRUCTURAL LAYER WITHIN WALLS UNLESS OTHERWISE NOTED. REFER TO WALL TYPE SCHEDULES FOR BUILD-UP AND CORE LOCATION.

• OPENING DIMENSIONS ARE TO THE OUTSIDE EDGE OF THE OPENING UNLESS OTHERWISE NOTED.

• SOME FIRE RATED WALLS HAVE BEEN CARRIED THROUGH FOR EASE OF CONSTRUCTION AND ALIGNMENT OF WALL FINISHES.

• SERVICES RETICULATION THROUGH JOINERY IS TO BE COORDINATED BY THE CONTRACTOR

• ALL SERVICES RISERS REQUIRE A FRL OF 120/120/120.

• ALL RW50 AND ABOVE RATED WALLS TO EXTEND TO U/S OF SLAB OR ROOF TO PREVENT FLANKING NOISE TRANSFER. REFER TO RCP

DISCLAIMER

ALL DIMENSIONS SHOWN ON DRAWINGS ARE IN MILLIMETRES UNLESS OTHERWISE NOTED AND SHOULD BE VERIFIED ON SITE BEFORE COMMENCING BUILDING WORKS. DO NOT SCALE THIS DRAWING. THESE ARCHITECTURAL DRAWINGS ARE TO BE READ IN CONJUNCTION WITH THE BUILDING SPECIFICATION, TECHNICAL SHEETS AND CONSULTANT DRAWINGS. ANY DISCREPANCIES ARE TO BE REFERRED TO THE PROJECT ARCHITECT FOR CLARIFICATION PRIOR TO WORK COMMENCING.

SSUE			
No.	Date	Description	Chkd
1	17.08.2023	Issue for 80% Design Development	EK
2	14.09.2023	Issue for 100% Design Development	EK
3	20.09.2023	Issue with DDA Updates	EK
4	23.11.2023	Issue for Coordination	DJ
5	04.12.2023	Issue for Coordination	DJ
6	15.12.2023	Issue for Coordination	TP
7	21.12.2023	Issue for Draft CC4	TP
A	22.01.2024	Issue for CC4	DJ



NRRS

nbrsarchitecture.com 61 2 9922 2344 Any form of replication of this drawing in full or in part without the written permission of NBRS+PARTNERS Pty Ltd constitutes an infringement of the copyright. Nominated Architect:

Andrew Duffin NSW 5602 © 2023 ABN 16 002 247 565 NBRS & Partners Pty Ltd VIC 51197 Project

Melonba Education Campus

Cnr Elara Boulevard and Kaluta Avenue, Melonba. Lot 30 DP 1237735 for


SINSW

Drawing Title

BLOCK G - GF WALL SETOUT PLAN -WEST

FOR CONSTRUCTION

0 1m 2m 3m 4m 5m 6m 7m 8m 1:100

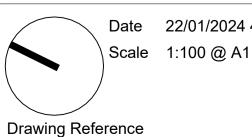

MM-NBRS-BG-GF-DR-A-1774

Date 22/01/2024 4:49:34 PM

Revision


Α

WALL SETOUT DIMENSIONS HAVE BEEN PROVIDED. IT IS THE CONTRACTORS RESPONSIBILITY TO ENSURE THAT WALL CONSTRUCTION AND LNINGS ACHIEVE REQUIRED SPACIAL COMPLIANCES. NBRS HAS ALSO PROVIDED MINIMUM CLEAR DIMENSIONS REQUIRED FOR COMPLAINCES.


(GH

CONTRACTOR TO READ THIS DRAWING IN CONJUNCTION WITH NBRS SETOUT DRAWINGS INCLUDING 5701 & 5702.

FOR COMPREHENSIVE INFORMATION ON STRUCTURAL FINISH FLOOR LEVEL OR FLOOR FINISH TYPE REFER TO ARCHITECTURAL CONCRETE DRAWINGS OR FLOOR FINISH DRAWINGS.

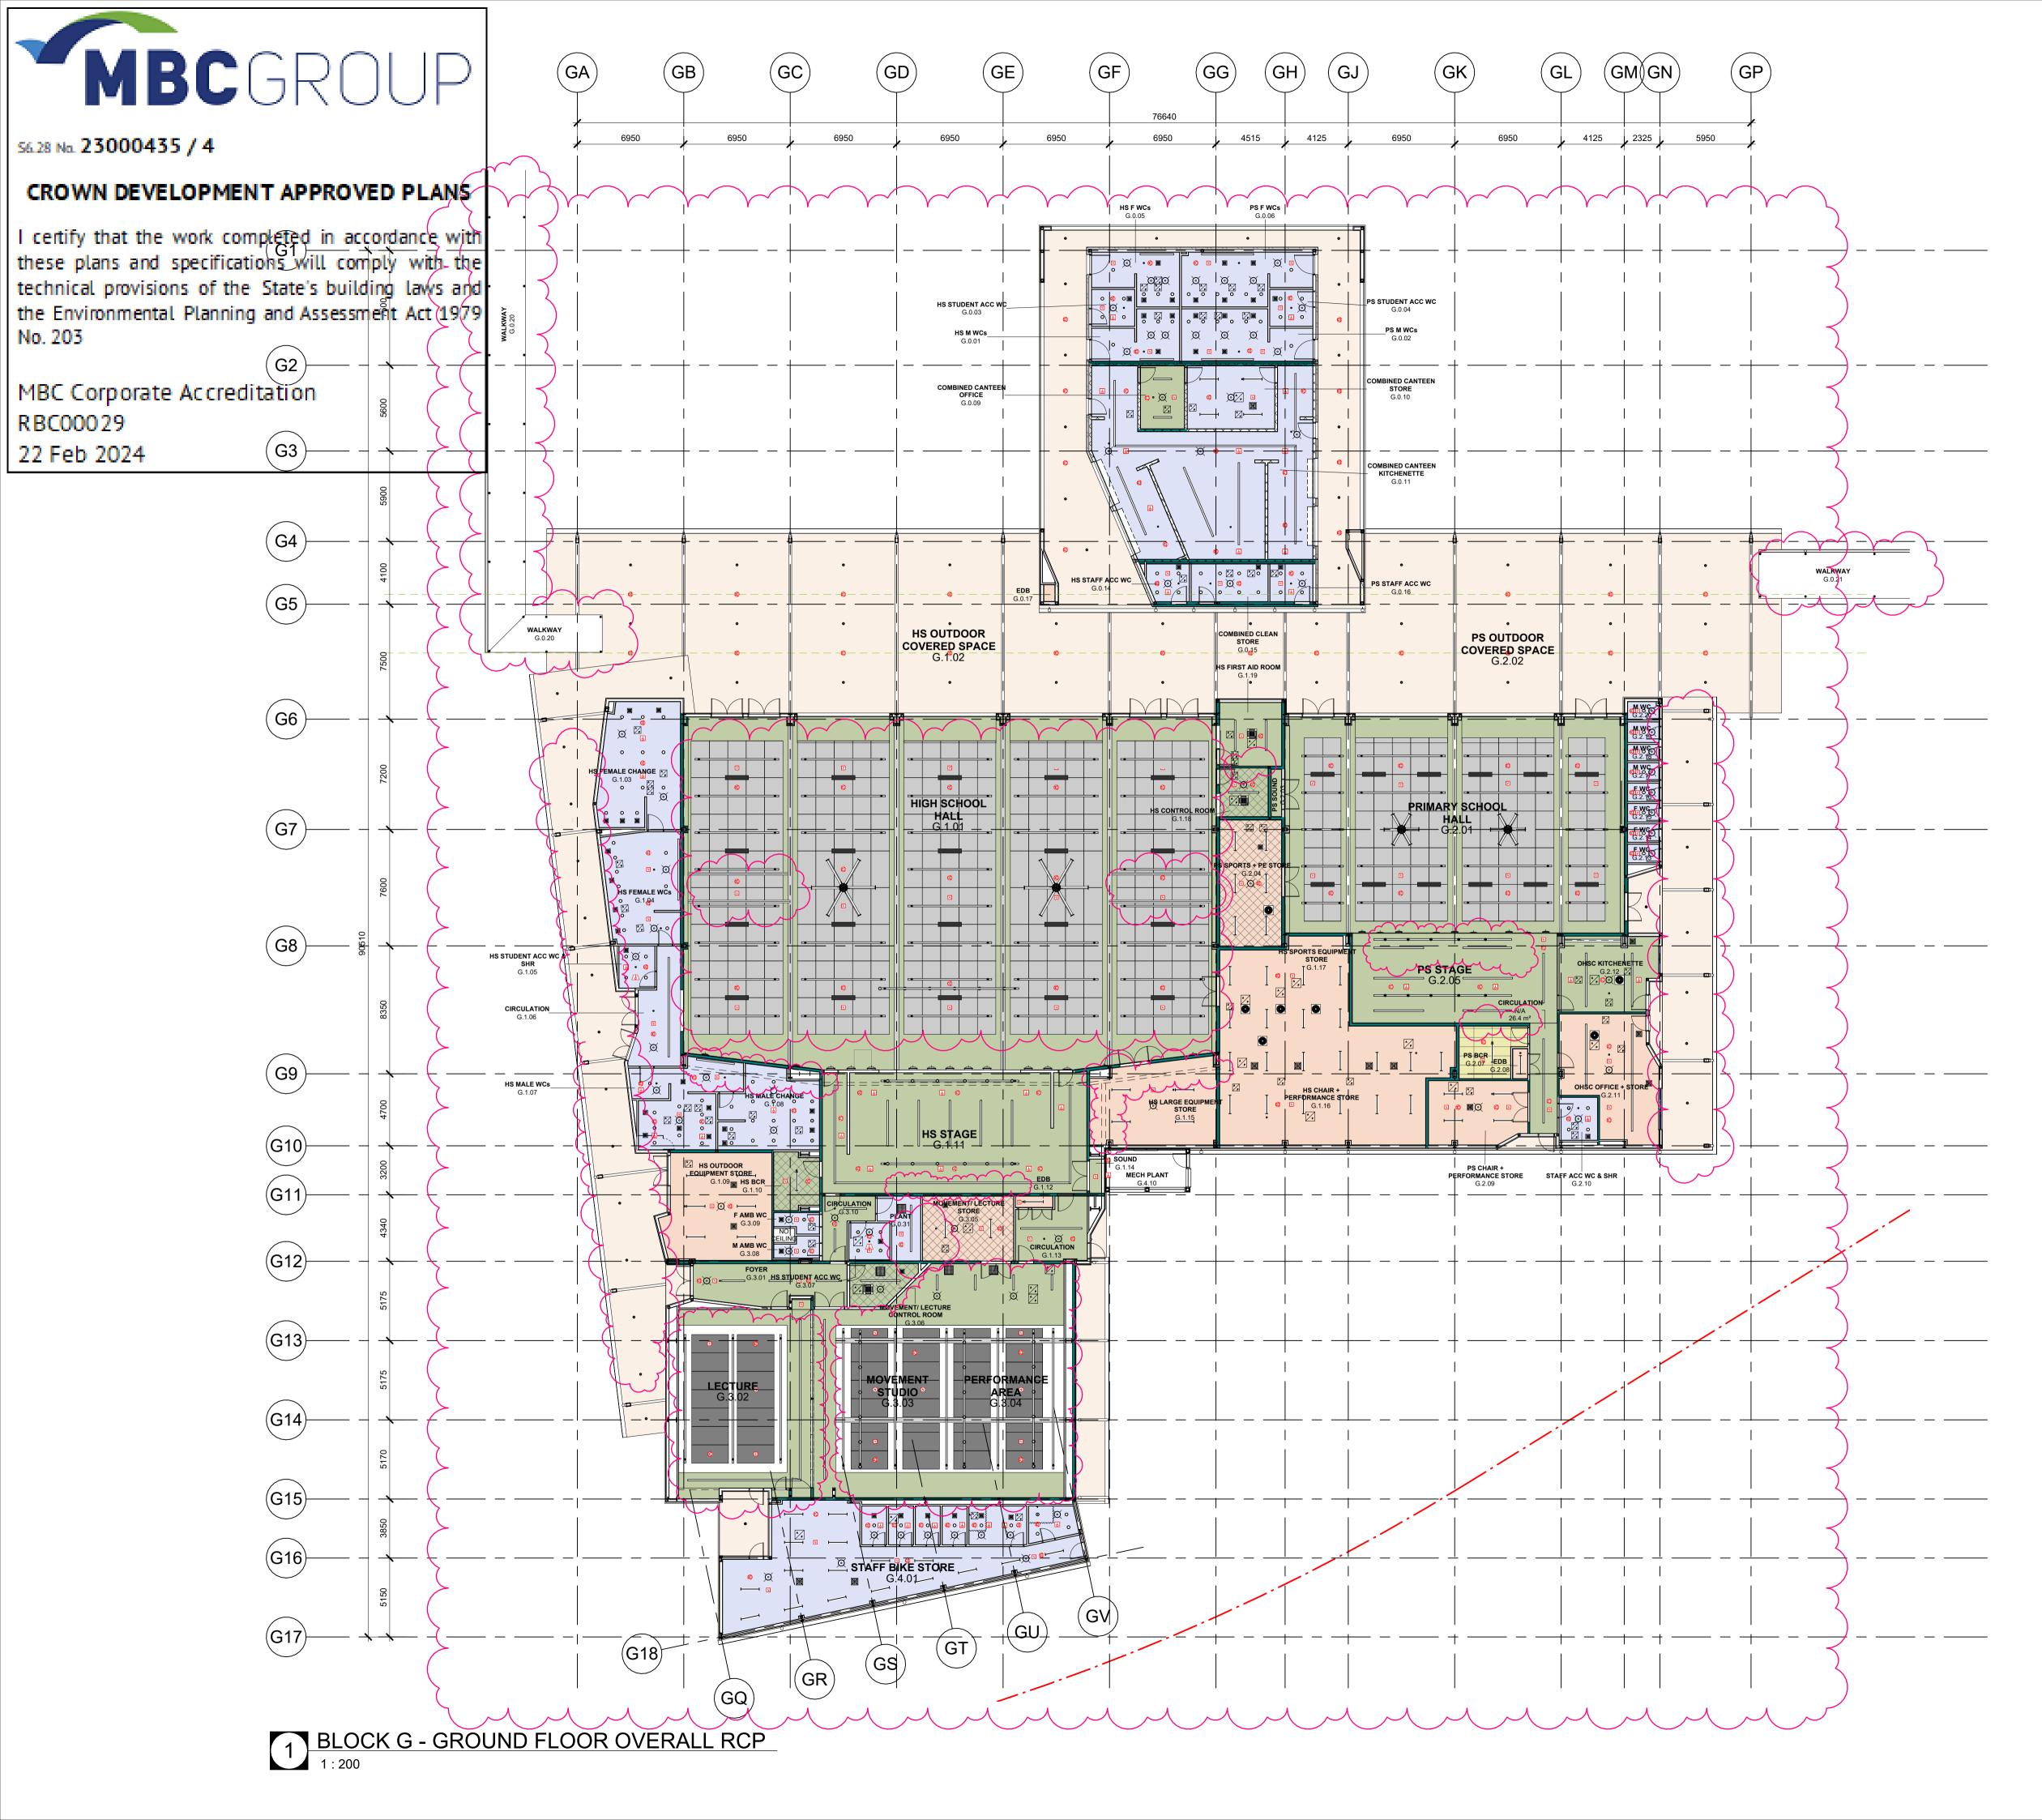



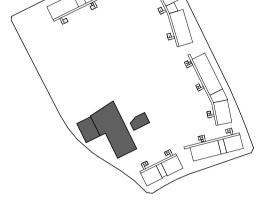

PRINT DRAWINGS IN COLOUR ONLY



GENERAL NOTES

ROOM TAGS REFERENCE NEW HUB EFSG NUMBERS. REFER TO THE AREA SCHEDULES (0000 SERIES) TO RECONCILE EFSG WEBSITE INFORMATION.

PROVIDE GALVANISED SURFACE MOUNTED CONDUIT TO LIGHT FITTINGS THAT ARE MOUNTED TO THE UNDERSIDE OF CONCRETE SLAB AND UNDER CEILING TYPE CLG16 & CLG11. REFER TO MECHANICAL & ELECTRICAL SERVICES DOCUMENTATION FOR THE QUANTITY & TYPES OF FITTINGS & FIXTURES. ALL EXPOSED STEEL TO EXTERNAL AREAS TO BE HOT DIPPED GALVANISED.

REFER TO CIVIL AND LANDSCAPE ARCH DOCUMENTS FOR EXTERNAL WORKS.

DISCLAIMER

ALL DIMENSIONS SHOWN ON DRAWINGS ARE IN MILLIMETRES UNLESS OTHERWISE NOTED AND SHOULD BE VERIFIED ON SITE BEFORE COMMENCING BUILDING WORKS. DO NOT SCALE THIS DRAWING. THESE ARCHITECTURAL DRAWINGS ARE TO BE READ IN CONJUNCTION WITH THE BUILDING SPECIFICATION, TECHNICAL SHEETS AND CONSULTANT DRAWINGS. ANY DISCREPANCIES ARE TO BE REFERRED TO THE PROJECT ARCHITECT FOR CLARIFICATION PRIOR TO WORK COMMENCING.

lssue

No. Date Description 21.12.2023 Issue for Draft CC4 A 22.01.2024 Issue for CC4

Chko TP D.I

Architect NBRS

61 2 9922 2344 nbrsarchitecture.com Any form of replication of this drawing in full or in part without the written permission of NBRS+PARTNERS Pty Ltd constitutes an infringement of the copyright. Nominated Architect: Andrew Duffin NSW 5602 © 2023 ABN 16 002 247 565 NBRS & Partners Pty Ltd VIC 51197

Project Melonba Education Campus

Cnr Elara Boulevard and Kaluta Avenue, Melonba. Lot 30 DP 1237735 for SINSW

Drawing Title

BLOCK G - OVERALL RCP


FOR CONSTRUCTION

Date 22/01/2024 4:49:22 PM Scale As indicated @ A1




MM-NBRS-BG-GF-DR-A-2170

Revision

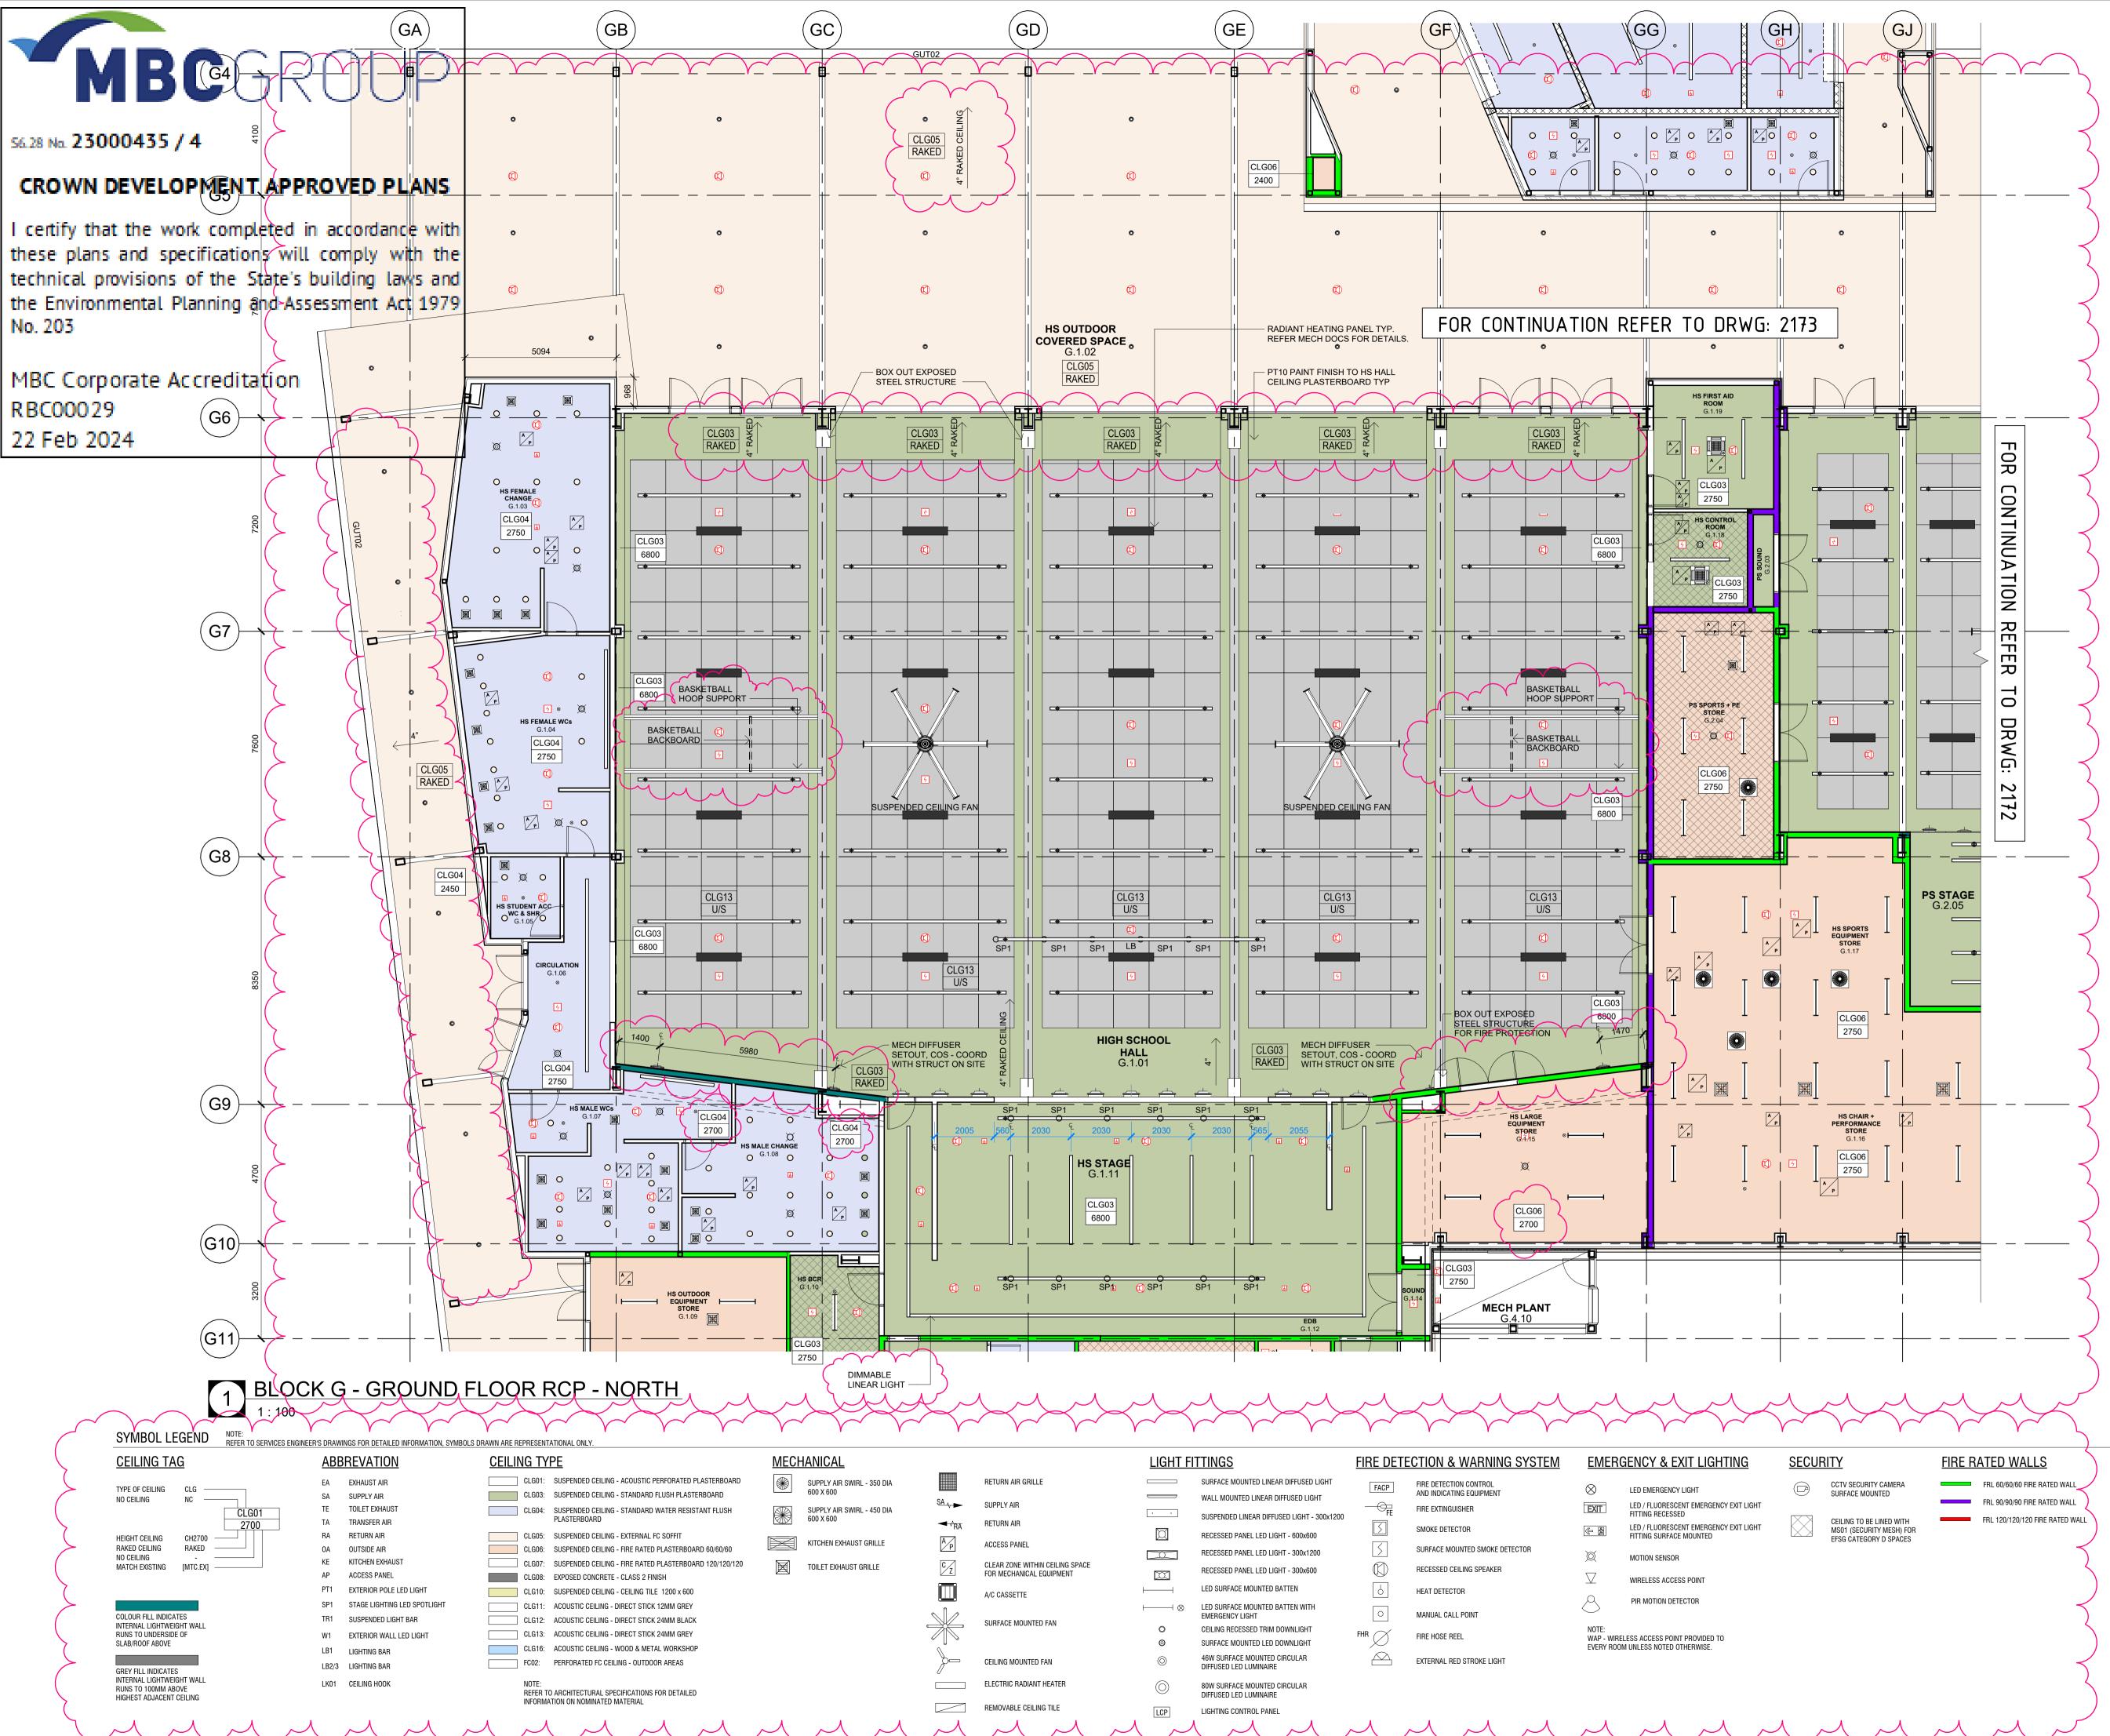

ELECTRIC RADIANT H
REMOVABLE CEILING



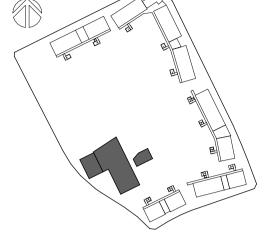

PRINT DRAWINGS IN COLOUR ONLY

GENERAL NOTES

ROOM TAGS REFERENCE NEW HUB EFSG NUMBERS. REFER TO THE AREA SCHEDULES (0000 SERIES) TO RECONCILE EFSG WEBSITE INFORMATION.

PROVIDE GALVANISED SURFACE MOUNTED CONDUIT TO LIGHT FITTINGS THAT ARE MOUNTED TO THE UNDERSIDE OF CONCRETE SLAB AND UNDER CEILING TYPE CLG16 & CLG11. REFER TO MECHANICAL & ELECTRICAL SERVICES DOCUMENTATION FOR THE QUANTITY & TYPES OF FITTINGS & FIXTURES

ALL EXPOSED STEEL TO EXTERNAL AREAS TO BE HOT DIPPED GALVANISED.

REFER TO CIVIL AND LANDSCAPE ARCH DOCUMENTS FOR EXTERNAL WORKS.

DISCLAIMER

ALL DIMENSIONS SHOWN ON DRAWINGS ARE IN MILLIMETRES UNLESS OTHERWISE NOTED AND SHOULD BE VERIFIED ON SITE BEFORE COMMENCING BUILDING WORKS. DO NOT SCALE THIS DRAWING. THESE ARCHITECTURAL DRAWINGS ARE TO BE READ IN CONJUNCTION WITH THE BUILDING SPECIFICATION, TECHNICAL SHEETS AND CONSULTANT DRAWINGS. ANY DISCREPANCIES ARE TO BE REFERRED TO THE PROJECT ARCHITECT FOR CLARIFICATION PRIOR TO WORK COMMENCING.

Issue			
No.	Date	Description	Chkd
1	31.07.2023	Issue for Information	EK
2	17.08.2023	Issue for 80% Design Development	EK
3	14.09.2023	Issue for 100% Design Development	EK
4	17.11.2023	Issue for Coordination	DJ
5	23.11.2023	Issue for Coordination	DJ
6	21.12.2023	Issue for Draft CC4	TP
А	18.01.2024	Issue for CC4	DJ

Architect NRRS

61 2 9922 2344 Any form of replication of this drawing in full or in part without the written permission of NBRS+PARTNERS Pty Ltd constitutes an infringement of the

copyright. Nominated Architect: Andrew Duffin NSW 5602 © 2023 NBRS & Partners Pty Ltd VIC 51197 ABN 16 002 247 565 Project

nbrsarchitecture.com

Melonba Education Campus

Cnr Elara Boulevard and Kaluta Avenue, Melonba. Lot 30 DP 1237735 for

SINSW

Drawing Title

BLOCK G - GF RCP - NORTH

FOR CONSTRUCTION

Date Scale 1:100@A1

18/01/2024 5:14:35 PM

Drawing Reference MM-NBRS-BG-GF-DR-A-217

Revision




56.28 No. 23000435 / 4

CROWN DEVELOPMENT APPROVED PLANS

I certify that the work completed in accordance with these plans and specifications will comply with the technical provisions of the State's building laws and the Environmental Planning and Assessment Act 1979 No. 203

MBC Corporate Accreditation RBC00029 22 Feb 2024

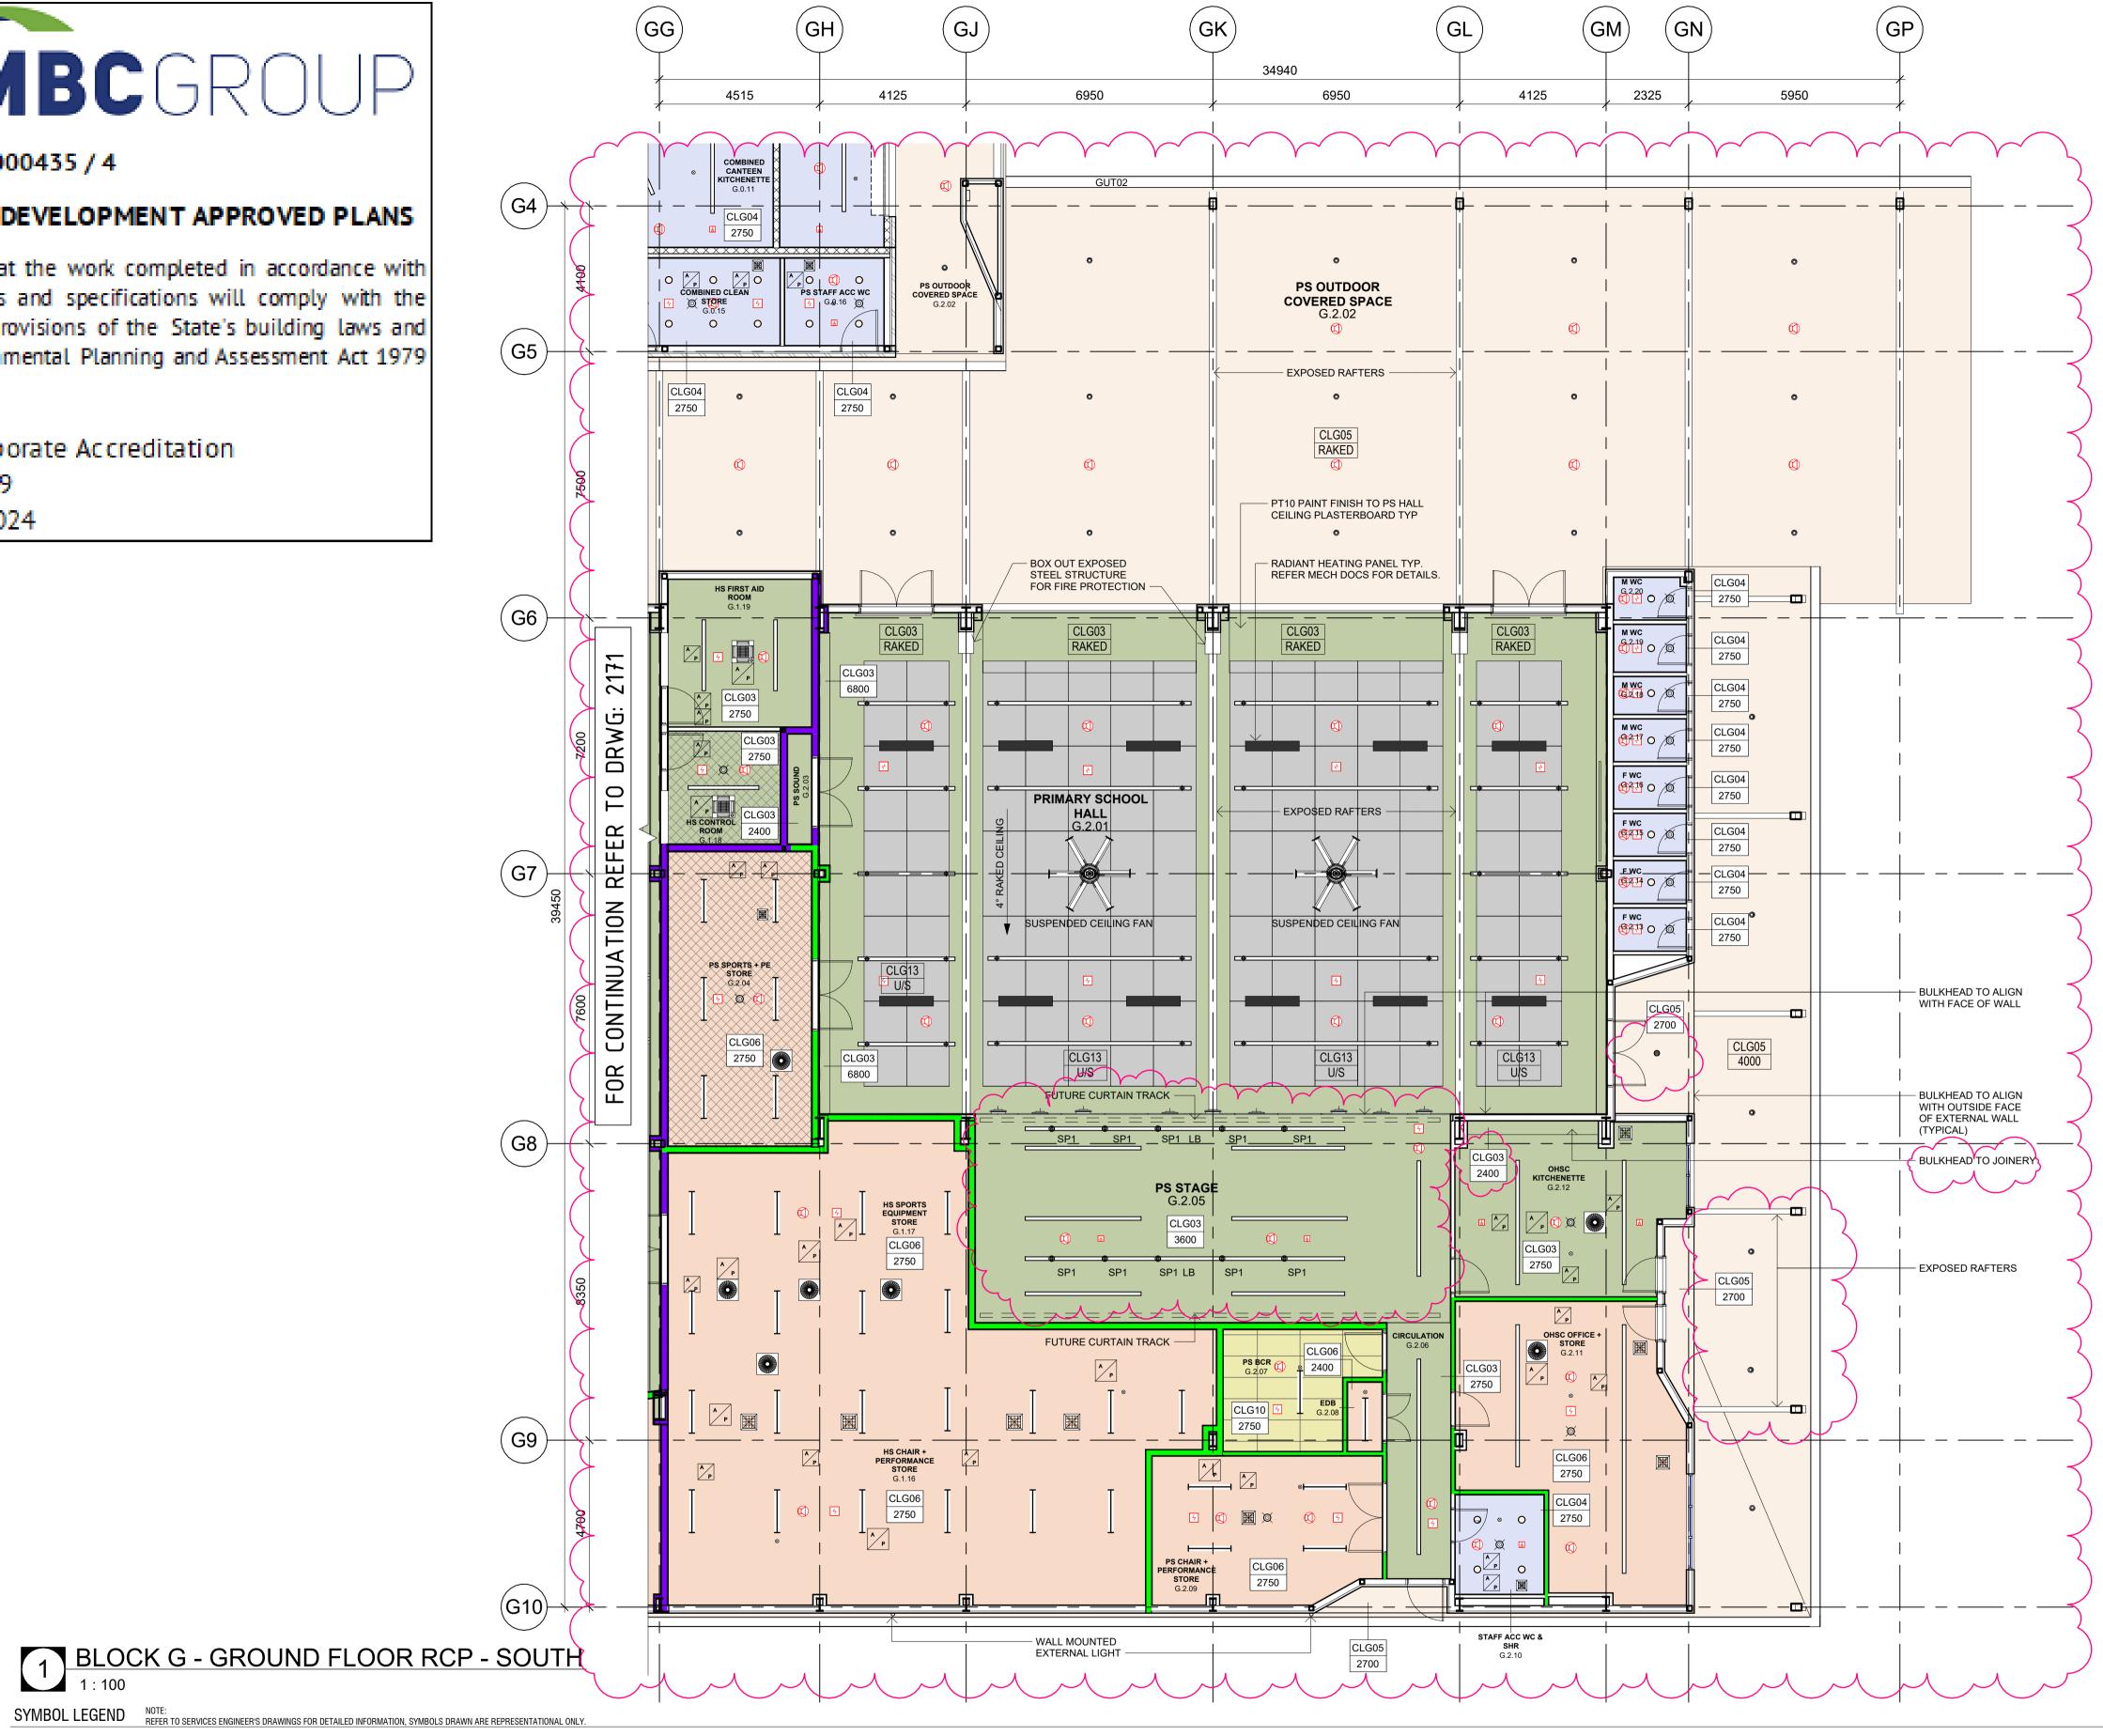


1 BLOCK G - GROUND FLOOR RCP - SOUTH

<u>CEILING TAG</u>

TYPE OF CEILING CLG -NO CEILING NC HEIGHT CEILING CH2700

AKED CEILING	RAKED	
IO CEILING	-	
ATCH EXISTING	[MTC.EX]	
	. ,	

CL GO1

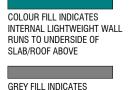

INTERNAL LIGHTWEIGHT WAL RUNS TO 100MM ABOVE HIGHEST ADJACENT CEILING

ABBREVATION EA EXHAUST AIR

SA	SUPPLY AIR
TE	TOILET EXHAUST
TA	TRANSFER AIR
RA	RETURN AIR
OA	OUTSIDE AIR
KE	KITCHEN EXHAUST
AP	ACCESS PANEL
PT1	EXTERIOR POLE LED LIGHT
SP1	STAGE LIGHTING LED SPOTLIGHT
TR1	SUSPENDED LIGHT BAR
W1	EXTERIOR WALL LED LIGHT
LB1	LIGHTING BAR
LB2/3	LIGHTING BAR
LK01	CEILING HOOK

CLG03:	SUSPENDED CEILING - STANDARD FLUSH PLASTERBOARD
CLG04:	SUSPENDED CEILING - STANDARD WATER RESISTANT FLUSH PLASTERBOARD
CLG05:	SUSPENDED CEILING - EXTERNAL FC SOFFIT
CLG06:	SUSPENDED CEILING - FIRE RATED PLASTERBOARD 60/60/60
CLG07:	SUSPENDED CEILING - FIRE RATED PLASTERBOARD 120/120/120
CLG08:	EXPOSED CONCRETE - CLASS 2 FINISH
CLG10:	SUSPENDED CEILING - CEILING TILE 1200 x 600
CLG11:	ACOUSTIC CEILING - DIRECT STICK 12MM GREY
CLG12:	ACOUSTIC CEILING - DIRECT STICK 24MM BLACK
CLG13:	ACOUSTIC CEILING - DIRECT STICK 24MM GREY
CLG16:	ACOUSTIC CEILING - WOOD & METAL WORKSHOP
FC02:	PERFORATED FC CEILING - OUTDOOR AREAS
NOTE: REFER TO) ARCHITECTURAL SPECIFICATIONS FOR DETAILED

INFORMATION ON NOMINATED MATERIAL

CLG01: SUSPENDED CEILING - ACOUSTIC PERFORATED PLASTERBOARD

CEILING TYPE

MECHANICAL

	SUPPLY AIR SWIRL - 350 DIA 600 X 600
	SUPPLY AIR SWIRL - 450 DIA 600 X 600
\ge	KITCHEN EXHAUST GRILLE
X	TOILET EXHAUST GRILLE

A P CZ

RETURN AIR GRILLE

SUPPLY AIR

RETURN AIR

ACCESS PANEL

A/C CASSETTE

SURFACE MOUNTED FAN

CEILING MOUNTED FAN

REMOVABLE CEILING TILE

ELECTRIC RADIANT HEATER

• • Ø CLEAR ZONE WITHIN CEILING SPACE \square FOR MECHANICAL EQUIPMENT \longrightarrow 0 0

LCP

LIGHT FITTINGS

RECESSED PANEL LED LIGHT - 600x600 RECESSED PANEL LED LIGHT - 300x1200 RECESSED PANEL LED LIGHT - 300x600 LED SURFACE MOUNTED BATTEN LED SURFACE MOUNTED BATTEN WITH EMERGENCY LIGHT

SURFACE MOUNTED LINEAR DIFFUSED LIGHT

WALL MOUNTED LINEAR DIFFUSED LIGHT

SUSPENDED LINEAR DIFFUSED LIGHT - 300x1200

CEILING RECESSED TRIM DOWNLIGHT SURFACE MOUNTED LED DOWNLIGHT 46W SURFACE MOUNTED CIRCULAR DIFFUSED LED LUMINAIRE 80W SURFACE MOUNTED CIRCULAR DIFFUSED LED LUMINAIRE

LIGHTING CONTROL PANEL

FIRE DETECTION & WARNING SYSTEM

FIRE DETECTION CONTROL FACP AND INDICATING EQUIPMENT -œ FIRE EXTINGUISHER \leq SMOKE DETECTOR SURFACE MOUNTED SMOKE DETECTOR (RECESSED CEILING SPEAKER

HEAT DETECTOR

6

0

 \bigtriangleup

FHR X

MANUAL CALL POINT FIRE HOSE REEL

EXTERNAL RED STROKE LIGHT

EMERGENCY & EXIT LIGHTING

LED / FLUORESCENT EMERGENCY EXIT LIGHT

<u>SECURITY</u>

FIRE RATED WALLS

FRL 60/60/60 FIRE RATED WALL

FRL 120/120/120 FIRE RATED WALL

FRL 90/90/90 FIRE RATED WALL

CCTV SECURITY CAMERA SURFACE MOUNTED

FITTING RECESSED LED / FLUORESCENT EMERGENCY EXIT LIGHT FITTING SURFACE MOUNTED

MS01 (SECURITY MESH) FOR EFSG CATEGORY D SPACES

CEILING TO BE LINED WITH

WIRELESS ACCESS POINT

PIR MOTION DETECTOR

MOTION SENSOR

LED EMERGENCY LIGHT

 \otimes

EXIT


(今 🖗

Ø

NOTE: WAP - WIRELESS ACCESS POINT PROVIDED TO EVERY ROOM UNLESS NOTED OTHERWISE.



LOCATION PLAN

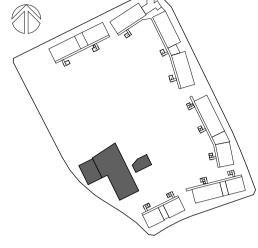

PRINT DRAWINGS IN COLOUR ONLY

GENERAL NOTES

ROOM TAGS REFERENCE NEW HUB EFSG NUMBERS. REFER TO THE AREA SCHEDULES (0000 SERIES) TO RECONCILE EFSG WEBSITE INFORMATION.

PROVIDE GALVANISED SURFACE MOUNTED CONDUIT TO LIGHT FITTINGS THAT ARE MOUNTED TO THE UNDERSIDE OF CONCRETE SLAB AND UNDER CEILING TYPE CLG16 & CLG11.

REFER TO MECHANICAL & ELECTRICAL SERVICES DOCUMENTATION FOR THE QUANTITY & TYPES OF FITTINGS & FIXTURES. ALL EXPOSED STEEL TO EXTERNAL AREAS TO BE HOT DIPPED

GALVANISED. REFER TO CIVIL AND LANDSCAPE ARCH DOCUMENTS FOR EXTERNAL WORKS.

DISCLAIMER

ALL DIMENSIONS SHOWN ON DRAWINGS ARE IN MILLIMETRES UNLESS OTHERWISE NOTED AND SHOULD BE VERIFIED ON SITE BEFORE COMMENCING BUILDING WORKS. DO NOT SCALE THIS DRAWING. THESE ARCHITECTURAL DRAWINGS ARE TO BE READ IN CONJUNCTION WITH THE BUILDING SPECIFICATION, TECHNICAL SHEETS AND CONSULTANT DRAWINGS. ANY DISCREPANCIES ARE TO BE REFERRED TO THE PROJECT ARCHITECT FOR CLARIFICATION PRIOR TO WORK COMMENCING.

Issue			
No.	Date	Description	Chkd
1	31.07.2023	Issue for Information	EK
2	17.08.2023	Issue for 80% Design Development	EK
3	14.09.2023	Issue for 100% Design Development	EK
4	17.11.2023	Issue for Coordination	DJ
5	23.11.2023	Issue for Coordination	DJ
6	21.12.2023	Issue for Draft CC4	TP
А	18.01.2024	Issue for CC4	DJ





nbrsarchitecture.com

copyright. Nominated Architect: Andrew Duffin NSW 5602 © 2023 ABN 16 002 247 565 NBRS & Partners Pty Ltd VIC 51197

Melonba Education Campus

Project

Cnr Elara Boulevard and Kaluta Avenue, Melonba. Lot 30 DP 1237735 for

SINSW

Drawing Title

BLOCK G - GF RCP - SOUTH






Date 18/01/2024 5:13:56 PM

Drawing Reference

MM-NBRS-BG-GF-DR-A-2172

Revision

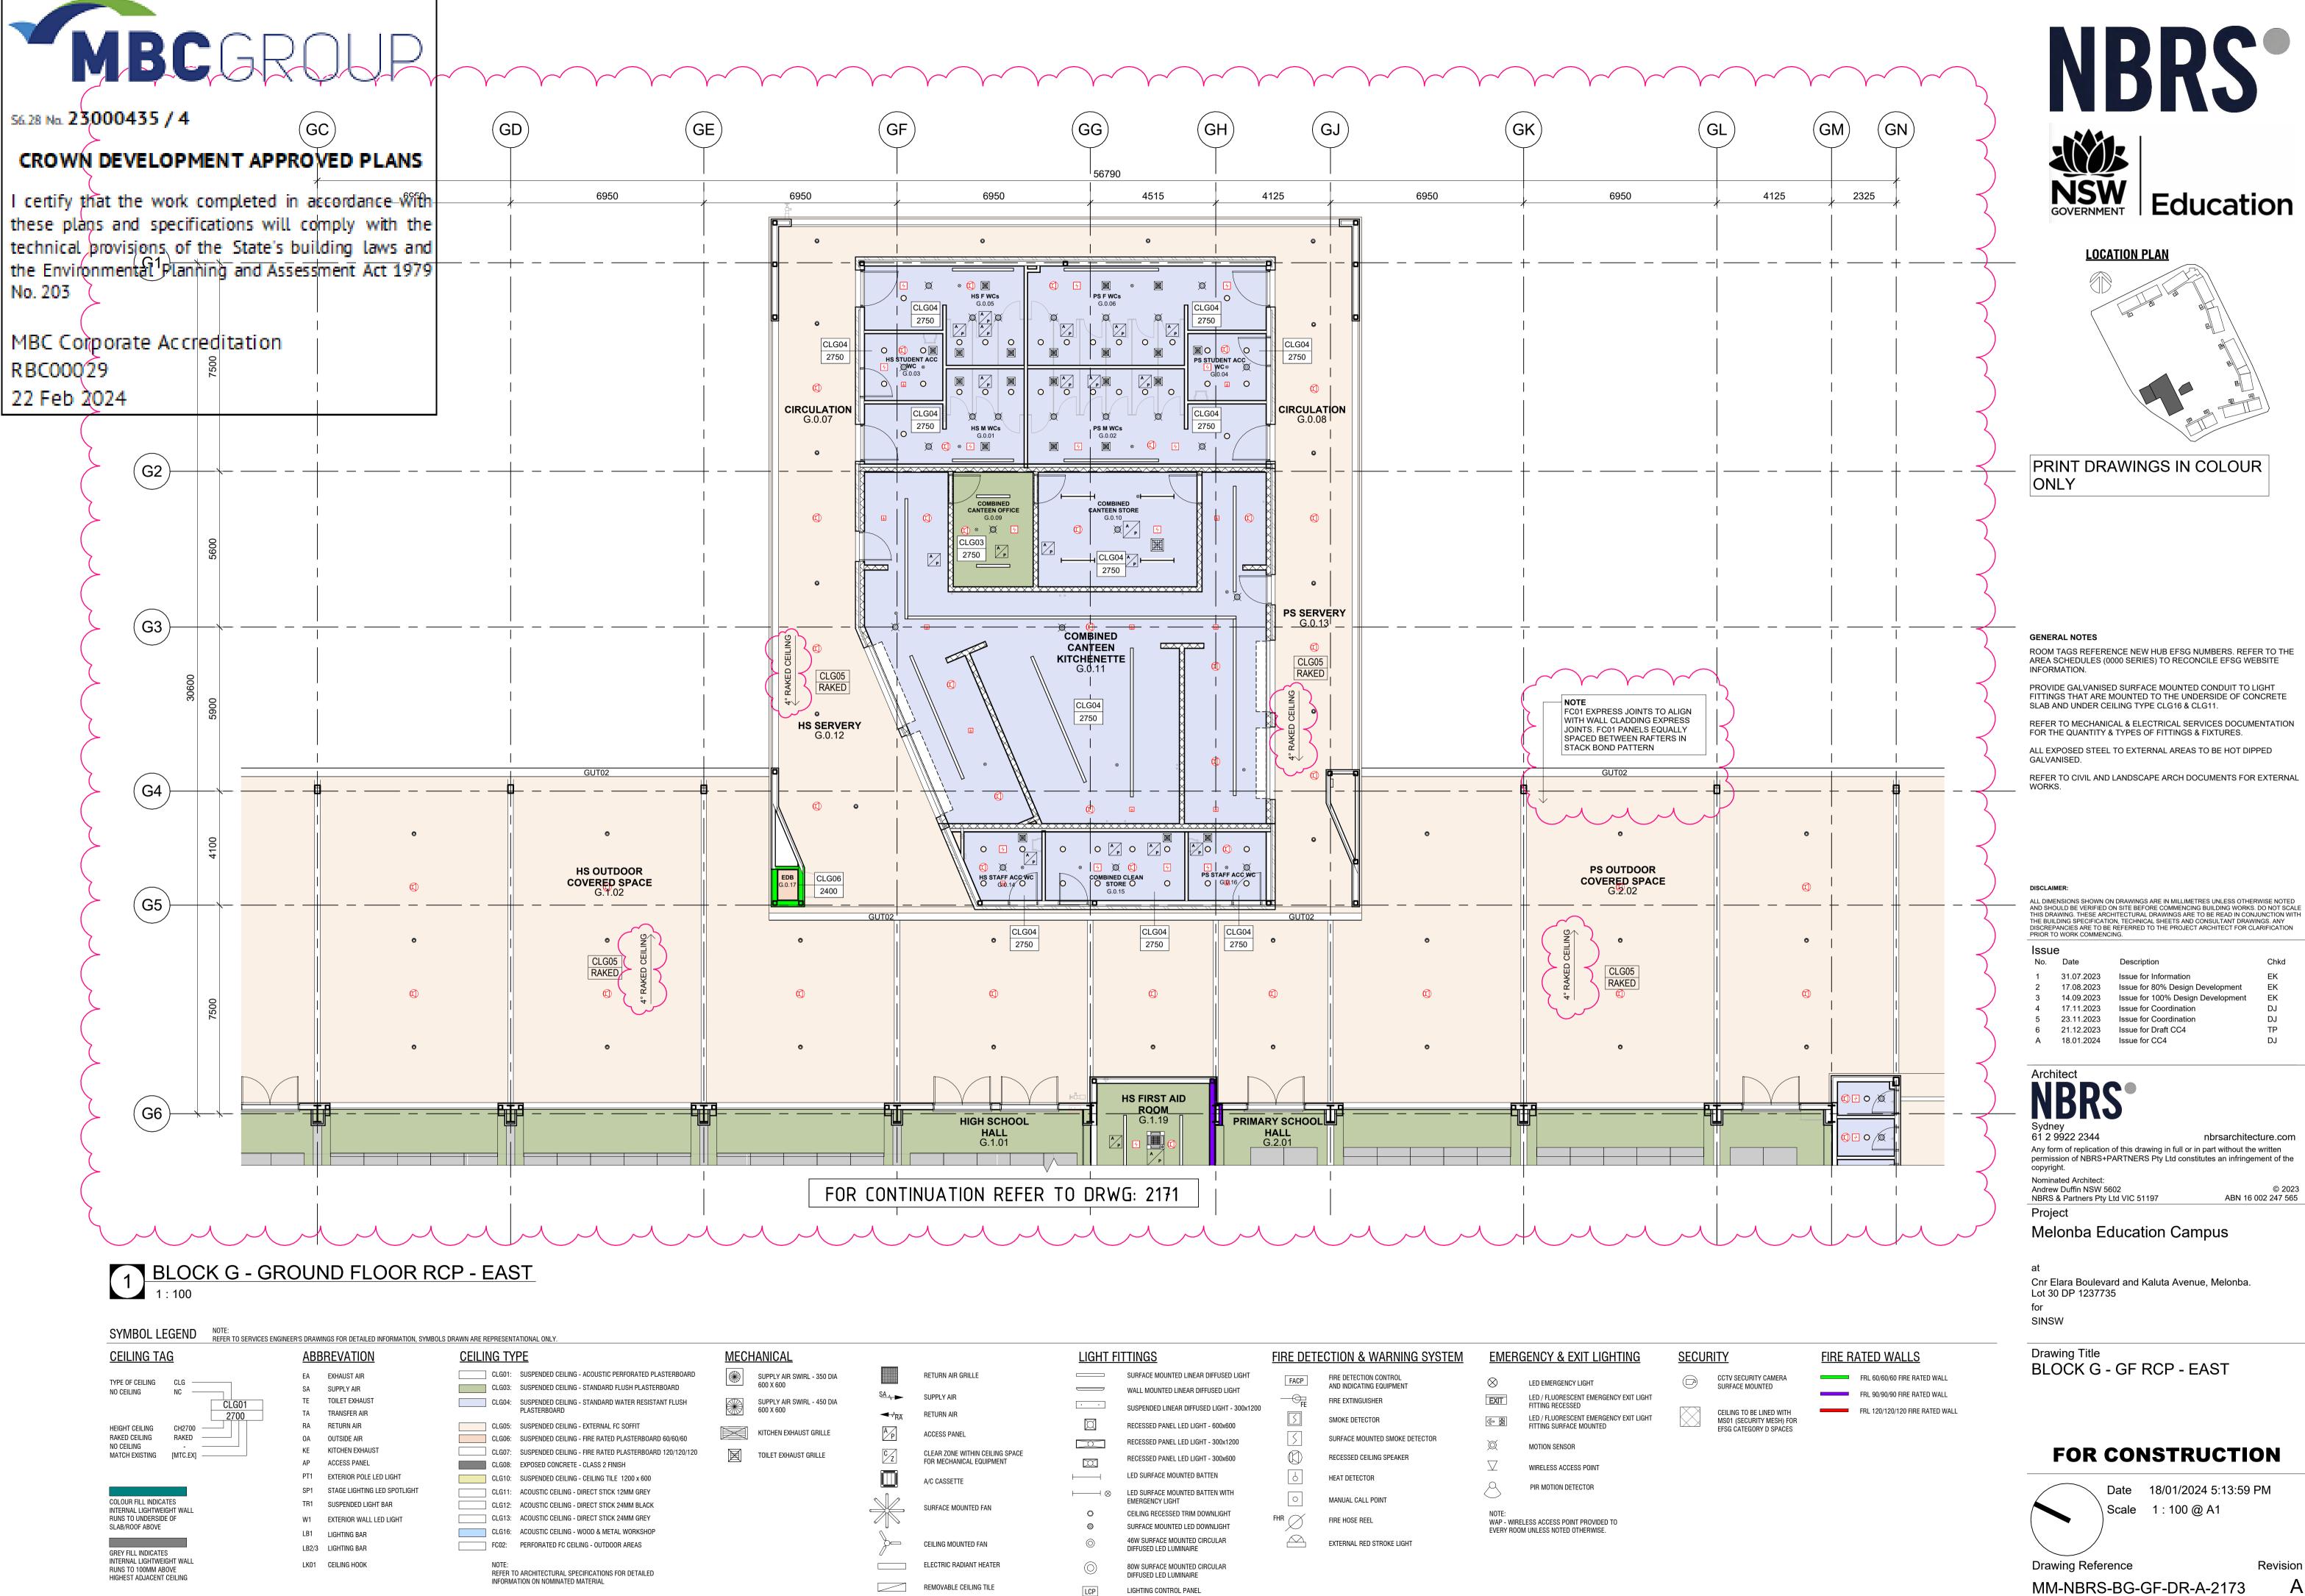

18/01/2024 5:13:59 PM

Revision Α

EK

DJ

© 2023


MBCGROUP

56.28 No. 23000435 / 4

CROWN DEVELOPMENT APPROVED PLANS

I certify that the work completed in accordance with these plans and specifications will comply with the technical provisions of the State's building laws and the Environmental Planning and Assessment Act 1979 No. 203

MBC Corporate Accreditation RBC00029 22 Feb 2024

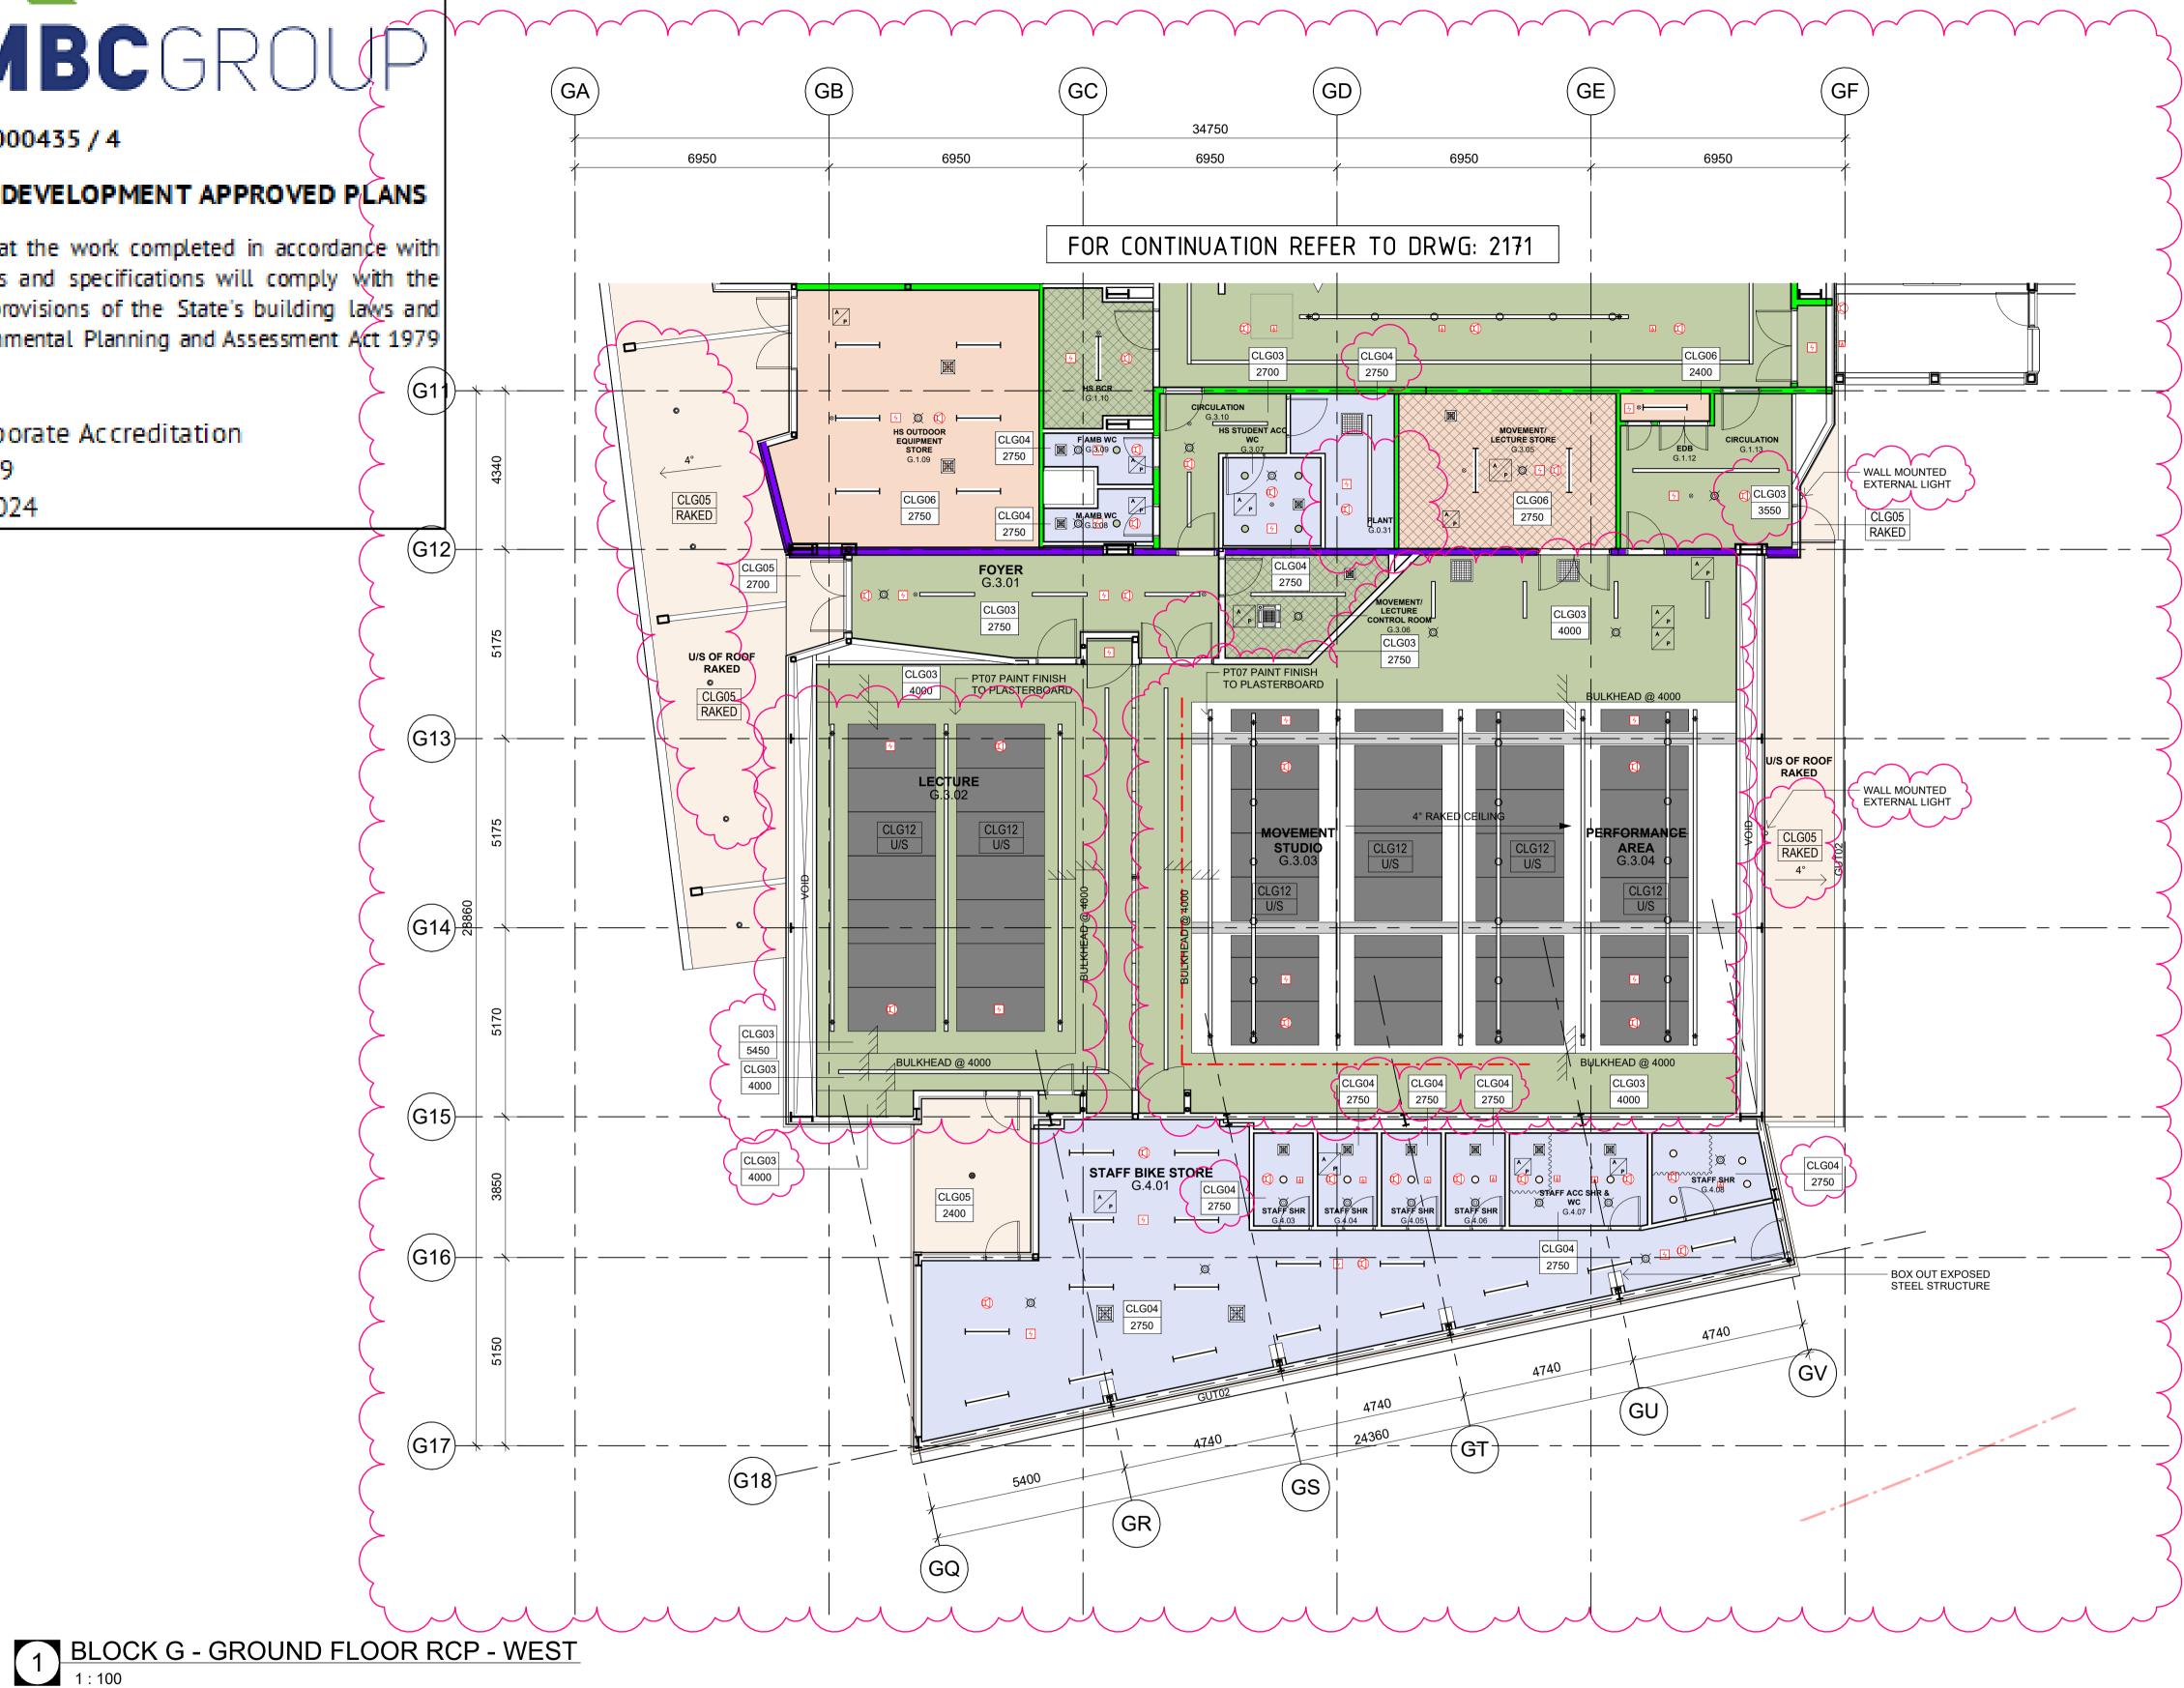



TYPE OF CEILING CLG -NO CEILING NC HEIGHT CEILING CH2700 RAKED CEILING RAKED NO CEILING MATCH EXISTING [MTC.EX]



RUNS TO 100MM ABOVE

HIGHEST ADJACENT CEILING

ABBREVATION EA EXHAUST AIR SA SUPPLY AIR TOILET EXHAUS TA TRANSFER AIR RA RETURN AIR

- 0A OUTSIDE AIR KE KITCHEN EXHAUST AP ACCESS PANEL
- PT1 EXTERIOR POLE LED LIGHT
- SP1 STAGE LIGHTING LED SPOTLIGHT
- TR1 SUSPENDED LIGHT BAR
- W1 EXTERIOR WALL LED LIGHT LB1 LIGHTING BAR
- LB2/3 LIGHTING BAR
- LK01 CEILING HOOK

CLG06: SUSPENDED CEILING - FIRE RATED PLASTERBOARD 60/60/60 CLG07: SUSPENDED CEILING - FIRE RATED PLASTERBOARD 120/120/120 CLG08: EXPOSED CONCRETE - CLASS 2 FINISH CLG10: SUSPENDED CEILING - CEILING TILE 1200 x 600 CLG11: ACOUSTIC CEILING - DIRECT STICK 12MM GREY CLG12: ACOUSTIC CEILING - DIRECT STICK 24MM BLACK CLG13: ACOUSTIC CEILING - DIRECT STICK 24MM GREY CLG16: ACOUSTIC CEILING - WOOD & METAL WORKSHOP FC02: PERFORATED FC CEILING - OUTDOOR AREAS NOTE REFER TO ARCHITECTURAL SPECIFICATIONS FOR DETAILED INFORMATION ON NOMINATED MATERIAL

CLG01: SUSPENDED CEILING - ACOUSTIC PERFORATED PLASTERBOARD

CLG03: SUSPENDED CEILING - STANDARD FLUSH PLASTERBOARD

PLASTERBOARD

CLG05: SUSPENDED CEILING - EXTERNAL FC SOFFIT

CLG04: SUSPENDED CEILING - STANDARD WATER RESISTANT FLUSH

CEILING TYPE

MECHANICAL SUPPLY AIR SWIRL - 350 DIA

V(1)	600 X 600
()	SUPPLY AIR SWIRL - 450 DIA 600 X 600
\ge	KITCHEN EXHAUST GRILLE
X	TOILET EXHAUST GRILLE

		LIGHT FI	<u>TTINGS</u>
	RETURN AIR GRILLE		SURFACE MOUNTED LINEAR
SA 🗸 ►	SUPPLY AIR		WALL MOUNTED LINEAR DIF
-	BETURN AIR	•••	SUSPENDED LINEAR DIFFUSE
		\square	RECESSED PANEL LED LIGH
Γ́ Ρ	ACCESS PANEL	0	RECESSED PANEL LED LIGH
CZ	CLEAR ZONE WITHIN CEILING SPACE FOR MECHANICAL EQUIPMENT		RECESSED PANEL LED LIGH
	A/C CASSETTE		LED SURFACE MOUNTED BA
		$\longmapsto \otimes$	LED SURFACE MOUNTED BA EMERGENCY LIGHT
	SURFACE MOUNTED FAN	0	CEILING RECESSED TRIM DO
<pre>%</pre>		ø	SURFACE MOUNTED LED DO
Þ	CEILING MOUNTED FAN	\odot	46W SURFACE MOUNTED CI DIFFUSED LED LUMINAIRE
	ELECTRIC RADIANT HEATER	\bigcirc	80W SURFACE MOUNTED CI DIFFUSED LED LUMINAIRE
	REMOVABLE CEILING TILE	LCP	LIGHTING CONTROL PANEL

FIRE DETECTION & WARNING SYSTEM

ounted linear diffused light Ited linear diffused light	FAC
LINEAR DIFFUSED LIGHT - 300x1200	
PANEL LED LIGHT - 600x600	
PANEL LED LIGHT - 300x1200	5
PANEL LED LIGHT - 300x600	K
CE MOUNTED BATTEN	6
CE MOUNTED BATTEN WITH / LIGHT	0
CESSED TRIM DOWNLIGHT	FHR 📿
OUNTED LED DOWNLIGHT	X
CE MOUNTED CIRCULAR ED LUMINAIRE	
CE MOUNTED CIRCULAR	

Ē	FIRE EXTINGUISHER
	SMOKE DETECTOR
	SURFACE MOUNTED SMOKE DETECTOR
	RECESSED CEILING SPEAKER
	HEAT DETECTOR

FIRE DETECTION CONTROL

AND INDICATING EQUIPMENT

MANUAL CALL POINT

FIRE HOSE REEL

EXTERNAL RED STROKE LIGHT

EMERGENCY & EXIT LIGHTING

 \otimes LED EMERGENCY LIGHT LED / FLUORESCENT EMERGENCY EXIT LIGHT EXIT FITTING RECESSED LED / FLUORESCENT EMERGENCY EXIT LIGHT (~ 🏠 FITTING SURFACE MOUNTED Ø MOTION SENSOR WIRELESS ACCESS POINT

PIR MOTION DETECTOR

NOTE:

<u>SECURITY</u>

CCTV SECURITY CAMERA SURFACE MOUNTED

> CEILING TO BE LINED WITH MS01 (SECURITY MESH) FOR EFSG CATEGORY D SPACES

FIRE RATED WALLS

FRL 60/60/60 FIRE RATED WALL


FRL 120/120/120 FIRE RATED WALL

FRL 90/90/90 FIRE RATED WALL

WAP - WIRELESS ACCESS POINT PROVIDED TO EVERY ROOM UNLESS NOTED OTHERWISE.



LOCATION PLAN

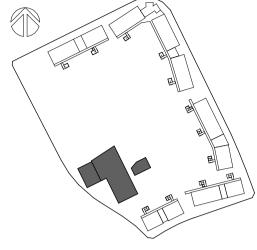

PRINT DRAWINGS IN COLOUR ONLY

GENERAL NOTES

ROOM TAGS REFERENCE NEW HUB EFSG NUMBERS. REFER TO THE AREA SCHEDULES (0000 SERIES) TO RECONCILE EFSG WEBSITE INFORMATION.

PROVIDE GALVANISED SURFACE MOUNTED CONDUIT TO LIGHT FITTINGS THAT ARE MOUNTED TO THE UNDERSIDE OF CONCRETE SLAB AND UNDER CEILING TYPE CLG16 & CLG11.

GALVANISED.

WORKS.

REFER TO MECHANICAL & ELECTRICAL SERVICES DOCUMENTATION FOR THE QUANTITY & TYPES OF FITTINGS & FIXTURES.

ALL EXPOSED STEEL TO EXTERNAL AREAS TO BE HOT DIPPED

REFER TO CIVIL AND LANDSCAPE ARCH DOCUMENTS FOR EXTERNAL

DISCLAIMER

ALL DIMENSIONS SHOWN ON DRAWINGS ARE IN MILLIMETRES UNLESS OTHERWISE NOTED AND SHOULD BE VERIFIED ON SITE BEFORE COMMENCING BUILDING WORKS. DO NOT SCALE THIS DRAWING. THESE ARCHITECTURAL DRAWINGS ARE TO BE READ IN CONJUNCTION WITH THE BUILDING SPECIFICATION, TECHNICAL SHEETS AND CONSULTANT DRAWINGS. ANY DISCREPANCIES ARE TO BE REFERRED TO THE PROJECT ARCHITECT FOR CLARIFICATION PRIOR TO WORK COMMENCING.

lssu	е		
No.	Date	Description	Chkd
1	31.07.2023	Issue for Information	EK
2	17.08.2023	Issue for 80% Design Development	EK
3	14.09.2023	Issue for 100% Design Development	EK
4	20.09.2023	Issue with DDA Updates	EK
5	17.11.2023	Issue for Coordination	DJ
6	23.11.2023	Issue for Coordination	DJ
7	21.12.2023	Issue for Draft CC4	TP
Α	18.01.2024	Issue for CC4	DJ



IDDC













nbrsarchitecture.com

permission of NBRS+PARTNERS Pty Ltd constitutes an infringement of the

Nominated Architect: Andrew Duffin NSW 5602 © 2023 ABN 16 002 247 565 NBRS & Partners Pty Ltd VIC 51197

Melonba Education Campus

copyright.

Project

Cnr Elara Boulevard and Kaluta Avenue, Melonba. Lot 30 DP 1237735 for

SINSW

Drawing Title

Drawing Reference


BLOCK G - GF RCP - WEST




Date 18/01/2024 5:10:23 PM Scale 1:100@A1

MM-NBRS-BG-GF-DR-A-2174

Revision

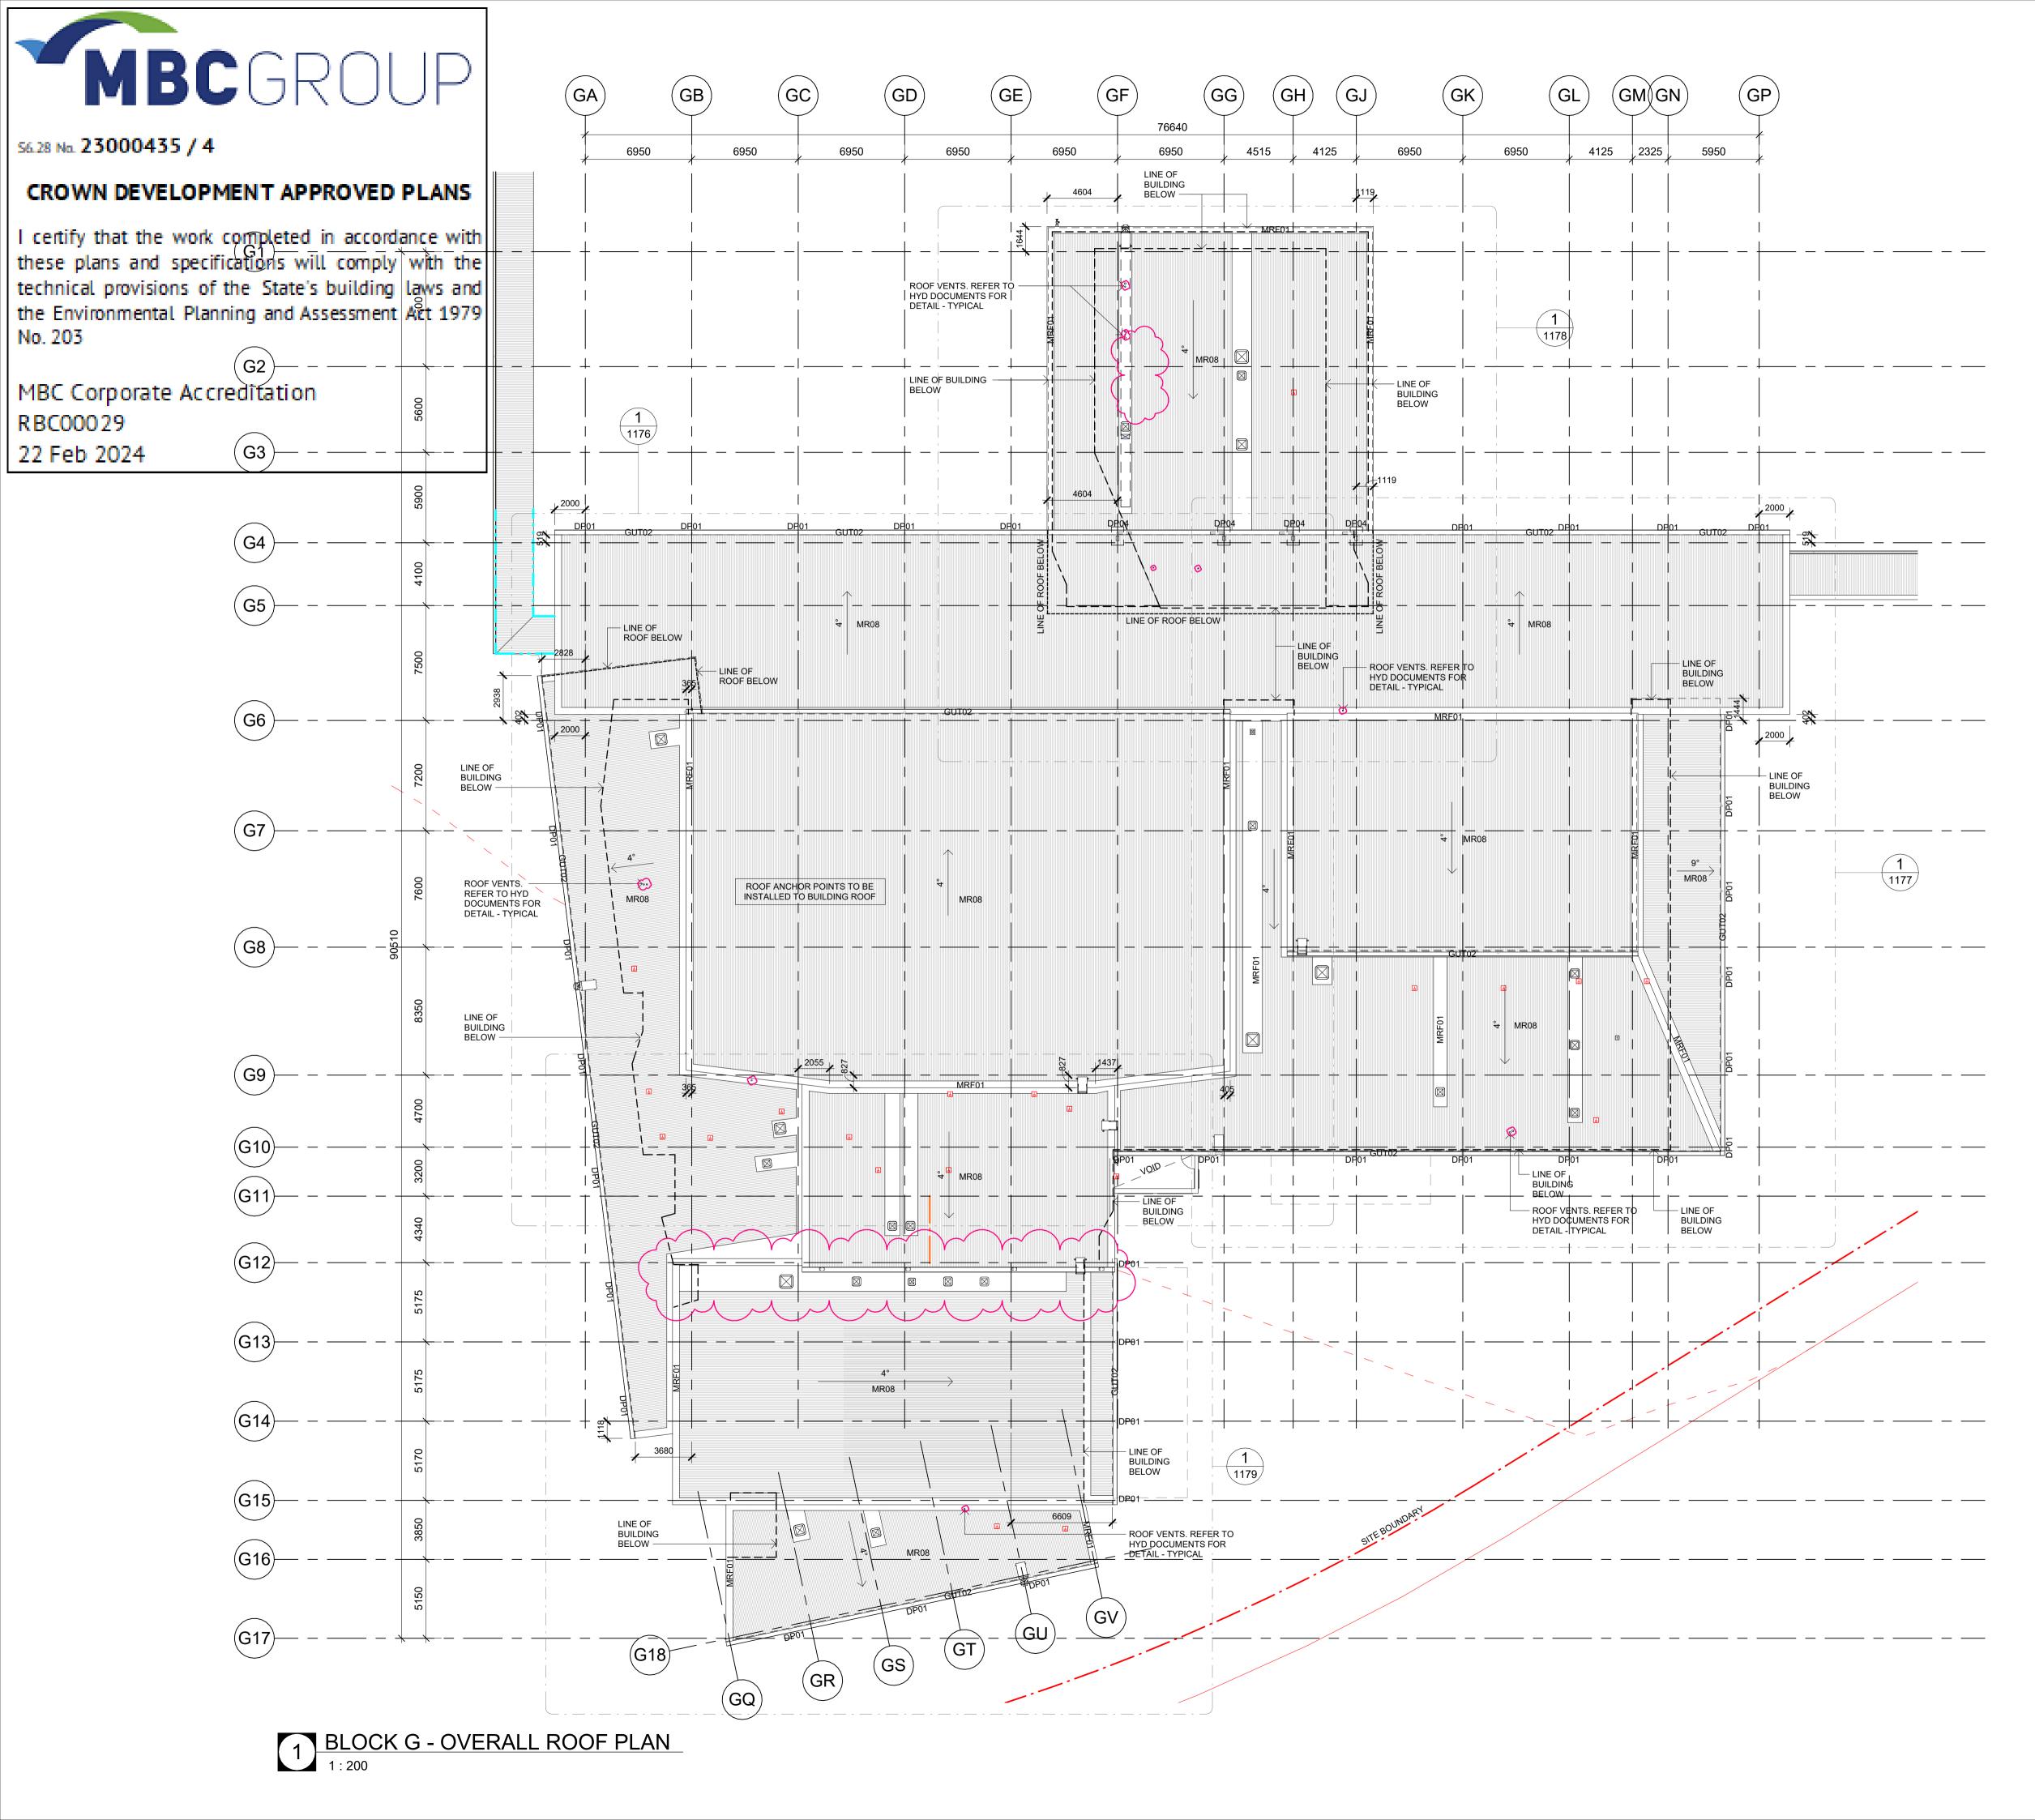



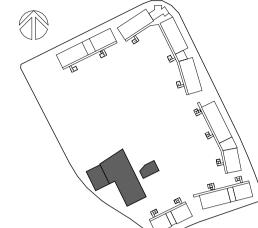

GENERAL NOTES

1. CONTRACTOR TO MAKE PROVISION & FACILITATE THE DESIGN, DOCUMENTATION & CONSTRUCTION OF ROOF ACCESS, ROOF MOUNTED WALKWAYS & FALL PREVENTION ANCHORS. THE DESIGN & DOCUMENTATION OF ROOF ACCESS & FALL PREVENTION IS TO BE CARRIED OUT IN CONSULTATION WITH THE ARCHITECT.

2. EXTENT OF ROOF ACCESS AND FALL PREVENTION ARE INDICATIVE ONLY.

3. PROVIDE ADDITIONAL SUPPORTS IN WALL FRAMING, CEILING FRAMING AND ROOF FRAMING TO ACCOMMODATE WALL, CEILING OR ROOF HUNG FITOUT, FIXTURE AND EQUIPMENT.

CODE DESCRIPTION

DP01 DOWNPIPE 150 OD WITH 2100H GAL CHS SLEEVE DP04 DOWNPIPE SPREADER 150 OD

GUT01 VALLEY GUTTER GUT02 300 HALF ROUND GUTTER GUT03 150 HALF ROUND GUTTER

GUTG GUTTER GUARD

MR08 METAL ROOFING - KLIPLOK MRF01 METAL FLASHING - ROOF

MFP01 METAL FLASHING - PARAPET FLASHING MFP02 METAL FLASHING - PARAPET CLADDING

PV PHOTOVOLTAIC PANEL

RAH05 ROOF ACCESS - PERMANENT LADDER

INAL 103	ROOF ACCESS - FERMANENT LADDER
RAH06	ROOF ACCESS - SUPPORT BRACKET
RAH07	ROOF ACCESS - WALKWAY
RAH08	ROOF ACCESS - INTERMEDIATE LANDING

DISCLAIMER

ALL DIMENSIONS SHOWN ON DRAWINGS ARE IN MILLIMETRES UNLESS OTHERWISE NOTED AND SHOULD BE VERIFIED ON SITE BEFORE COMMENCING BUILDING WORKS. DO NOT SCALE THIS DRAWING. THESE ARCHITECTURAL DRAWINGS ARE TO BE READ IN CONJUNCTION WITH THE BUILDING SPECIFICATION, TECHNICAL SHEETS AND CONSULTANT DRAWINGS. ANY DISCREPANCIES ARE TO BE REFERRED TO THE PROJECT ARCHITECT FOR CLARIFICATION PRIOR TO WORK COMMENCING.

	1		01	 ~	۰
1					
			~	 ~	
		- C	C	р	

e		
Date	Description	Chkd
17.08.2023	Issue for 80% Design Development	EK
14.09.2023	Issue for 100% Design Development	EK
23.11.2023	Issue for Coordination	DJ
21.12.2023	Issue for Draft CC4	TP
11.01.2024	For Coordination	DJ
18.01.2024	Issue for CC4	DJ
	Date 17.08.2023 14.09.2023 23.11.2023 21.12.2023 11.01.2024	DateDescription17.08.2023Issue for 80% Design Development14.09.2023Issue for 100% Design Development23.11.2023Issue for Coordination21.12.2023Issue for Draft CC411.01.2024For Coordination



61 2 9922 2344 nbrsarchitecture.com Any form of replication of this drawing in full or in part without the written permission of NBRS+PARTNERS Pty Ltd constitutes an infringement of the copyright. Nominated Architect:

Andrew Duffin NSW 5602 © 2023 ABN 16 002 247 565 NBRS & Partners Pty Ltd VIC 51197 Project

Melonba Education Campus

Cnr Elara Boulevard and Kaluta Avenue, Melonba. Lot 30 DP 1237735 for


SINSW

Drawing Title


BLOCK G - OVERALL ROOF PLAN


FOR CONSTRUCTION

Date 18/01/2024 5:10:06 PM Scale As indicated @ A1

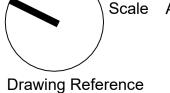


MM-NBRS-BG-LR-DR-A-1175

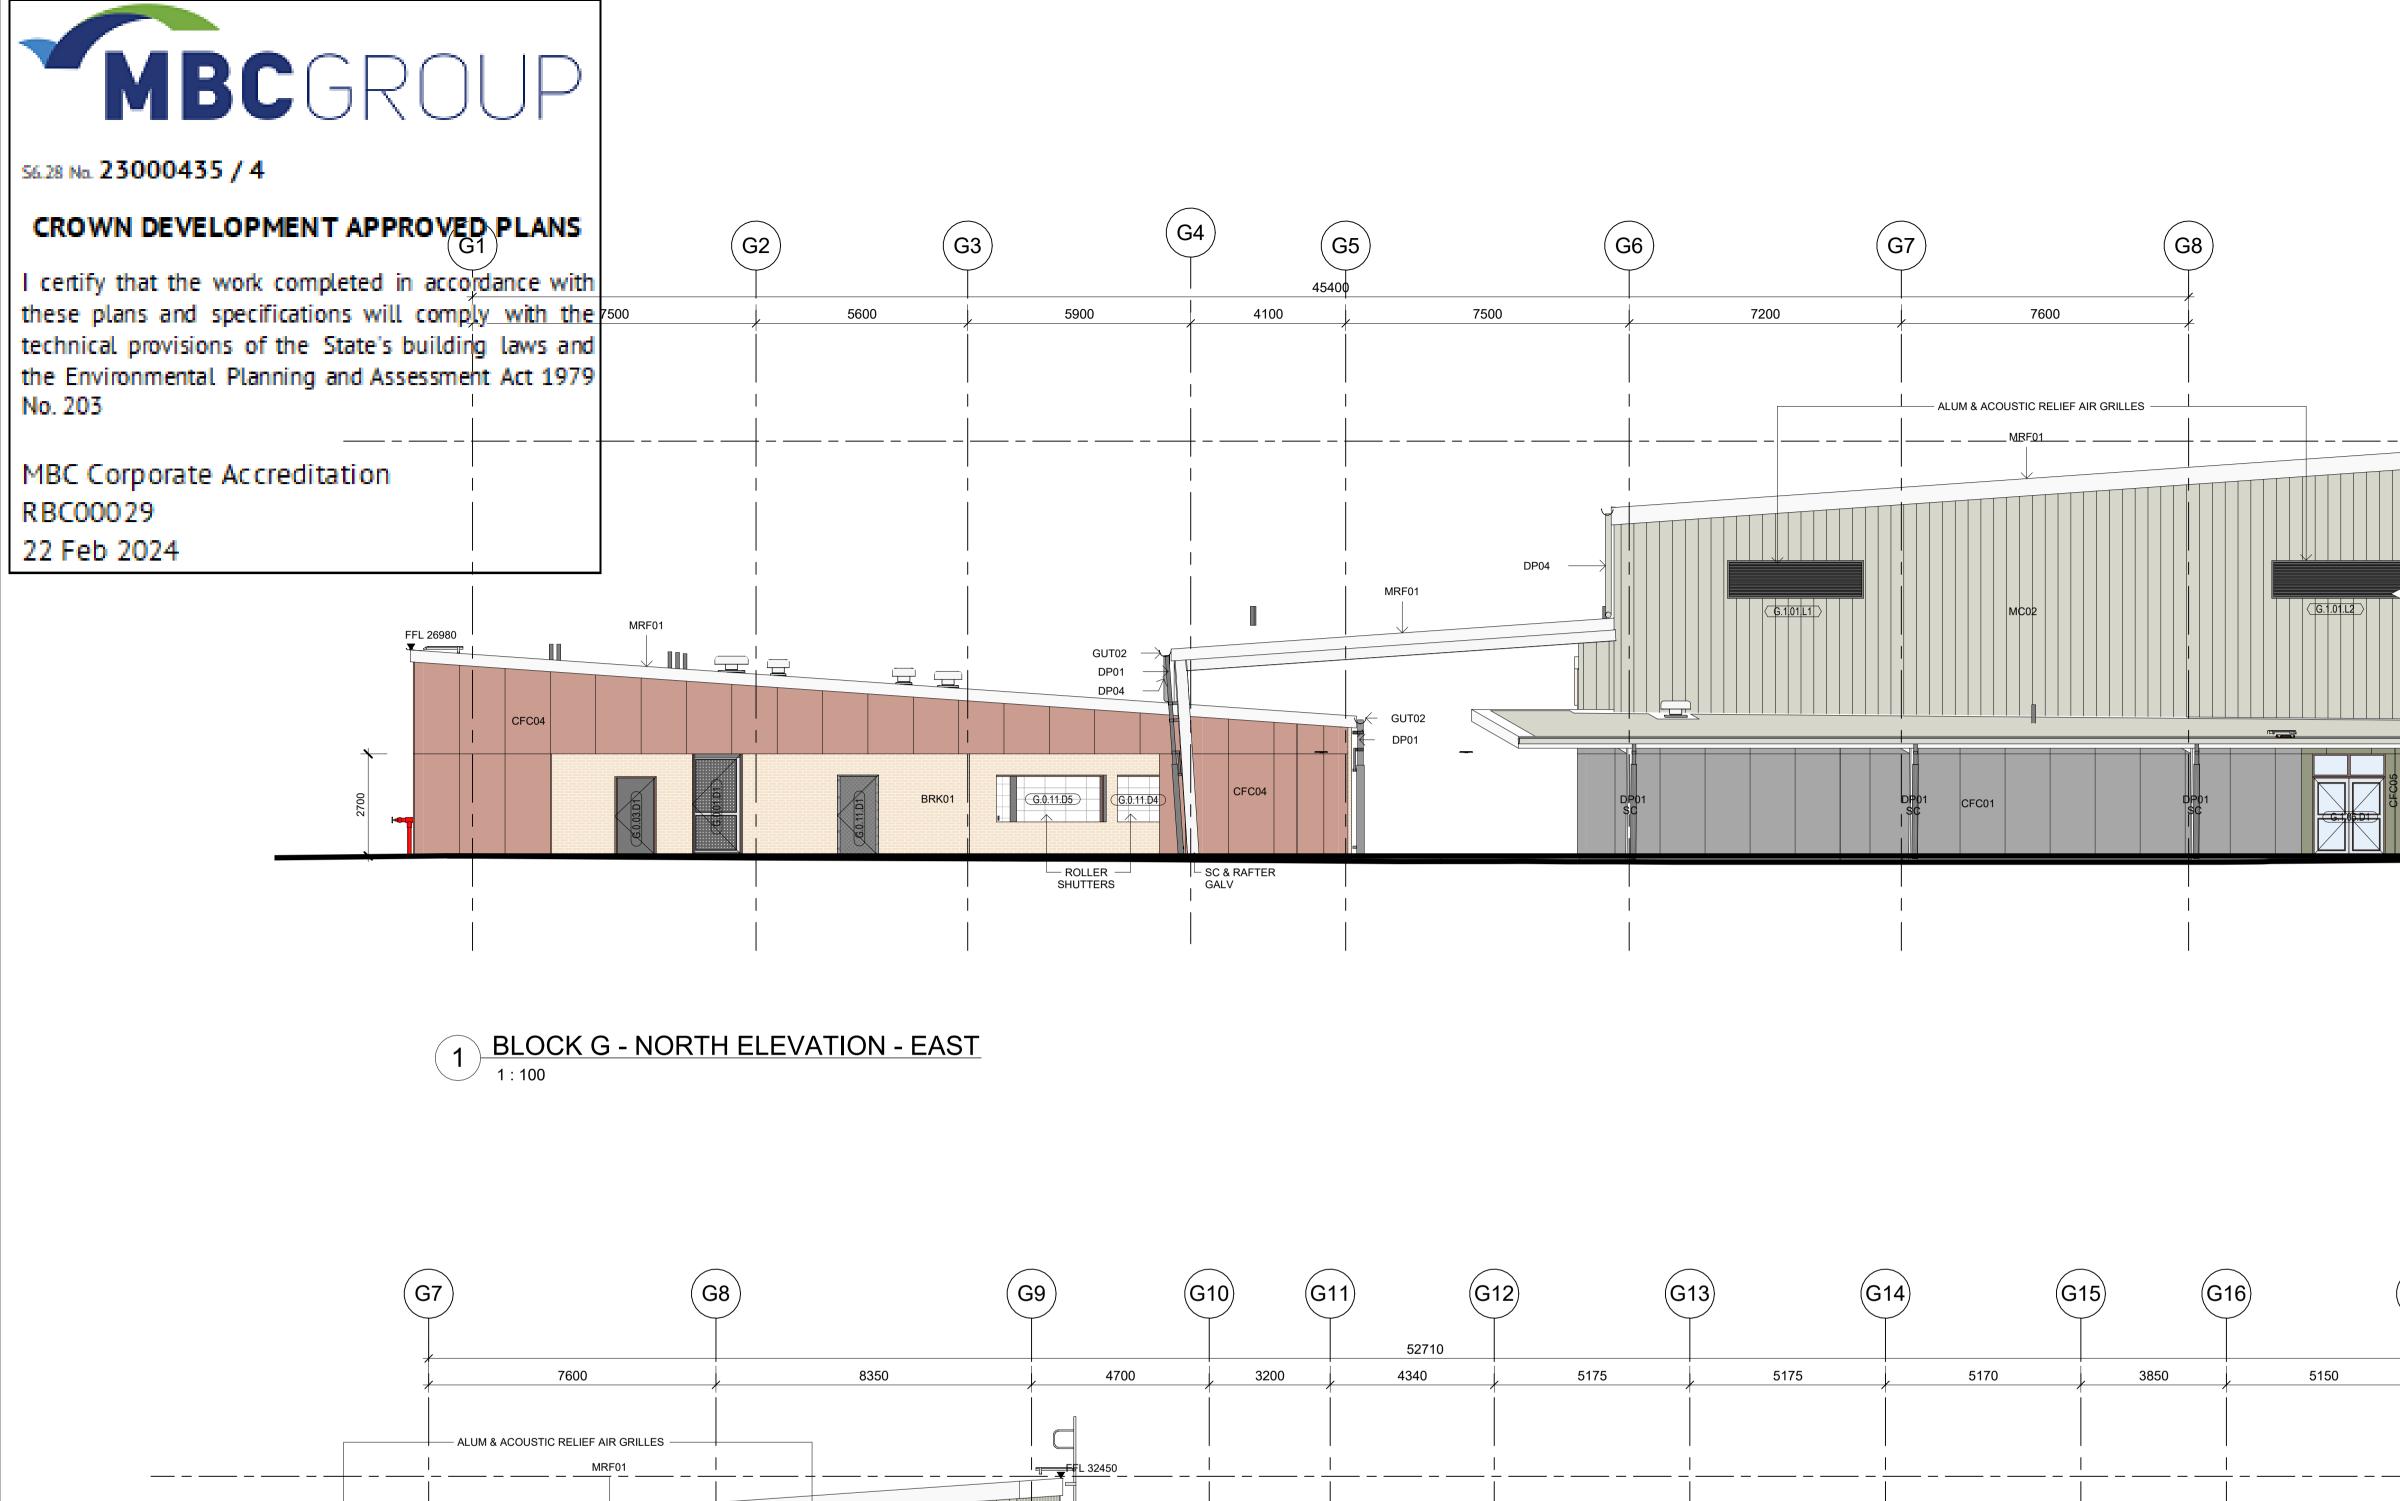

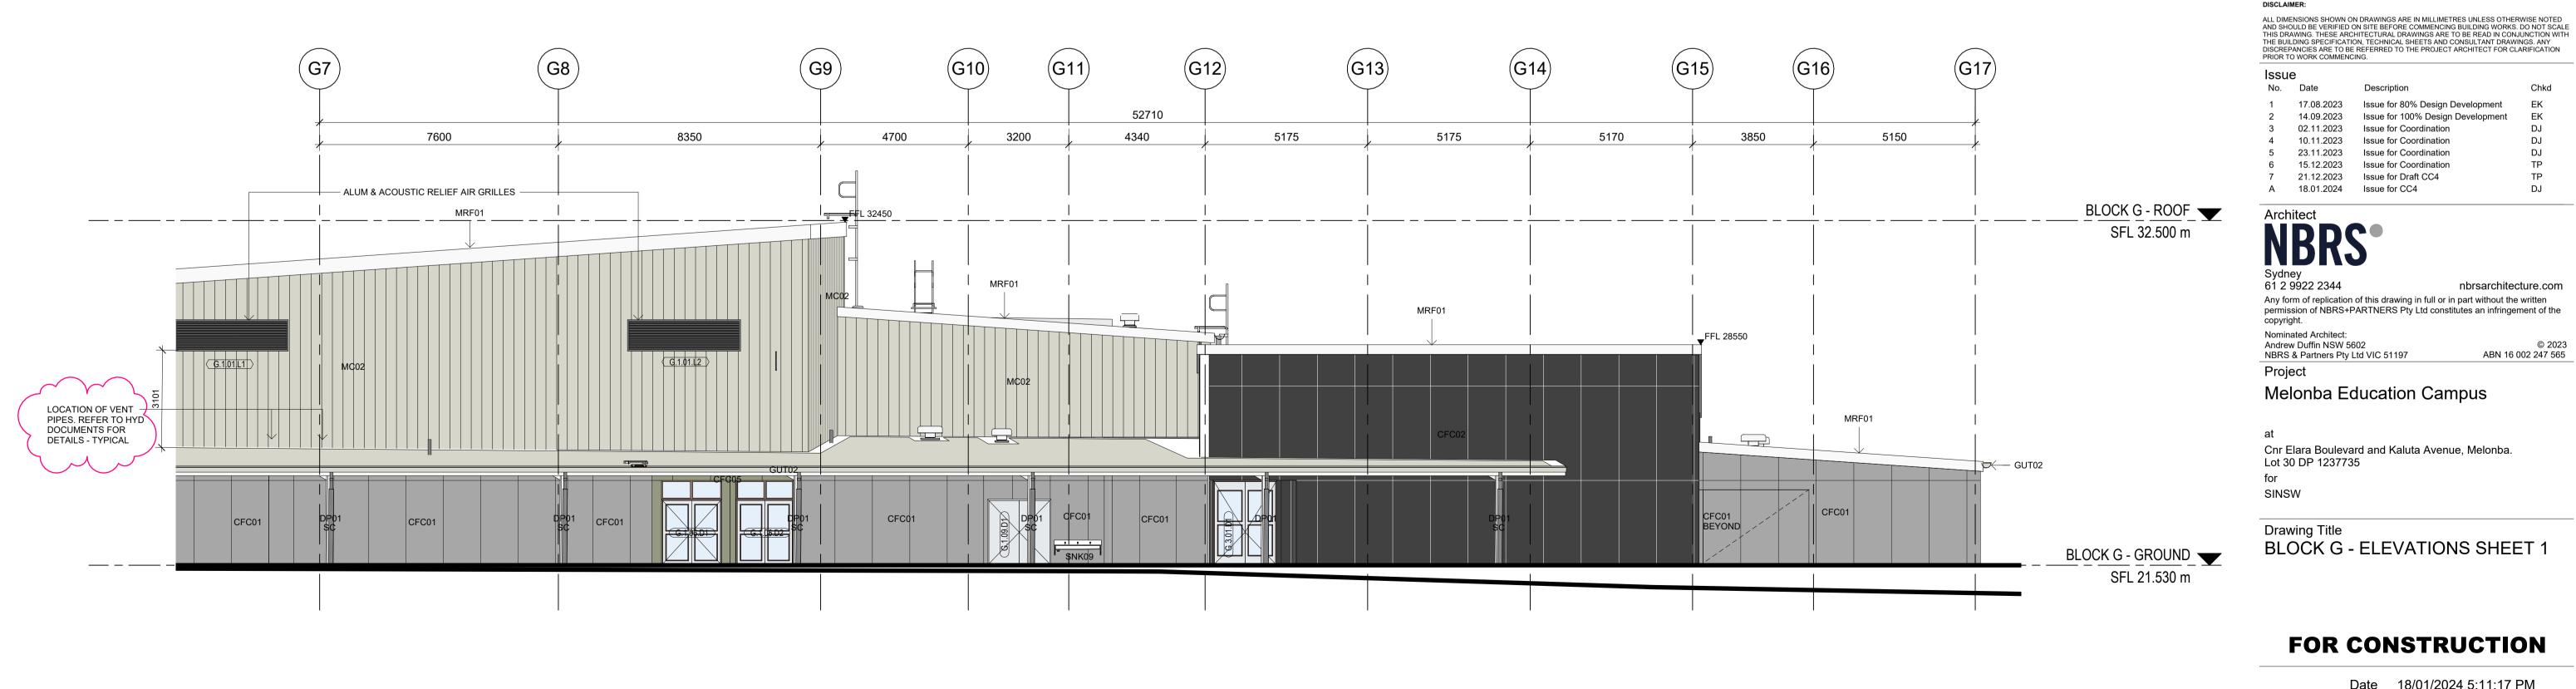

2 BLOCK G - NORTH ELEVATION - WEST

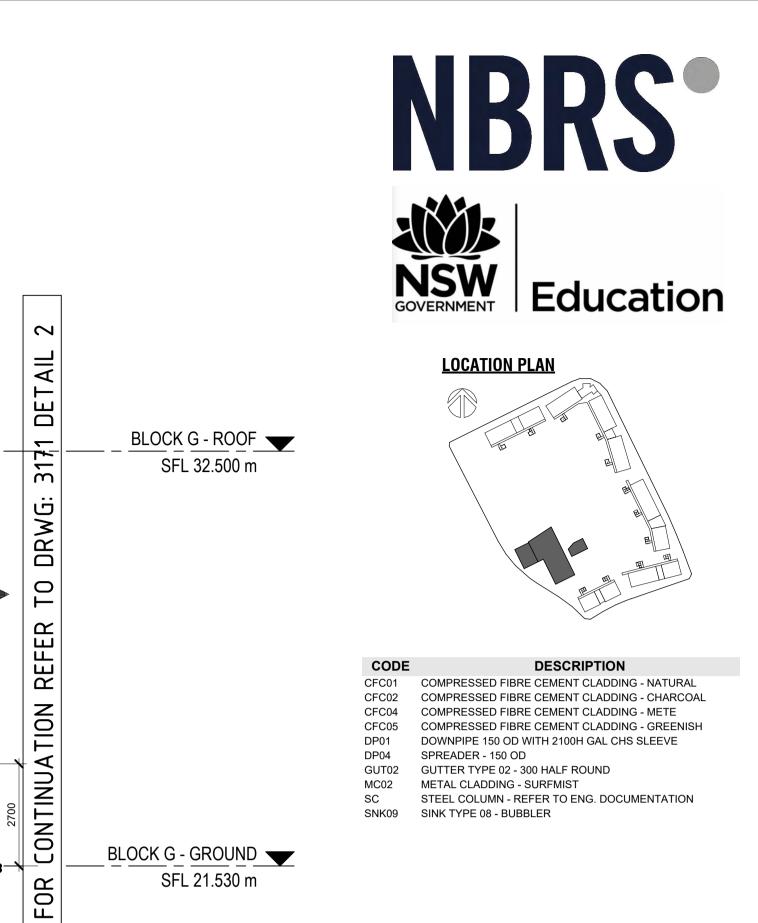


Date 18/01/2024 5:11:17 PM Scale 1:100 @ A1


Revision

MM-NBRS-BG-ZZ-DR-A-3171 A

Drawing Reference

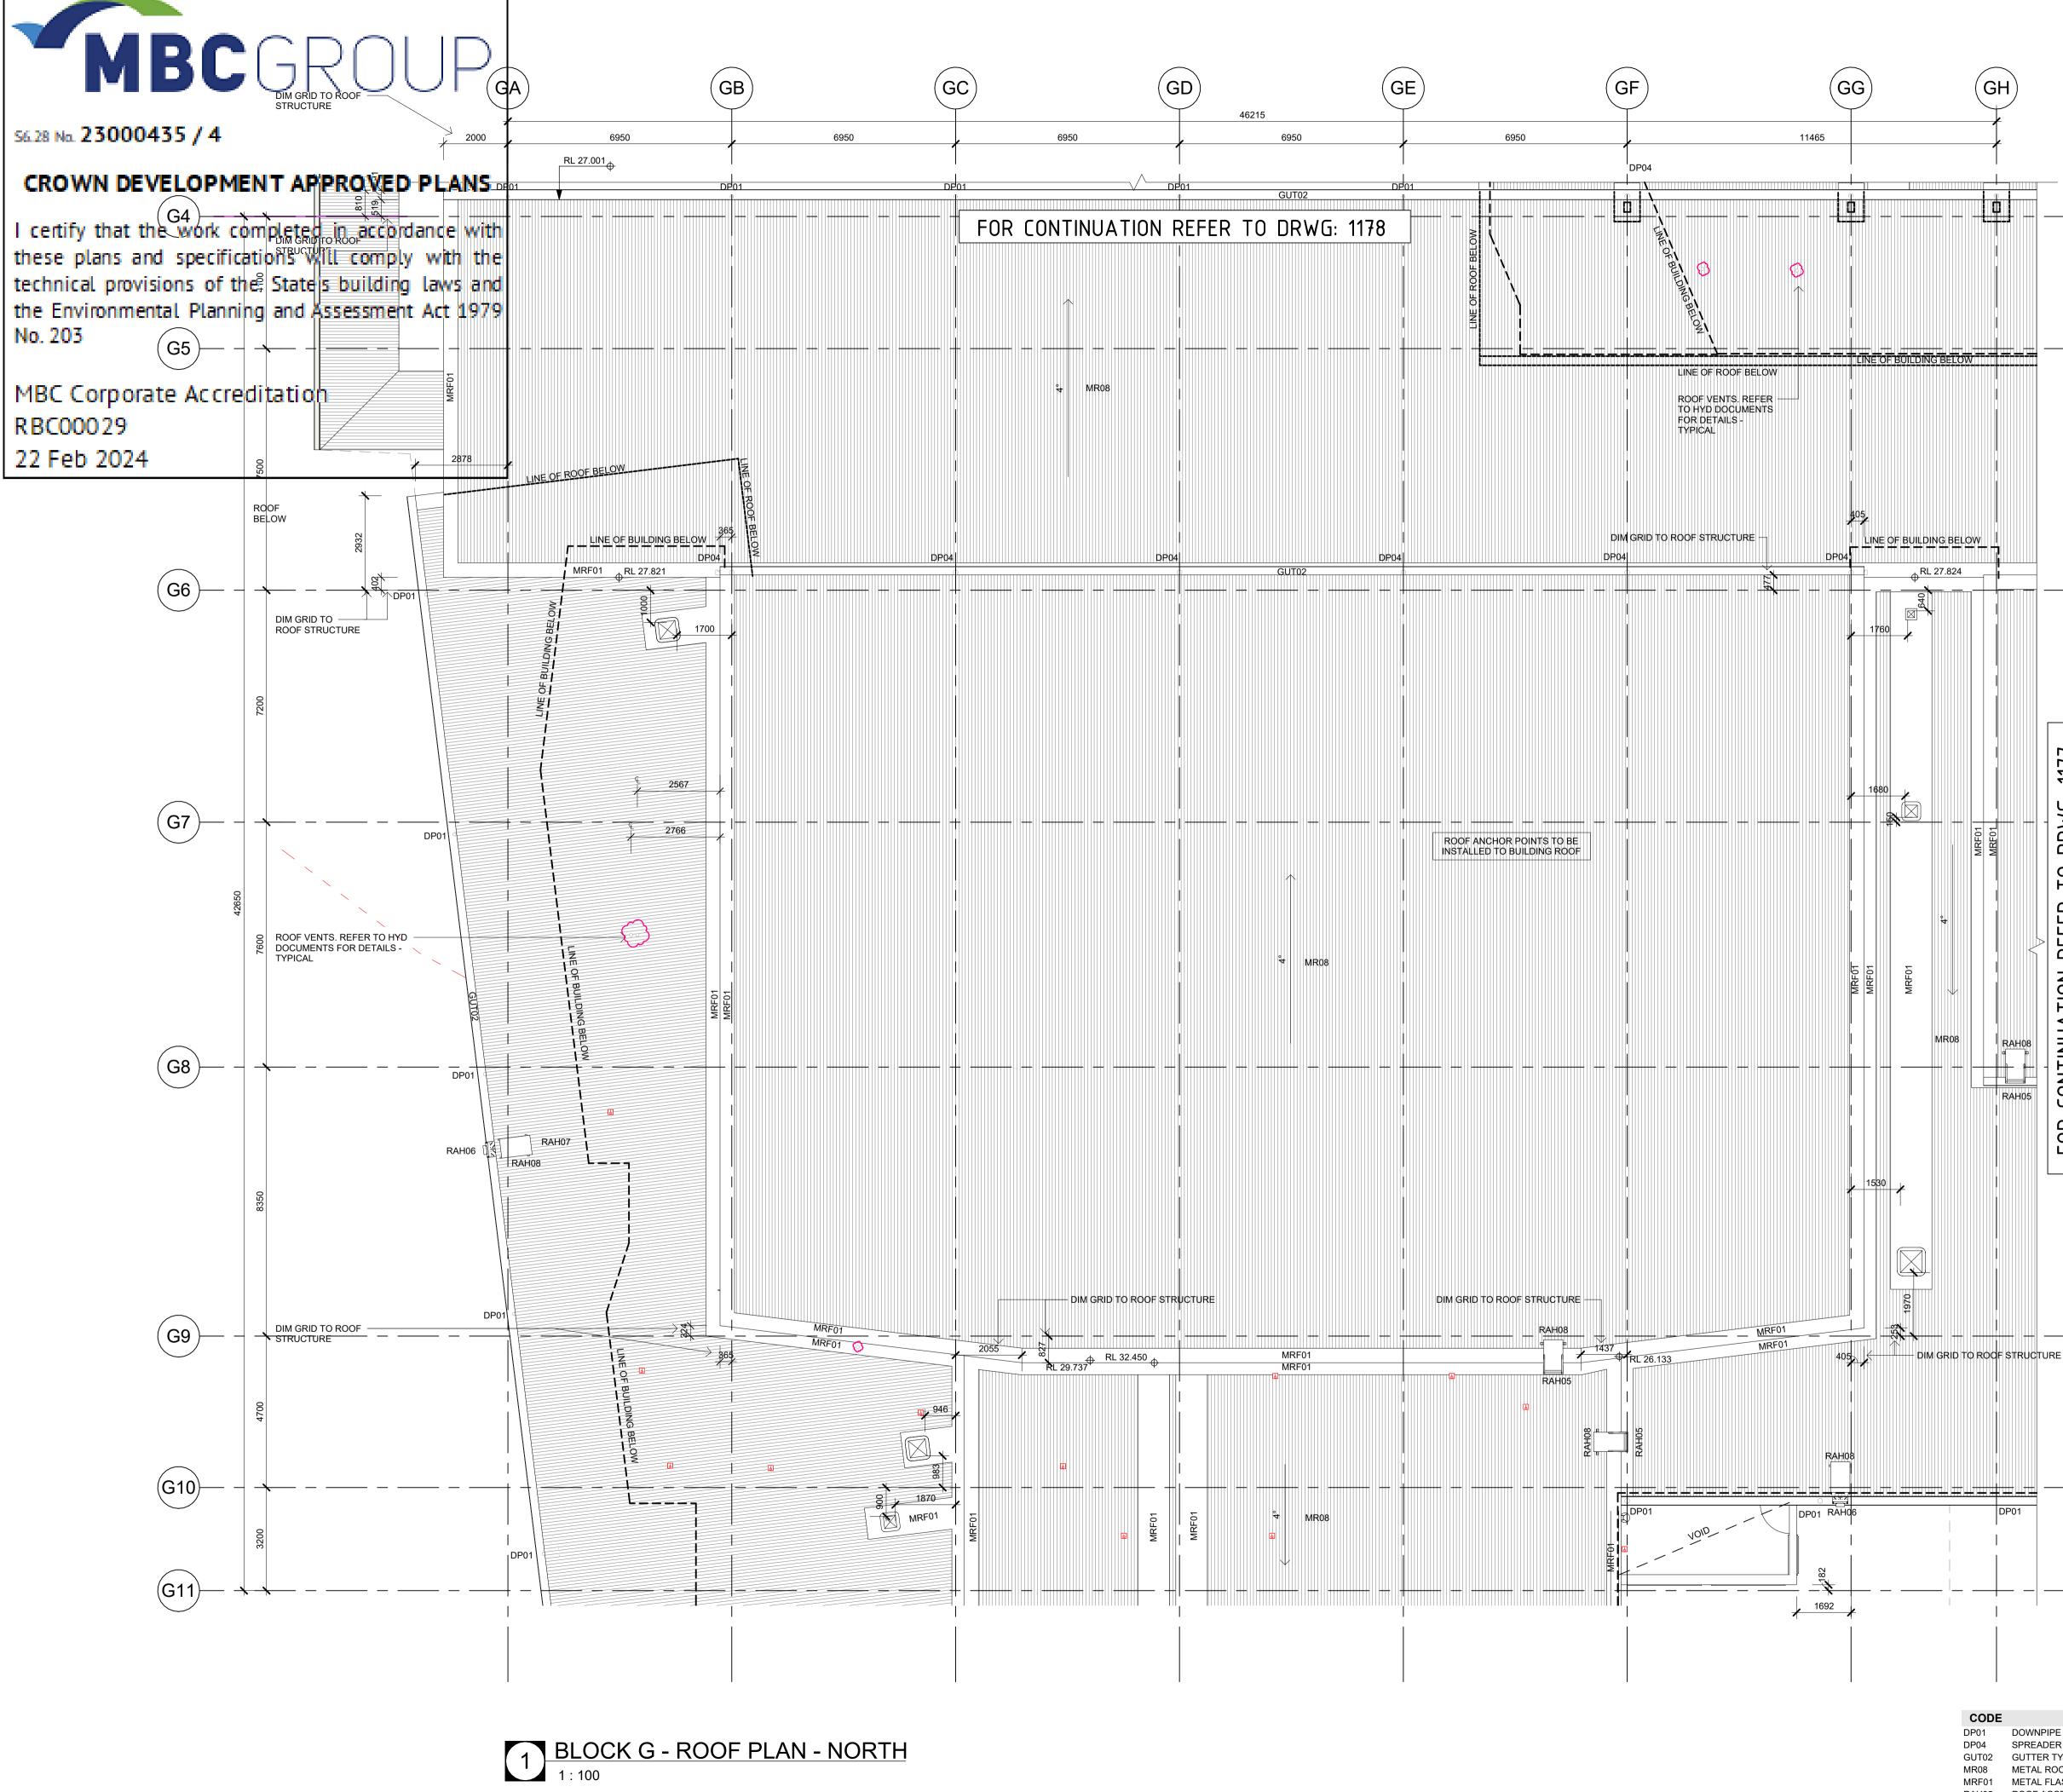



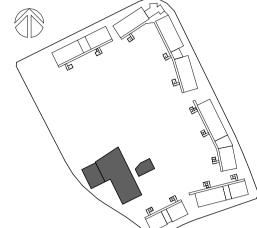

GENERAL NOTES

1. CONTRACTOR TO MAKE PROVISION & FACILITATE THE DESIGN, DOCUMENTATION & CONSTRUCTION OF ROOF ACCESS, ROOF MOUNTED WALKWAYS & FALL PREVENTION ANCHORS. THE DESIGN & DOCUMENTATION OF ROOF ACCESS & FALL PREVENTION IS TO BE CARRIED OUT IN CONSULTATION WITH THE ARCHITECT.

2. EXTENT OF ROOF ACCESS AND FALL PREVENTION ARE INDICATIVE ONLY.

3. PROVIDE ADDITIONAL SUPPORTS IN WALL FRAMING, CEILING FRAMING AND ROOF FRAMING TO ACCOMMODATE WALL, CEILING OR ROOF HUNG FITOUT, FIXTURE AND EQUIPMENT.

CODE DESCRIPTION

DP01 DOWNPIPE 150 OD WITH 2100H GAL CHS SLEEVE DP04 DOWNPIPE SPREADER 150 OD

GUT01 VALLEY GUTTER GUT02 300 HALF ROUND GUTTER GUT03 150 HALF ROUND GUTTER

GUTG GUTTER GUARD

MR08 METAL ROOFING - KLIPLOK MRF01 METAL FLASHING - ROOF

MFP01 METAL FLASHING - PARAPET FLASHING MFP02 METAL FLASHING - PARAPET CLADDING

PV PHOTOVOLTAIC PANEL

RAH05 ROOF ACCESS - PERMANENT LADDER

1000	ROOF ACCESS - I ERMANENT EADDER
RAH06	ROOF ACCESS - SUPPORT BRACKET
RAH07	ROOF ACCESS - WALKWAY
RAH08	ROOF ACCESS - INTERMEDIATE LANDING

DISCLAIMER

ALL DIMENSIONS SHOWN ON DRAWINGS ARE IN MILLIMETRES UNLESS OTHERWISE NOTED AND SHOULD BE VERIFIED ON SITE BEFORE COMMENCING BUILDING WORKS. DO NOT SCALE THIS DRAWING. THESE ARCHITECTURAL DRAWINGS ARE TO BE READ IN CONJUNCTION WITH THE BUILDING SPECIFICATION, TECHNICAL SHEETS AND CONSULTANT DRAWINGS. ANY DISCREPANCIES ARE TO BE REFERRED TO THE PROJECT ARCHITECT FOR CLARIFICATION PRIOR TO WORK COMMENCING.

FRIOR	10	000
1001		

Issu	е		
No.	Date	Description	Chkd
1	17.08.2023	Issue for 80% Design Development	EK
2	14.09.2023	Issue for 100% Design Development	EK
3	23.11.2023	Issue for Coordination	DJ
4	21.12.2023	Issue for Draft CC4	TP
5	11.01.2024	For Coordination	DJ
А	18.01.2024	Issue for CC4	DJ



61 2 9922 2344 nbrsarchitecture.com Any form of replication of this drawing in full or in part without the written permission of NBRS+PARTNERS Pty Ltd constitutes an infringement of the

copyright. Nominated Architect: Andrew Duffin NSW 5602 © 2023 ABN 16 002 247 565 NBRS & Partners Pty Ltd VIC 51197

Project Melonba Education Campus


Cnr Elara Boulevard and Kaluta Avenue, Melonba. Lot 30 DP 1237735 for

SINSW

Drawing Title

BLOCK G - ROOF PLAN - NORTH


FOR (CONSTR	UCTION
-------	--------	--------

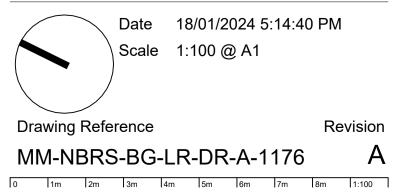

1 1 Ü \geq Ц Ο К ш ш Ц NOI INUA -. NOD Ц FOI


_ ___

DESCRIPTION DOWNPIPE 150 OD WITH 2100H GAL CHS SLEEVE SPREADER - 150 OD GUTTER TYPE 02 - 300 HALF ROUND METAL ROOFING - KLIPLOK METAL FLASHING - ROOF ROOF ACCESS - PERMANENT LADDER ROOF ACCESS - SUPPORT BRACKET RAH08 ROOF ACCESS - INTERMEDIATE LANDING

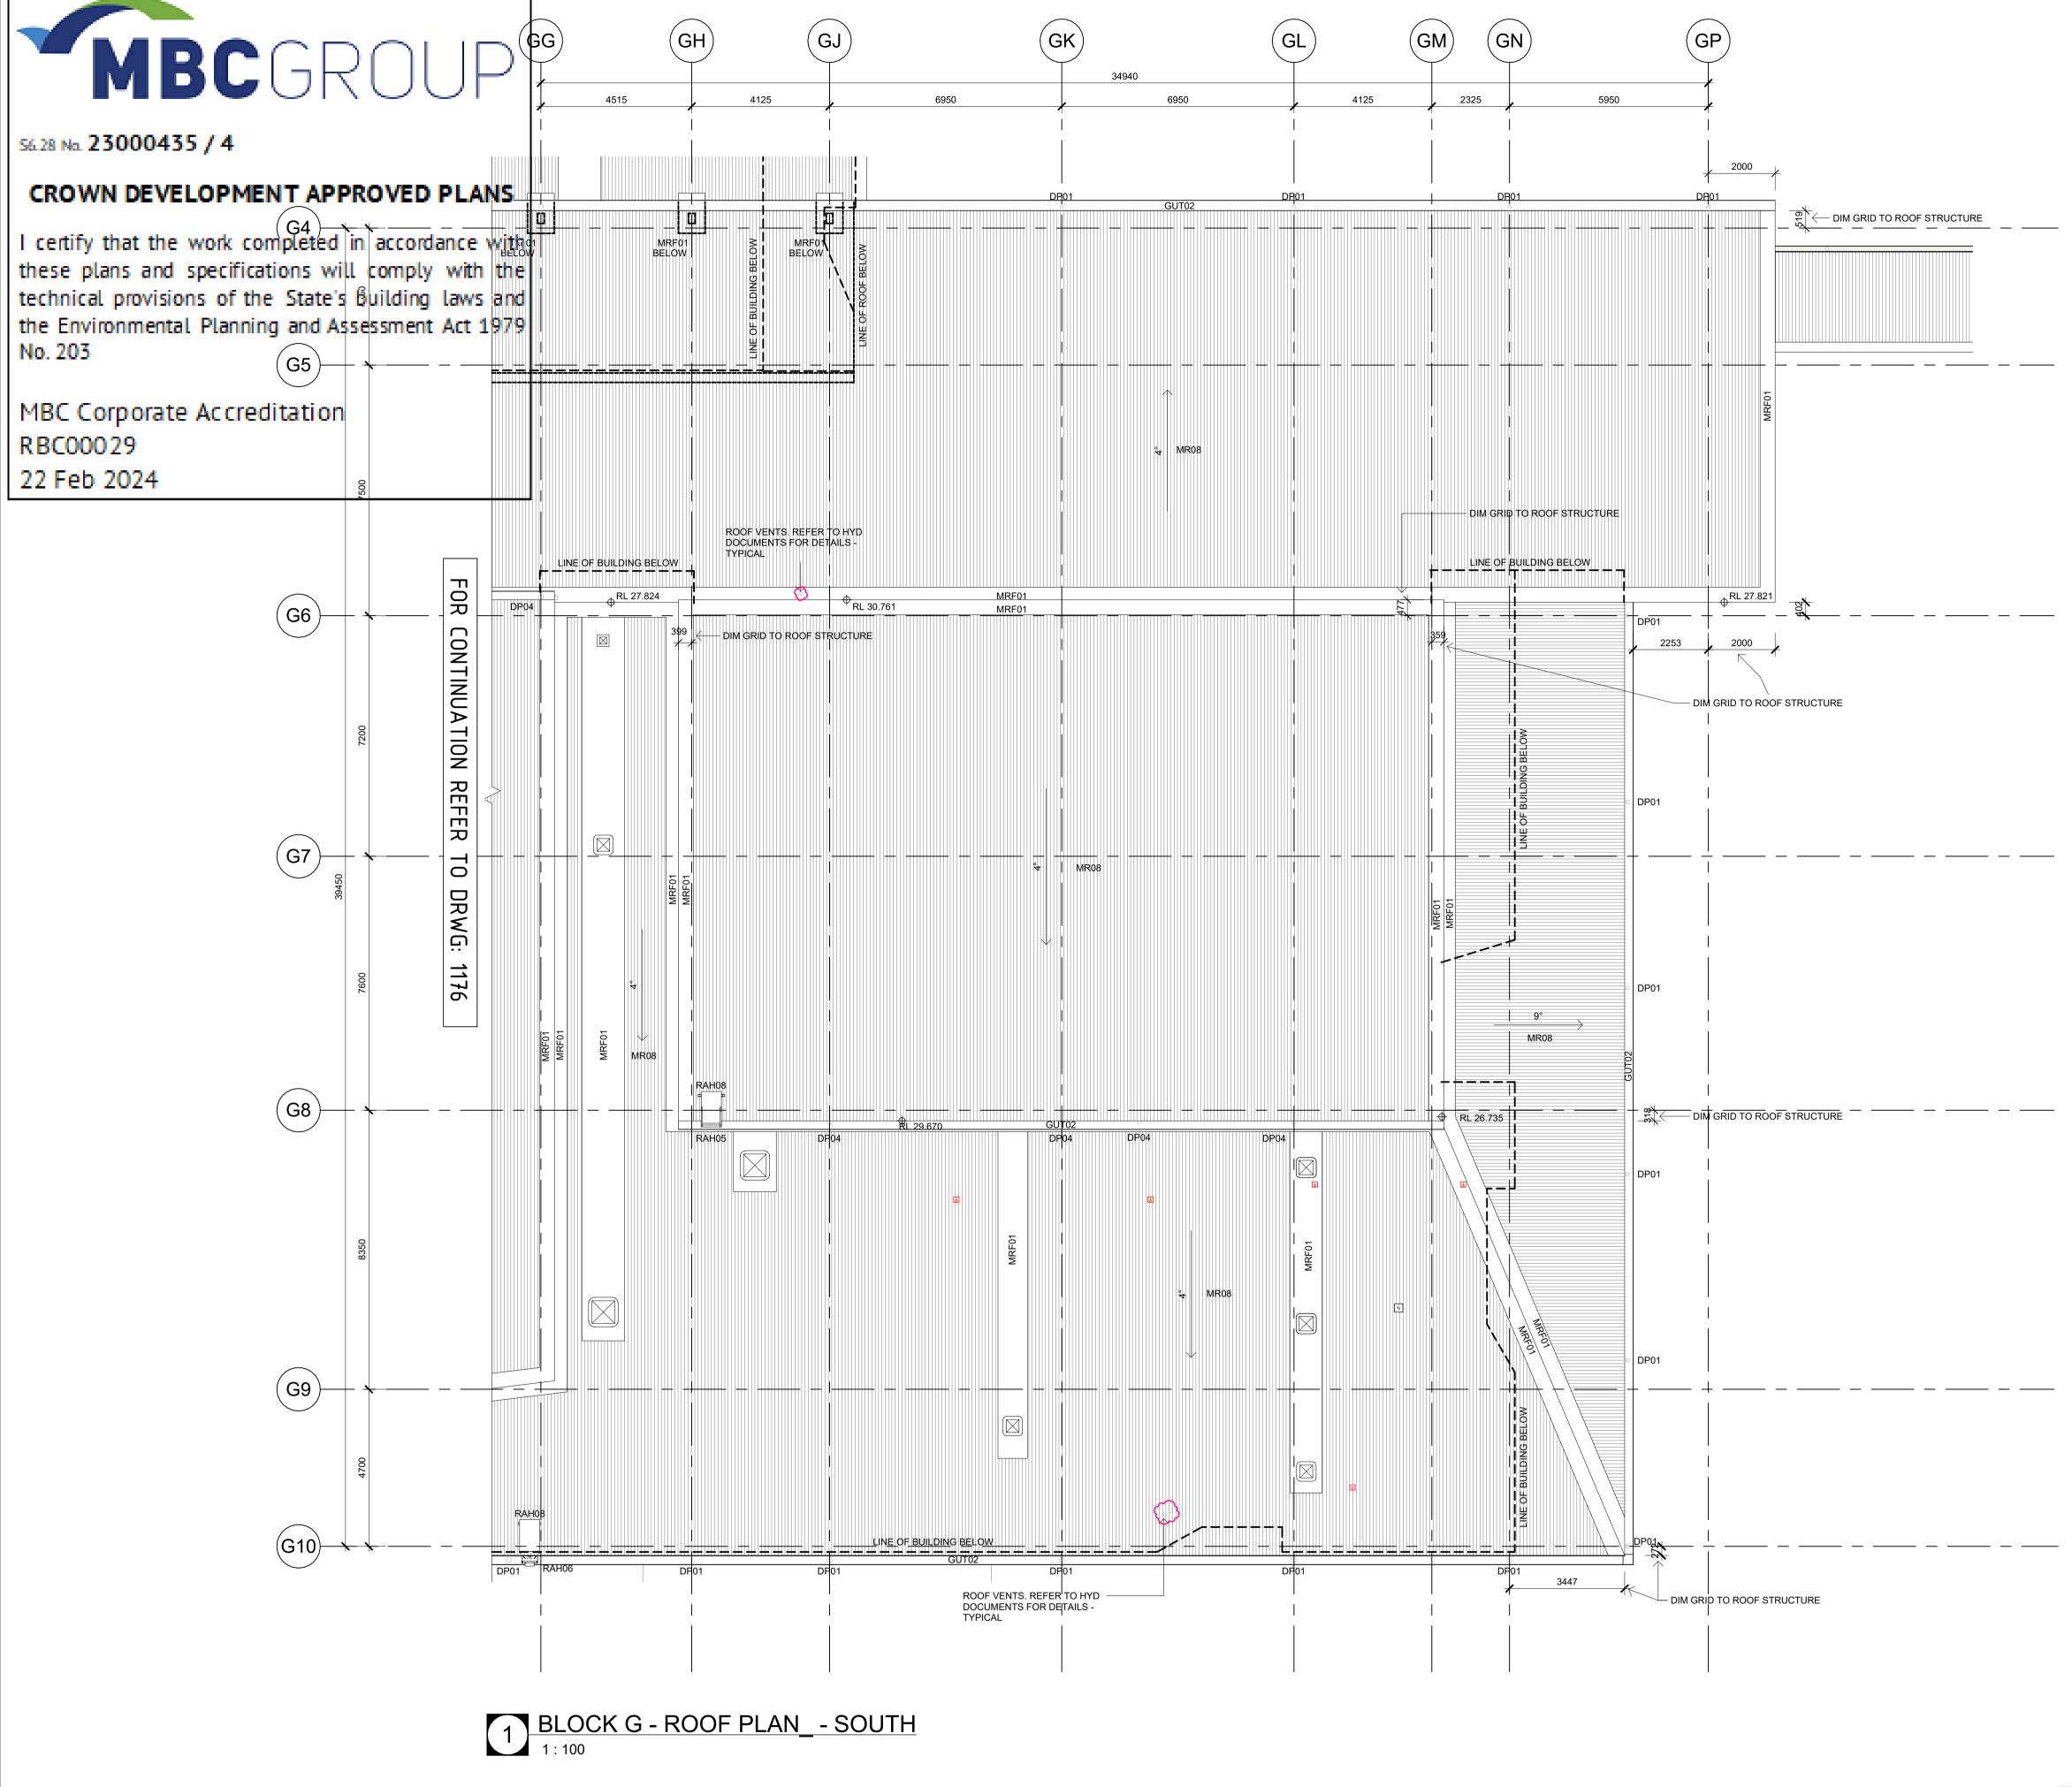





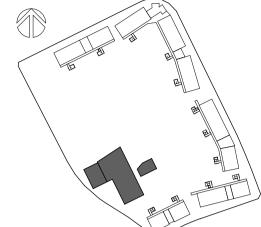

GENERAL NOTES

1. CONTRACTOR TO MAKE PROVISION & FACILITATE THE DESIGN, DOCUMENTATION & CONSTRUCTION OF ROOF ACCESS, ROOF MOUNTED WALKWAYS & FALL PREVENTION ANCHORS. THE DESIGN & DOCUMENTATION OF ROOF ACCESS & FALL PREVENTION IS TO BE CARRIED OUT IN CONSULTATION WITH THE ARCHITECT.

2. EXTENT OF ROOF ACCESS AND FALL PREVENTION ARE INDICATIVE ONLY.

3. PROVIDE ADDITIONAL SUPPORTS IN WALL FRAMING, CEILING FRAMING AND ROOF FRAMING TO ACCOMMODATE WALL, CEILING OR ROOF HUNG FITOUT, FIXTURE AND EQUIPMENT.

CODE DESCRIPTION

DP01 DOWNPIPE 150 OD WITH 2100H GAL CHS SLEEVE DP04 DOWNPIPE SPREADER 150 OD

GUT01 VALLEY GUTTER

GUT02 300 HALF ROUND GUTTER GUT03 150 HALF ROUND GUTTER

GUTG GUTTER GUARD

MR08 METAL ROOFING - KLIPLOK MRF01 METAL FLASHING - ROOF

MFP01 METAL FLASHING - PARAPET FLASHING MFP02 METAL FLASHING - PARAPET CLADDING

PV PHOTOVOLTAIC PANEL

RAH05 ROOF ACCESS - PERMANENT LADDER

RAHUS	ROOF ACCESS - PERMANENT LADDER
RAH06	ROOF ACCESS - SUPPORT BRACKET
RAH07	ROOF ACCESS - WALKWAY
RAH08	ROOF ACCESS - INTERMEDIATE LANDING

DISCLAIMER

ALL DIMENSIONS SHOWN ON DRAWINGS ARE IN MILLIMETRES UNLESS OTHERWISE NOTED AND SHOULD BE VERIFIED ON SITE BEFORE COMMENCING BUILDING WORKS. DO NOT SCALE THIS DRAWING. THESE ARCHITECTURAL DRAWINGS ARE TO BE READ IN CONJUNCTION WITH THE BUILDING SPECIFICATION, TECHNICAL SHEETS AND CONSULTANT DRAWINGS. ANY DISCREPANCIES ARE TO BE REFERRED TO THE PROJECT ARCHITECT FOR CLARIFICATION PRIOR TO WORK COMMENCING.

_	FRIOR	10	~~
	1221	IP	

•		
Date	Description	Chkd
17.08.2023	Issue for 80% Design Development	EK
14.09.2023	Issue for 100% Design Development	EK
23.11.2023	Issue for Coordination	DJ
21.12.2023	Issue for Draft CC4	TP
11.01.2024	For Coordination	DJ
18.01.2024	Issue for CC4	DJ
	Date 17.08.2023 14.09.2023 23.11.2023 21.12.2023 11.01.2024	DateDescription17.08.2023Issue for 80% Design Development14.09.2023Issue for 100% Design Development23.11.2023Issue for Coordination21.12.2023Issue for Draft CC411.01.2024For Coordination



61 2 9922 2344 nbrsarchitecture.com Any form of replication of this drawing in full or in part without the written permission of NBRS+PARTNERS Pty Ltd constitutes an infringement of the copyright. Nominated Architect: Andrew Duffin NSW 5602

© 2023 ABN 16 002 247 565 NBRS & Partners Pty Ltd VIC 51197 Project

Melonba Education Campus


Cnr Elara Boulevard and Kaluta Avenue, Melonba. Lot 30 DP 1237735 for

SINSW

Drawing Title


BLOCK G - ROOF PLAN - SOUTH

FOR CONSTRUCTION

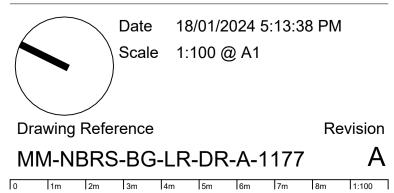


DESCRIPTION

DOWNPIPE 150 OD WITH 2100H GAL CHS SLEEVE SPREADER - 150 OD GUTTER TYPE 02 - 300 HALF ROUND METAL ROOFING - KLIPLOK METAL FLASHING - ROOF ROOF ACCESS - PERMANENT LADDER ROOF ACCESS - SUPPORT BRACKET RAH08 ROOF ACCESS - INTERMEDIATE LANDING

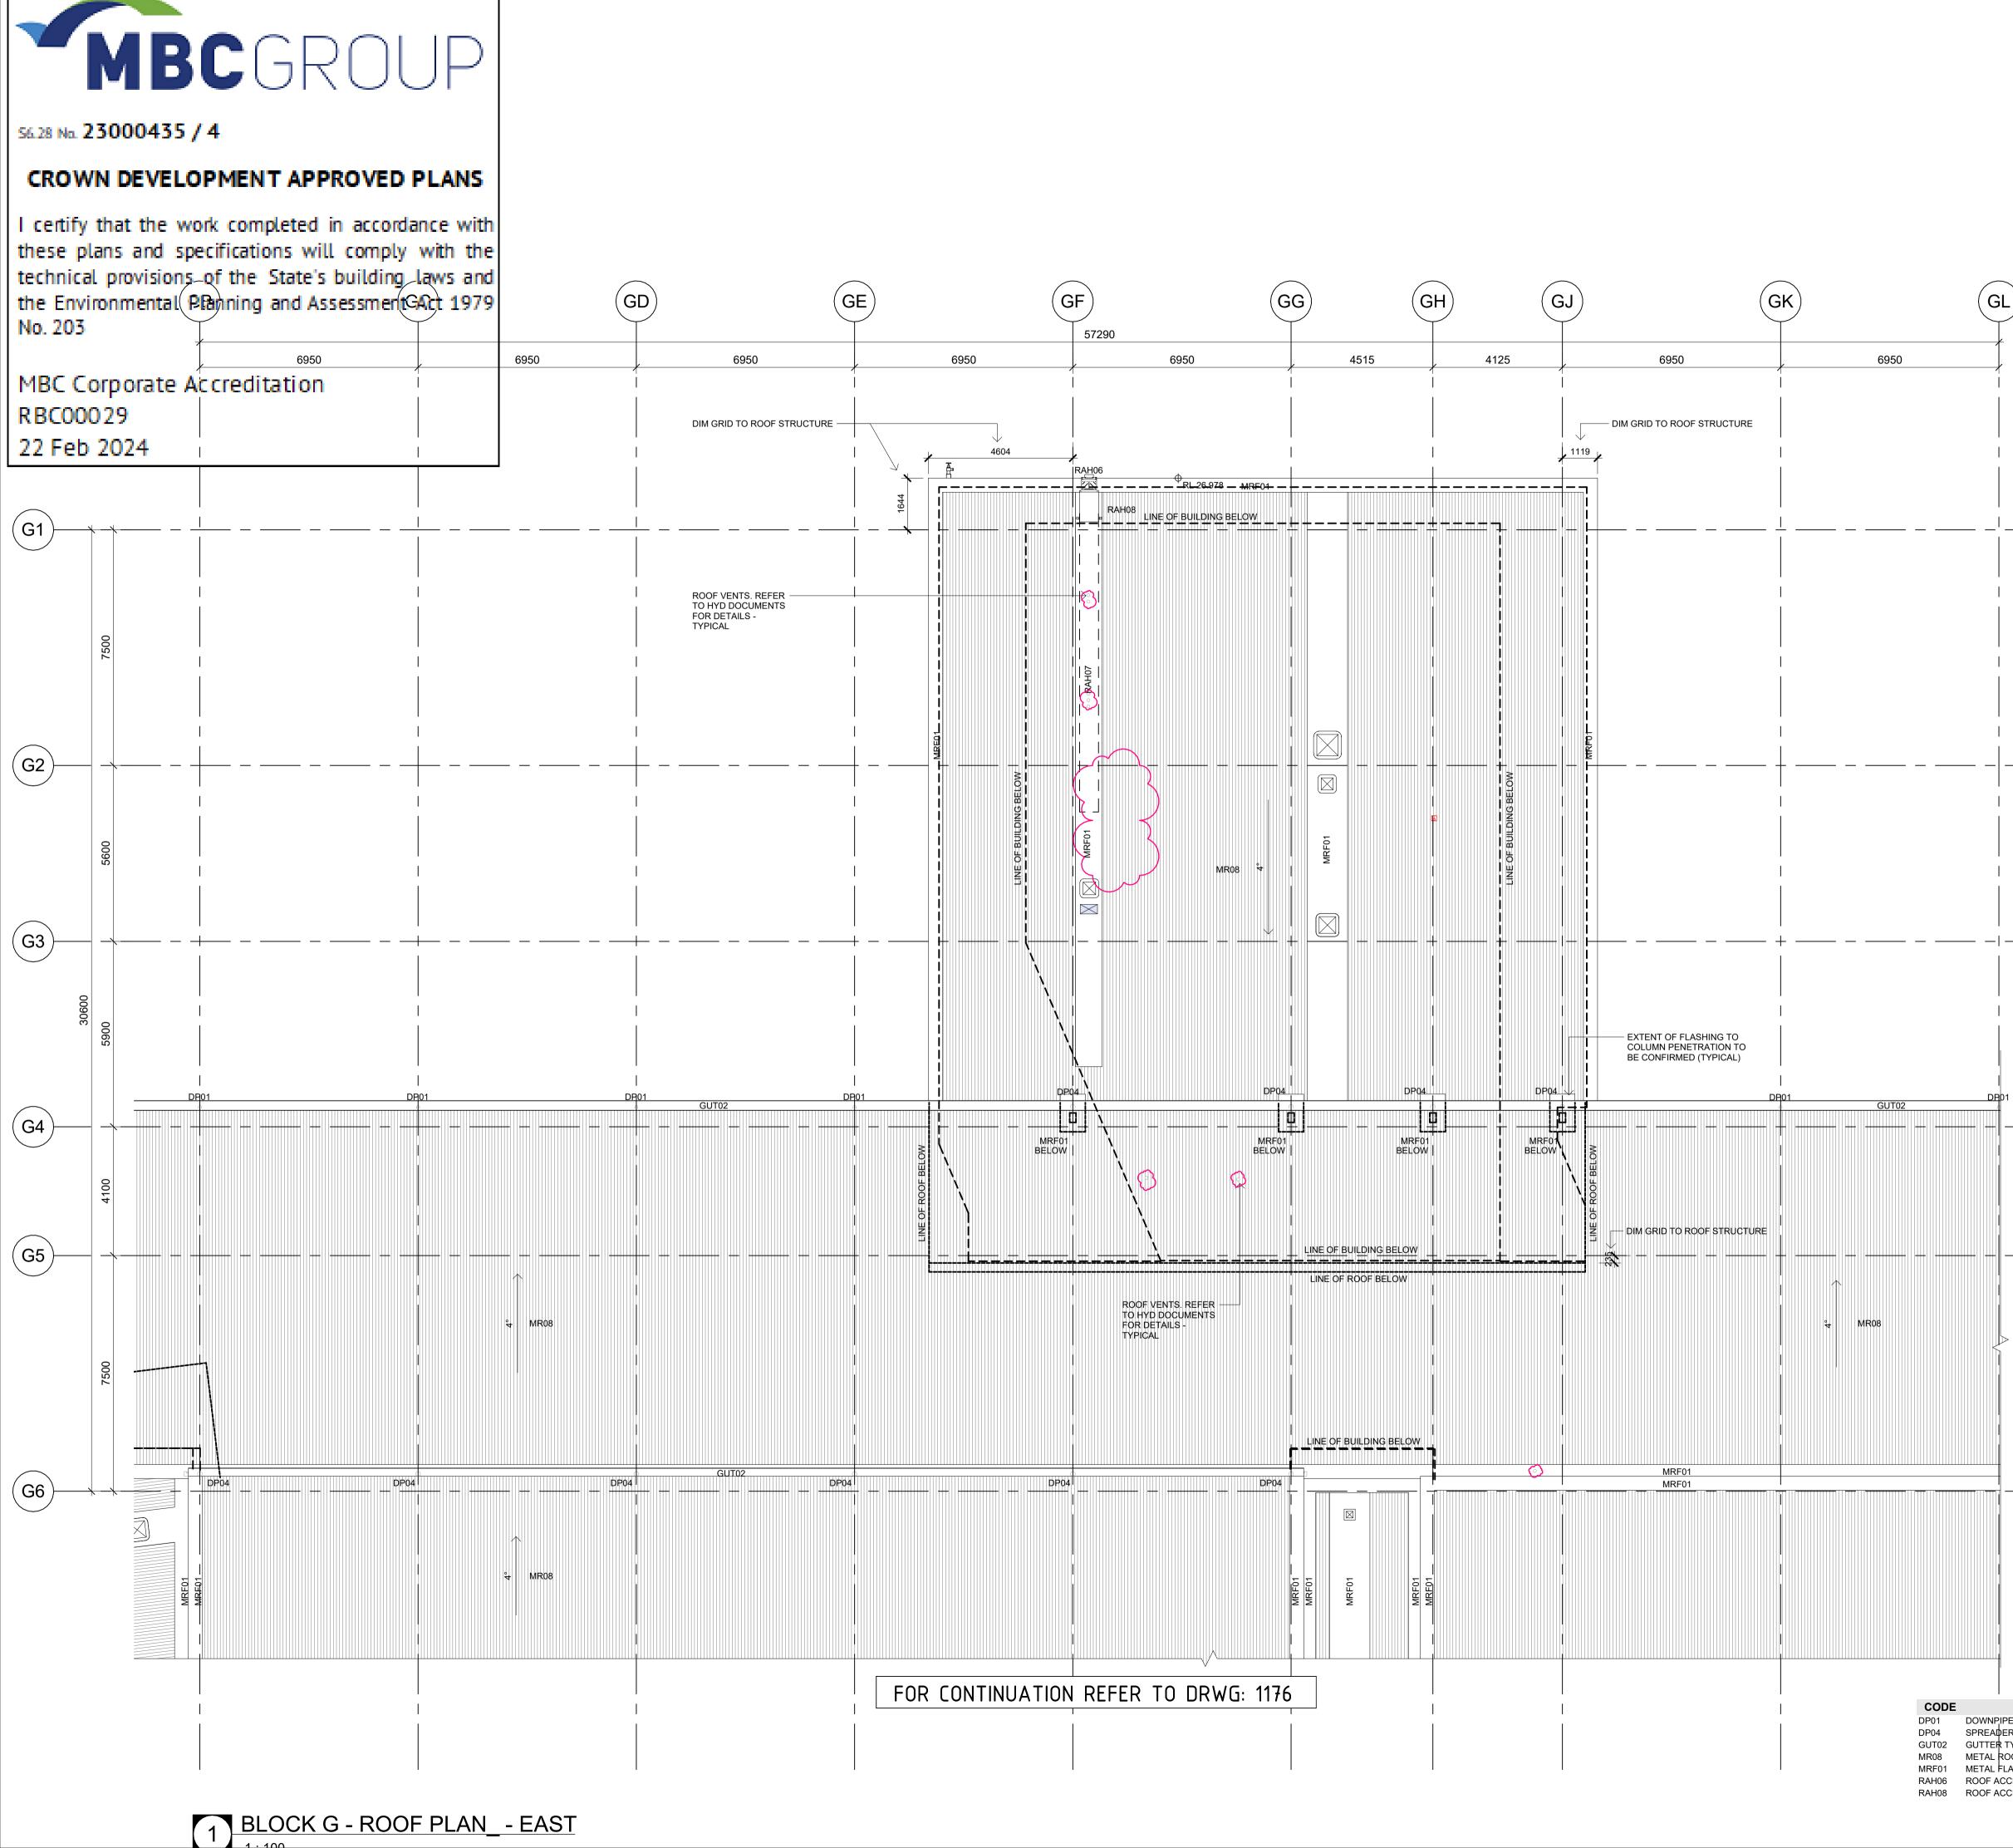



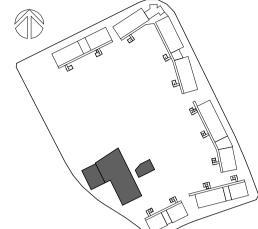

GENERAL NOTES

1. CONTRACTOR TO MAKE PROVISION & FACILITATE THE DESIGN, DOCUMENTATION & CONSTRUCTION OF ROOF ACCESS, ROOF MOUNTED WALKWAYS & FALL PREVENTION ANCHORS. THE DESIGN & DOCUMENTATION OF ROOF ACCESS & FALL PREVENTION IS TO BE CARRIED OUT IN CONSULTATION WITH THE ARCHITECT.

2. EXTENT OF ROOF ACCESS AND FALL PREVENTION ARE INDICATIVE ONLY.

3. PROVIDE ADDITIONAL SUPPORTS IN WALL FRAMING, CEILING FRAMING AND ROOF FRAMING TO ACCOMMODATE WALL, CEILING OR ROOF HUNG FITOUT, FIXTURE AND EQUIPMENT.

CODE DESCRIPTION

DP01 DOWNPIPE 150 OD WITH 2100H GAL CHS SLEEVE DP04 DOWNPIPE SPREADER 150 OD

GUT01 VALLEY GUTTER

GUT02 300 HALF ROUND GUTTER GUT03 150 HALF ROUND GUTTER

GUTG GUTTER GUARD

MR08 METAL ROOFING - KLIPLOK MRF01 METAL FLASHING - ROOF

MFP01 METAL FLASHING - PARAPET FLASHING MFP02 METAL FLASHING - PARAPET CLADDING

PV PHOTOVOLTAIC PANEL

RAH05	ROOF	ACCESS	- PERMAN	NENT L	ADDER

RAH06	ROOF ACCESS - SUPPORT BRACKET
RAH07	ROOF ACCESS - WALKWAY
RAH08	ROOF ACCESS - INTERMEDIATE LANDING

DISCLAIMER

ALL DIMENSIONS SHOWN ON DRAWINGS ARE IN MILLIMETRES UNLESS OTHERWISE NOTED AND SHOULD BE VERIFIED ON SITE BEFORE COMMENCING BUILDING WORKS. DO NOT SCALE THIS DRAWING. THESE ARCHITECTURAL DRAWINGS ARE TO BE READ IN CONJUNCTION WITH THE BUILDING SPECIFICATION. TECHNICAL SHEETS AND CONSULTANT DRAWINGS. ANY DISCREPANCIES ARE TO BE REFERRED TO THE PROJECT ARCHITECT FOR CLARIFICATION DRIVED WORK COMMENCED

PRIOR T	PRIOR TO WORK COMMENCING.							
Issue								
No.	Date	Description	Chkd					
1	17.08.2023	Issue for 80% Design Development	EK					
2	14.09.2023	Issue for 100% Design Development	EK					
3	23.11.2023	Issue for Coordination	DJ					
4	21.12.2023	Issue for Draft CC4	TP					
5	11.01.2024	For Coordination	DJ					
А	18.01.2024	Issue for CC4	DJ					



nbrsarchitecture.com 61 2 9922 2344 Any form of replication of this drawing in full or in part without the written permission of NBRS+PARTNERS Pty Ltd constitutes an infringement of the copyright. Nominated Architect: Andrew Duffin NSW 5602

© 2023 ABN 16 002 247 565 NBRS & Partners Pty Ltd VIC 51197 Project

Melonba Education Campus


Cnr Elara Boulevard and Kaluta Avenue, Melonba. Lot 30 DP 1237735 for

SINSW

Drawing Title

BLOCK G - ROOF PLAN - EAST



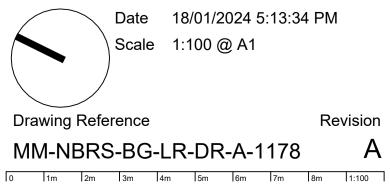

TION INUA \vdash NO Ū \propto FOI DESCRIPTION

T 117

Ü

 \geq

DR

Ο

 \simeq

ட RE

DOWNPIPE 150 OD WITH 2100H GAL CHS SLEEVE SPREADER - 150 OD GUTTER TYPE 02 - 300 HALF ROUND METAL ROOFING - KLIPLOK

METAL FLASHING - ROOF ROOF ACCESS - SUPPORT BRACKET

ROOF ACCESS - INTERMEDIATE LANDING


MBCGROUP

56.28 No. 23000435 / 4

CROWN DEVELOPMENT APPROVED PLANS

I certify that the work completed in accordance with these plans and specifications will comply with the technical provisions of the State's building laws and the Environmental Planning and Assessment Act 1979 No. 203

MBC Corporate Accreditation RBC00029 (G10) 22 Feb 2024

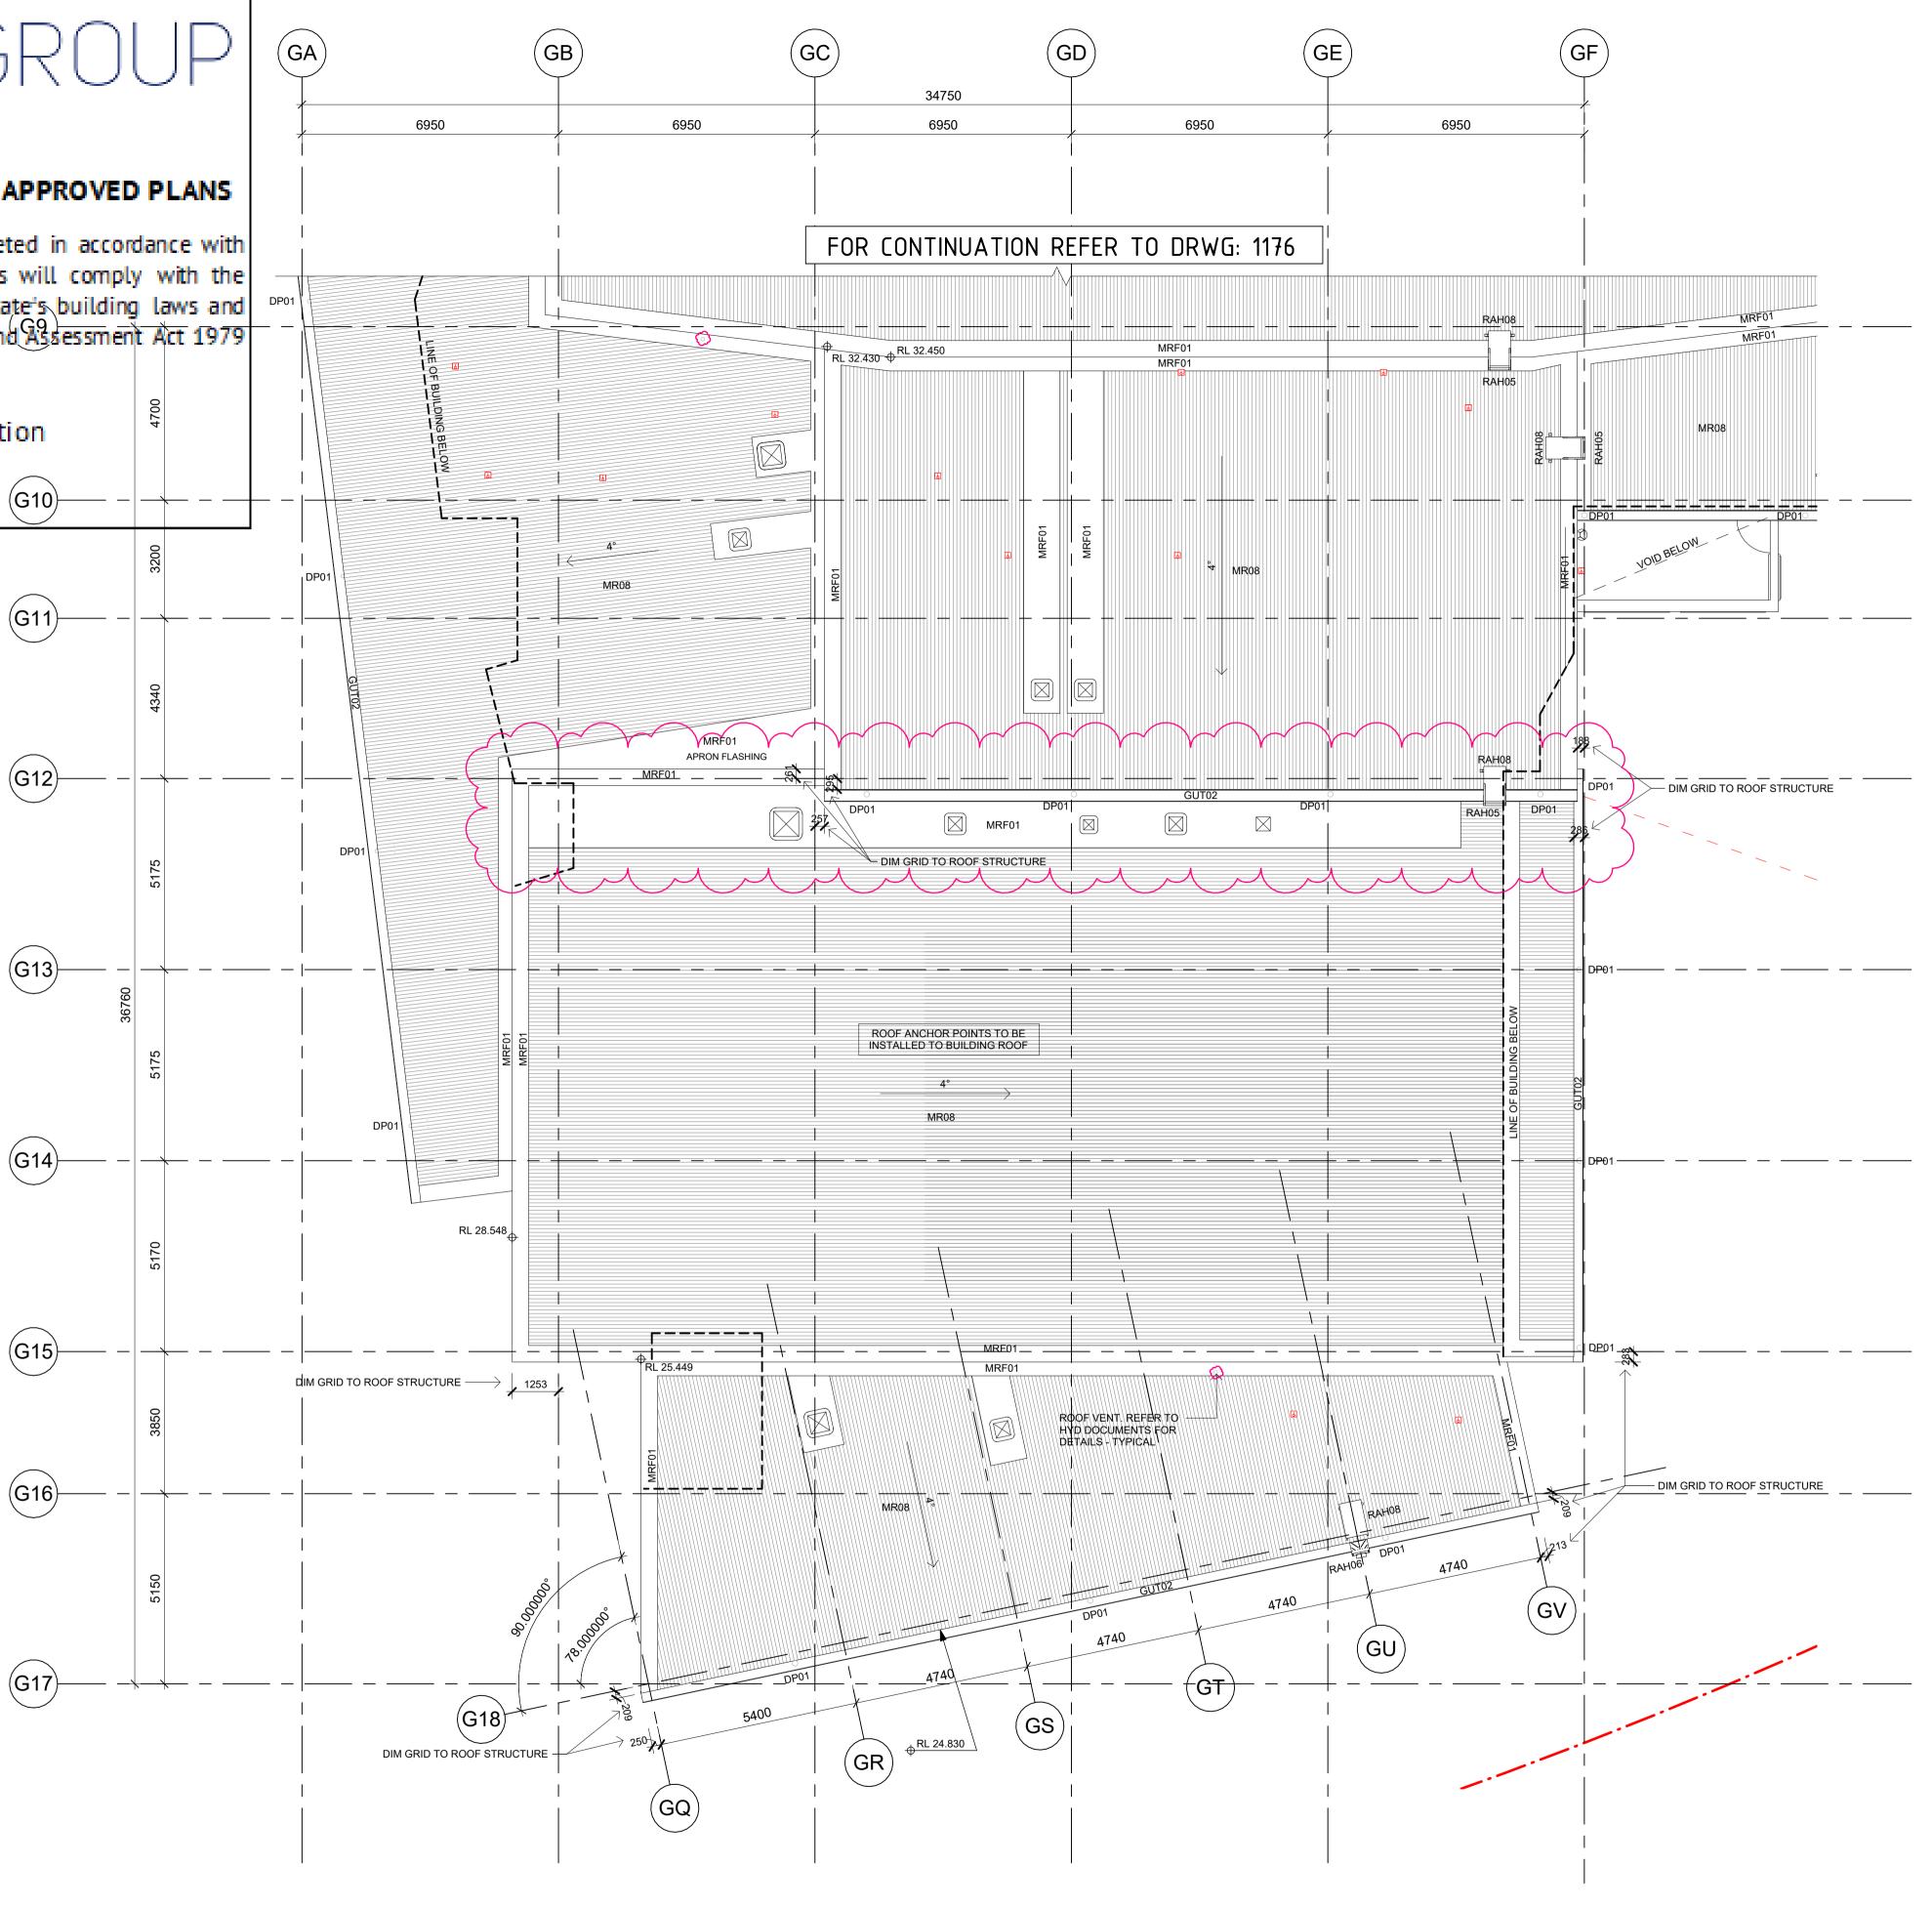




CODE DP01 GUT02 MR08 MRF01



LOCATION PLAN

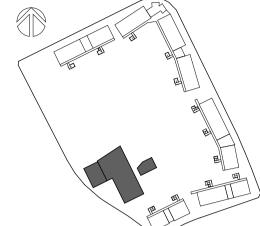

GENERAL NOTES

1. CONTRACTOR TO MAKE PROVISION & FACILITATE THE DESIGN, DOCUMENTATION & CONSTRUCTION OF ROOF ACCESS, ROOF MOUNTED WALKWAYS & FALL PREVENTION ANCHORS. THE DESIGN & DOCUMENTATION OF ROOF ACCESS & FALL PREVENTION IS TO BE CARRIED OUT IN CONSULTATION WITH THE ARCHITECT.

2. EXTENT OF ROOF ACCESS AND FALL PREVENTION ARE INDICATIVE ONLY.

3. PROVIDE ADDITIONAL SUPPORTS IN WALL FRAMING, CEILING FRAMING AND ROOF FRAMING TO ACCOMMODATE WALL, CEILING OR ROOF HUNG FITOUT, FIXTURE AND EQUIPMENT.

CODE DESCRIPTION

DP01 DOWNPIPE 150 OD WITH 2100H GAL CHS SLEEVE DP04 DOWNPIPE SPREADER 150 OD

GUT01 VALLEY GUTTER GUT02 300 HALF ROUND GUTTER GUT03 150 HALF ROUND GUTTER

GUTG GUTTER GUARD

MR08 METAL ROOFING - KLIPLOK MRF01 METAL FLASHING - ROOF

MFP01 METAL FLASHING - PARAPET FLASHING MFP02 METAL FLASHING - PARAPET CLADDING

PV PHOTOVOLTAIC PANEL

RAH05 ROOF ACCESS - PERMANENT LADDER

INAL 103	ROOF ACCESS - FERMANENT LADDER
RAH06	ROOF ACCESS - SUPPORT BRACKET
RAH07	ROOF ACCESS - WALKWAY
RAH08	ROOF ACCESS - INTERMEDIATE LANDING

DISCLAIMER

ALL DIMENSIONS SHOWN ON DRAWINGS ARE IN MILLIMETRES UNLESS OTHERWISE NOTED AND SHOULD BE VERIFIED ON SITE BEFORE COMMENCING BUILDING WORKS. DO NOT SCALE THIS DRAWING. THESE ARCHITECTURAL DRAWINGS ARE TO BE READ IN CONJUNCTION WITH THE BUILDING SPECIFICATION, TECHNICAL SHEETS AND CONSULTANT DRAWINGS. ANY DISCREPANCIES ARE TO BE REFERRED TO THE PROJECT ARCHITECT FOR CLARIFICATION PRIOR TO WORK COMMENCING.

			~			~		~ .	
	•	c	c	•	ı	۵			
	•	J	Ĵ	ν	J	C			

sue	;		
lo.	Date	Description	Chkd
	17.08.2023	Issue for 80% Design Development	EK
2	14.09.2023	Issue for 100% Design Development	EK
3	23.11.2023	Issue for Coordination	DJ
Ļ	15.12.2023	Issue for Coordination	TP
5	21.12.2023	Issue for Draft CC4	TP
6	11.01.2024	For Coordination	DJ
4	18.01.2024	Issue for CC4	DJ



61 2 9922 2344

nbrsarchitecture.com Any form of replication of this drawing in full or in part without the written permission of NBRS+PARTNERS Pty Ltd constitutes an infringement of the copyright. Nominated Architect: Andrew Duffin NSW 5602 © 2023

ABN 16 002 247 565 NBRS & Partners Pty Ltd VIC 51197 Project

Melonba Education Campus


Cnr Elara Boulevard and Kaluta Avenue, Melonba. Lot 30 DP 1237735 for

SINSW

Drawing Title

BLOCK G - ROOF PLAN - WEST

FOR CONSTRUCTION

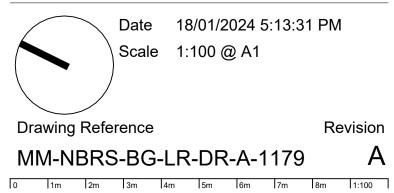

DESCRIPTION

DOWNPIPE 150 OD WITH 2100H GAL CHS SLEEVE GUTTER TYPE 02 - 300 HALF ROUND METAL ROOFING - KLIPLOK METAL FLASHING - ROOF RAH05 ROOF ACCESS - PERMANENT LADDER RAH06 ROOF ACCESS - SUPPORT BRACKET RAH08 ROOF ACCESS - INTERMEDIATE LANDING