

12 March 2021

Mr Lincoln Lawler
Principal Development Planner - Coordinator
Planning and Strategy
Department of Education

-via emaillincoln.lawler@det.nsw.edu.au

Dear Mr Lawler

Notice of Determination of Section 4.55(1A) Modification Application Lindfield Learning Village (SSD-8114 Mod-2)

Our ref.: SSD-8114 Mod 2

I am writing to inform you that the above modification application was approved, subject to amended conditions, on 12 March 2021, by the Director, Social and Infrastructure Assessments as delegate of the Minister for Planning and Public Spaces under section 4.55(1A) of the *Environmental Planning and Assessment Act 1979* (the Act).

All documents associated with the application are available on the Department's website at: https://www.planningportal.nsw.gov.au/major-projects/project/41046.

The conditions in the notice of modification are required to prevent, minimise, and/or offset adverse environmental impacts.

Reviews/Appeals

Certain appeal and review rights are available to applicants and objectors following determination of a modification application. In this case, you have a right to appeal the determination on its merits to the Land and Environment Court under section 8.9 of the Act.

For further enquiries, please contact Navdeep Shergill on (02) 8289 6777 or via email at Navdeep.singhshergill@planning.nsw.gov.au.

Yours sincerely

Jason Maslen **Team Leader**

School Infrastructure Assessments

Enclosed: Instrument of Modification

Modification of Development Consent

Section 4.55(1A) of the Environmental Planning and Assessment Act 1979

As delegate of the Minister for Planning and Public Spaces, I approve the modification of the development consent referred to in Schedule 1, subject to the conditions in Schedule 2.

Karen Harragon

Director

Social and Infrastructure Assessments

Sydney 12 March 2021

SCHEDULE 1

Development consent: Phase 2 and 3 consent (SSD 8114) granted by the Minister for

Planning and Public Spaces on 12 November 2020

For the following: Staged construction and operation Lindfield Learning Village

including:

adaptive reuse of existing buildings to cater for up to 2000

students;

 alterations and additions to the existing buildings, including construction of a Covered Outdoor Learning Area (COLA) and

external egress staircase;

access arrangements including provisions of drop-off/pick-up

and turnaround facilities for vehicles and buses;

• construction of a fire trail for bush fire management purposes;

 tree removal and provision of open play space areas and other associated landscaping works; and

associated infrastructure works.

Applicant: Department of Education

Consent Authority: Minister for Planning and Public Spaces

The Land: Lot 2 and 4 DP 1151639, 100 Eton Road, Lindfield

Former UTS Ku-ring-gai Campus

Modification: SSD 8114 MOD 2: Modification of condition A2 to include updated

and amended landscape drawings to reflect design refinements

SCHEDULE 2

The Phase 2 and 3 consent (SSD 8114) granted on 12 November 2020 is modified as follows:

(a) Schedule 2 Part A – Administrative Conditions, condition A2 is modified by the insertion of **bold and underlined** words and deletion of the **bold and struck out words** as follows:


Architectural Plans and Landscape Plans prepared by DesignInc Lacoste + Stevenson bmc2				
Dwg No.	Rev	Name of Plan	Date	
AR-2-2104J	С	STAGE 2 - EXISTING & DEMOLITION PLAN - LEVEL 4 - ZONE J - EARLY WORKS	07/08/2020	
AR-2-2204J	В	STAGE 2 - EXISTING & DEMOLITION RCP - LEVEL 4 - ZONE J - EARLY WORKS	07/08/2020	
AR-2-2304J	С	STAGE 2 - GA PLAN - LEVEL 4 - ZONE J	07/08/2020	
DA-2-100	С	SITE PLAN	17/04/2020	
DA-2-101	D	INDICATIVE CONSTRUCTION MANAGEMENT PLAN	17/04/2020	
DA-2-102	D	PHASE 1-3 SITE PLAN	09/10/2020	
DA-2-200	В	PHASE 2 & 3 - PROPOSED FLOOR PLAN LEVEL 0	28/08/2019	
DA-2-201	D	PHASE 2 & 3 - PROPOSED FLOOR PLAN LEVEL 1	17/04/2020	
DA-2-202	D	PHASE 2 & 3 - PROPOSED FLOOR PLAN LEVEL 2	17/04/2020	
DA-2-203	D	PHASE 2 & 3 - PROPOSED FLOOR PLAN LEVEL 3	17/04/2020	
DA-2-204	Е	PHASE 2 & 3 - PROPOSED FLOOR PLAN LEVEL 4	09/10/2020	
DA-2-205	D	PHASE 2 & 3 - PROPOSED FLOOR PLAN LEVEL 5	17/04/2020	
DA-2-206	D	PHASE 2 & 3 - PROPOSED FLOOR PLAN LEVEL 6	17/04/2020	
DA-2-207	С	PHASE 2 & 3 - PROPOSED ROOF PLAN	17/04/2020	
DA-2-300	С	NORTH & SOUTH BUILDING ELEVATION	17/04/2020	
DA-2-301	С	EAST & WEST BUILDING ELEVATION	17/04/2020	
DA-2-400	В	BUILDING SECTIONS - SHEET 1	17/04/2020	
DA-2-401	В	BUILDING SECTIONS - SHEET 2	17/04/2020	
LA-2-0005	G	LANDSCAPE ANALYSIS	25/08/2020	
LA-2-0006	H	LANDSCAPE MASTER PLAN	25/08/2020	
LA-2-0007	B	LANDSCAPE MASTER PLAN	25/08/2020	
LA-2-0008	G	CIRCULATION DIAGRAM	25/08/2020	
LA-2-0009	H	WSUD DIAGRAM	25/08/2020	
LA-2-0010	G	LANDSCAPE BLOW UP PLAN 1	25/08/2020	
LA-2-0011	G	LANDSCAPE BLOW UP PLAN 2	25/08/2020	

LA-2-0012	G	LANDSCAPE BLOW UP PLAN 3	17/04/2020
LA-2-0013	G	LANDSCAPE BLOW UP PLAN 4	17/04/2020
LA-2-0014	G	LANDSCAPE BLOW UP PLAN 5	17/04/2020
LA-2-0015	G	LANDSCAPE BLOW UP PLAN 6	25/08/2020
LA-2-0016	G	LANDSCAPE BLOW UP PLAN 7 - PARKOUR TRAIL	25/08/2020
LA-2-0017	G	LANDSCAPE BLOW UP PLAN 8	25/08/2020
LA-2-0018	E	SHELTER DESIGN	22/07/2019
LA-2-1000	G	SECURITY FENCE MASTER PLAN	28/04/2020
LA-2-1001	G	SECURITY FENCE PLAN 1	17/04/2020
LA-2-1002	F	SECURITY FENCE PLAN 2	04/12/2019
LA-2-1003	G	SECURITY FENCE PLAN 3	28/07/2020
LA-2-1004	G	SECURITY FENCE PLAN 4	17/04/2020
LA-2-1005	G	SECURITY FENCE PLAN 4	28/04/2020
LA-2-2000	E	LANDSCAPE DETAILS	21/04/2020
LA-2-3000	E	PLANTING PALLETTE	21/04/2020
LA-2-4001	A	TREE LOCATION PLAN 1	25/08/2020
LA-2-4002	A	TREE LOCATION PLAN 2	25/08/2020
LA-2-0005	<u>H</u>	LANDSCAPE ANALYSIS	04/12/2020
LA-2-0006	<u>I</u>	LANDSCAPE MASTER PLAN SOUTH	04/12/2020
LA-2-0007	<u>D</u>	LANDSCAPE MASTER PLAN EAST	09/12/2020
LA-2-0008	<u>H</u>	CIRCULUATION DIAGRAM	04/12/2020
LA-2-0009	<u>I</u>	WSUD DIAGRAM	04/12/2020
LA-2-0010	<u>H</u>	LANDSCAPE BLOW UP PLAN 1	04/12/2020
LA-2-0011	<u>H</u>	LANDSCAPE BLOW UP PLAN 2	04/12/2020
LA-2-0012	<u>H</u>	LANDSCAPE BLOW UP PLAN 3	04/12/2020
LA-2-0013	<u>H</u>	LANDSCAPE BLOW UP PLAN 4	04/12/2020
LA-2-0016	<u>H</u>	LANDSCAPE BLOW UP PLAN 7 - PARKOUR TRAIL	04/12/2020
LA-2-0017	<u>H</u>	LANDSCAPE BLOW UP PLAN 8	04/12/2020
LA-2-0018	<u>F</u>	SHELTER DIAGRAM	04/12/2020
LA-2-1000	<u>H</u>	SECURITY FENCE MASTER PLAN	04/12/2020
LA-2-1001	<u>H</u>	SECURITY FENCE PLAN 1	04/12/2020
LA-2-1002	<u>G</u>	SECURITY FENCE PLAN 2	04/12/2020
LA-2-1003	<u>H</u>	SECURITY FENCE PLAN 3	04/12/2020
LA-2-1004	<u>H</u>	SECURITY FENCE PLAN 4	04/12/2020
LA-2-1005	<u>H</u>	SECURITY FENCE PLAN 5	04/12/2020
LA-2-2000	<u>F</u>	LANDSCAPE DETAILS	04/12/2020
LA-2-3000	<u>F</u>	PLANTING PALLETTE	04/12/2020
LA-2-4001	<u>B</u>	TREE LOCATION PLAN 1	04/12/2020
LA-2-4002	<u>C</u>	TREE LOCATION PLAN 2	09/12/2020

End of modification (SSD 8114 MOD 2)

NSW Government Department of Planning, Industry and Environment



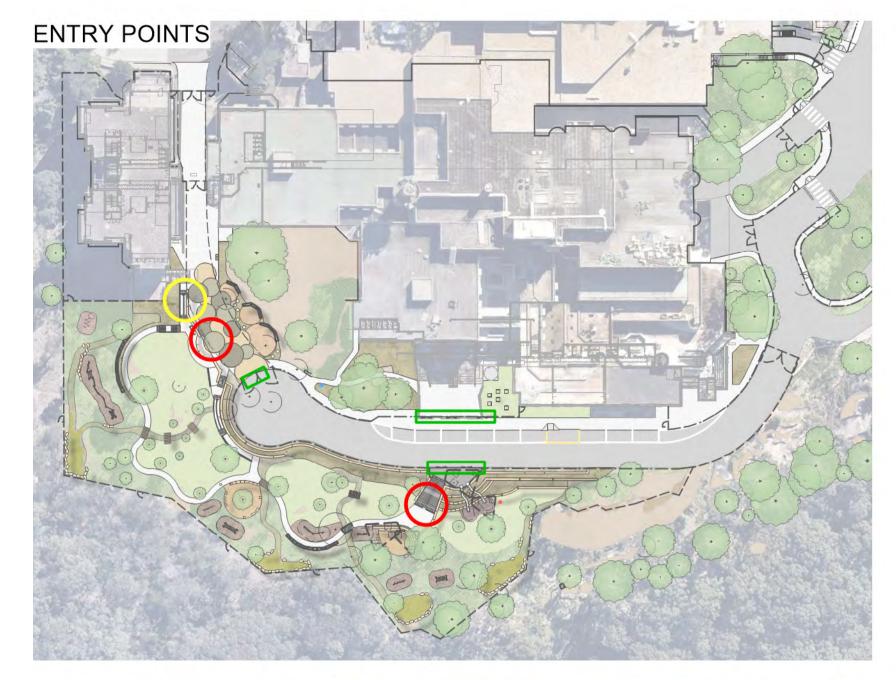

ACCESSIBLE ENTRANCE LANDSCAPE ENTRANCE GATES TO LOOP ROAD






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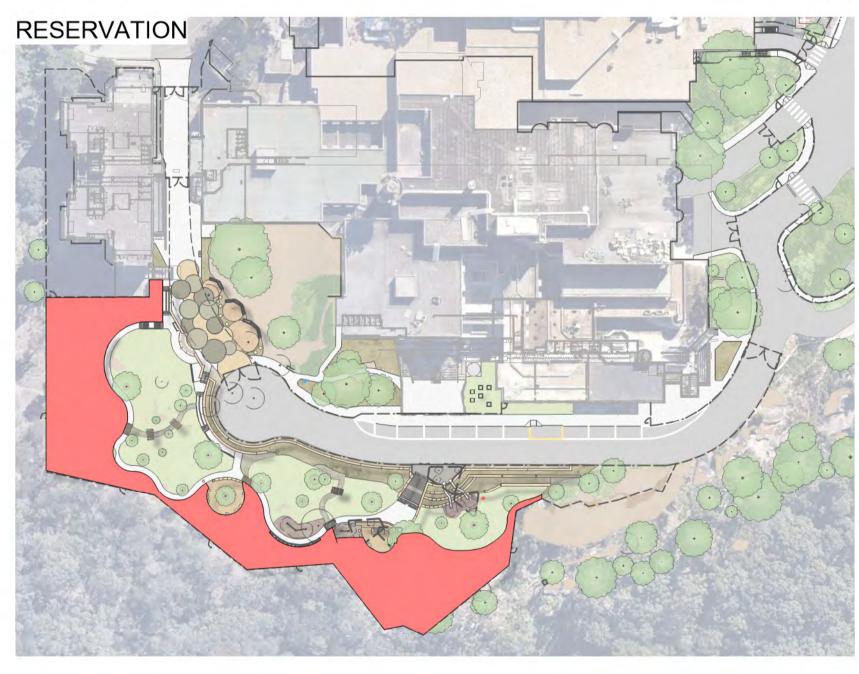
Approved Section: 4.55(1A) Application no: SSD 8114-MOD-2

Granted on: 12 March 2021

Sheet no: 1 of 22 Signed:

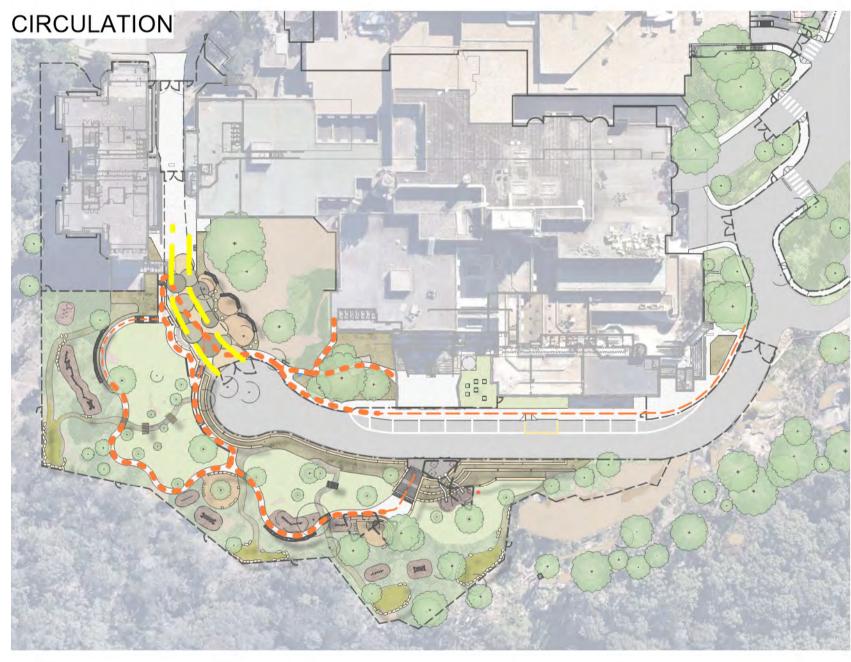

ACCESSIBLE FOOTPATH — PRIMARY CIRCULATION FIRE TRAIL



MANAGED LAND TO INNER PROTECTION ZONE STANDARDS



PASSIVE ACTIVE



14/06/2019 PRELIMINARY 08/07/2019 FOR HERITAGE REVIEW 12/07/2019 PRELIMINARY SS DA 22/07/2019 SS DA 29/08/2019 SS DA 21/04/2020 SS DA 25/08/2020 SS DA 04/12/2020 SS DA

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Landscape Architect

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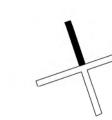
Project Lindfield Learning Centre

ETON ROAD, LINDFIELD NSW

SCHOOL INFRASTRUCTURE NSW

Drawing Title LANDSCAPE ANALYSIS

Date 04/12/2020



Project No. Sheet No.

20203 LA-2-0005 H



NBRSARCHITECTURE. LANDSCAPE

EXISTING TREE TO RETAIN AND PROTECT



PORTLAND GREY CONCRETE WITH COVE FINISH



RAISED VEGETABLE GARDEN



No.	Date	Description	Chkd
В	08/07/2019	FOR HERITAGE REVIEW	JH
C	12/07/2019	PRELIMINARY SS DA	JH
D	22/07/2019	SS DA	JH
E	29/08/2019	SS DA	JH
F	02/09/2019	REMOVED TREE CORRECTION FOR S	SDAJH
G	21/04/2020	SS DA	MD
H	25/08/2020	SS DA	DH
1	04/12/2020	SS DA	BR

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NBRSARCHITECTURE LANDSCAP

LEGEND

PROPOSED TREE

EXISTING TREE TO RETAIN AND PROTECT

EXISTING TREE TO REMOVED

PORTLAND GREY CONCRETE WITH COVE FINISH

OXIDISED CONCRETE

DECO GRANITE

PLAYGROUND MULCH

NATURAL TURF

MASS PLANTING

VEGETATED SWALE

BIO-RETENTION BASIN

MANAGED LAND

SANDSTONE LOG RETAINING WALL
SALVAGED SANDSTONE BOULDERS

BENCH SEATING

TIMBER BRIDGE

SHADE STRUCTURE

RAISED VEGETABLE GARDEN

SANDSTONE STEPPING STONES

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 MD

 B
 25/08/2020
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 04/12/2020
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Client SCHOOL INFRASTRUCTURE NSW

Drawing Title

Date 09/12/2020

LANDSCAPE MASTER PLAN EAST


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Project No. Sheet No. Revision N

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В	08/07/2019	FOR HERITAGE REVIEW	JH
C	12/07/2019	PRELIMINARY SS DA	JH
D	22/07/2019	SS DA	JH
E	29/08/2019	SS DA	JH
F	02/09/2019	REMOVED TREE CORRECTION FO	R SSDAJH
G	25/08/2020	SS DA	DH
Н	04/12/2020	SS DA	BR

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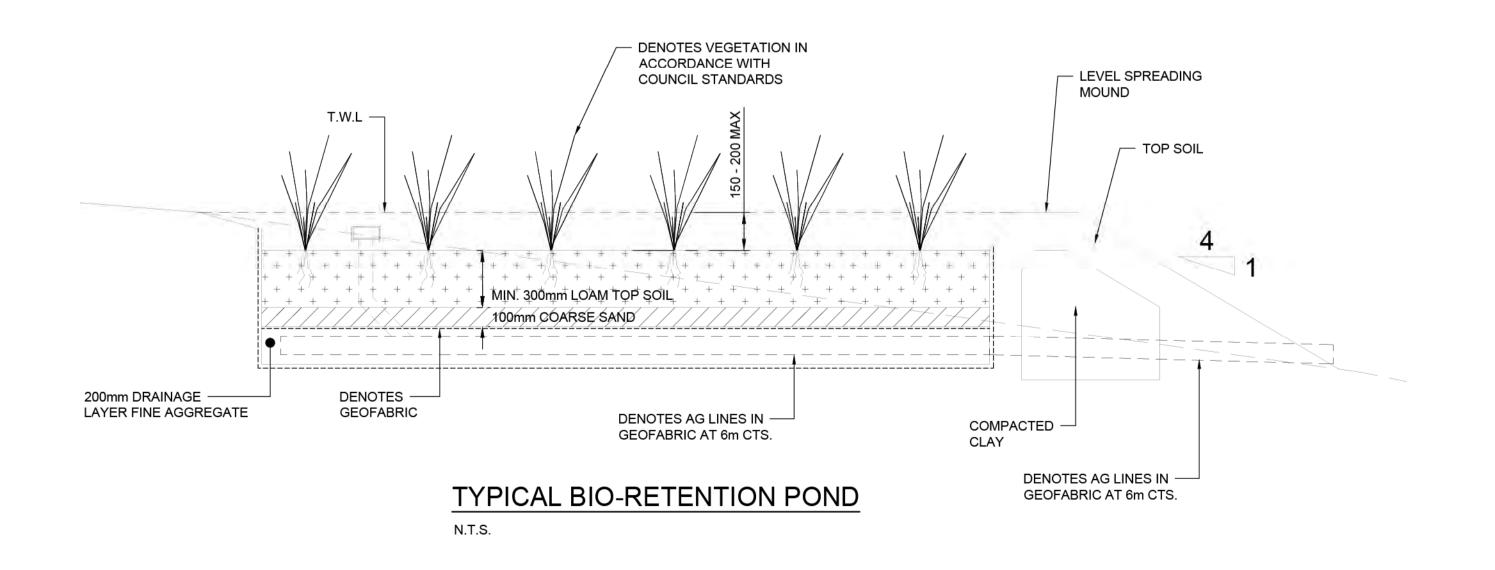
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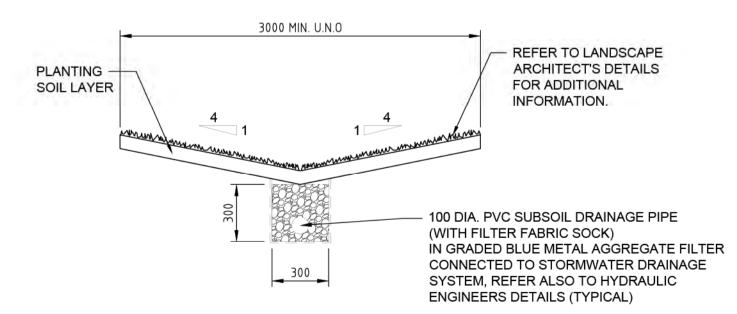
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TYPICAL VEGETATED SWALE DETAIL

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F	02/09/2019	REMOVED TREE CORRECTION FOR	
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H	25/08/2020	SS DA	JH
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Date 04/12/2020

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Description

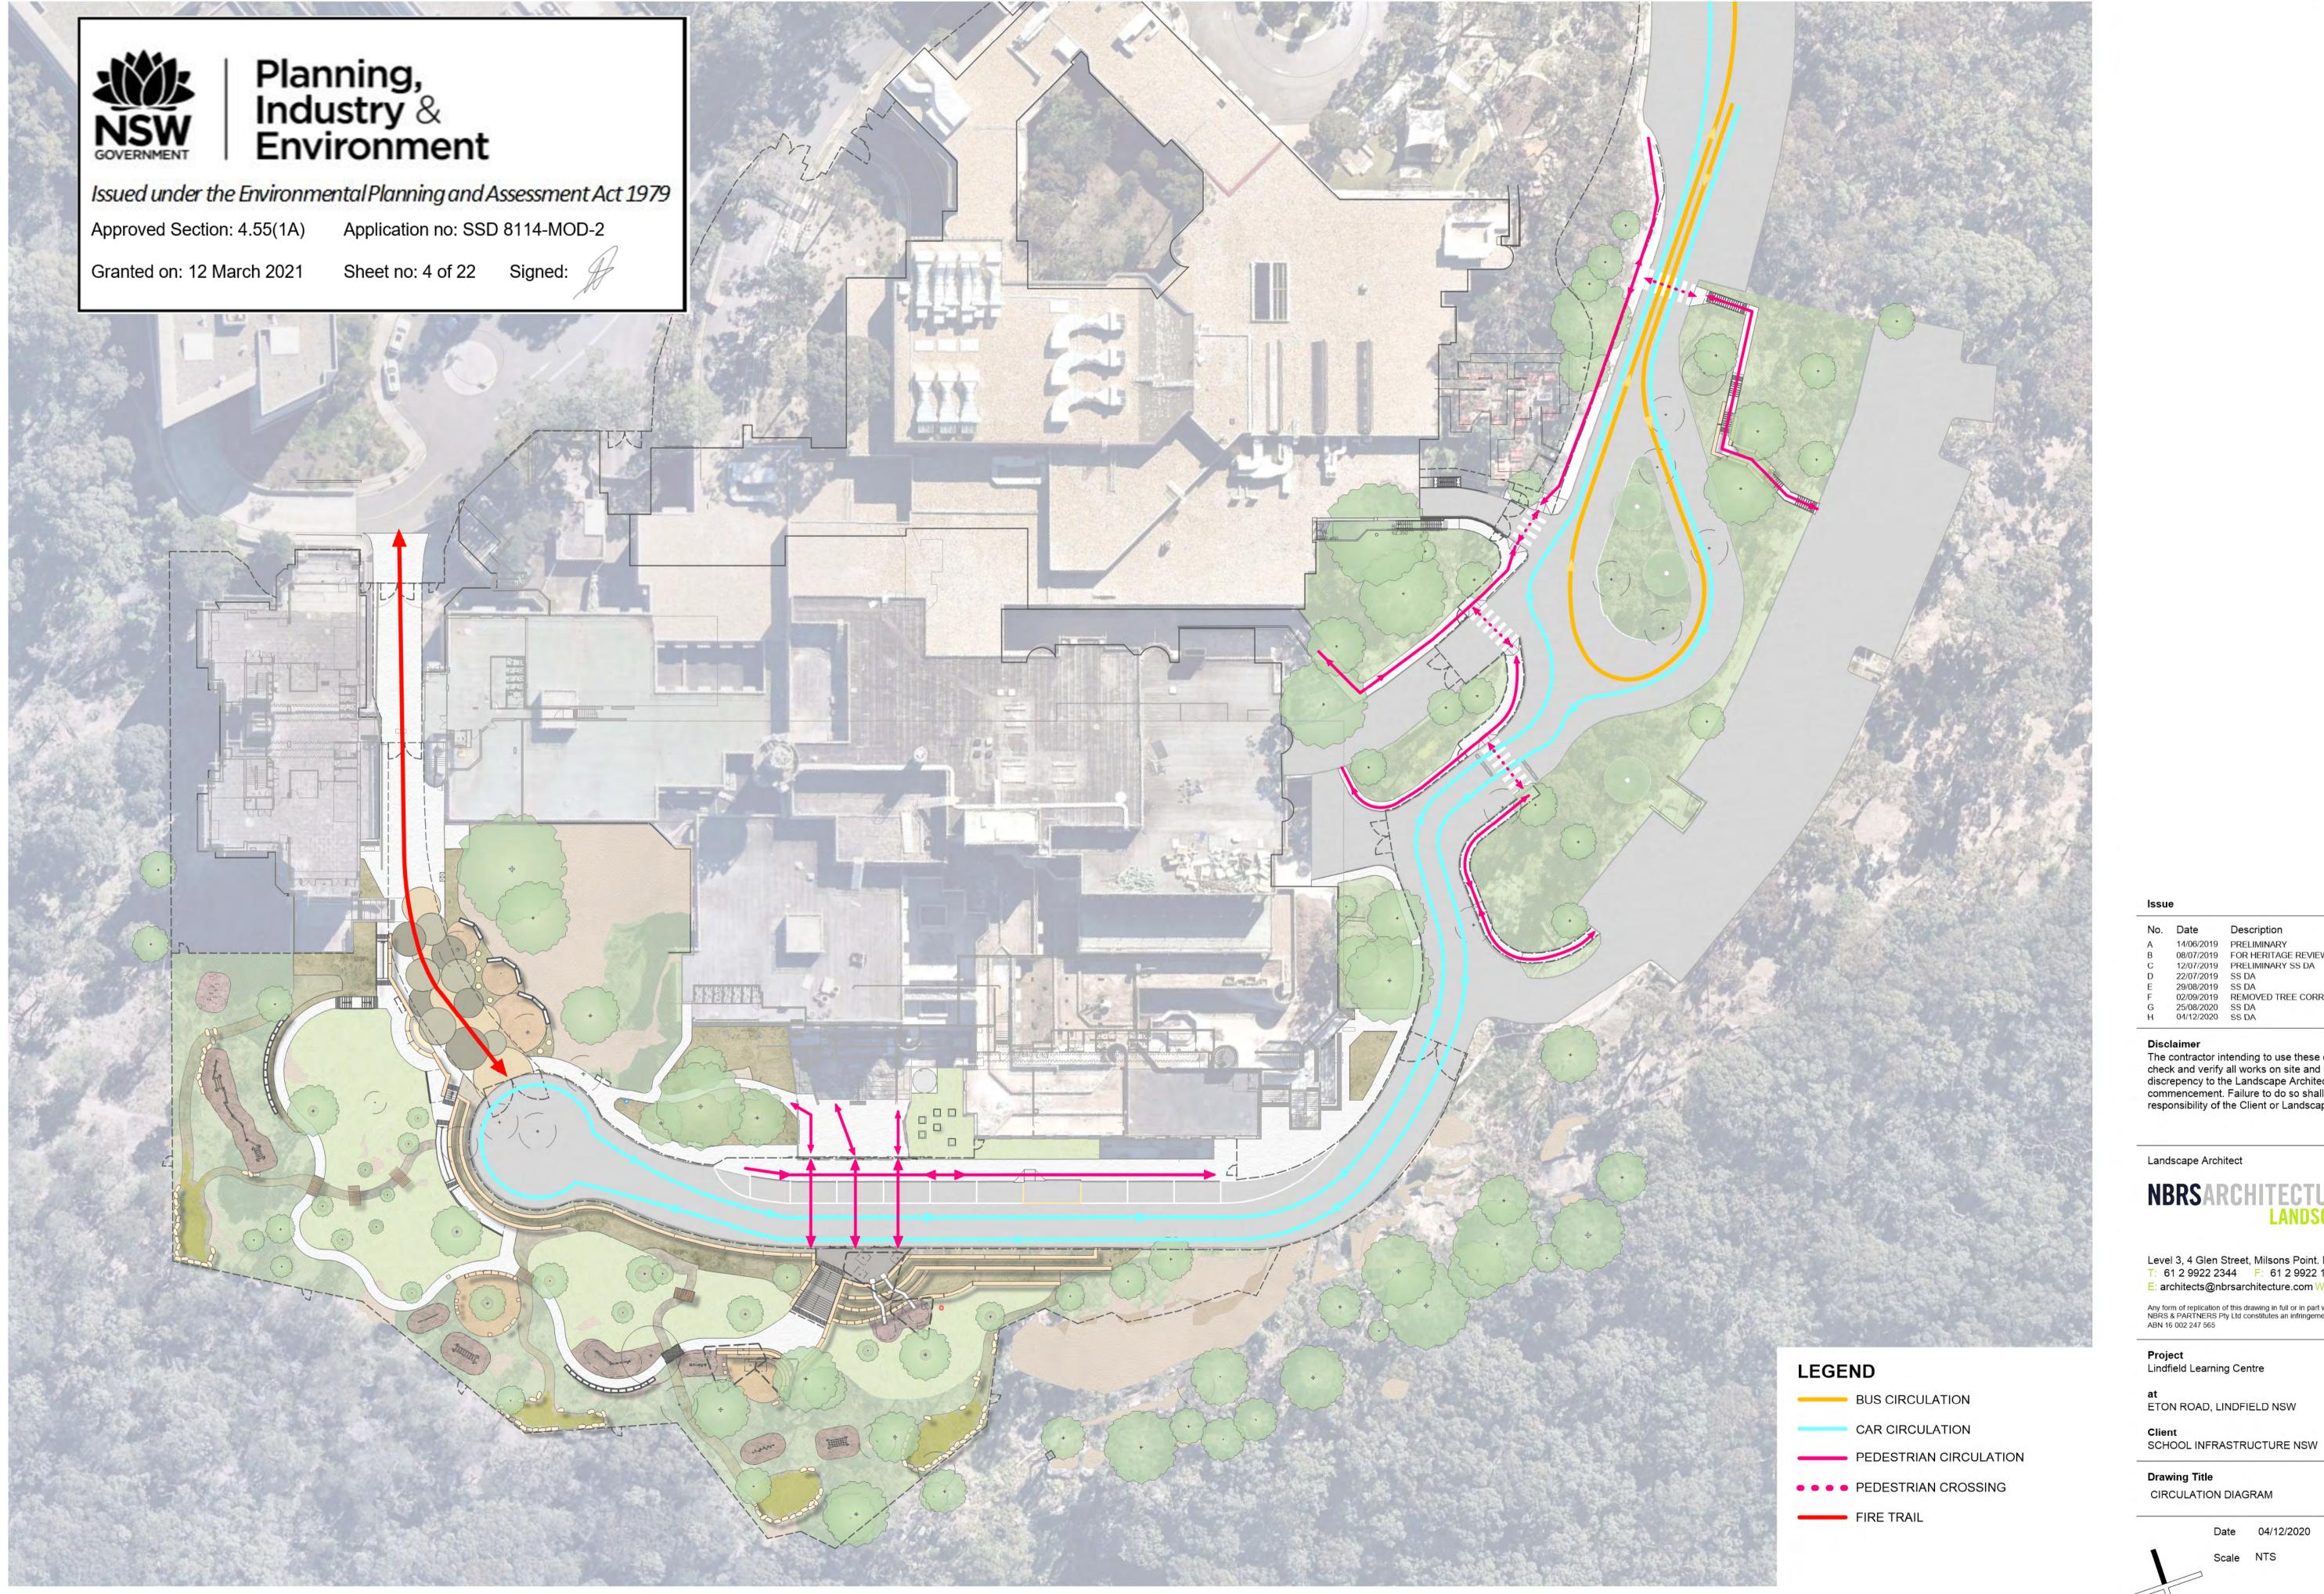No. Date

WSUD DIAGRAM



Landscape Blow Up Plan 1

Fire truck access playspace

The new vehicle turning head to the south of the COLA for increases the change in level between road and lower play space. Circular sandstone log terracing with plants in between is proposed to retain soil adjacent the road with and no access from the road to the lower play space.

The fire truck access area to the west of the turning circle will be utilised as a play space, effectively acting as a threshold between the COLA and the lower play space. As a result of the new fencing arrangement Children will now be able to move freely from the upper to lower area through this space. We propose a number of robust surface treatments including varying diameter interlocking and standalone circular coloured concrete pads, reflective of the turning circle geometry, with games line-marking, minimal areas of reinforced turf, deco sandstone and boulders to the outside of the core fire truck pathway.

Inclusions are:

- Defined circular areas of play with line markings and varying materials along the fire access pathway
- Passive deco sandstone sitting areas for informal learning
- Border planting of native plants, inc conjunction with bushfire consultant
- Retention of existing trees and rock outcrops adjacent school
- Sandstone steps to lower open grass area to double as sitting steps
- Native lower lawn areas with areas of exposed rock
- Accessible path or travel to the north of the play space

Native Materials

The sandstone logs will be natural in appearance with rough split face finishes to the sides of the log and gang sawn finish to the top, bottom and ends. Sizes will vary from the standard 2000x500x500mm to half size 1000x500x500mm. The sawn finishes will enable children to sit comfortably on the rock. This approach will represent and reference the natural rock sandstone escarpment located to the east. Our proposal includes a number of breaks in the sandstone and pockets of native indigenous grass and shrub planting in those gaps to further integrate the proposal with the natural character. There will be some integrated crushed sandstone between the stones (no turf) to allow for passage between the terraces.

A Note on Open Lawn Areas

All turf areas will be laid in controlled areas only and surrounded by coloured concrete paths to prevent the encroachment of turf into the bush setting. Turf is generally kept to a minimum and will be Nara Zoysia macrantha - native turf that is low maintenance and easy to establish. It has outstanding winter colour – and will in fact out perform popular buffalo varieties.



Planning, Industry & Environment

Approved Section: 4.55(1A) Application no: SSD 8114-MOD-2

Granted on: 12 March 2021

Sheet no: 6 of 22 Signed:

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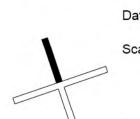
ETON ROAD, LINDFIELD NSW

Client SCHOOL INFRASTRUCTURE NSW

SCHOOL INFRASTRUC

Drawing Title

LANDSCAPE BLOW UP PLAN 1



Date 04/12/2020 Scale 1:100

Project No. Sheet No.

20203 LA-2-0010 H

2 SECTION B Scale: 1:75

SECTION A
Scale: 1:75

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 FOR HERITAGE REVIEW
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 PRELIMINARY SS DA
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 D
 22/07/2019
 SS DA
 JH

 E
 29/08/2019
 SS DA
 JH

 F
 02/09/2019
 REMOVED TREE CORRECTION FOR SSDAJH

 G
 25/08/2020
 SS DA
 DH

 H
 04/12/2020
 SS DA
 BR

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Landscape Blow Up Plan 2

The Flexible Recreation Precinct

Utilising the minimal changes in grade this precinct provides an opportunity for active and passive recreation activity, similar to the stage 1 landscape design to the north. The change in grade from the road to the lower turf areas has created an opportunity for viewing over the space and an informal amphitheatre. Inclusions are:

- Open native lawn areas with areas of exposed rock
- Sandstone log terracing doubling as sitting walls
- Parkour trail commencement including manufactured elements and natural materials
- Running track with distances to be marked on the concrete path loop
- Existing trees retained to provide shade
- Accessible path from the North
- Organic geometry to paths and lawn spaces in response to the circular turn around area and natural feel of the site. Vegetated WSUD swales throughout to channel and filter water from roadway
- Lawn areas will framed by loose rough rock, groups of native grasses, areas of deco sandstone and naturalistic vegetated swales with sleeper crossings.

A Note on Open Lawn Areas

All turf areas will be laid in controlled areas only and surrounded by coloured concrete paths to prevent the encroachment of turf into the bush setting. Turf is generally kept to a minimum and will be Nara Zoysia macrantha - native turf that is low maintenance and easy to establish. It has outstanding winter colour and will in fact out perform popular buffalo varieties.

Native Materials

The sandstone logs will be natural in appearance with rough split face finishes to the sides of the log and gang sawn finish to the top, bottom and ends. Sizes will vary from the standard 2000x500x500mm to half size 1000x500x500mm. The sawn finishes will enable children to sit comfortably on the rock. This approach will represent and reference the natural rock sandstone escarpment located to the east. Our proposal includes a number of breaks in the sandstone and pockets of native indigenous grass and shrub planting in those gaps to further integrate the proposal with the natural character. There will be some integrated crushed sandstone between the stones (no turf) to allow for passage between the terraces. There are also a number of sandstone logs as part of the 'natural parkour' trail and these will be positioned in groups and situated at differing orientations to minimise the impact of man made intervention in the natural landscape.

Planning, Industry & Environment

Issued under the Environmental Planning and Assessment Act 1979

Application no: SSD 8114-MOD-2

Sheet no: 7 of 22 Signed:

Approved Section: 4.55(1A)

Granted on: 12 March 2021



NI-	Data	Description	Chles
No.	Date	Description	Chkd
Α	14/06/2019	PRELIMINARY	JH, AV
В	08/07/2019	FOR HERITAGE REVIEW	JH
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ETON ROAD, LINDFIELD NSW

SCHOOL INFRASTRUCTURE NSW

Drawing Title

LANDSCAPE BLOW UP PLAN 2

Date 04/12/2020

Scale 1:100 20203 LA-2-0011 H





OPEN LAWN (PASSIVE / ACTIVE RECREATION)





The Terraced Learning Precinct

The area immediately opposite the COLA provides a significant nodal point / threshold immediately adjacent to the road. This will have a handrail and be used as an access to the top of the slides.

Water runoff from the roadway will be captured in the bio swale immediately adjacent to the road and piped to the lower play space and run through vegetated swales to control ponds on the southern boundary.

The upper threshold area leads down to a coloured concrete plaza space and terraced sandstone amphitheater for informal outdoor learning. The area is bordered by open lawn areas and managed bush character with vegetated WSUD swales dispersing water throughout.

Inclusions are:

- Shelter structures at the upper terraced platform
- Natural coloured concrete plaza and steps.
- Concrete ramps and steps tying in with natural levels and features
- Sandstone log amphitheater for informal learning with crushed sandstone flooring
- Parkour trail to the south
- Lawn terrace with areas of exposed rock and furniture elements
- Existing trees retained



- **1** STABILISED CRUSHED SANDSTONE
- 2 SHELTERS REFER LA-2-0014 FOR DETAIL





Issued under the Environmental Planning and Assessment Act 1979

Approved Section: 4.55(1A)

Application no: SSD 8114-MOD-2

Granted on: 12 March 2021

Sheet no: 8 of 22





ate	Description	Chkd
/06/2019	PRELIMINARY	JH, AW
3/07/2019	FOR HERITAGE REVIEW	JH
/07/2019	PRELIMINARY SS DA	JH
/07/2019	SS DA	JH
/08/2019	SS DA	JH
/09/2019	REMOVED TREE CORRECTION FOR SS	SDAJH
6/08/2020	SS DA	DH
/12/2020	SS DA	BR
/1	2/2020	2/2020 SS DA

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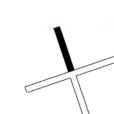
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ETON ROAD, LINDFIELD NSW

SCHOOL INFRASTRUCTURE NSW


Drawing Title

LANDSCAPE BLOW UP PLAN 3



Date 04/12/2020 Scale 1:100

20203 LA-2-0012 H

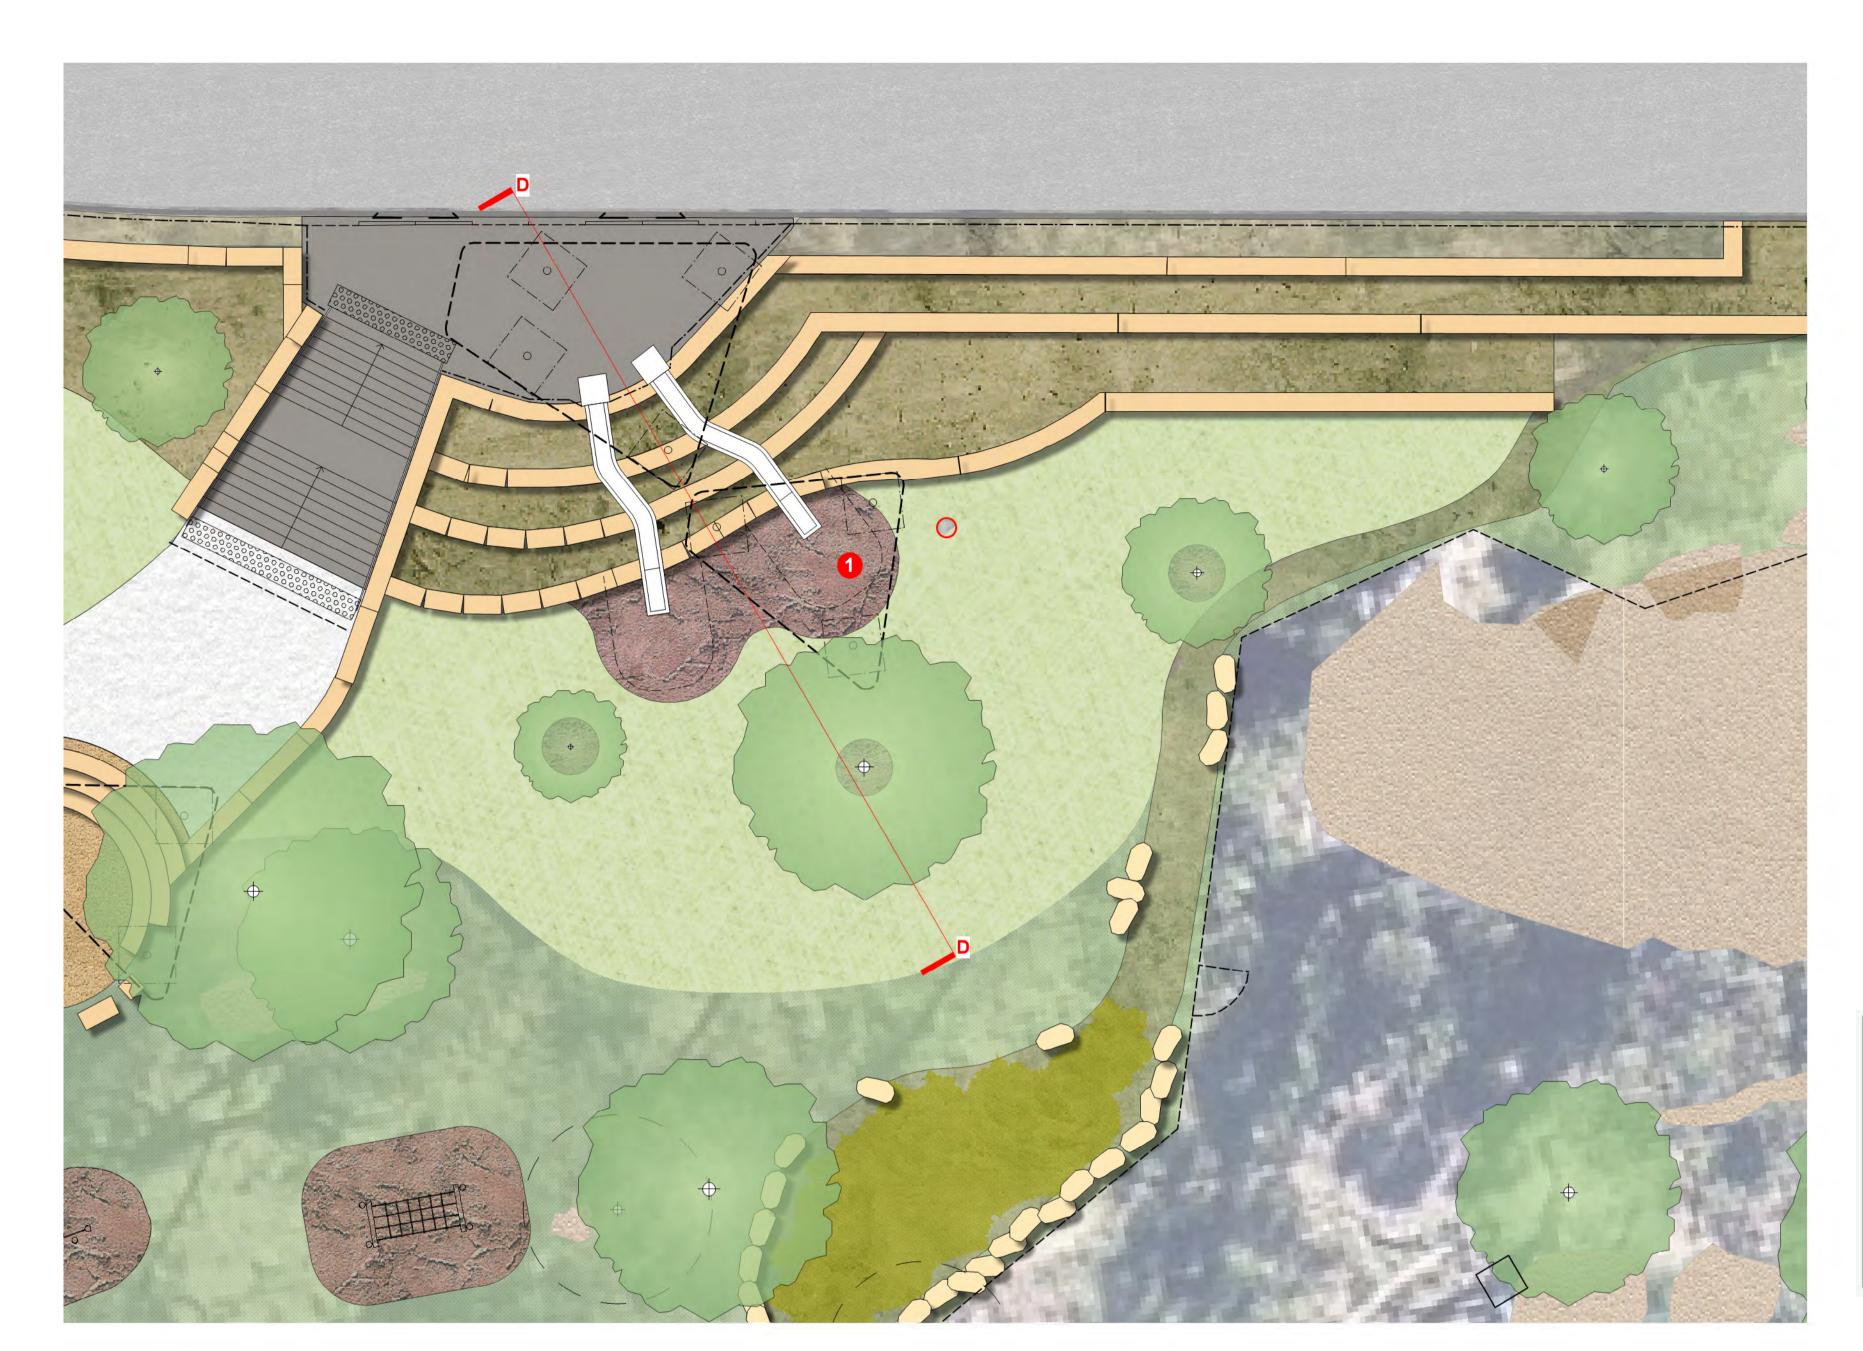

Landscape Blow Up Plan 4

Primary Adventure Play Space

This space contains the slide precinct and climbing precinct and will be the focus for active recreation. An extensive existing rock outcrop will act as a climbing wall with three climbing precincts of differing difficulty. The climbing precinct will be fenced and students only allowed access at controlled times and with full supervision. Inclusions are:

- Elevated slide precinct with 2 covered slides and climbing rocks / planting in-between.
- Staircases providing access from the upper and lower slopes



SLIDE PRECINCT



Issued under the Environmental Planning and Assessment Act 1979 Approved Section: 4.55(1A) Application no: SSD 8114-MOD-2

Granted on: 12 March 2021 Sheet no: 9 of 22 Signed:



No.	Date	Description	Chkd
Α	14/06/2019	PRELIMINARY	JH, AV
В	08/07/2019	FOR HERITAGE REVIEW	JH
C	12/07/2019	PRELIMINARY SS DA	JH
D	22/07/2019	SS DA	JH
E	29/08/2019	SS DA	JH
F	02/09/2019	REMOVED TREE CORRECTION FOR S	SSDAJH
G	25/08/2020	SS DA	DH
Н	04/12/2020	SS DA	BR

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Drawing Title

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LANDSCAPE BLOW UP PLAN 4

Date 04/12/2020 Scale 1:100

Project No. Sheet No.

20203 LA-2-0013 H








Approved Section: 4.55(1A) Application no: SSD 8114-MOD-2

Granted on: 12 March 2021 Sheet no: 10 of 22 Signed

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LEGEND

- 4 AGILITY TRAIL MANUFACTURER: KOMPAN, MODEL: NRO865
- PARKOUR 1 MANUFACTURER: KOMPAN, MODEL: NRO851
- BALANCE BEAM (CUSTOM MADE)
- 4 STILTS MANUFACTURER: KOMPAN, MODEL: NRO806
- BALANCE POLES MANUFACTURER: KOMPAN, MODEL: NRO817
- 6 BALANCE POSTS WITH ROPE MANUFACTURER: KOMPAN, MODEL: NRO821
- BALANCE NET MANUFACTURER: KOMPAN, MODEL: NRO831 8 WOBBLE BRIDGE - MANUFACTURER: KOMPAN, MODEL: NRO810
- 9 SANDSTONE STEPPING STONE

No.	Date	Description	Chkd
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Drawing Title LANDSCAPE BLOW UP PLAN 7 - PARKOUR TRAIL

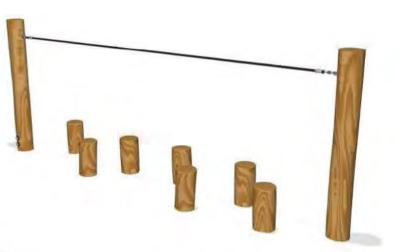Date 04/12/2020 Scale 1:100

20203 LA-2-0016 H







1 SECTION E 1:75

Landscape Blow Up Plan 8

Bus turnaround extended driveway zone

The extended driveway, bus turnaround loop has generally minimal physical impact on the existing landscape, but moderate impact visually. The loop road is intended to tie in with the existing levels as much as possible to achieve compliant grades.

There are existing eucalypt trees that will need to be removed to accommodate the construction of the bus loop. In conjunction with the bushfire consultant we propose to reinstate 3 No eucalypt trees (2 in the void and one further east toward the car park) The final positioning and species of trees will be determined at the time of occupation certificate but this is the current intent as co-ordinated by the consultant team.

Landscape surrounding the bus loop includes:

- Creating planting pockets on the embankment sufficient to accommodate the proposed Eucalypt trees and low grasses and shrubs in conjunction with Bushfire Consultant recommendations.
- Screening of the underside of the road and engineering supports to the new cantilevered road with tensioned vertical cables and climbing plants planted in terraced gardens at the base of the existing slope.
- A EXTENDED DRIVEWAY FOR BUS TURNAROUND
- B LANDSCAPE WITHIN VOID TO RETAIN NATURAL LEVELS
- PROPOSED NEW TREES TO REPLACE EXISTING
- SANDSTONE LOG RETAINING WALLS
- PEDESTRIAN CROSSING
- 8m WIDE DRIVEWAY
- **G** PATHWAY BEHIND FENCELINE



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Approved Section: 4.55(1A) Application no: SSD 8114-MOD-2

Granted on: 12 March 2021 Sheet no: 11 of 22 Signed &

No.	Date	Description	Chkd
Α	14/06/2019	PRELIMINARY	JH, AW
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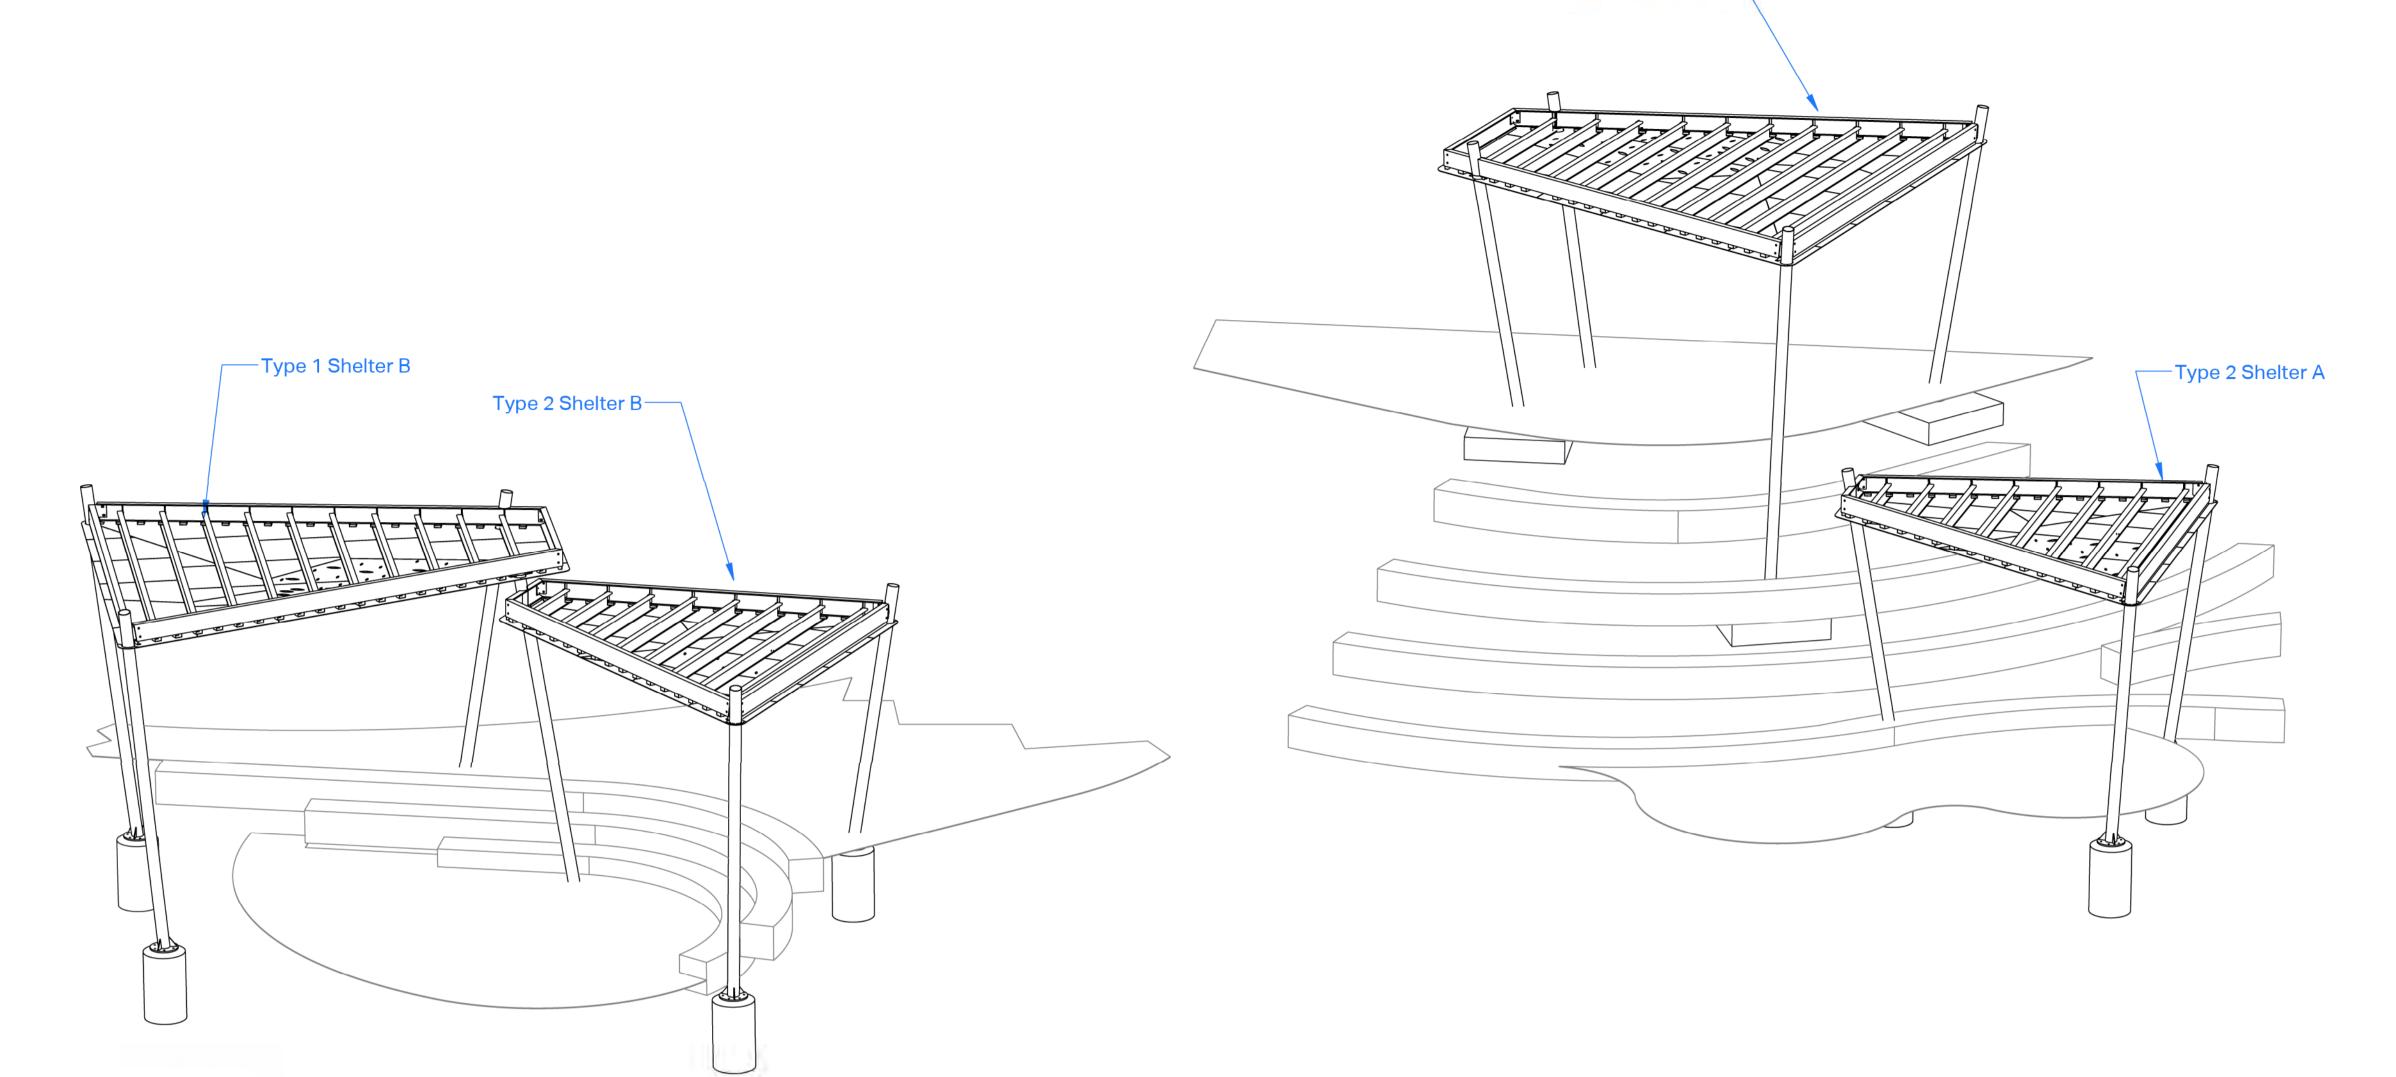
LANDSCAPE BLOW UP PLAN 8

Drawing Title

Date 04/12/2020 Scale 1:100

Project No. Sheet No.

20203 LA-2-0017 H



Type 1 Shelter A-



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Approved Section: 4.55(1A) Application no: SSD 8114-MOD-2

Granted on: 12 March 2021


Sheet no: 12 of 22 Signed

ngiled /

Shelter Design

All shelters will be of consistent materiality, and overall shape and form. The majority of the shelters are located considerably below the level of the road and will therefore will not block views of the buildings. Only the scale and number of overlapping rooves will vary from one location to the next. Additional detail has been added to the plans in accordance with that description. The rooves are shown on the plans as 'transparent' but will in effect be thin, powdercoated, perforated aluminum sheets with minimal side profile depth. An estimation of colour will be mid to dark sand or a 'cove matt' finish as prescribed in the report. The effect will be such that the roof structures on the shelters will have minimal reflection and not be considered highly visible from distance. The shapes of the roof structures replicate the design language used in the COLA. Shelter posts are intended to be either hardwood or powdercated aluminium and be representative of eucalypt tree trunks. The height of the roof structures above ground will vary but have minimal clearances to minimise visibility and provide maximum shade protection.

See T1182-103

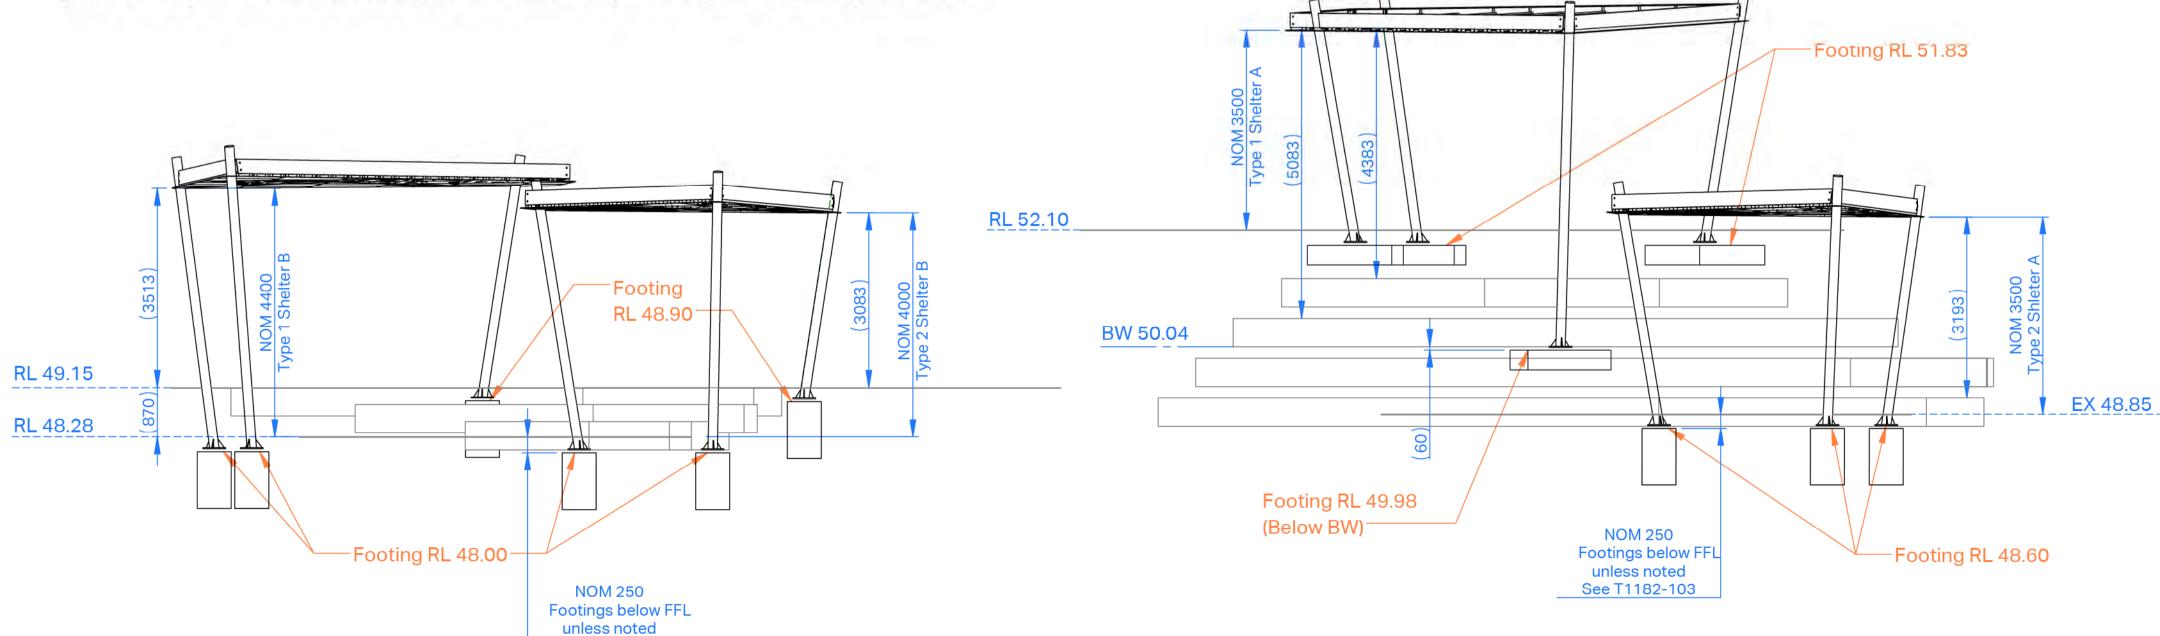

Southern Elevation

Issue

No.	Date	Description	
Α	14/06/2019	PRELIMINARY	
В	08/07/2019	FOR HERITAGE REVIEW	
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F	04/12/2020	SS DA	

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Drawing Title

SHELTER DESIGN


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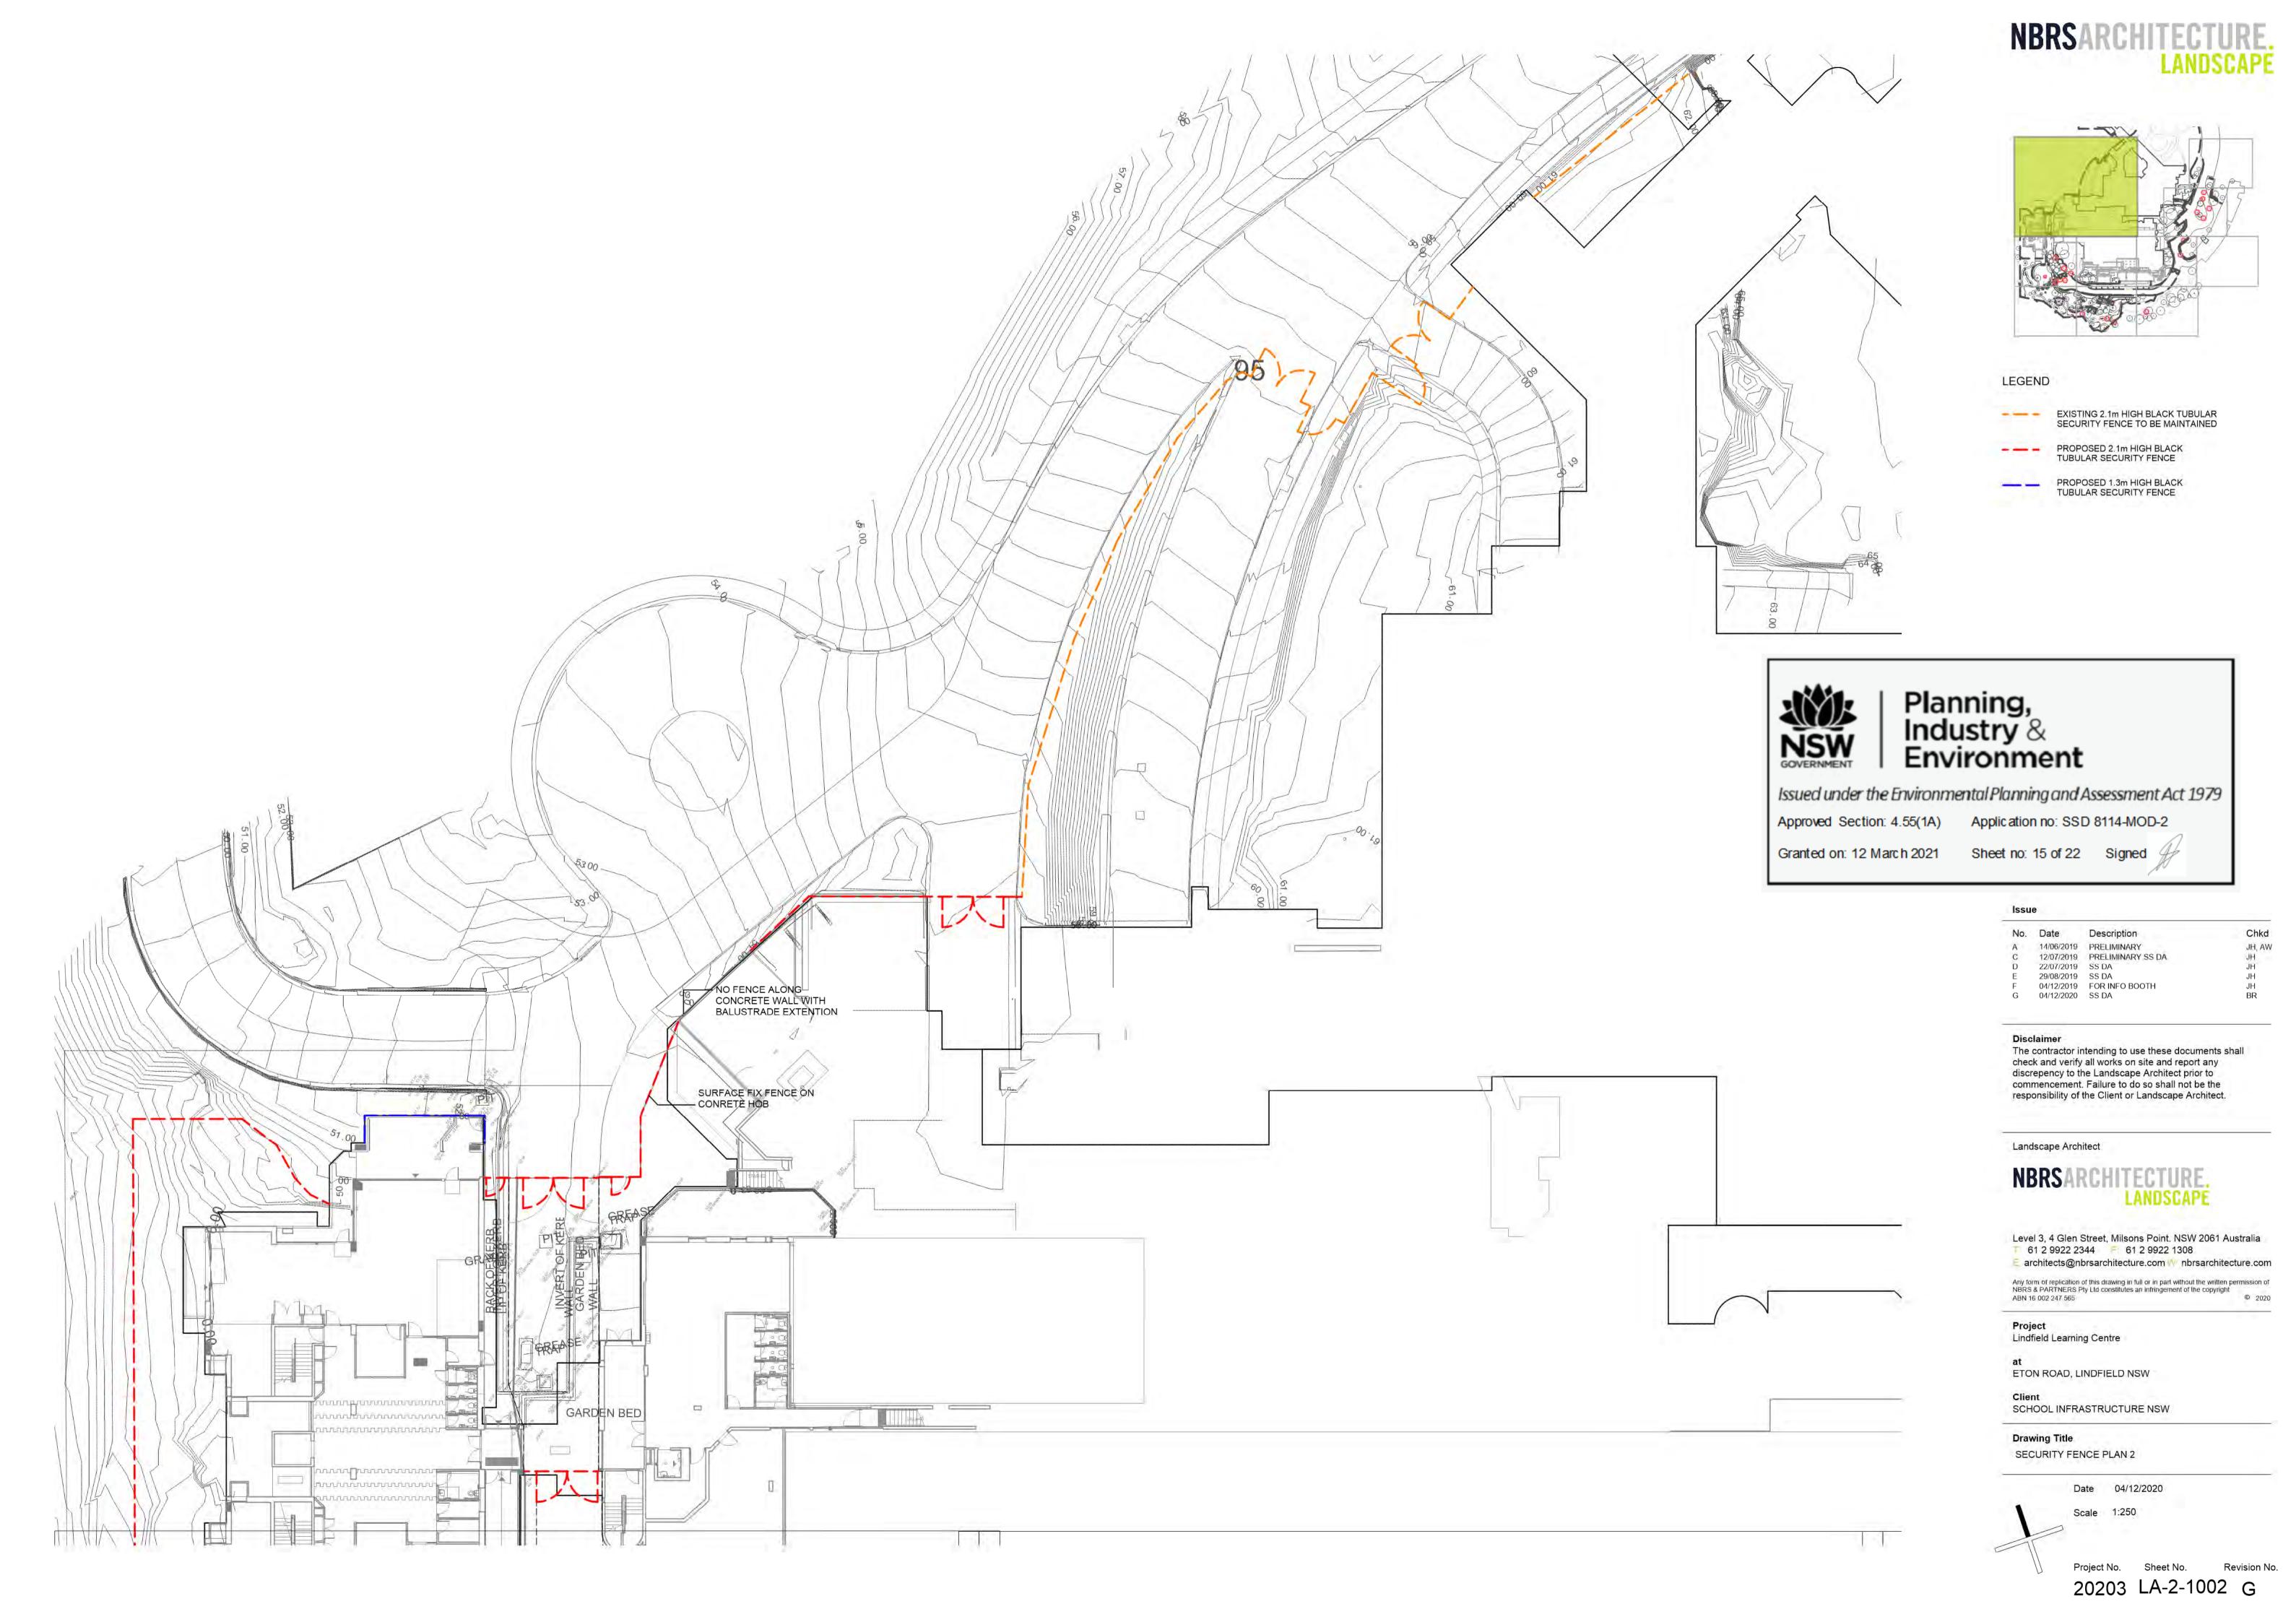
Date 04/12/2020 Scale 1:100


ct No. Sheet No.

20203 LA-2-0018 F






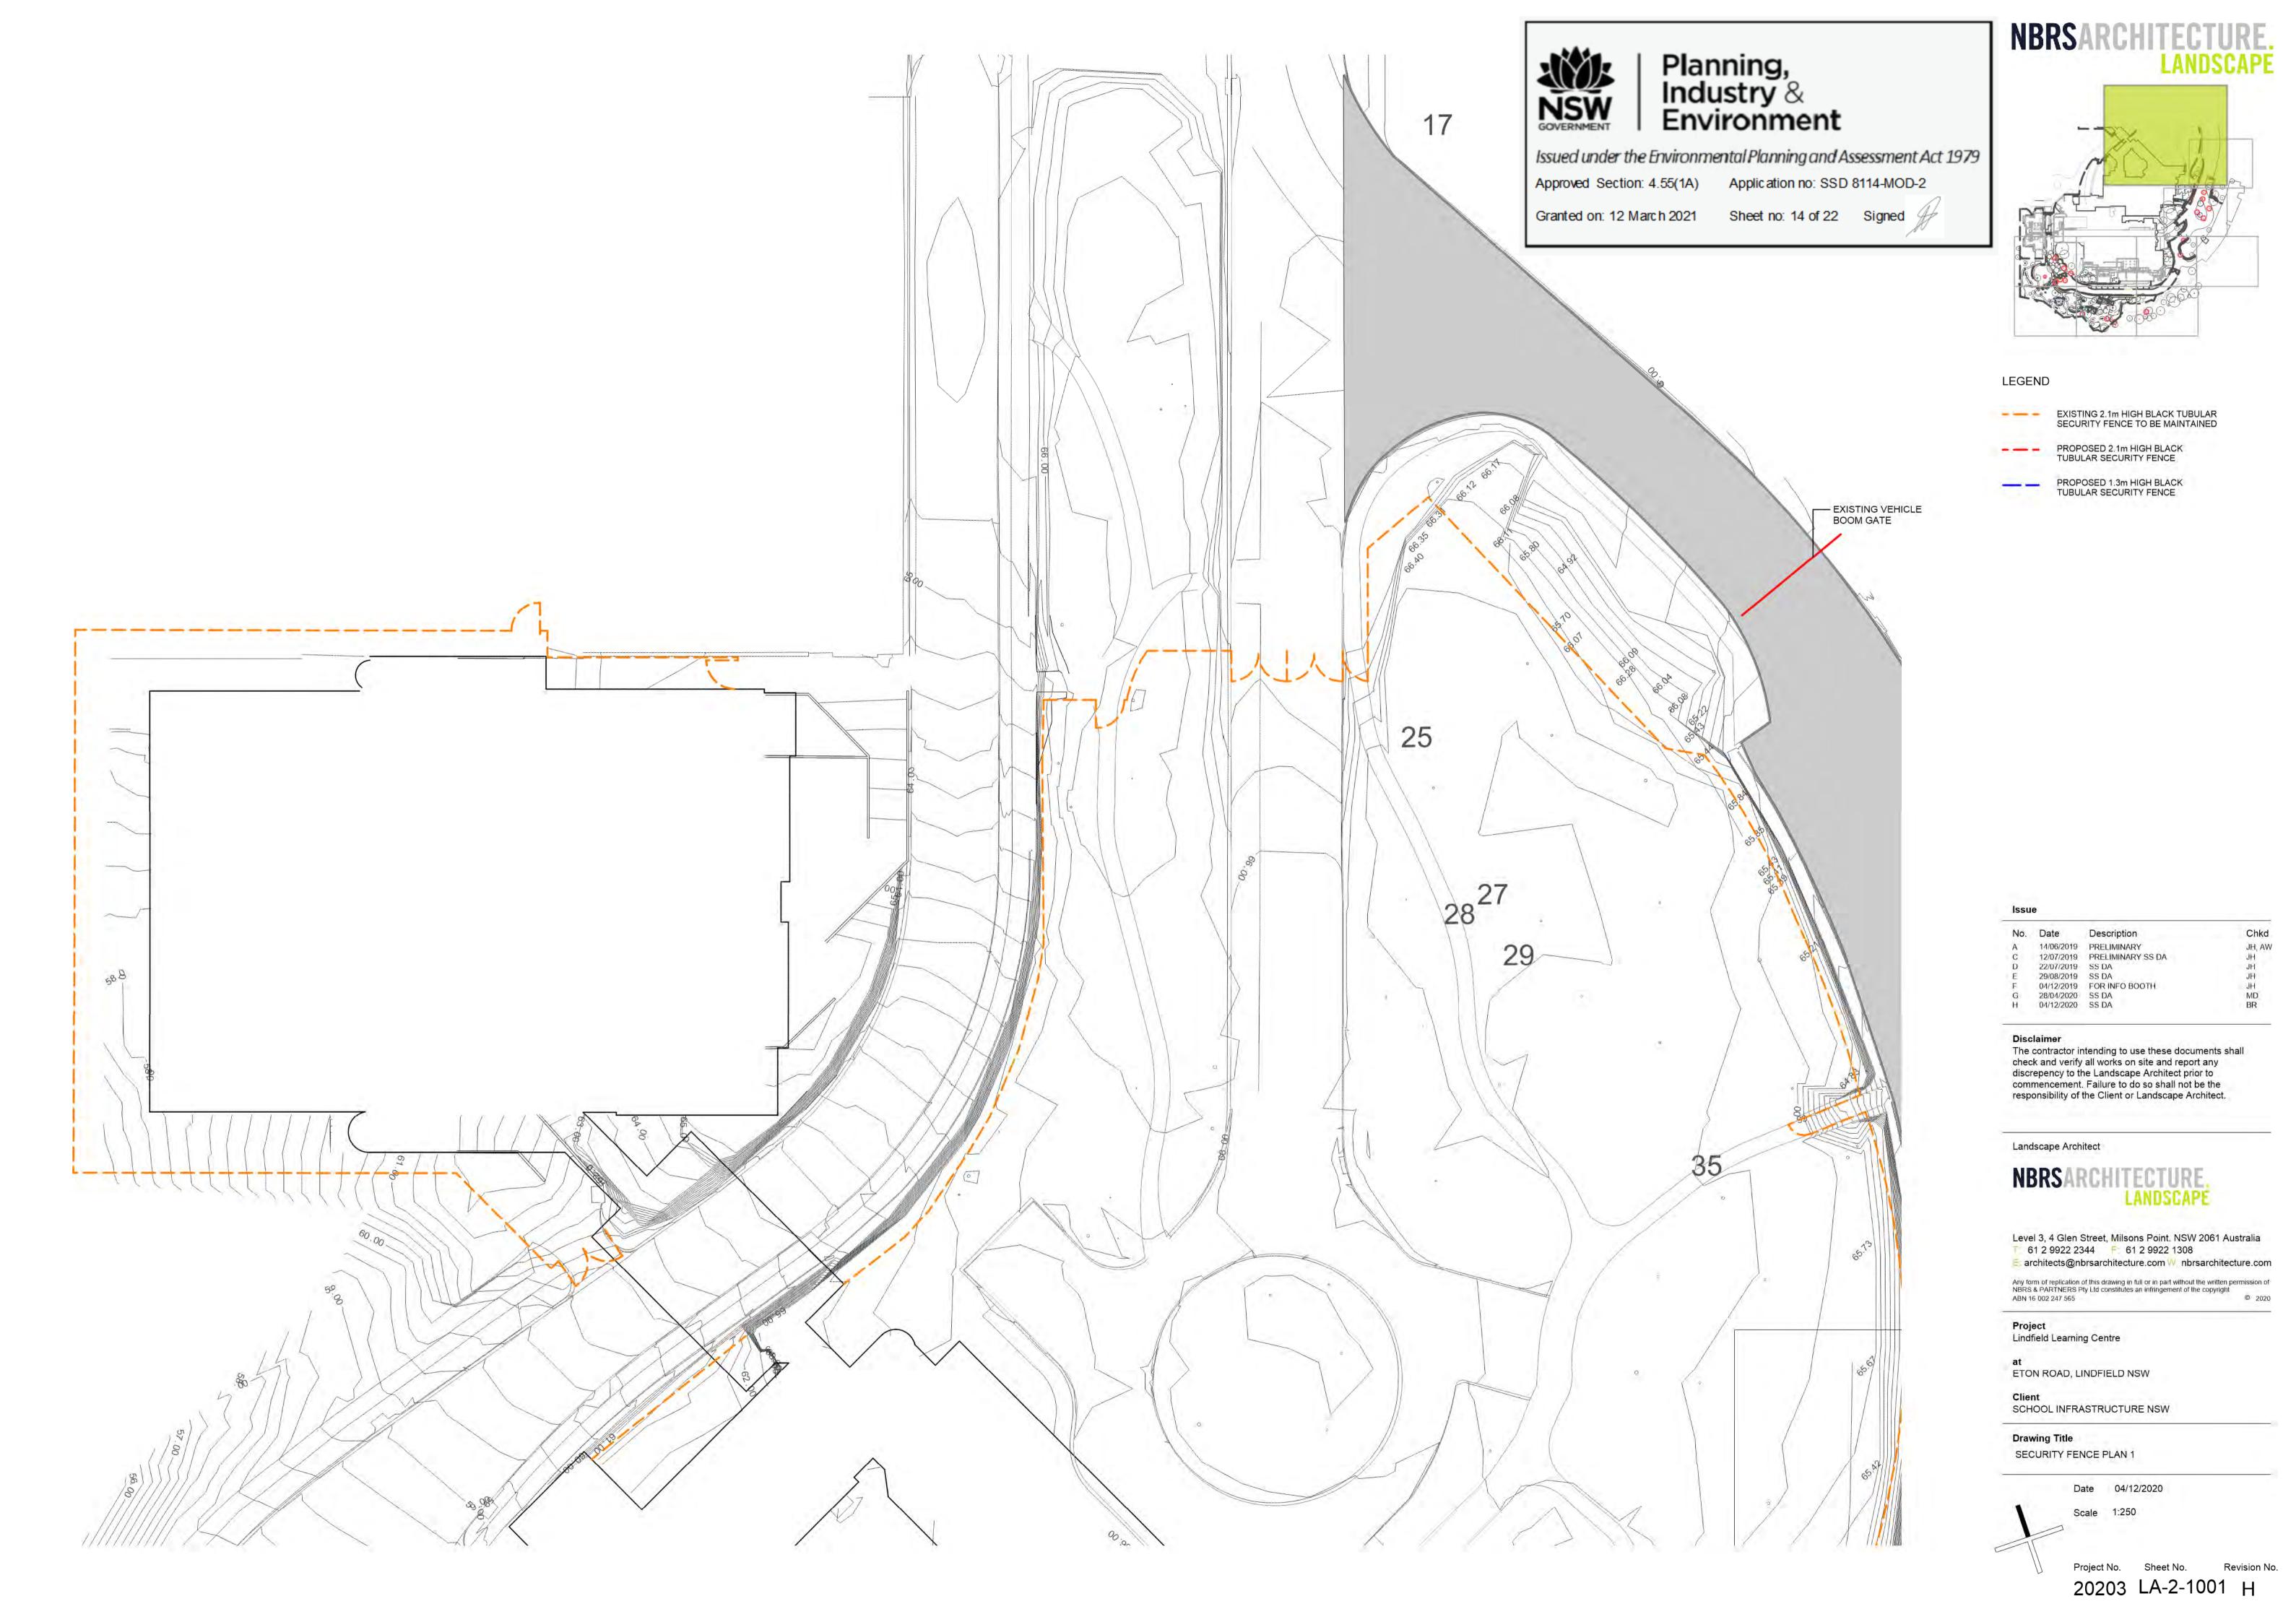

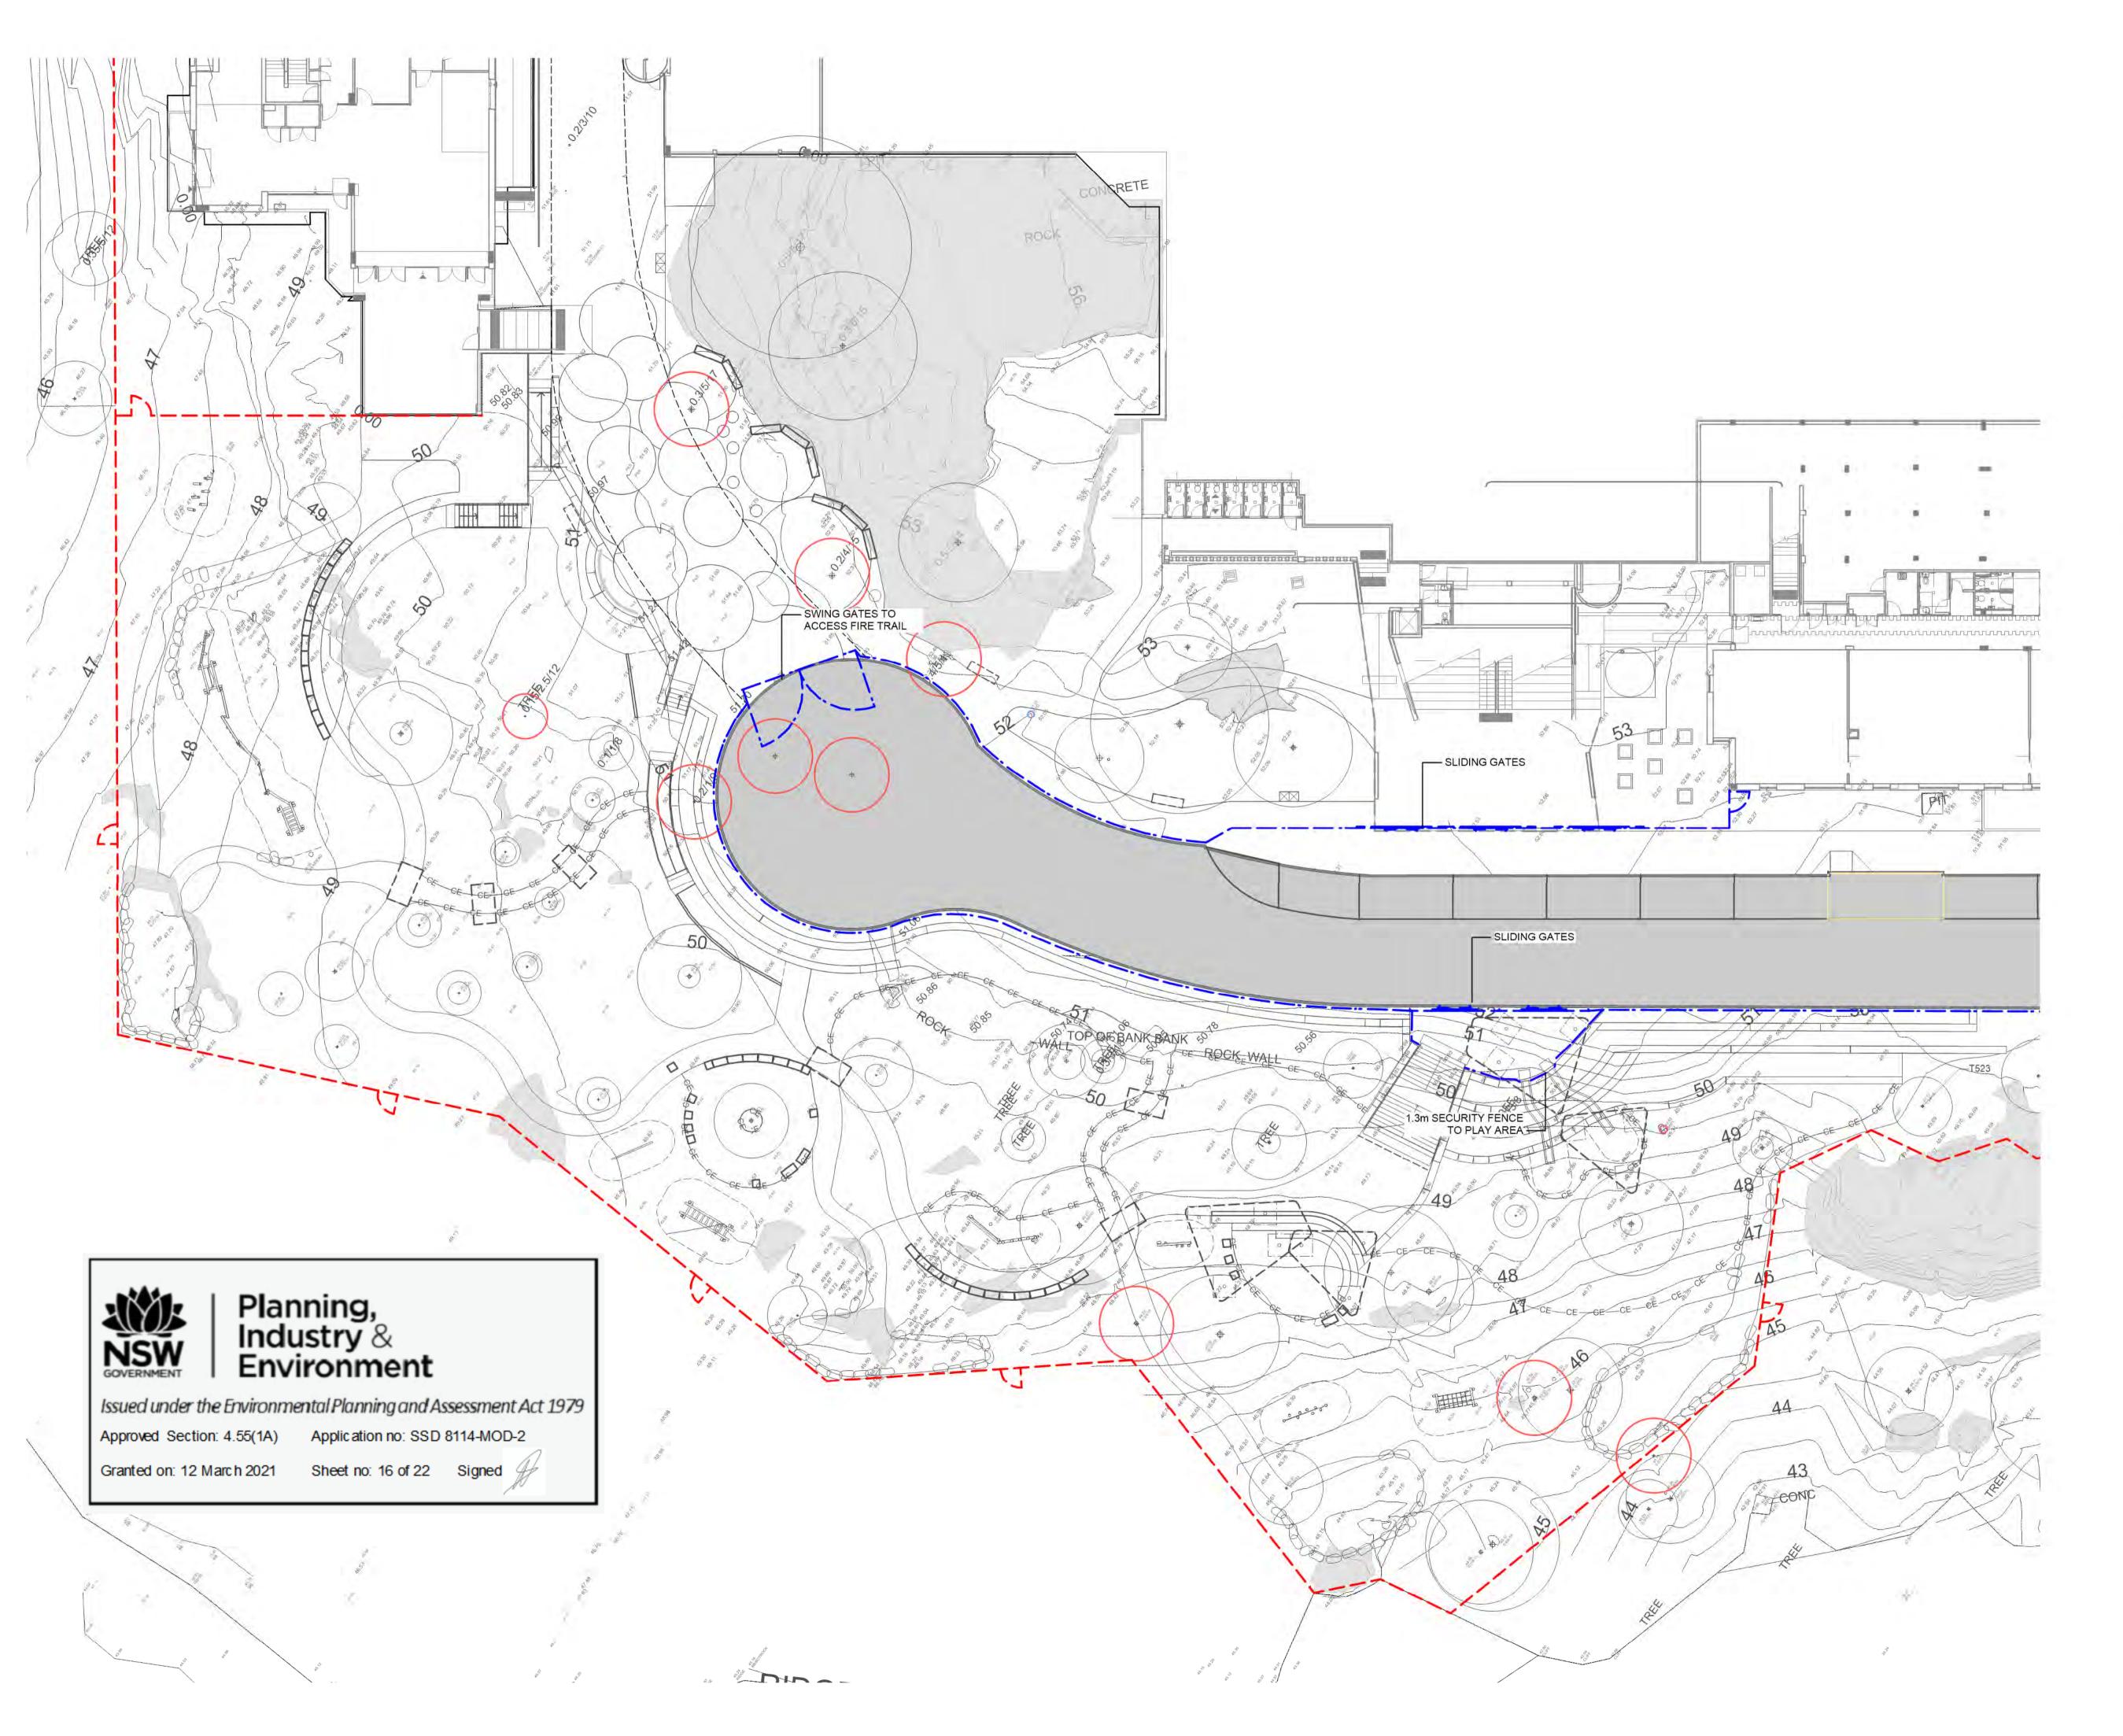





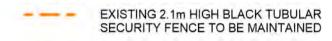

PROPOSED 2.1m HIGH BLACK TUBULAR SECURITY FENCE

PROPOSED 1.3m HIGH BLACK TUBULAR SECURITY FENCE

Issue

No.	Date	Description	Chkd
Α	14/06/2019	PRELIMINARY	JH, AV
C	12/07/2019	PRELIMINARY SS DA	JH
D	22/07/2019	SS DA	JH
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F	04/12/2019	FOR INFO BOOTH	JH
G	28/04/2020	SS DA	MD
H	04/12/2020	SS DA	BR

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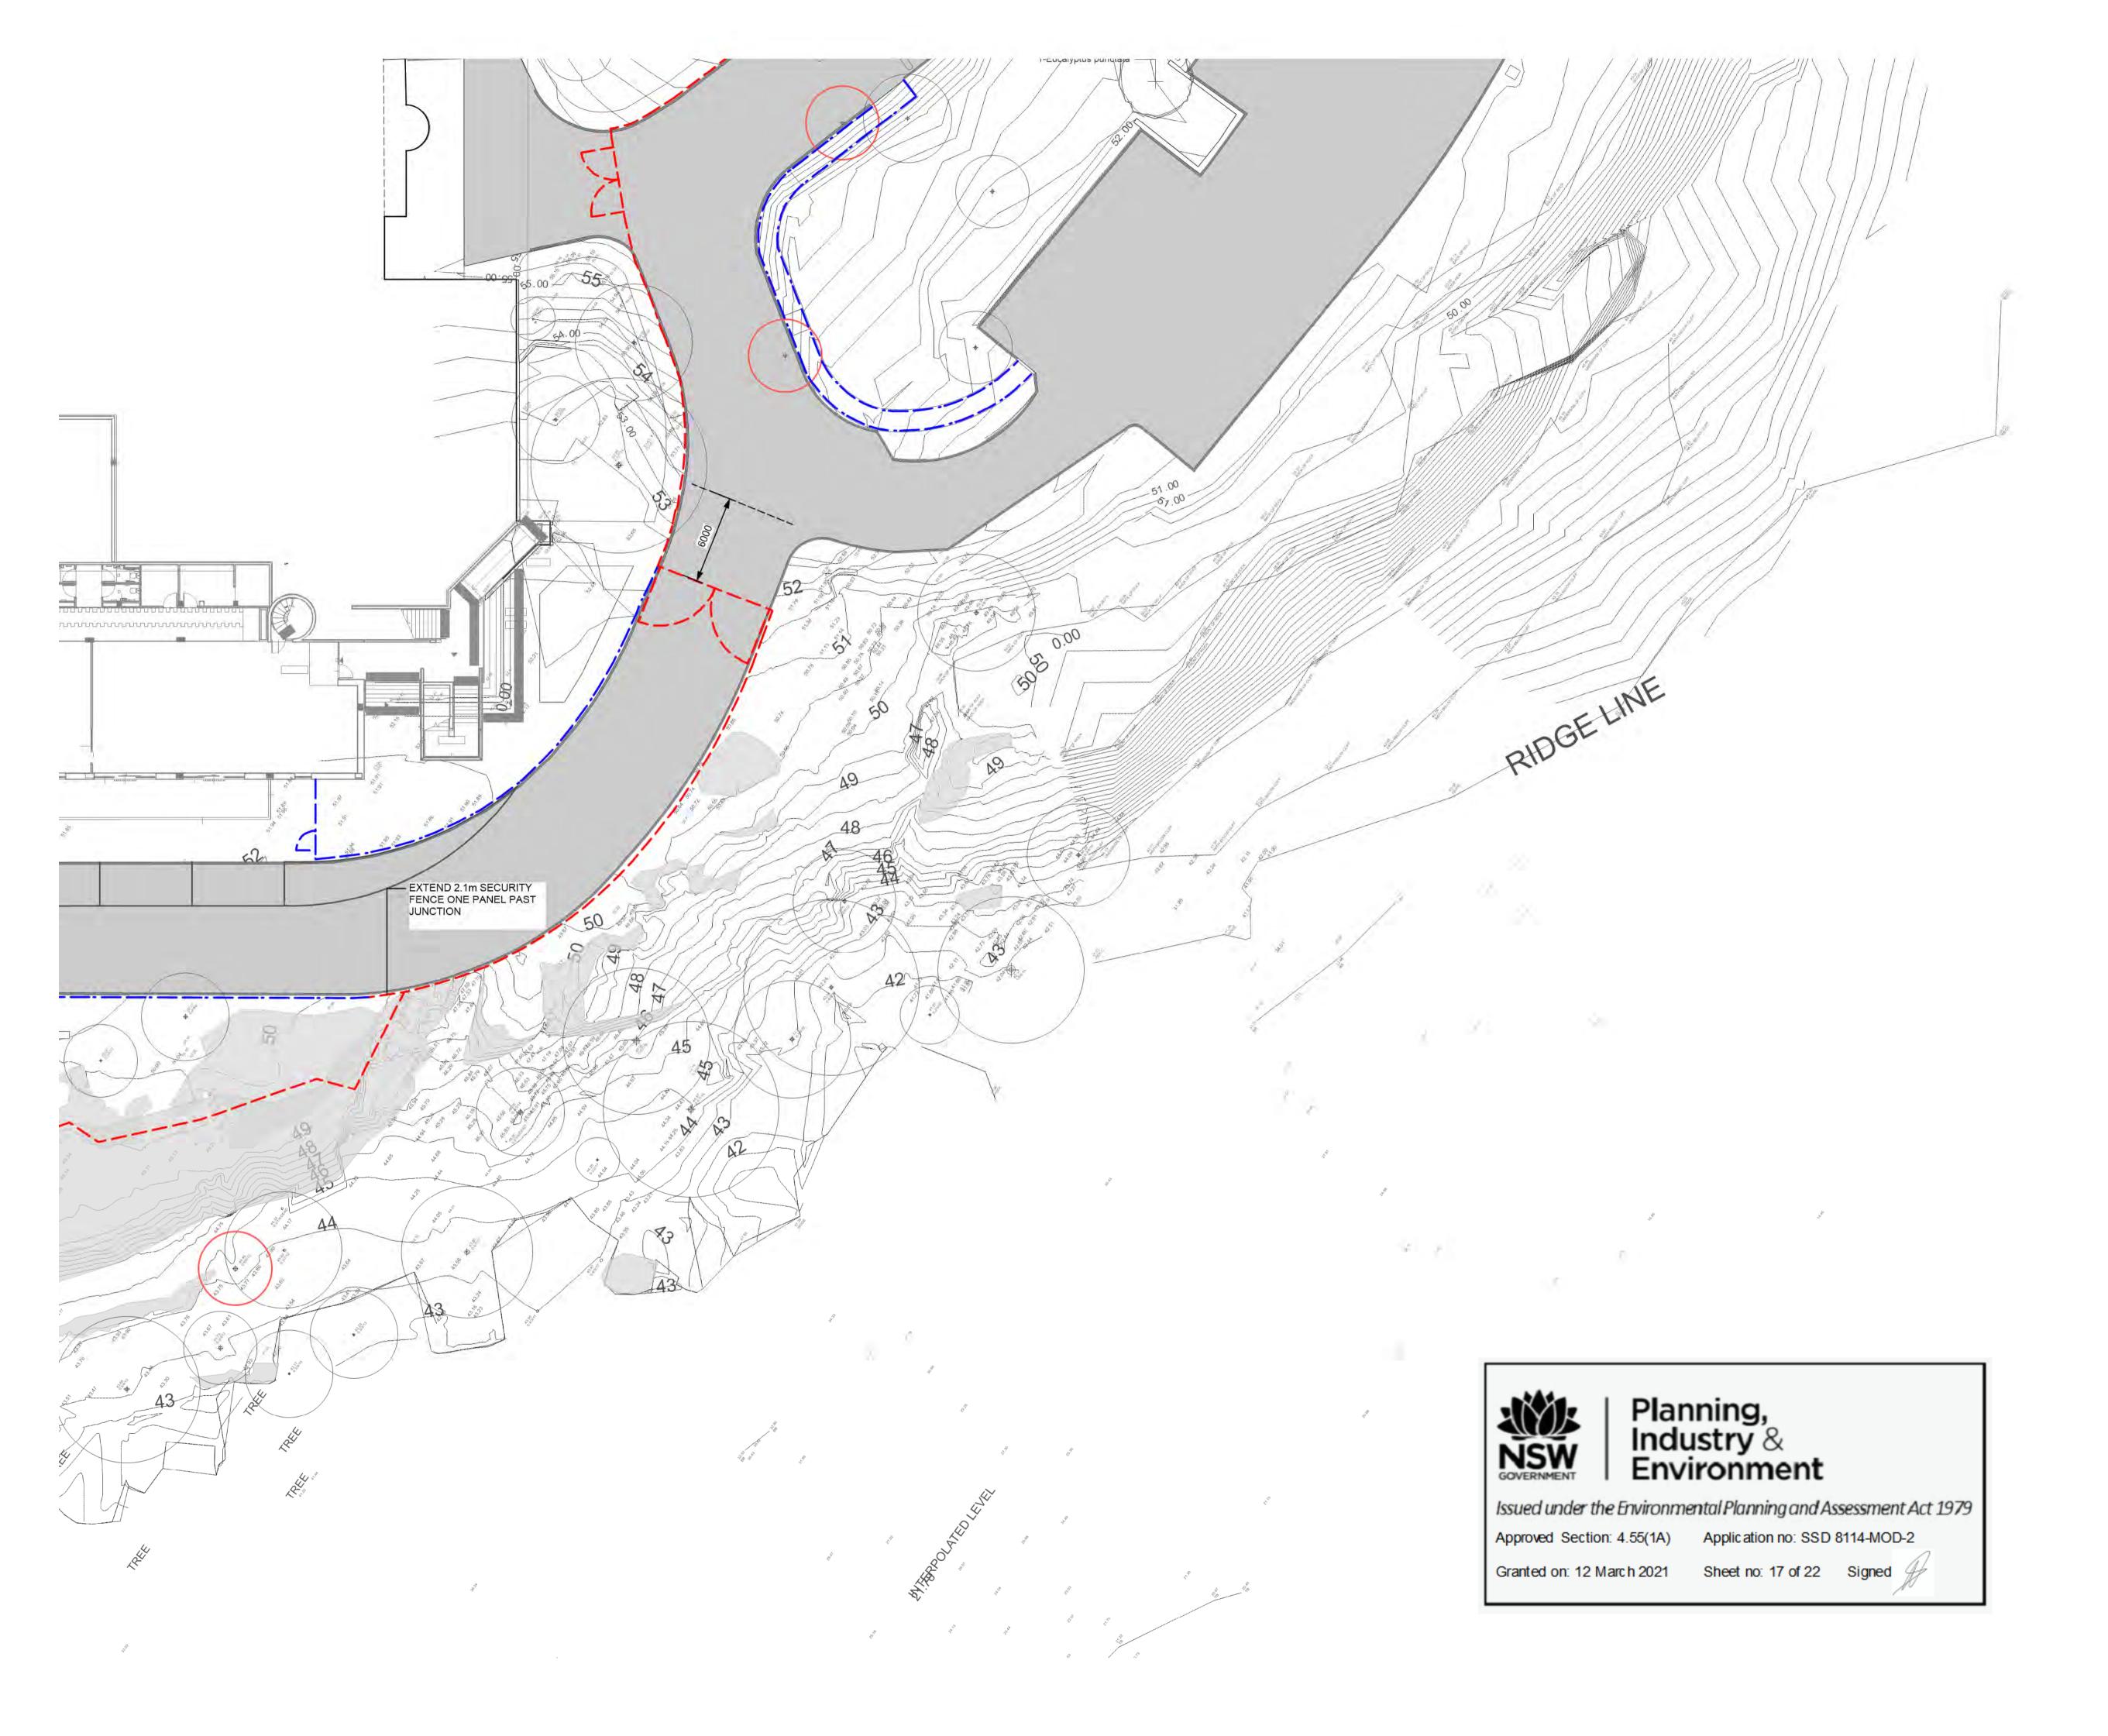
SECURITY FENCE PLAN 3

Date 04/12/2020

Scale 1:250

Project No. Sheet No. Revision No.

20203 LA-2-1003 H







EXISTING 2.1m HIGH BLACK TUBULAR SECURITY FENCE TO BE MAINTAINED

PROPOSED 2.1m HIGH BLACK TUBULAR SECURITY FENCE

PROPOSED 1.3m HIGH BLACK TUBULAR SECURITY FENCE

No.	Date	Description	Chkd
Α	14/06/2019	PRELIMINARY	JH, AW
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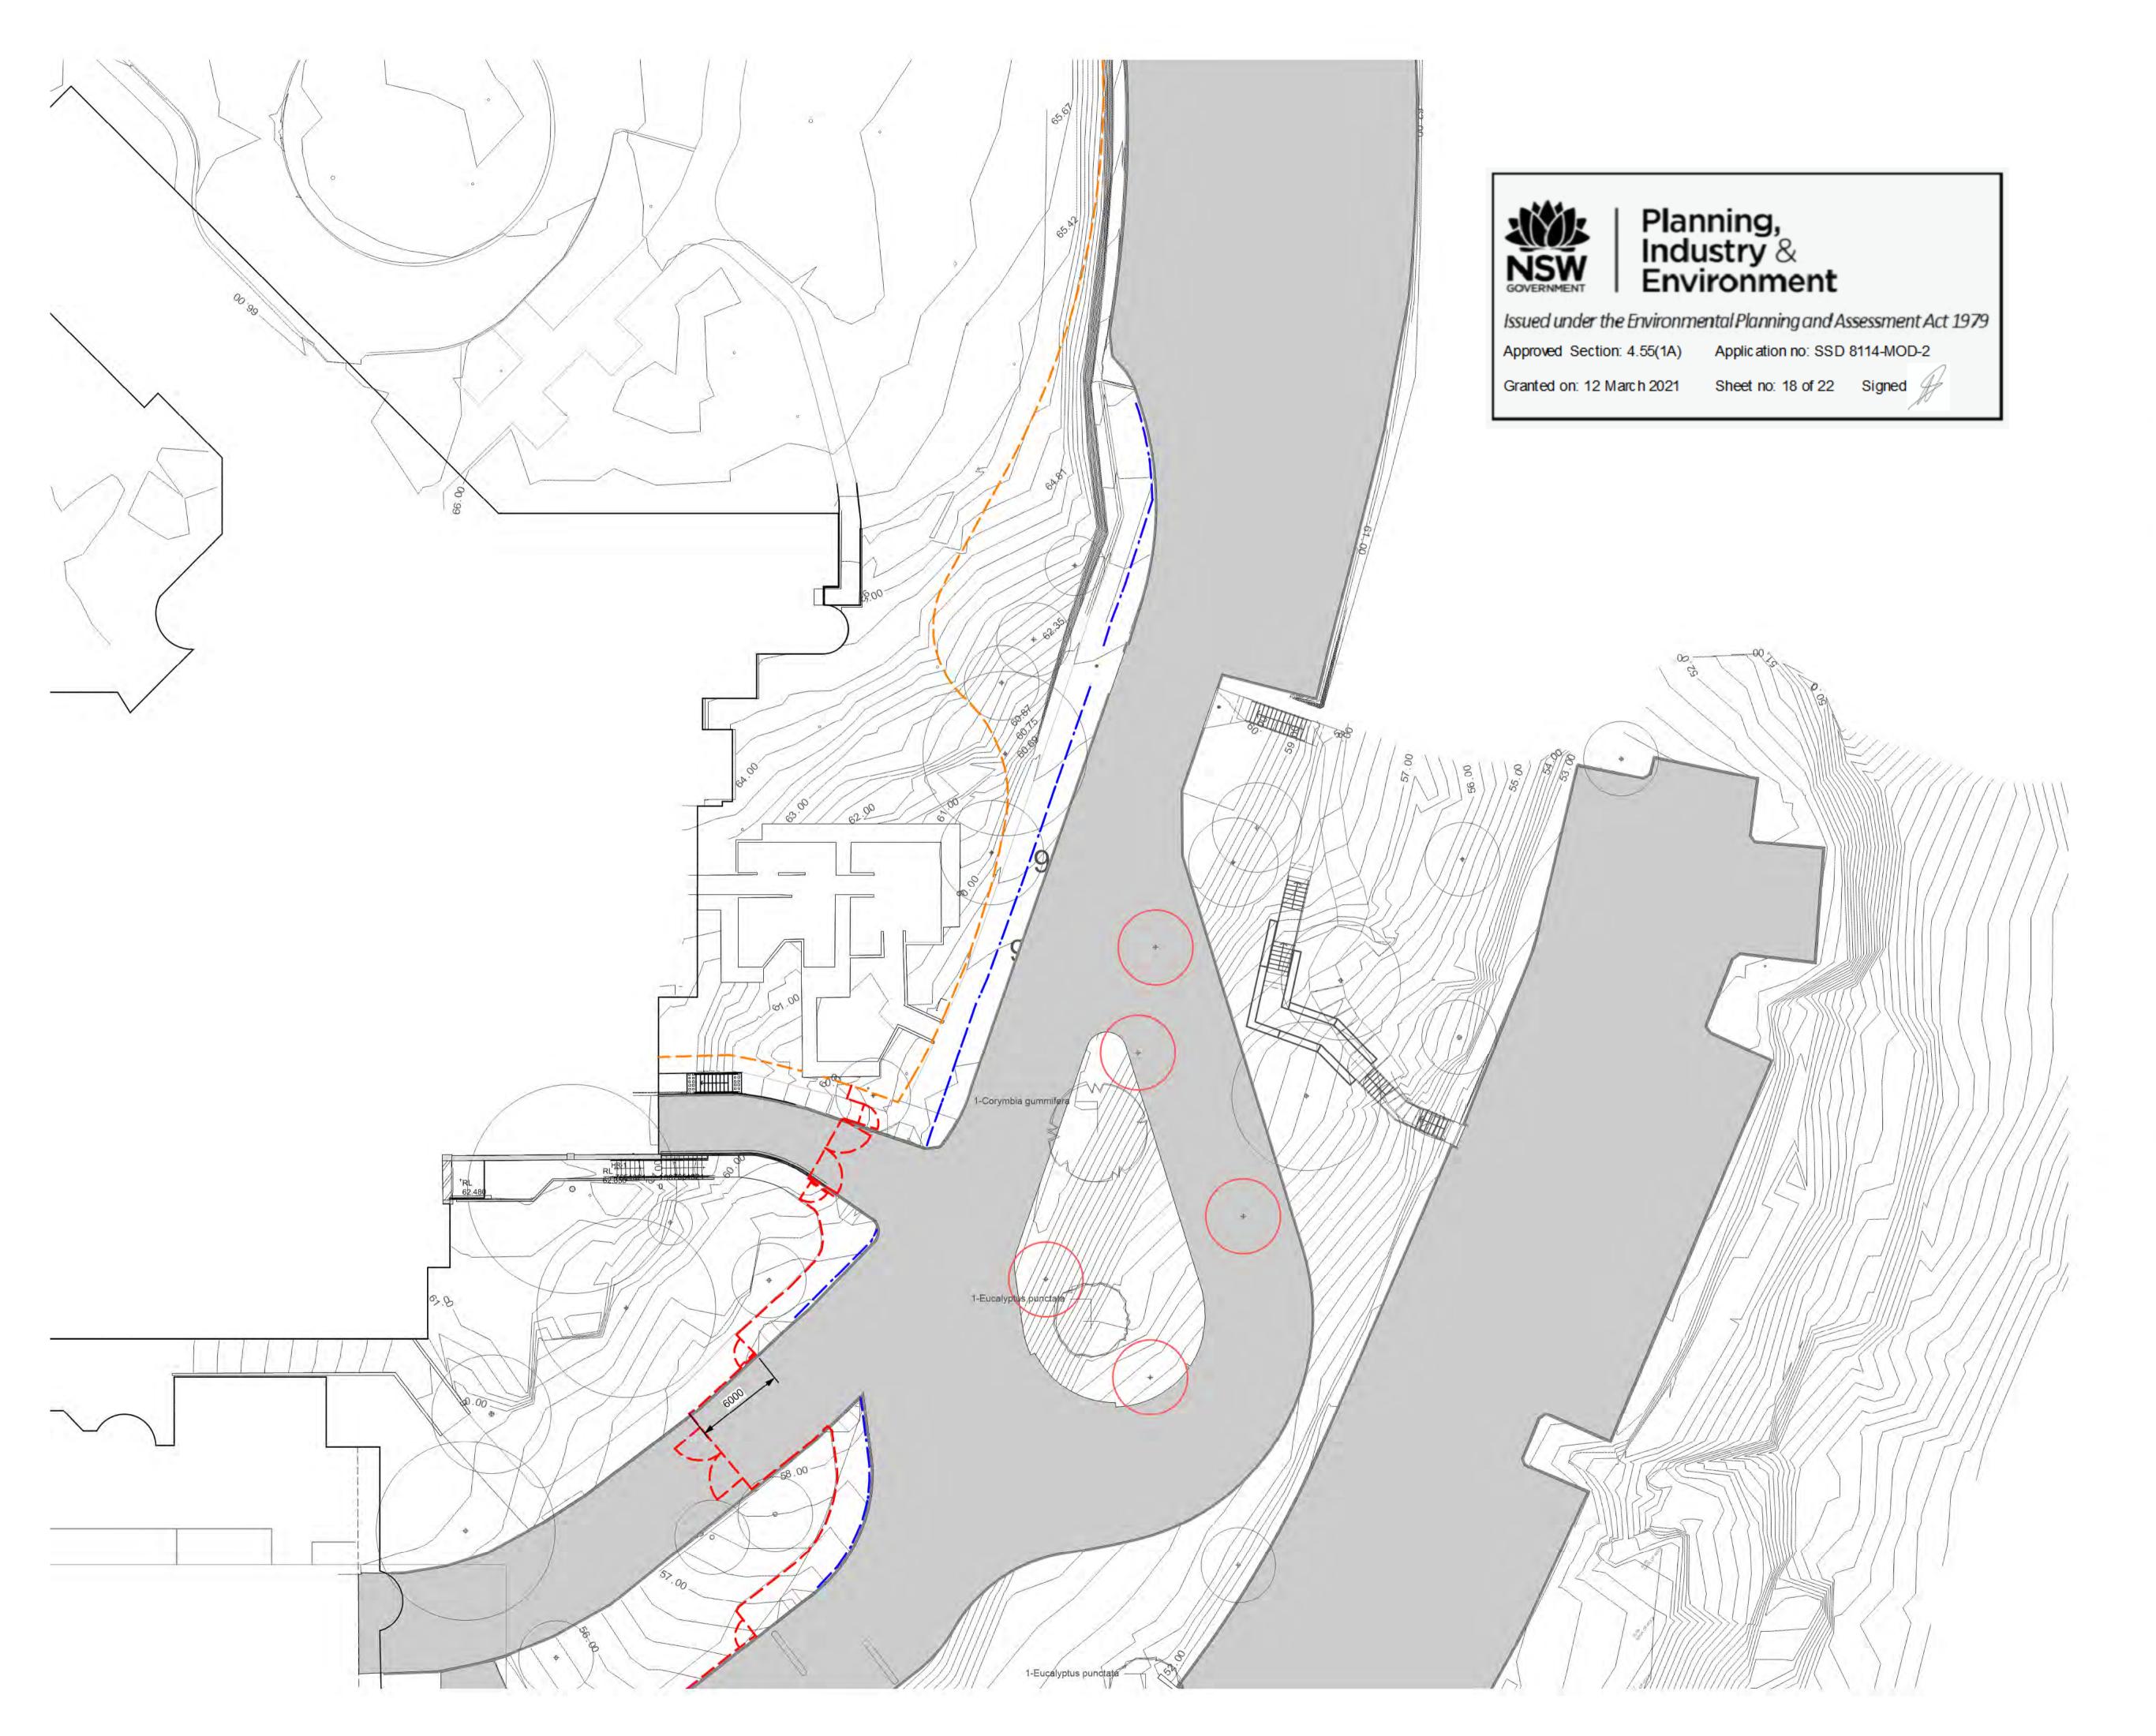
SCHOOL INFRASTRUCTURE NSW

Drawing Title SECURITY FENCE PLAN 4

Scale 1:250

Date 04/12/2020

20203 LA-2-1004 H







EXISTING 2.1m HIGH BLACK TUBULAR SECURITY FENCE TO BE MAINTAINED

PROPOSED 2.1m HIGH BLACK TUBULAR SECURITY FENCE

PROPOSED 1.3m HIGH BLACK TUBULAR SECURITY FENCE

Issue

No.	Date	Description	Chkd
Α	14/06/2019	PRELIMINARY	JH, AV
C	12/07/2019	PRELIMINARY SS DA	JH
D	22/07/2019	SS DA	JH
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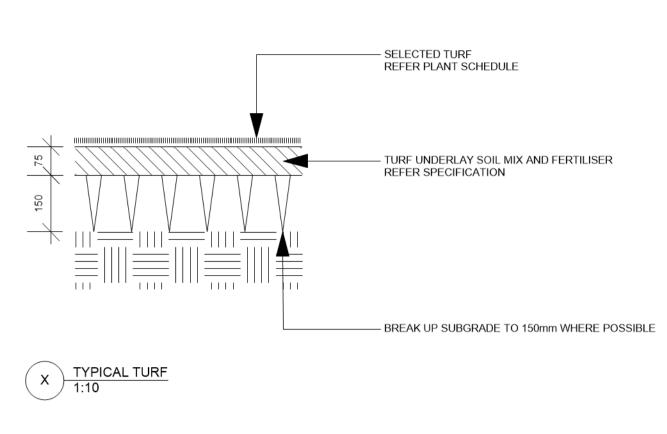
Drawing Title SECURITY FENCE PLAN 5


Date 04/12/2020

Scale 1:250


Project No. Sheet No. Revision No.

20203 LA-2-1005 H



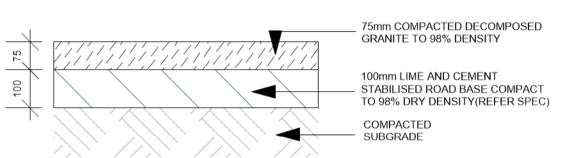

X TYPICAL DECOMPOSED GRANITE
1:10

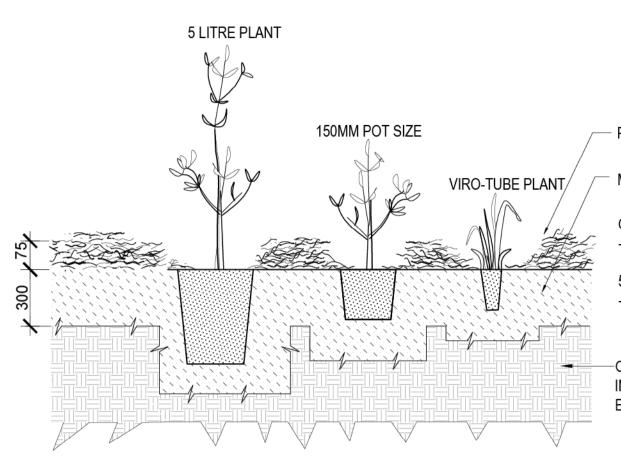

HARDWOOD STAKE - DO NOT PENETRATE ROOTBALL WITH

STAKE. STAKE TO PENETRATE 200MM MIN. INTO EXISTING

-NYLON/HESSIAN TIE WITH FIGURE EIGHT PATTEN

-45/75/100L CONTAINER TREE - REFER TO PLANTING

75 MM DEPTH ORGANIC PINE BARK MINI

CULTIVATED SUBGRADE 200MM DEPTH, ADD SOIL CONDITIONERS AS SPECIFIED

STAPLED TO STAKE

NUGGETS MULCH

PLACE 75MM THICK LAYER OF MULCH CLEAR OF PLANT STEM AND TAPER TO EDGE

MINIMUM OF 300MM OF ORGANIC SOIL MIX 'S4 GREEN LIFE'

- EXCAVATE 75MM DEEPER AND WIDER THAN PLANT CONTAINER


5 LITRE AND 150MM PLANTS
- EXCAVATE HOLES 100MM DEEPER AND WIDER THAN PLANT CONTAINER


-CULTIVATED SUBGRADE 150MM DEPTH, INCORPORATE GYPSUM WHERE CLAY IS ENCOUNTERED AT A RATE OF 1.5KG/M3

TYPICAL CONCRETE S

PLANTING REFER TO PLANTING PLANS

LS-4000 SERIES

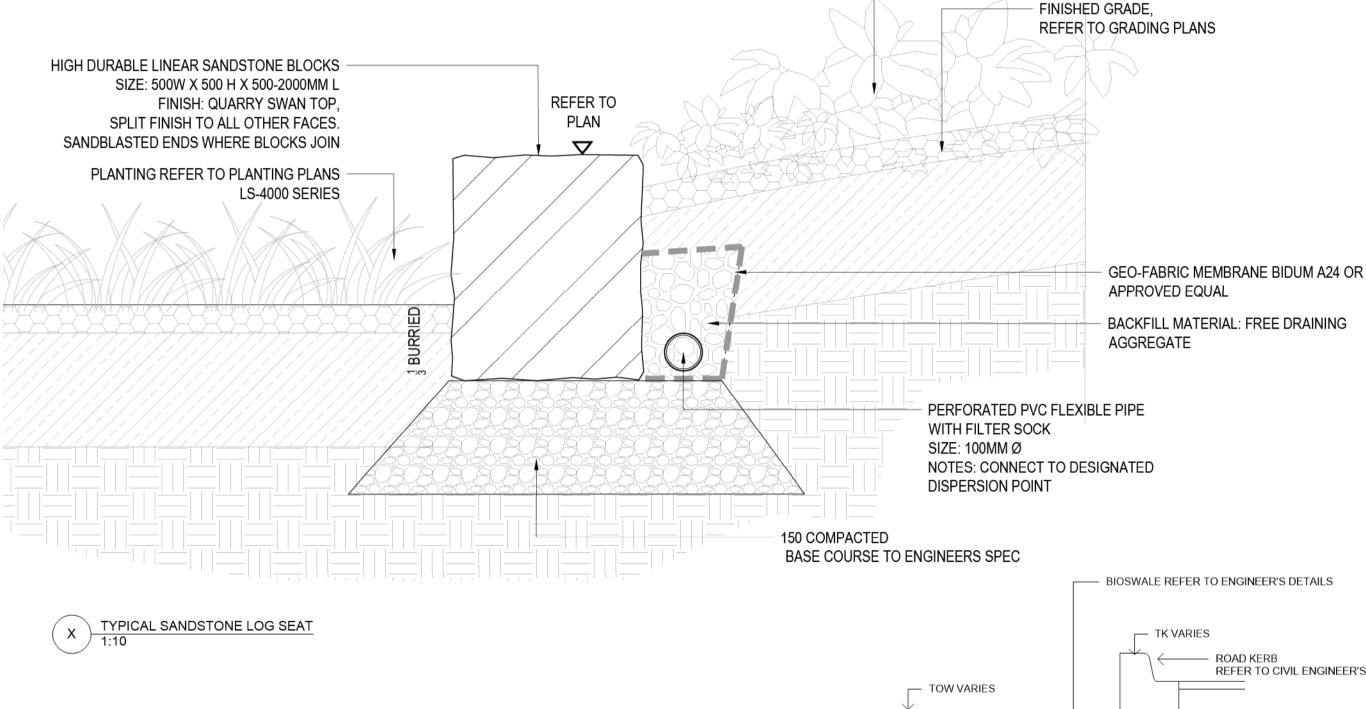

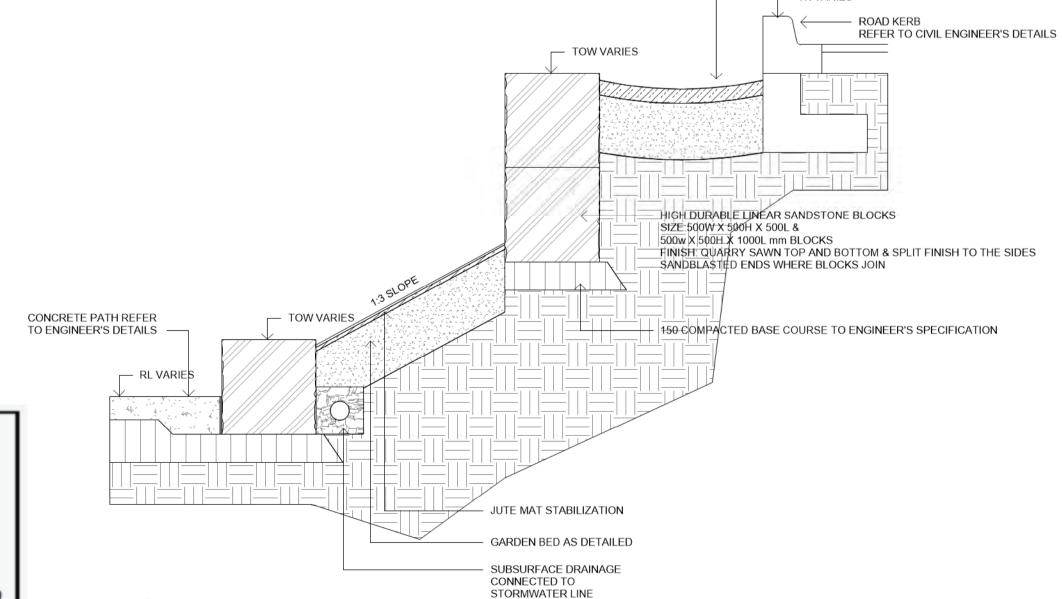

TYPICAL SANDSTONE LOG RETAINING WALL

NOTE: TREE PLANTING HOLE DIMENSIONS ACCORDING TO CONTAINER SIZE: WIDTH MIN. 2X ROOT BALL DIAMETER (MIN. 820 / 1100 / 1400MM FOR 45/75/100L CONTAINERS) AND DEPTH MIN. 1.5X ROOT BALL HEIGHT (MIN. 615/825/1050MM FOR 45/75/100L CONTAINERS)



ENSURE THAT 50MM AG PIPE OPENING IS

AG LINE NOT TO BE USED FOR WATERING

MASS PLANTING WHERE SHOWN IN PLAN.

KEEP MULCHING CLEAR OF PLANT STEM

ORGANIC SOIL MIX 'S4 GREEN LIFE'-

SOIL MIX TYPE BARANGAROO C

REFER TO PLANTING PLAN AND SCHEDULE

100MM ABOVE MULCH SURFACE.

ENDS TO REMAIN OPEN.





No.	Date	Description	Chkd
Α	14/06/2019	PRELIMINARY	JH, AW
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Client SCHOOL INFRASTRUCTURE NSW

Drawing Title


LANDSCAPE DETAILS

Date 04/12/2020
Scale AS SHOWN

ct No. Sheet No. F

20203 LA-2-2000 F



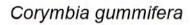



Banksia spinulosa



Hibbertia scandens



Ficinia nodosa



Lomandra 'Tanika'



Eucalyptus punctata



Callistemon 'Better John'



Anigozanthos 'Ruby Velvet'



Juncus usitatus



Pennisetum alopecuroides



Grevillea juniperus ' Gold Cluster'

Hardenbergia violacea

Carex appressa

Lomandra longifolia



Anigozanthos 'Gold Velvet'



Lomandra 'Hystix'



Themeda australis



ID	Botanical Name	Scheduled Size
Trees		
CG	Corymbia gummifera	100L
EP	Eucalyptus punctata	100L
Shrubs		
BS	Banksia spinulosa	200mm
CBJ	Callistemon 'Better John'	200mm
GJ	Grevillea juniperus 'Gold Cluster	200mm
Ground Covers		
HV	Hardenbergia violacea	200mm
HS	Hibbertia scandens	200mm
Grasses		
ARV	Anigozanthos 'Ruby Velvet'	200mm
AGV	Anigozanthus 'Gold Velvet'	200mm
CAA	Carex appressa	150mm
FN	Ficinia nodosa	150mm
JU	Juncus usitatus	150mm
LH	Lomandra 'Hystrix'	200mm
LOL	Lomandra longifolia	200mm
LT	Lomandra 'Tanika'	150mm
PA	Pennisetum alopecuroides	150mm
PLE	Poa labillardieri 'Eskerdale'	150mm
TA	Themeda australis	150mm
Total		

1,294m2 TURF APPROX. 1,294 TURF ROLL SPECIES: Zoysia 'Empire'

Planning, Industry & Environment

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Sheet no: 20 of 22 Signed

Approved Section: 4.55(1A) Application no: SSD 8114-MOD-2

Granted on: 12 March 2021

No.	Date	Description	Chko
Α	14/06/2019	PRELIMINARY	JH, A
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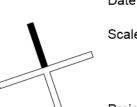
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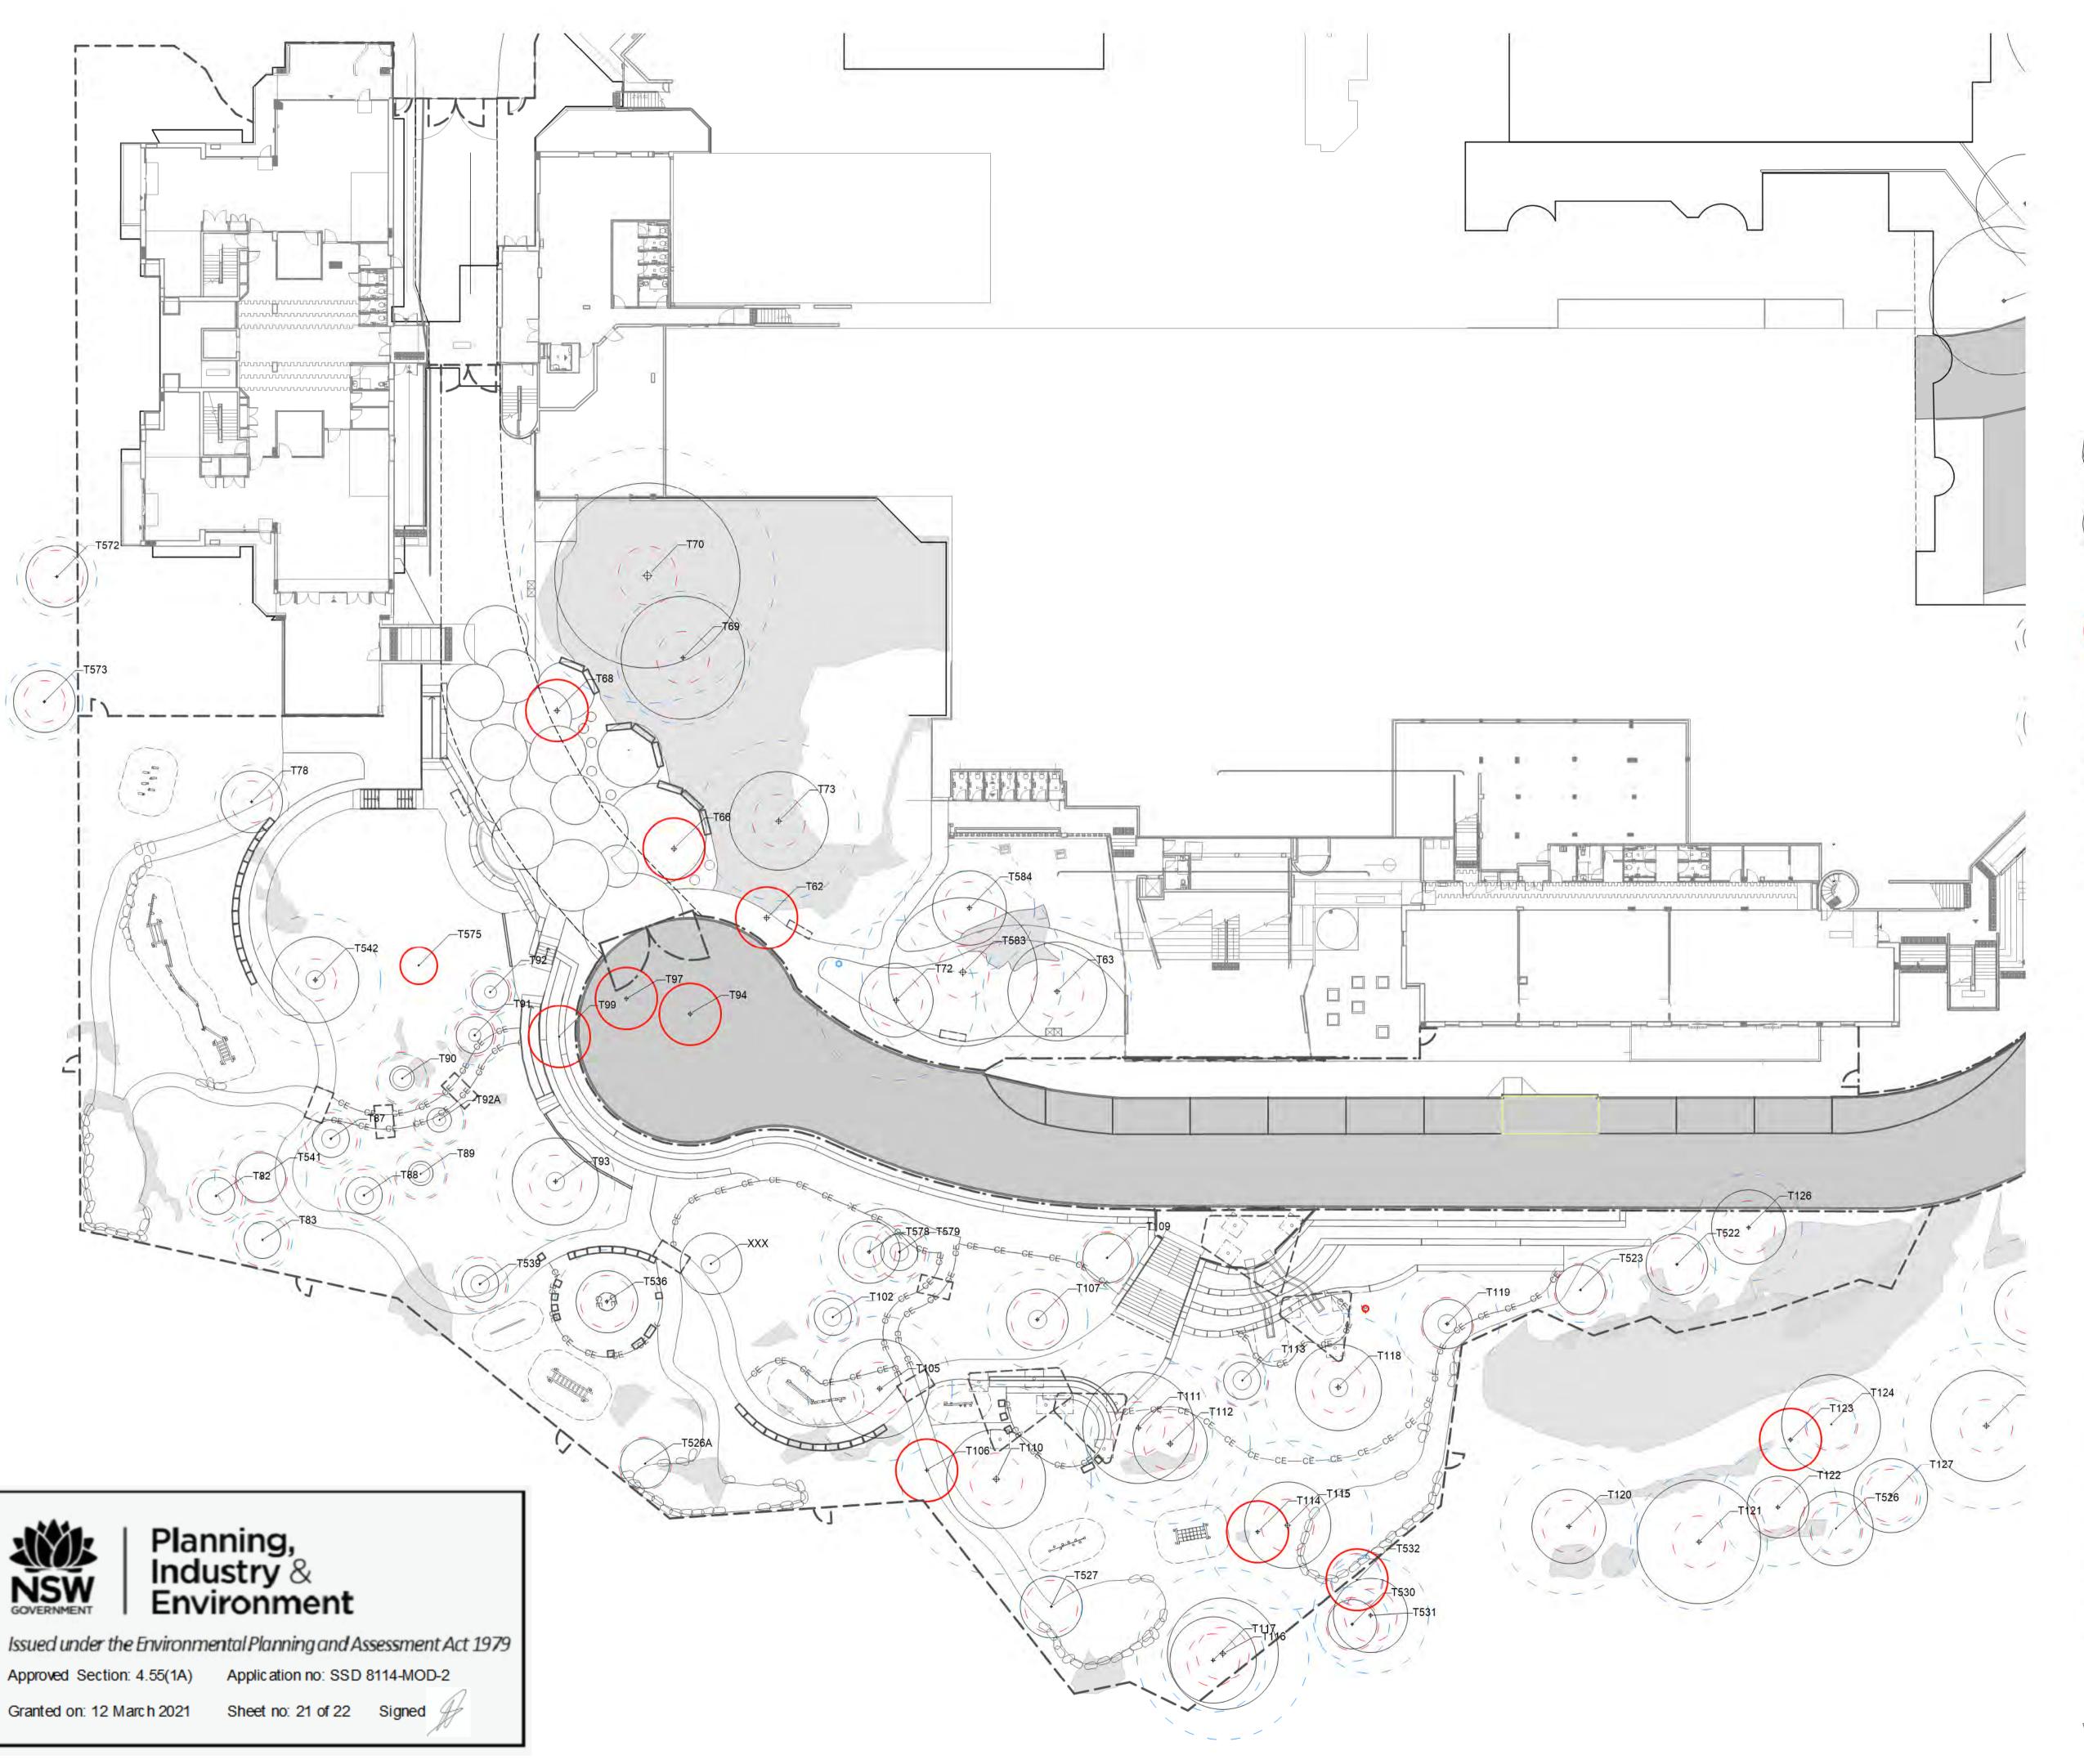
Drawing Title PLANTING PALETTE

Date 04/12/2020



Scale NTS


20203 LA-2-3000 F











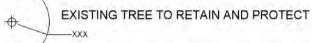

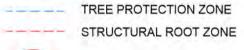

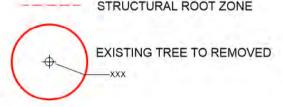

NOTE

Tree information (numbering, TPZ and SRZ) matches reports prepared by McArdle Arboricultural Consultancy.

Report 1: Arboricultural Impact and Tree Risk Assessment -17th of April, 2020 Report 2: Addendum Arboricultural Impact Assement - 22nd of May, 2020

Tree Codes:

T000 - refers to trees numbered in Report 1 A000 - refers to trees numbered Report 2 XXX - Unidentified specimen

	10000			
No.	Date	Description	Chko	
Α	26/08/2020	SS DA	DH	
В	04/12/2020	SS DA	BR	

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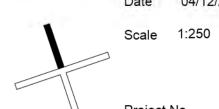
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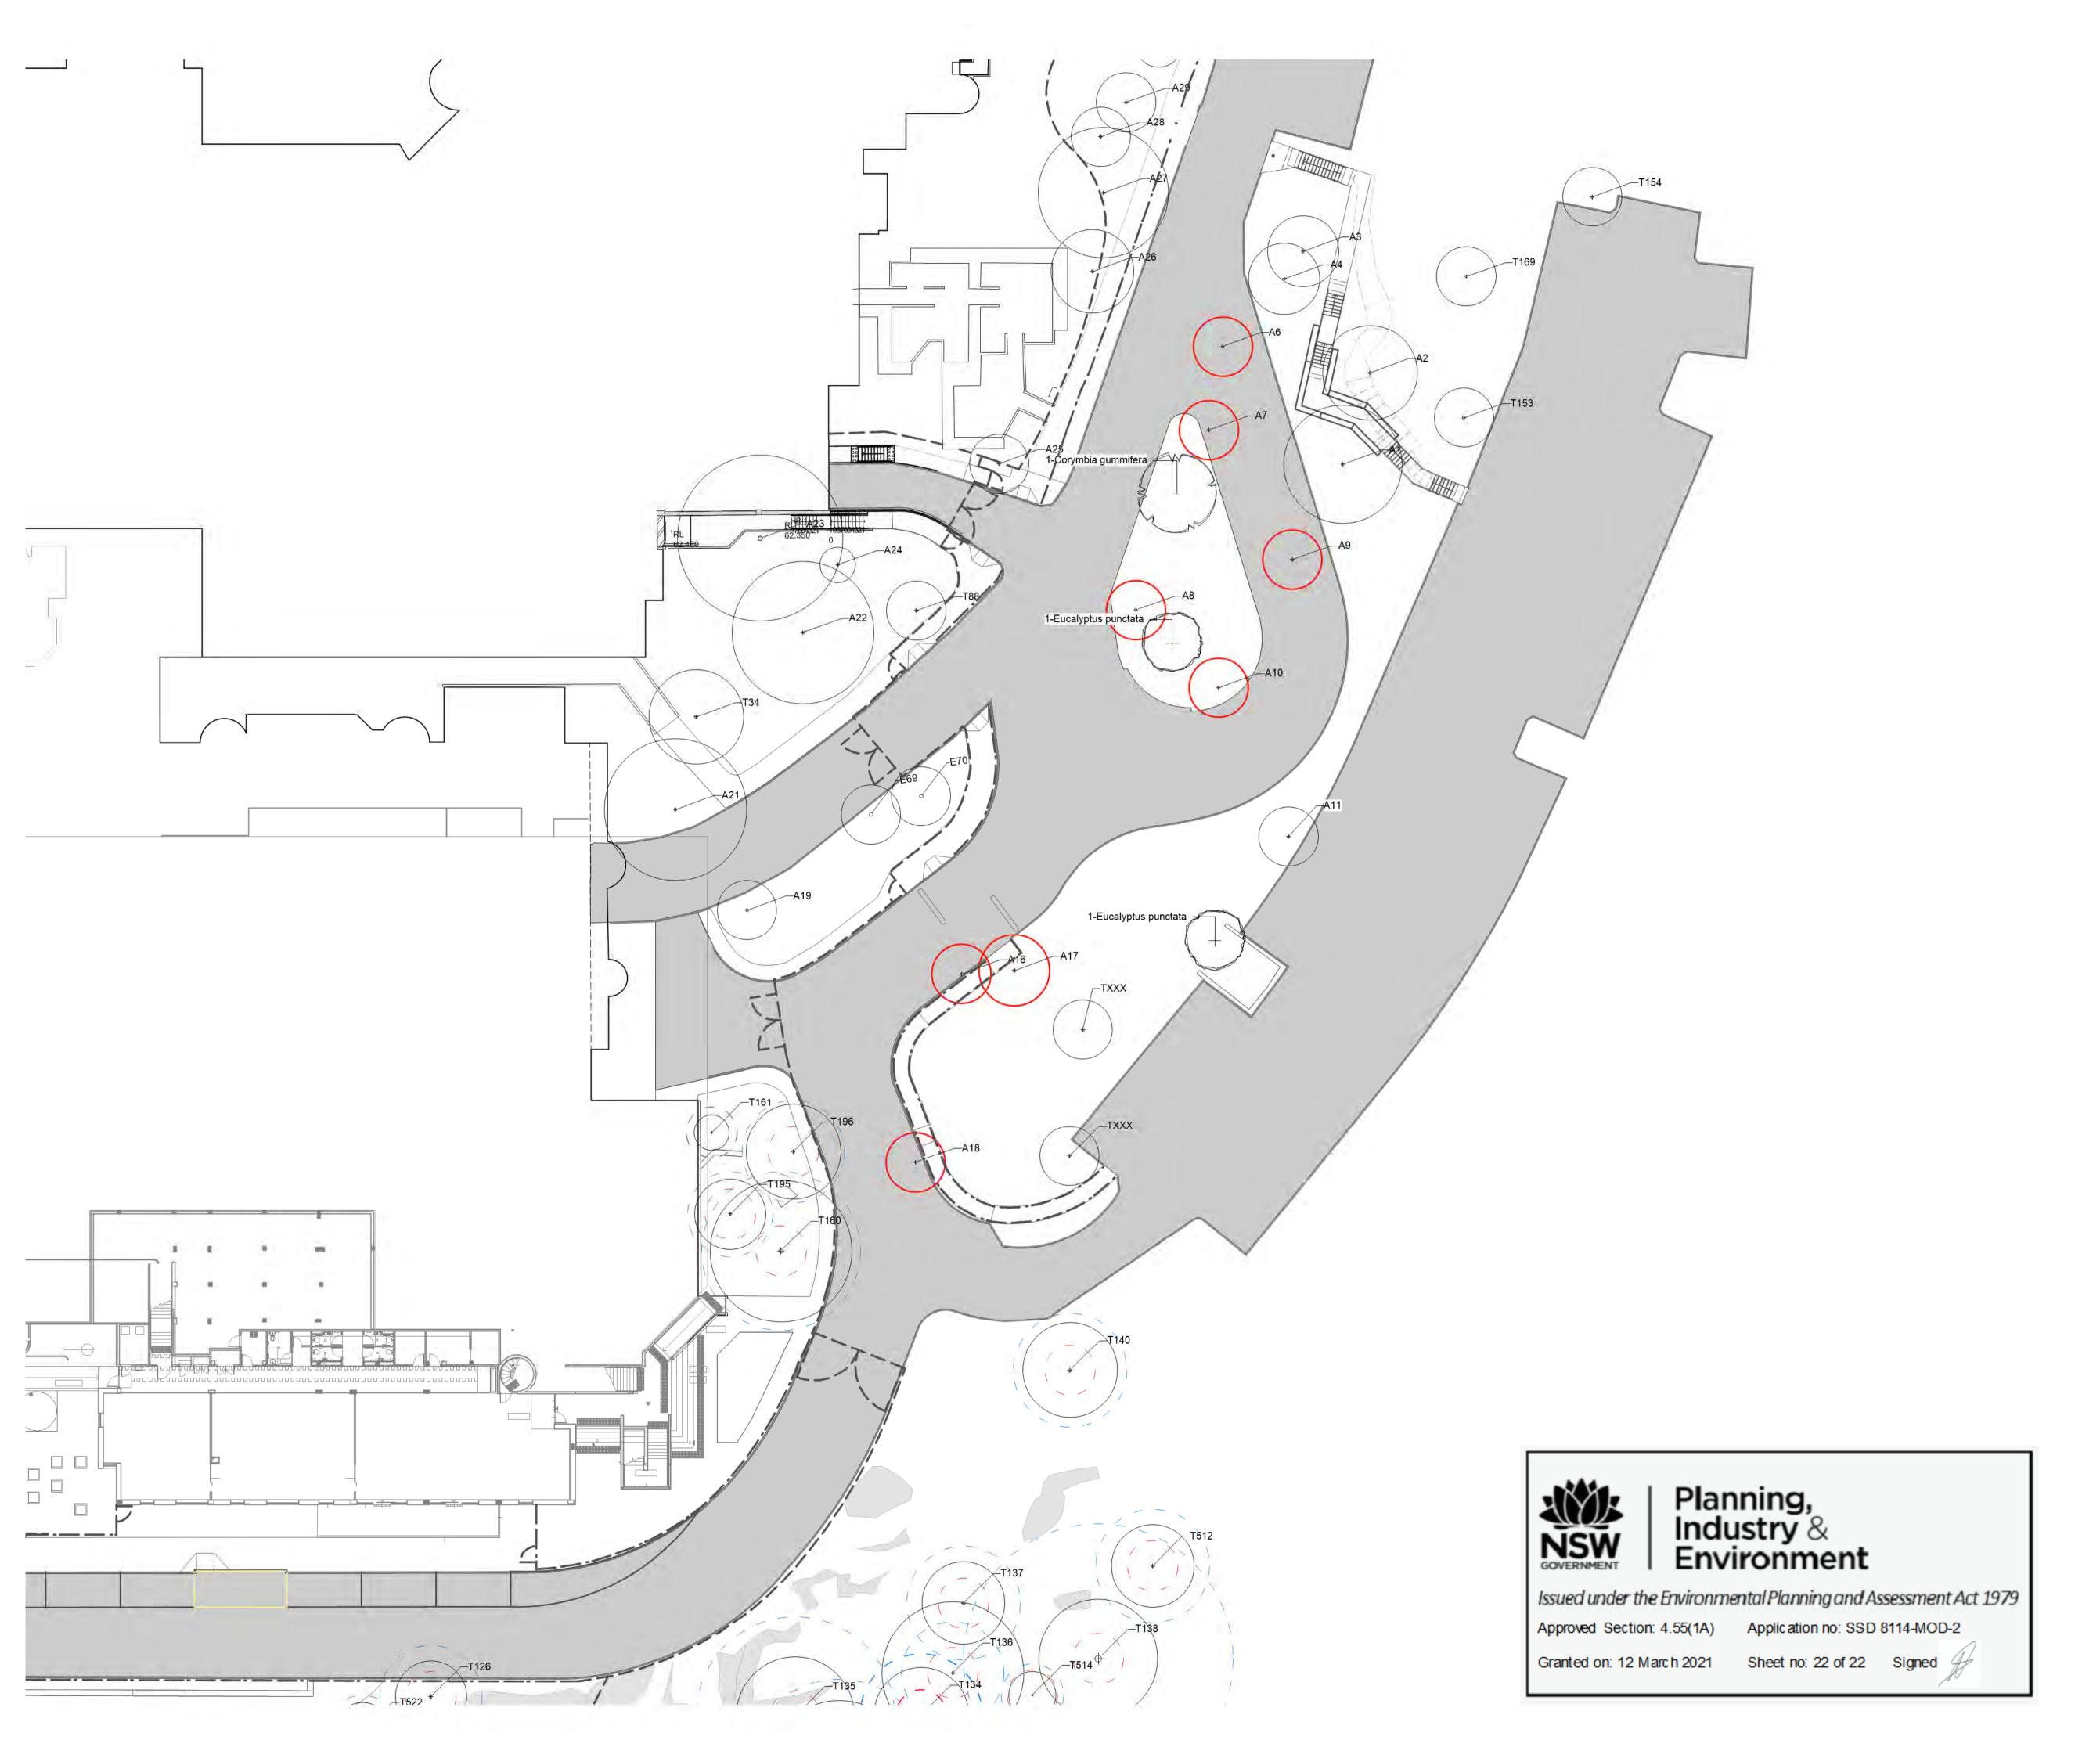
SCHOOL INFRASTRUCTURE NSW

Drawing Title TREE LOCATION PLAN 1

Date 04/12/2020



20203 LA-2-4001 B










PROPOSED TREE

TREE PROTECTION ZONE



EXISTING TREE TO RETAIN AND PROTECT

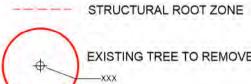

EXISTING TREE TO REMOVED



Tree information (numbering, TPZ and SRZ) matches reports prepared by McArdle Arboricultural Consultancy.

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Project Lindfield Learning Centre

ETON ROAD, LINDFIELD NSW

SCHOOL INFRASTRUCTURE NSW

Drawing Title

TREE LOCATION PLAN 2

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