JORDAN SPRINGS PUBLIC SCHOOL JORDAN SPRINGS, NSW



	DRAWING LIST - DET	FAILED DESIG	N		
Sheet Number	Sheet Name	Scale	Current Revision	Current Revision Date	Discipline
	CHOCK HALLIC	Court	1101101011	Canonic Novicion Bate	
	GENERAL INFORMATION				
0000	COVER SHEET / DRAWINGS INDEX	1:100	E	31.05.2019	ARCHITECTUR
100- 1199 - SITE PLAN	PROPOSED CITE AND POOF DIAM			Ta., aa., aa., a	ABOUNTEOTIN
1100	PROPOSED SITE AND ROOF PLAN	1:500	G	31.05.2019	ARCHITECTUR
1101	EXISTING SITE PLAN	1:500	A	31.05.2019	ARCHITECTUR
1110	BUILDING COMPLEX GROUND FLOOR PLAN	1:300	В	31.05.2019	ARCHITECTUR ARCHITECTUR
1112	BUILDING COMPLEX FIRST FLOOR PLAN BUILDING COMPLEX ROOF PLAN	1:300	B B	31.05.2019	ARCHITECTUR
		1:300		31.05.2019	
1120	SITE PLAN - SHADOW - DEC	1:1000	A	31.05.2019	ARCHITECTUR
1121	SITE PLAN - SHADOW - JUNE	1:1000	A	31.05.2019	ARCHITECTUR
000 - 2099 - GENERAL A	RRANGEMENT PLANS				
2000	FLOOR PLAN - GF - BLOCK C - PART 1	1:100	Н	31.05.2019	ARCHITECTUR
2001	FLOOR PLAN - GF - BLOCK A - PART 2	1:100	Н	31.05.2019	ARCHITECTUR
2002	FLOOR PLAN - GF - BLOCK B1 - PART 3	1:100	E	31.05.2019	ARCHITECTUR
2003	FLOOR PLAN - GF - BLOCK B2 - PART 4	1:100	E	31.05.2019	ARCHITECTUR
2004	FLOOR PLAN - GF - BLOCK B3 - PART 5	1:100	E	31.05.2019	ARCHITECTUR
2011	FLOOR PLAN - L1 - BLOCK A - PART 2	1:100	Н	31.05.2019	ARCHITECTUR
2012	FLOOR PLAN - L1 - BLOCK B1 - PART 3	1:100	E	31.05.2019	ARCHITECTUR
2013	FLOOR PLAN - L1 - BLOCK B2 - PART 4	1:100	E	31.05.2019	ARCHITECTUR
2014	FLOOR PLAN - L1 - BLOCK B3 - PART 5	1:100	E	31.05.2019	ARCHITECTUR
2020	ROOF PLAN - BLOCK C - PART 1	1:100	E	31.05.2019	ARCHITECTUR
2021	ROOF PLAN - BLOCK A - PART 2	1:100	D	31.05.2019	ARCHITECTUR
2022	ROOF PLAN - BLOCK B1 - PART 3	1:100	С	31.05.2019	ARCHITECTUR
2023	ROOF PLAN - BLOCK B2 - PART 4	1:100	С	31.05.2019	ARCHITECTUR
2024	ROOF PLAN - BLOCK B3 - PART 5	1:100	С	31.05.2019	ARCHITECTUR
2030	ROOF PLAN - SCHOOL ENTRY	1:100	С	31.05.2019	ARCHITECTUF
2031	ROOF PLAN - COLA A	1:100	С	31.05.2019	ARCHITECTUF
2032	ROOF PLAN - COLA B	1:100	С	31.05.2019	ARCHITECTUF
2033	ROOF PLAN - COLA C	1:100	С	31.05.2019	ARCHITECTUR
2034	ROOF PLAN - COLA D	1:100	C	31.05.2019	ARCHITECTUR
2001	100.7541 005.15	1.100		31.03.2019	7410111120101
000 - 3099 - ELEVATION	S				
3000	BUILDING 'C' ELEVATIONS	1:100	E	31.05.2019	ARCHITECTUR
3001	BUILDING 'A' ELEVATIONS	1:100	E	31.05.2019	ARCHITECTUR
3002	BUILDING 'B1' ELEVATIONS	1:100	D	31.05.2019	ARCHITECTUR
3003	BUILDING 'B2' ELEVATIONS	1:100	D	31.05.2019	ARCHITECTUR
3004	BUILDING 'B3' ELEVATIONS	1:100	D	31.05.2019	ARCHITECTUR
3050	BUILDING 'A' SECTION-ELEVATIONS	1:100	А	31.05.2019	ARCHITECTU
3051	BUILDING 'B1' SECTION-ELEVATIONS	1:100	А	31.05.2019	ARCHITECTU
3052	BUILDING 'B2' SECTION-ELEVATIONS	1:100	A	31.05.2019	ARCHITECTU
3053	BUILDING 'B3' SECTION-ELEVATIONS	1:100	Α	31.05.2019	ARCHITECTU
100 - 3199 - SECTIONS	OFOTIONIC RECOVER			04.05.0046	ADOLUTEOTU
3100	SECTIONS - BLOCK C	1:100	В	31.05.2019	ARCHITECTU
3101	SECTIONS - BLOCK A	1:100	В	31.05.2019	ARCHITECTU
3102	SECTIONS - BLOCK B1	1:100	В	31.05.2019	ARCHITECTU
3103	SECTIONS - BLOCK B2	1:100	В	31.05.2019	ARCHITECTU
3104	SECTIONS - BLOCK B3	1:100	В	31.05.2019	ARCHITECTUR
3150	STREETSCAPE ELEVATION & SITE SECTIONS	1:300	Α	31.05.2019	ARCHITECTU

General Notes:

1. This drawing is the copyright of Group GSA Pty Ltd and may not be altered, reproduced or transmitted in any form or by any means in part or in whole without the written permission of Group GSA

2. Drawings to be printed in colour.

3. Do not scale drawings. Dimensions govern.

4. All dimensions are in millimetres unless noted otherwise.

5. All dimensions shall be verified on site before proceeding

6. Any areas indicated on this sheet are approximate and indicative only.

1		
Amend	ments	
Issue	Description	Date
ÅΑ	FOR COORDINATION	27.03.2019
' B	DRAFT DETAILED DESIGN	10.04.2019
c	DRAFT DETAILED DESIGN	17.04.2019
' D	PROGRESS ISSUE	10.05.2019
ËE	SSD SUBMISSION	31.05.2019





Group GSA Pty Ltd ABN 76 002 113 779 Level 7, 80 William St East Sydney NSW Australia 2011 www.groupgsa.com

T +612 9361 4144 F +612 9332 3458

architecture interior design urban design landscape nom architect M. Sheldon 3990

JORDAN SPRINGS

COVER SHEET / DRAWINGS INDEX

Drawing Created	(date)	10/05/19
Drawing Created	(by)	NS
Plotted and check	ked by	FC
Verified		MF
Approved		ME
Project No	Drawing No	Issue
1206/6	3 JS-AR-00)00 F



- ⁻ ∃ General Notes

1. This drawing is the copyright of Group GSA Pty Ltd and may not be altered, reproduced or transmitted in any form or by any means in part or in whole without the written permission of Group GSA

2. Drawings to be printed in colour.

3. Do not scale drawings. Dimensions govern.

4. All dimensions are in millimetres unless noted otherwise.

2. Drawings to be printed in colour.
3. Do not scale drawings. Dimensions govern.
4. All dimensions are in millimetres unless noted otherwise.
5. All dimensions shall be verified on site before proceeding.
6. Any areas indicated on this sheet are approximate and indicative only.

 Amendments

 Issue
 Description
 Date

 A
 FOR COORDINATION
 27.03.2019

 B
 PROGRESS ISSUE
 10.05.2019

 C
 VEHICULAR CROSSINGS INDICATED
 13.05.2019

 D
 PEDESTRIAN CROSSING ADDED
 16.05.2019

 E
 TRAFFIC ISLAND ADDED
 17.05.2019

 F
 GENERALLY AMENDED
 22.05.2019

 G
 SSD SUBMISSION
 31.05.2019

LEGEND

Site boundary

Line of bushfire defendable space

Existing neighbouring buildings

Main pedestrian entry

Vehicular entry

★ Administration Building entry

AD

ADMIN / LIBRARY / CANTEEN




TIOME BY ICE

NOTES

Refer to Landscape Architect's plans for planting and fencing locations.
 Refer to Civil Engineer's drawings for pavement

and retaining wall details.

Refer to Bushfire Report for details on defendable space requirements.

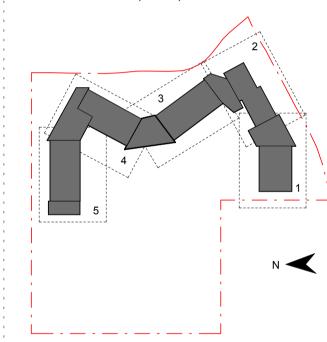

RICHARD CROOKES
CONSTRUCTIONS



Group GSA Pty Ltd ABN 76 002 113 779 Level 7, 80 William St East Sydney NSW Australia 2011

www.groupgsa.com T +612 9361 4144 F +612 9332 3458

architecture interior design urban design landscape nom architect M. Sheldon 3990


Project Title


JORDAN SPRINGS PUBLIC SCHOOL


Drawing Title

PROPOSED SITE AND ROOF PLAN

01- @ 44		4 - 500
Scale @ A1		1:500
Drawing Created (da	te)	30/05/2019
Drawing Created (by)	DN
Plotted and checked	by	DN
Verified		JS ≥
Approved		MB 5:47 F
Project No	Drawing No	lssue 6
180646	JS-AR-110	MB energy and market a

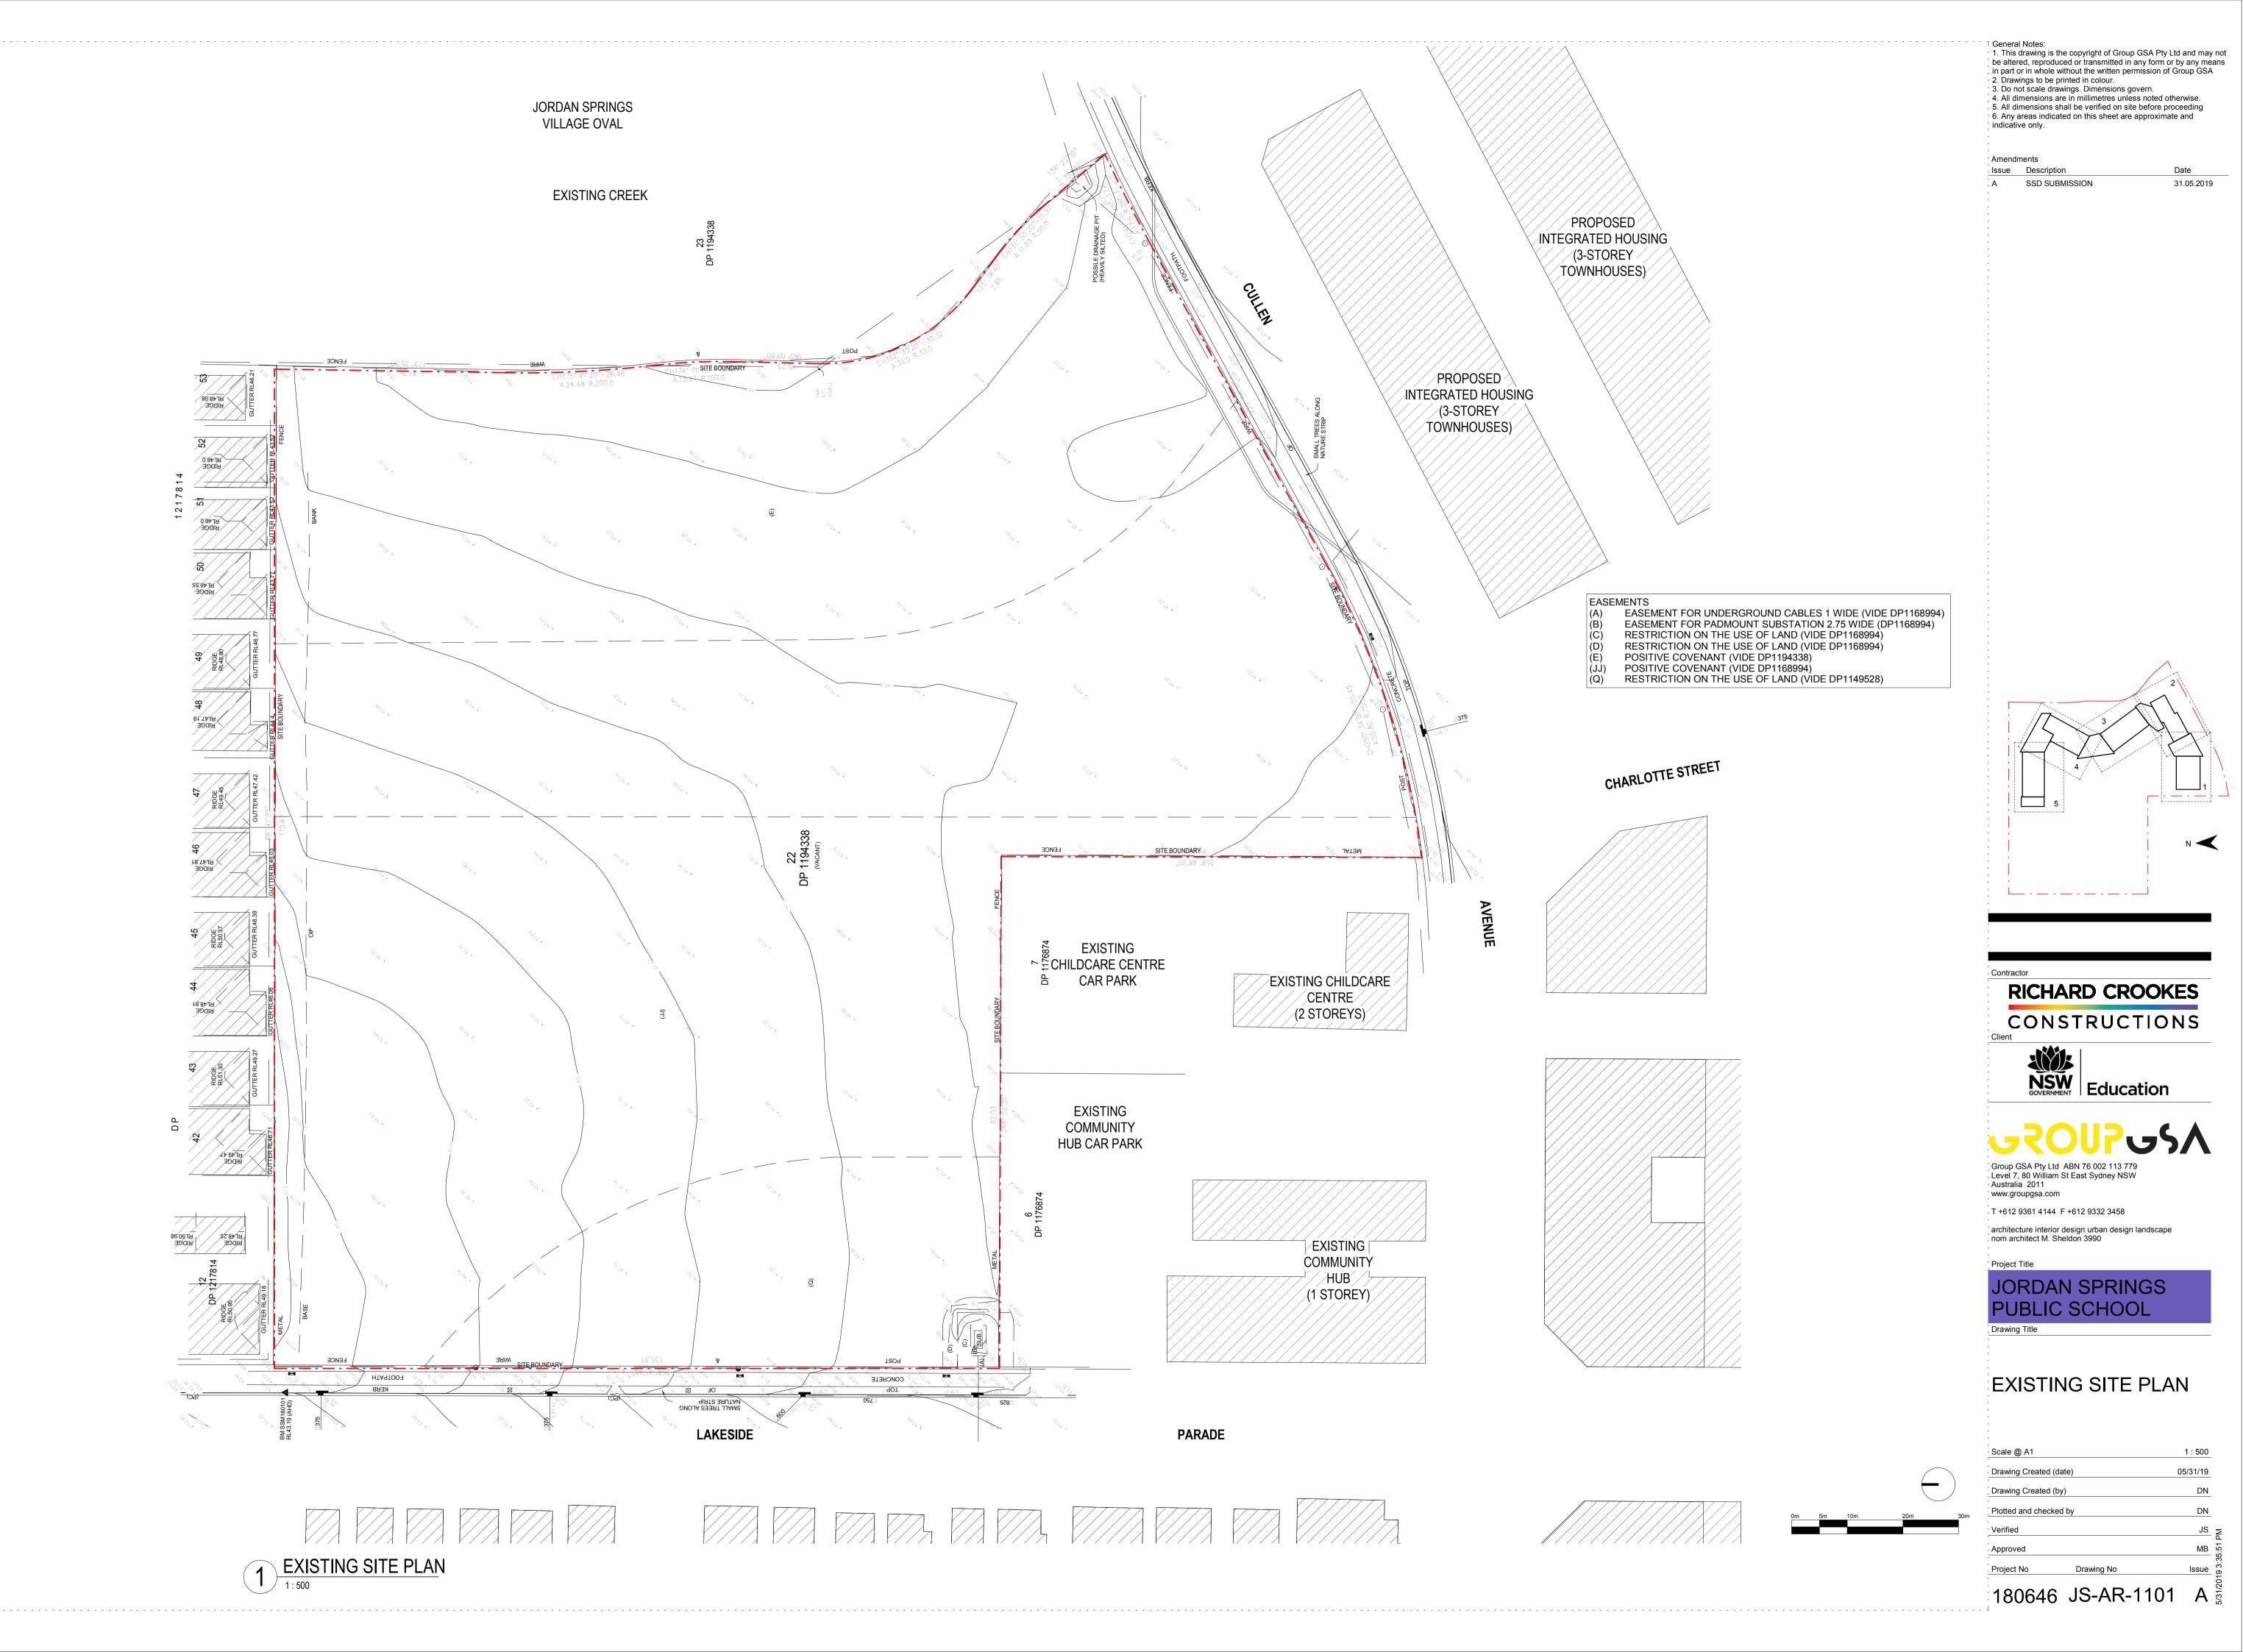

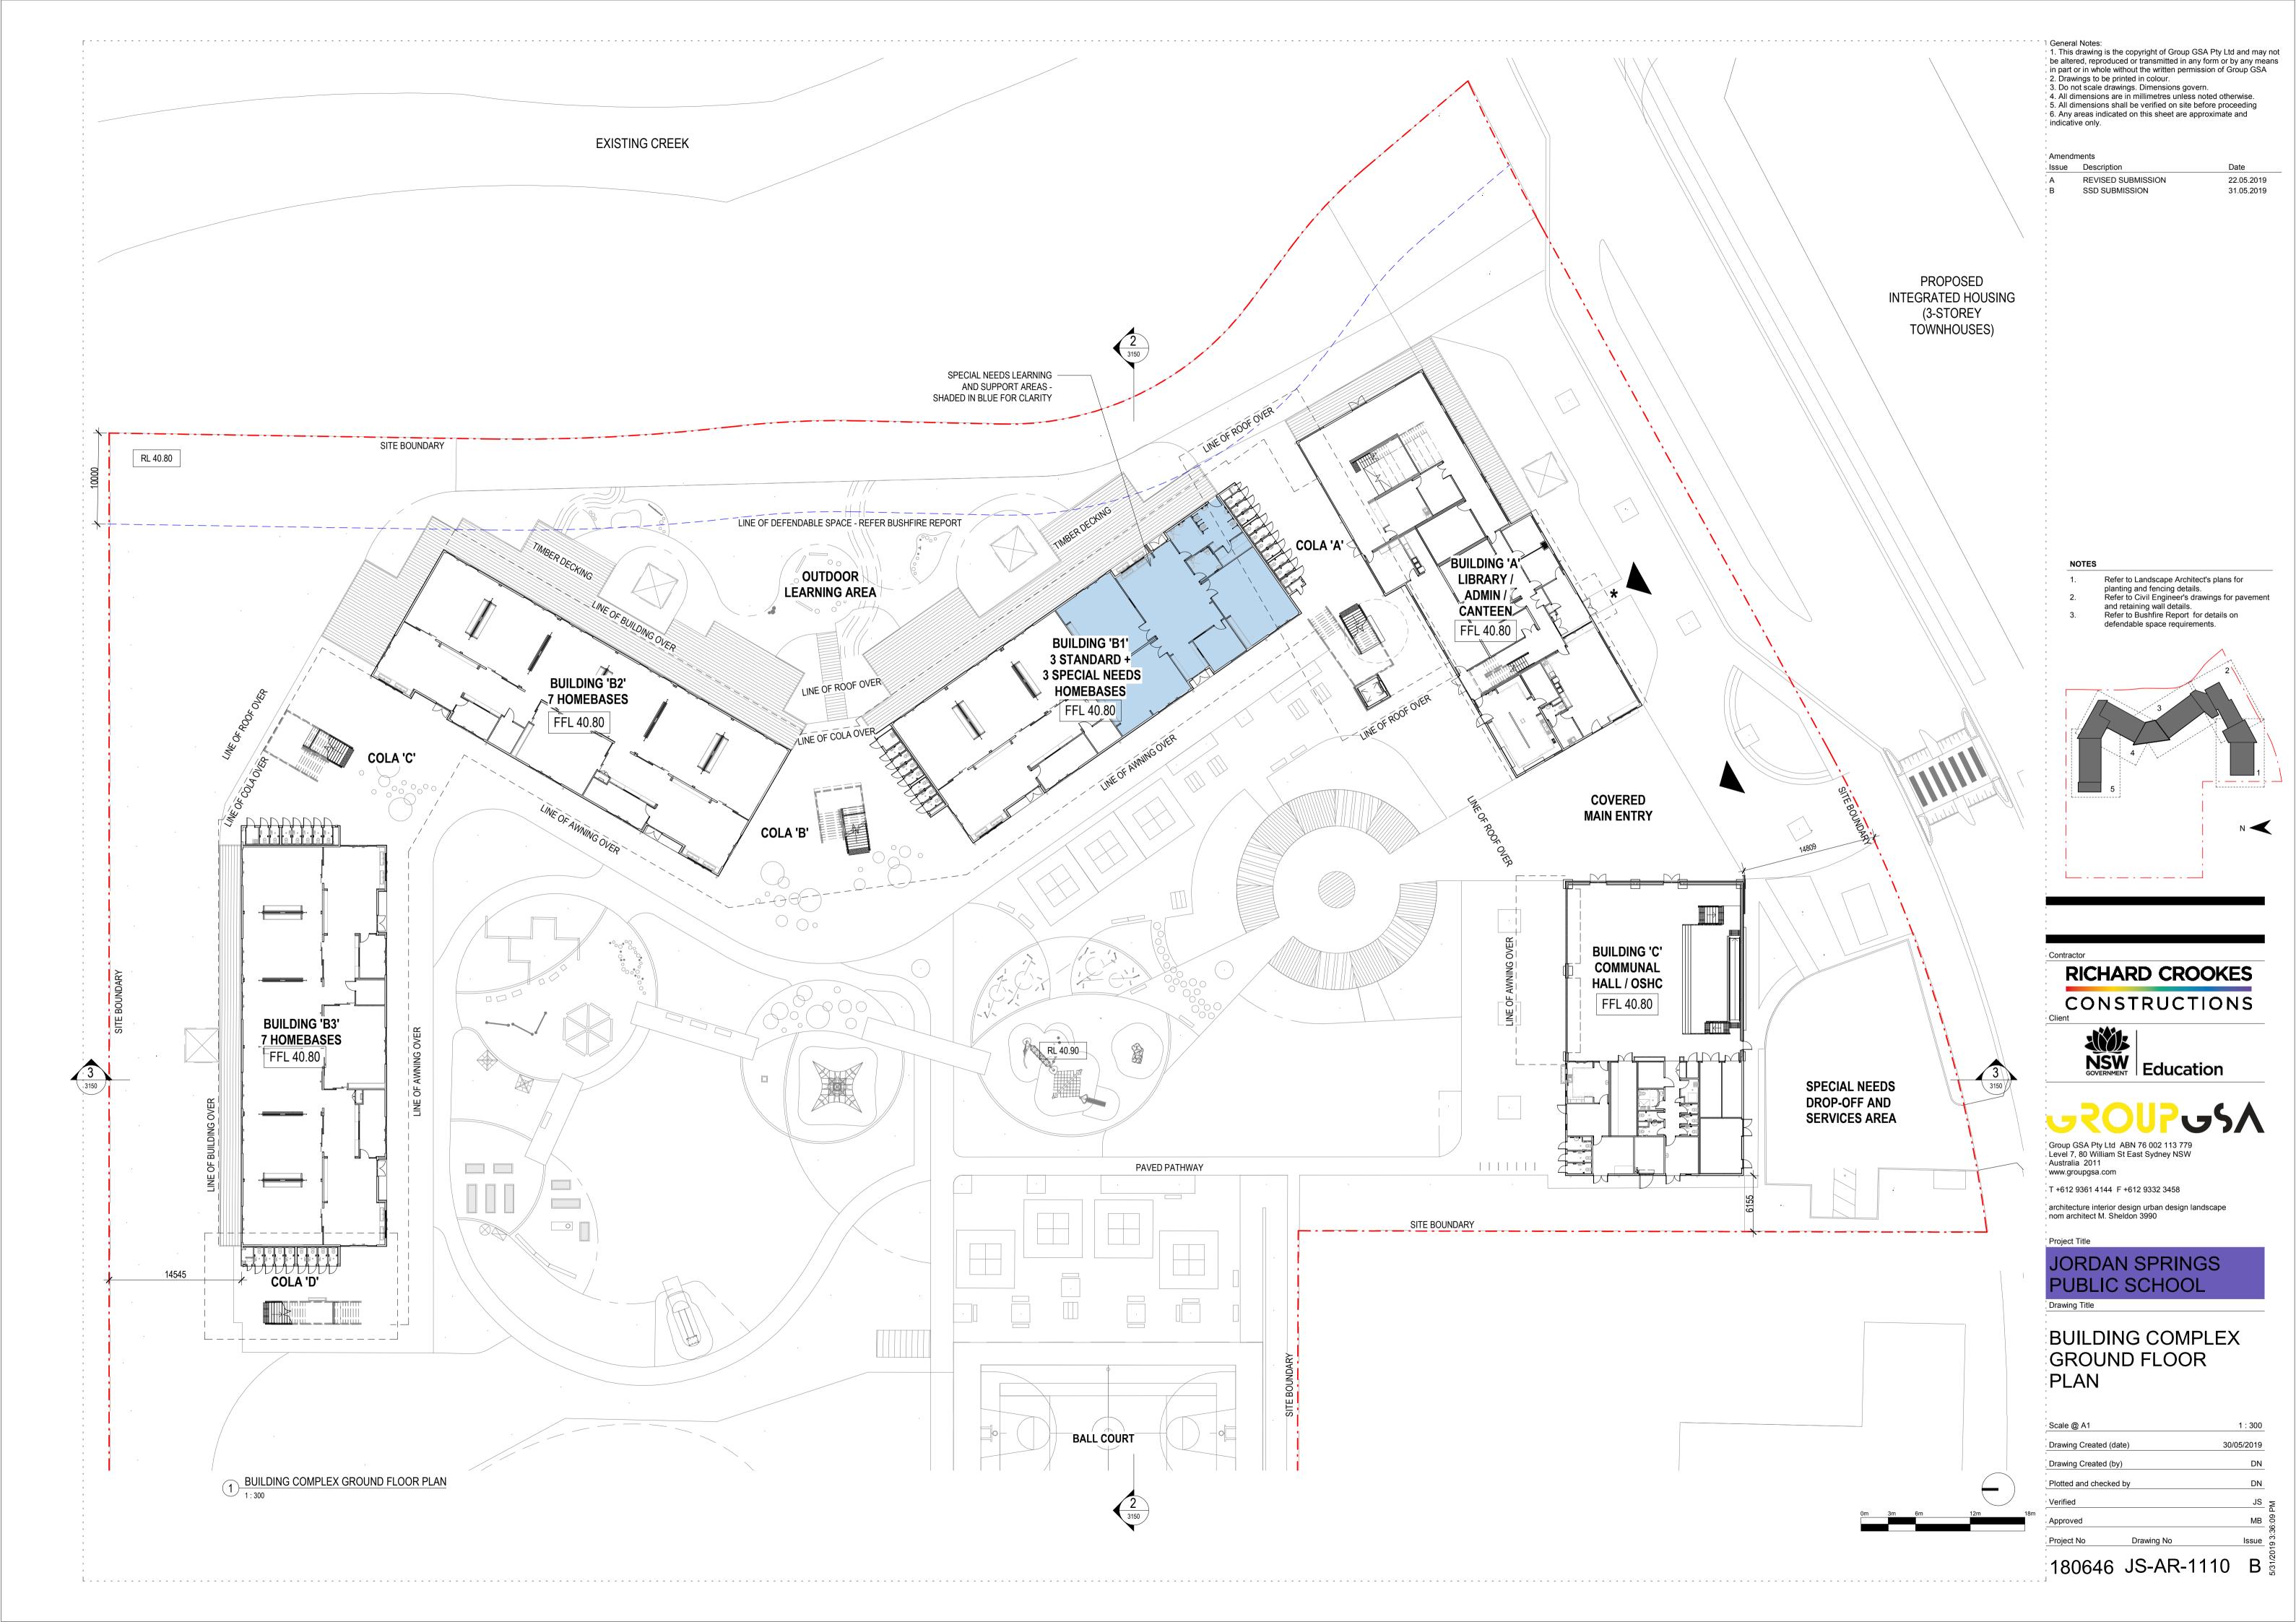

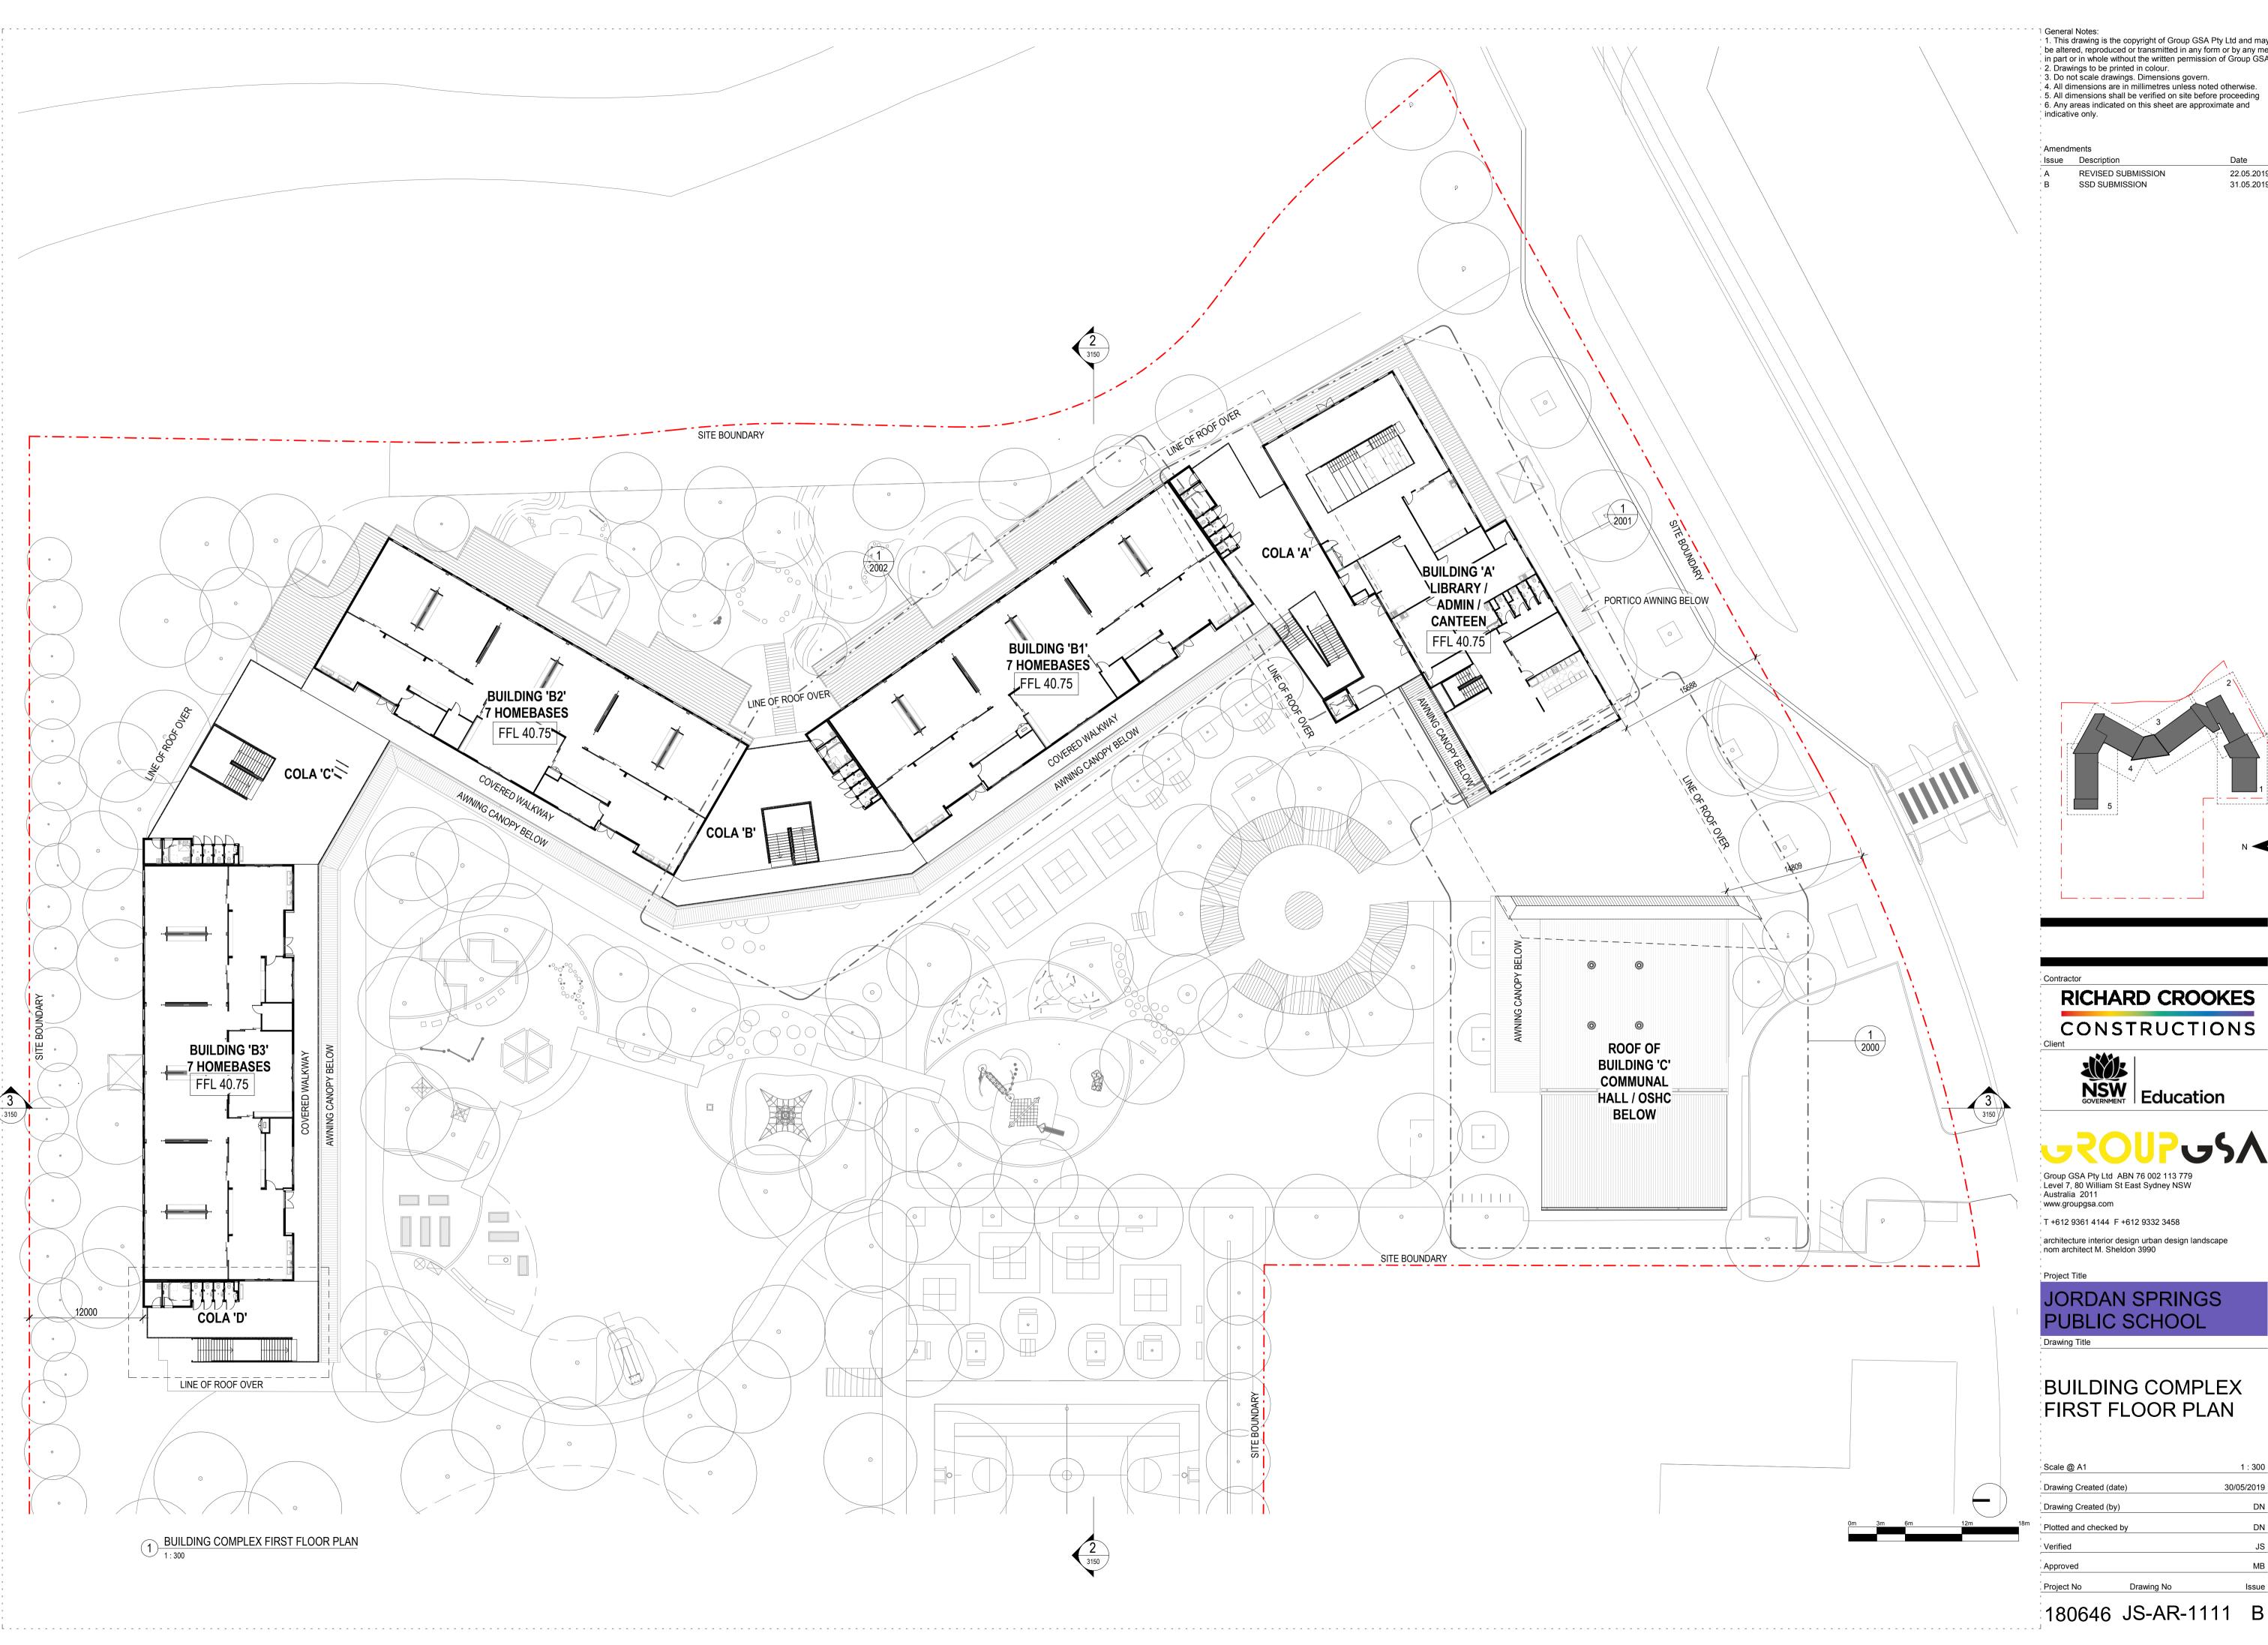

1. This drawing is the copyright of Group GSA Pty Ltd and may not be altered, reproduced or transmitted in any form or by any means in part or in whole without the written permission of Group GSA

2. Drawings to be printed in colour.3. Do not scale drawings. Dimensions govern.4. All dimensions are in millimetres unless noted otherwise.

REVISED SUBMISSION 22.05.2019 SSD SUBMISSION 31.05.2019

> RICHARD CROOKES CONSTRUCTIONS




architecture interior design urban design landscape nom architect M. Sheldon 3990


JORDAN SPRINGS PUBLIC SCHOOL

BUILDING COMPLEX FIRST FLOOR PLAN


1:300 Drawing Created (date) 30/05/2019 Plotted and checked by

180646 JS-AR-1111 B

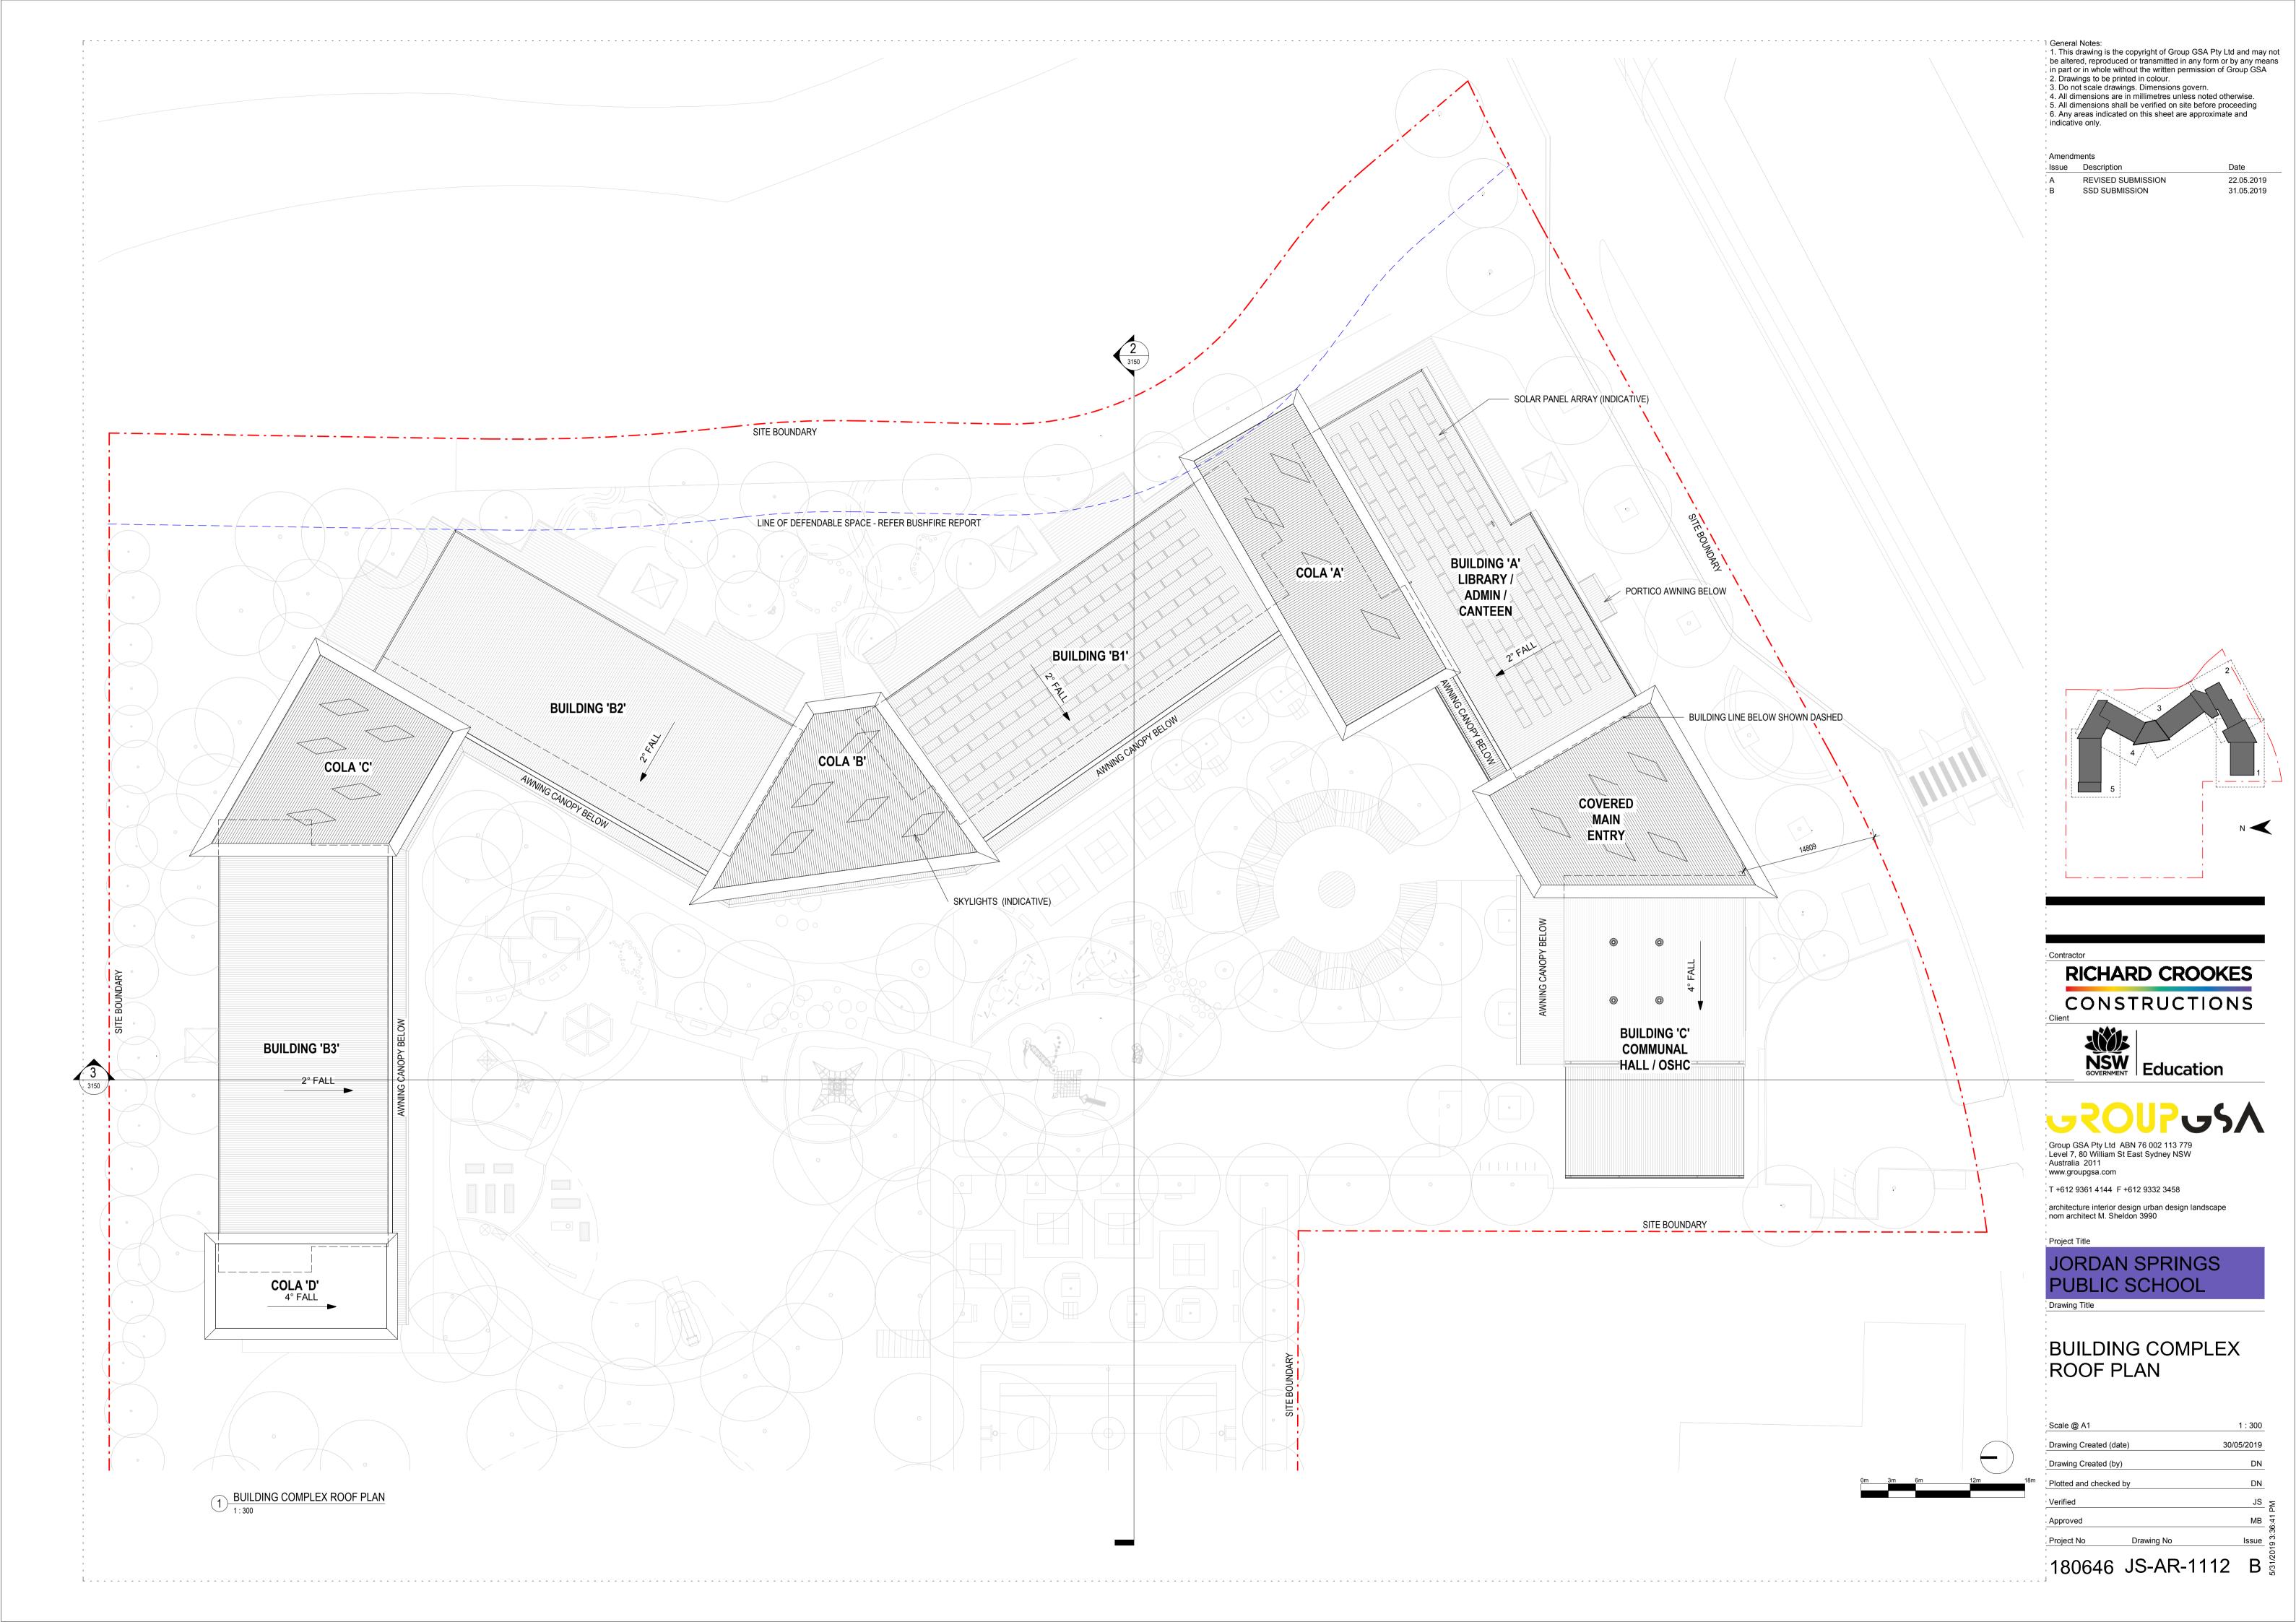

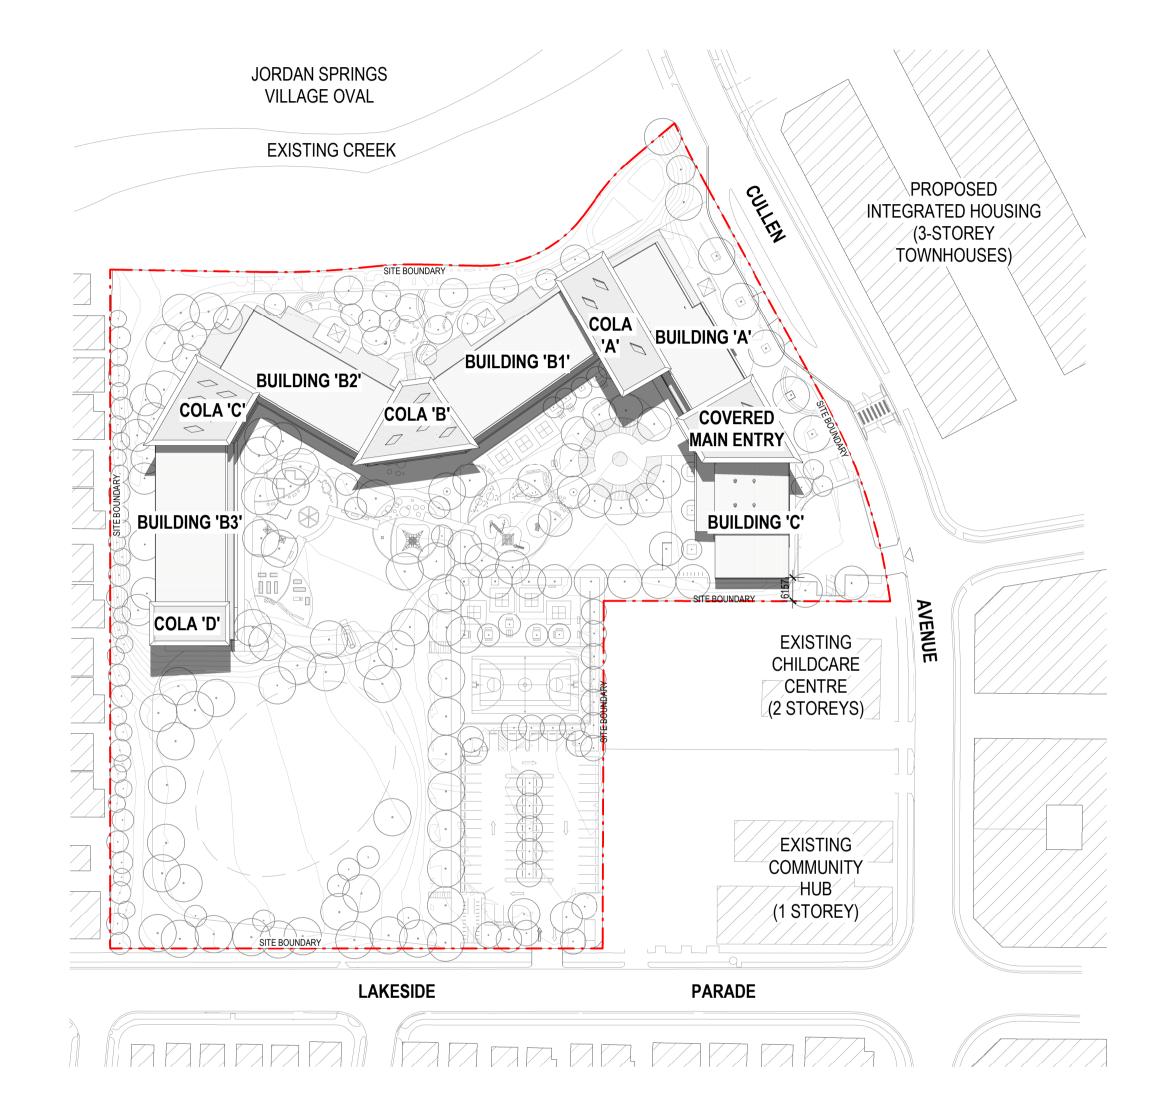

1 SHADOW DIAGRAM - 9AM, 22 DECEMBER

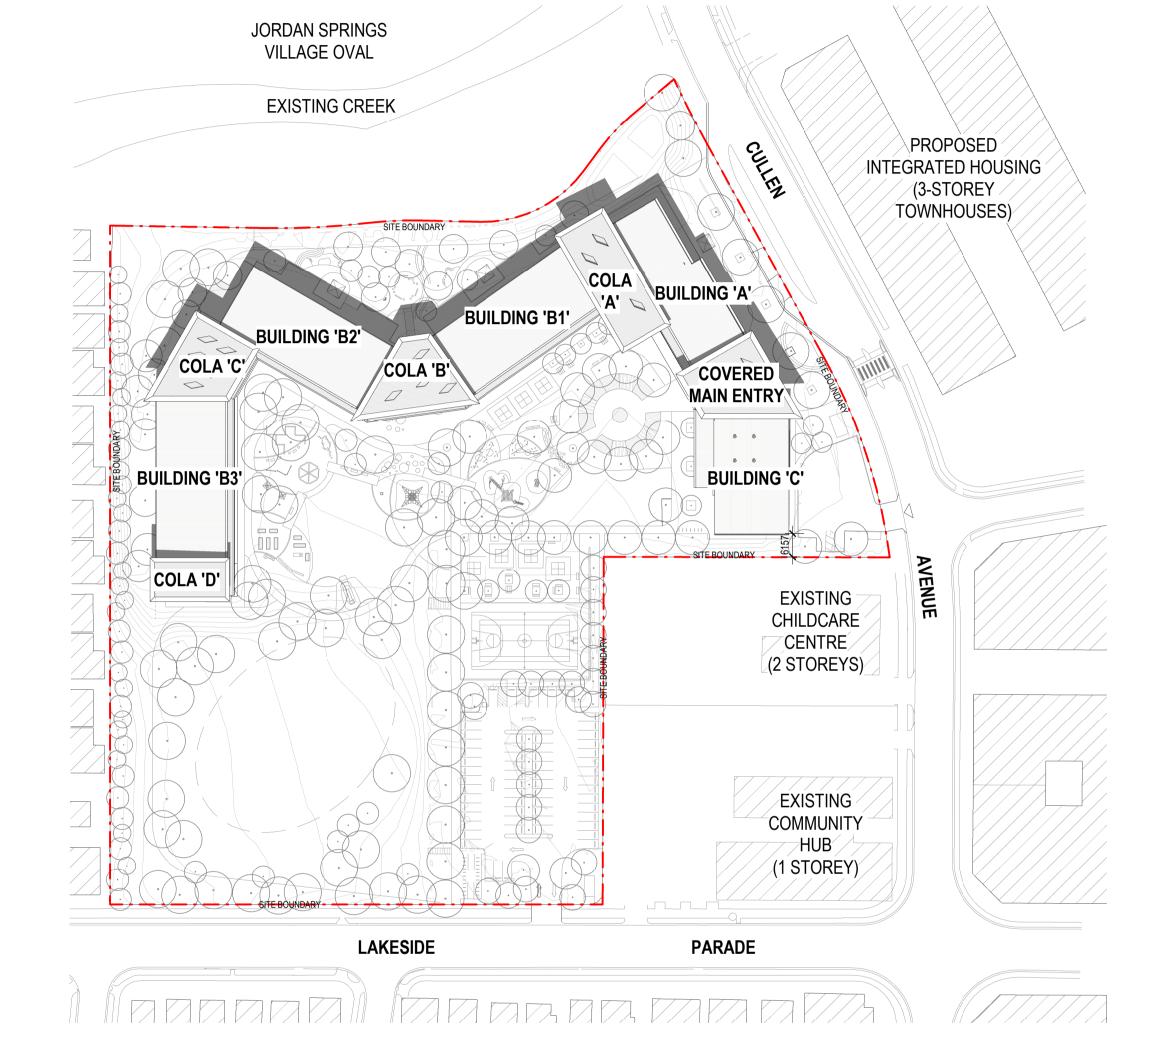

2 SHADOW DIAGRAM - 3PM, 22 DECEMBER


☐ ☐ General Notes:

- 1. This drawing is the copyright of Group GSA Pty Ltd and may not be altered, reproduced or transmitted in any form or by any means in part or in whole without the written permission of Group GSA 2. Drawings to be printed in colour.
 3. Do not scale drawings. Dimensions govern.
 4. All dimensions are in millimetres unless noted otherwise.
- 3. Do not scale drawings. Dimensions govern.
 4. All dimensions are in millimetres unless noted otherwise.
 5. All dimensions shall be verified on site before proceeding
 6. Any areas indicated on this sheet are approximate and indicative only.

Amendments

Issue Description Date

A SSD SUBMISSION 31.05.2019

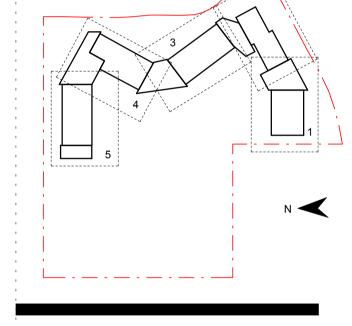

RICHARD CROOKES
CONSTRUCTIONS



Group GSA Pty Ltd ABN 76 002 113 779 Level 7, 80 William St East Sydney NSW Australia 2011

www.groupgsa.com T +612 9361 4144 F +612 9332 3458

architecture interior design urban design landscape nom architect M. Sheldon 3990

Project Title

JORDAN SPRINGS PUBLIC SCHOOL

SITE PLAN - SHADOW - DEC

Scale @ A1 1 : 1000

Drawing Created (date) 05/31/19

Drawing Created (by) LO


Plotted and checked by FT

Verified JS

Approved MB


Project No Drawing No Issue

180646 JS-AR-1120 A

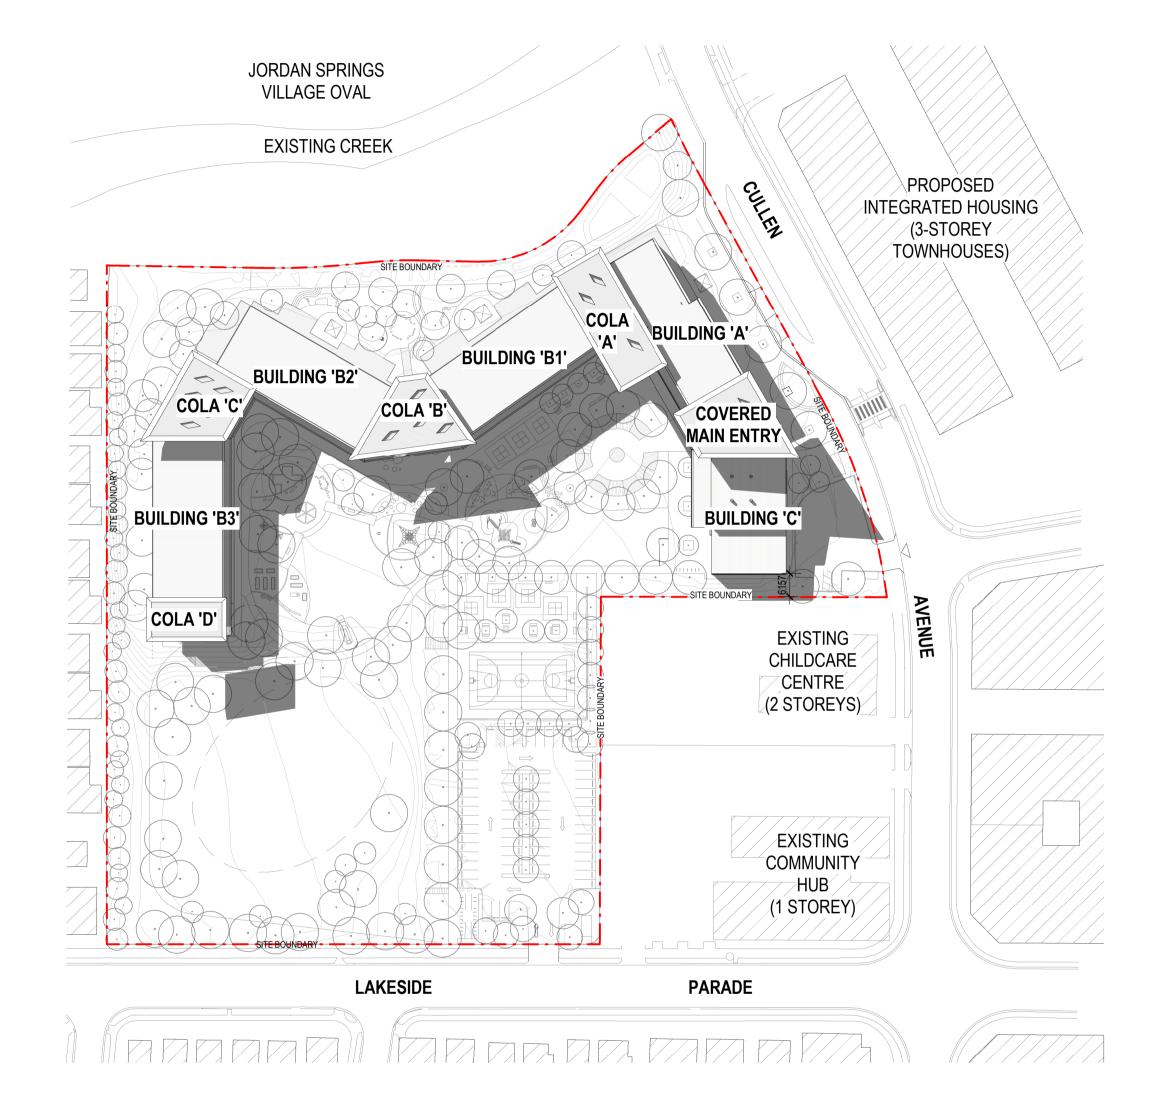

2 SHADOW DIAGRAM - 9AM, 21 JUNE



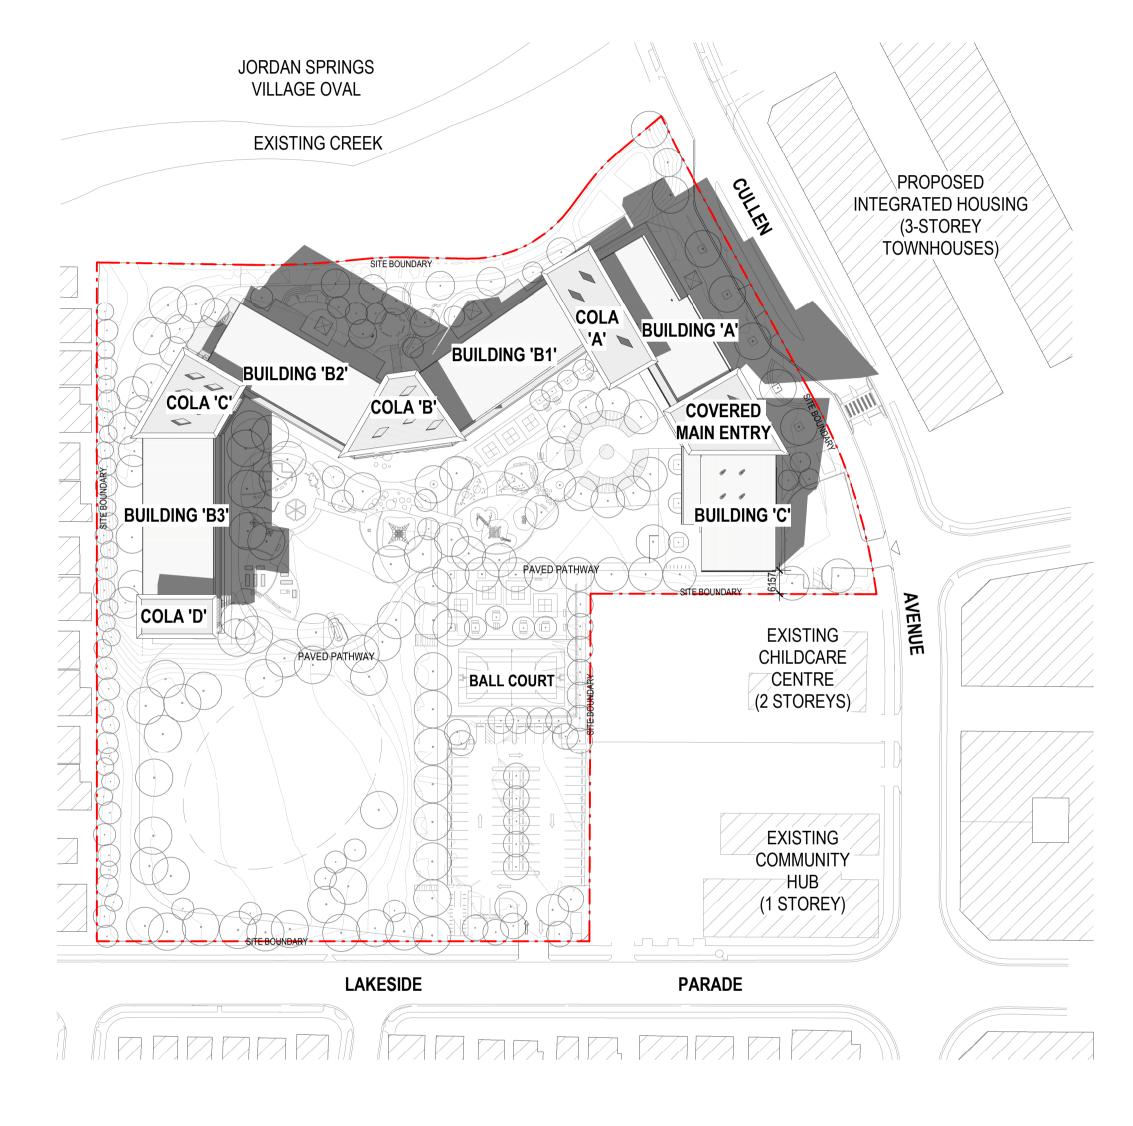


1. This drawing is the copyright of Group GSA Pty Ltd and may not be altered, reproduced or transmitted in any form or by any means in part or in whole without the written permission of Group GSA

In part of in whole without the written permission of Group GSA
2. Drawings to be printed in colour.
3. Do not scale drawings. Dimensions govern.
4. All dimensions are in millimetres unless noted otherwise.
5. All dimensions shall be verified on site before proceeding
6. Any areas indicated on this sheet are approximate and indicative only.

['] Amendments

Issue Description

A SSD SUBMISSION 31.05.2019

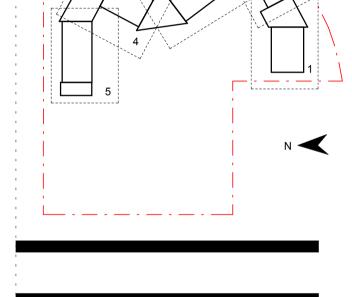







www.groupgsa.com

T +612 9361 4144 F +612 9332 3458

architecture interior design urban design landscape nom architect M. Sheldon 3990


Project Title

JORDAN SPRINGS **PUBLIC SCHOOL**

SITE PLAN - SHADOW - JUNE

Project No	Drawing No	Issue
Approved		MB
Verified		JS
Plotted and checked	d by	FT
Drawing Created (b	y)	LO
Drawing Created (d	ate)	05/31/19
Scale @ A1		1 : 1000

180646 JS-AR-1121 A 🖁

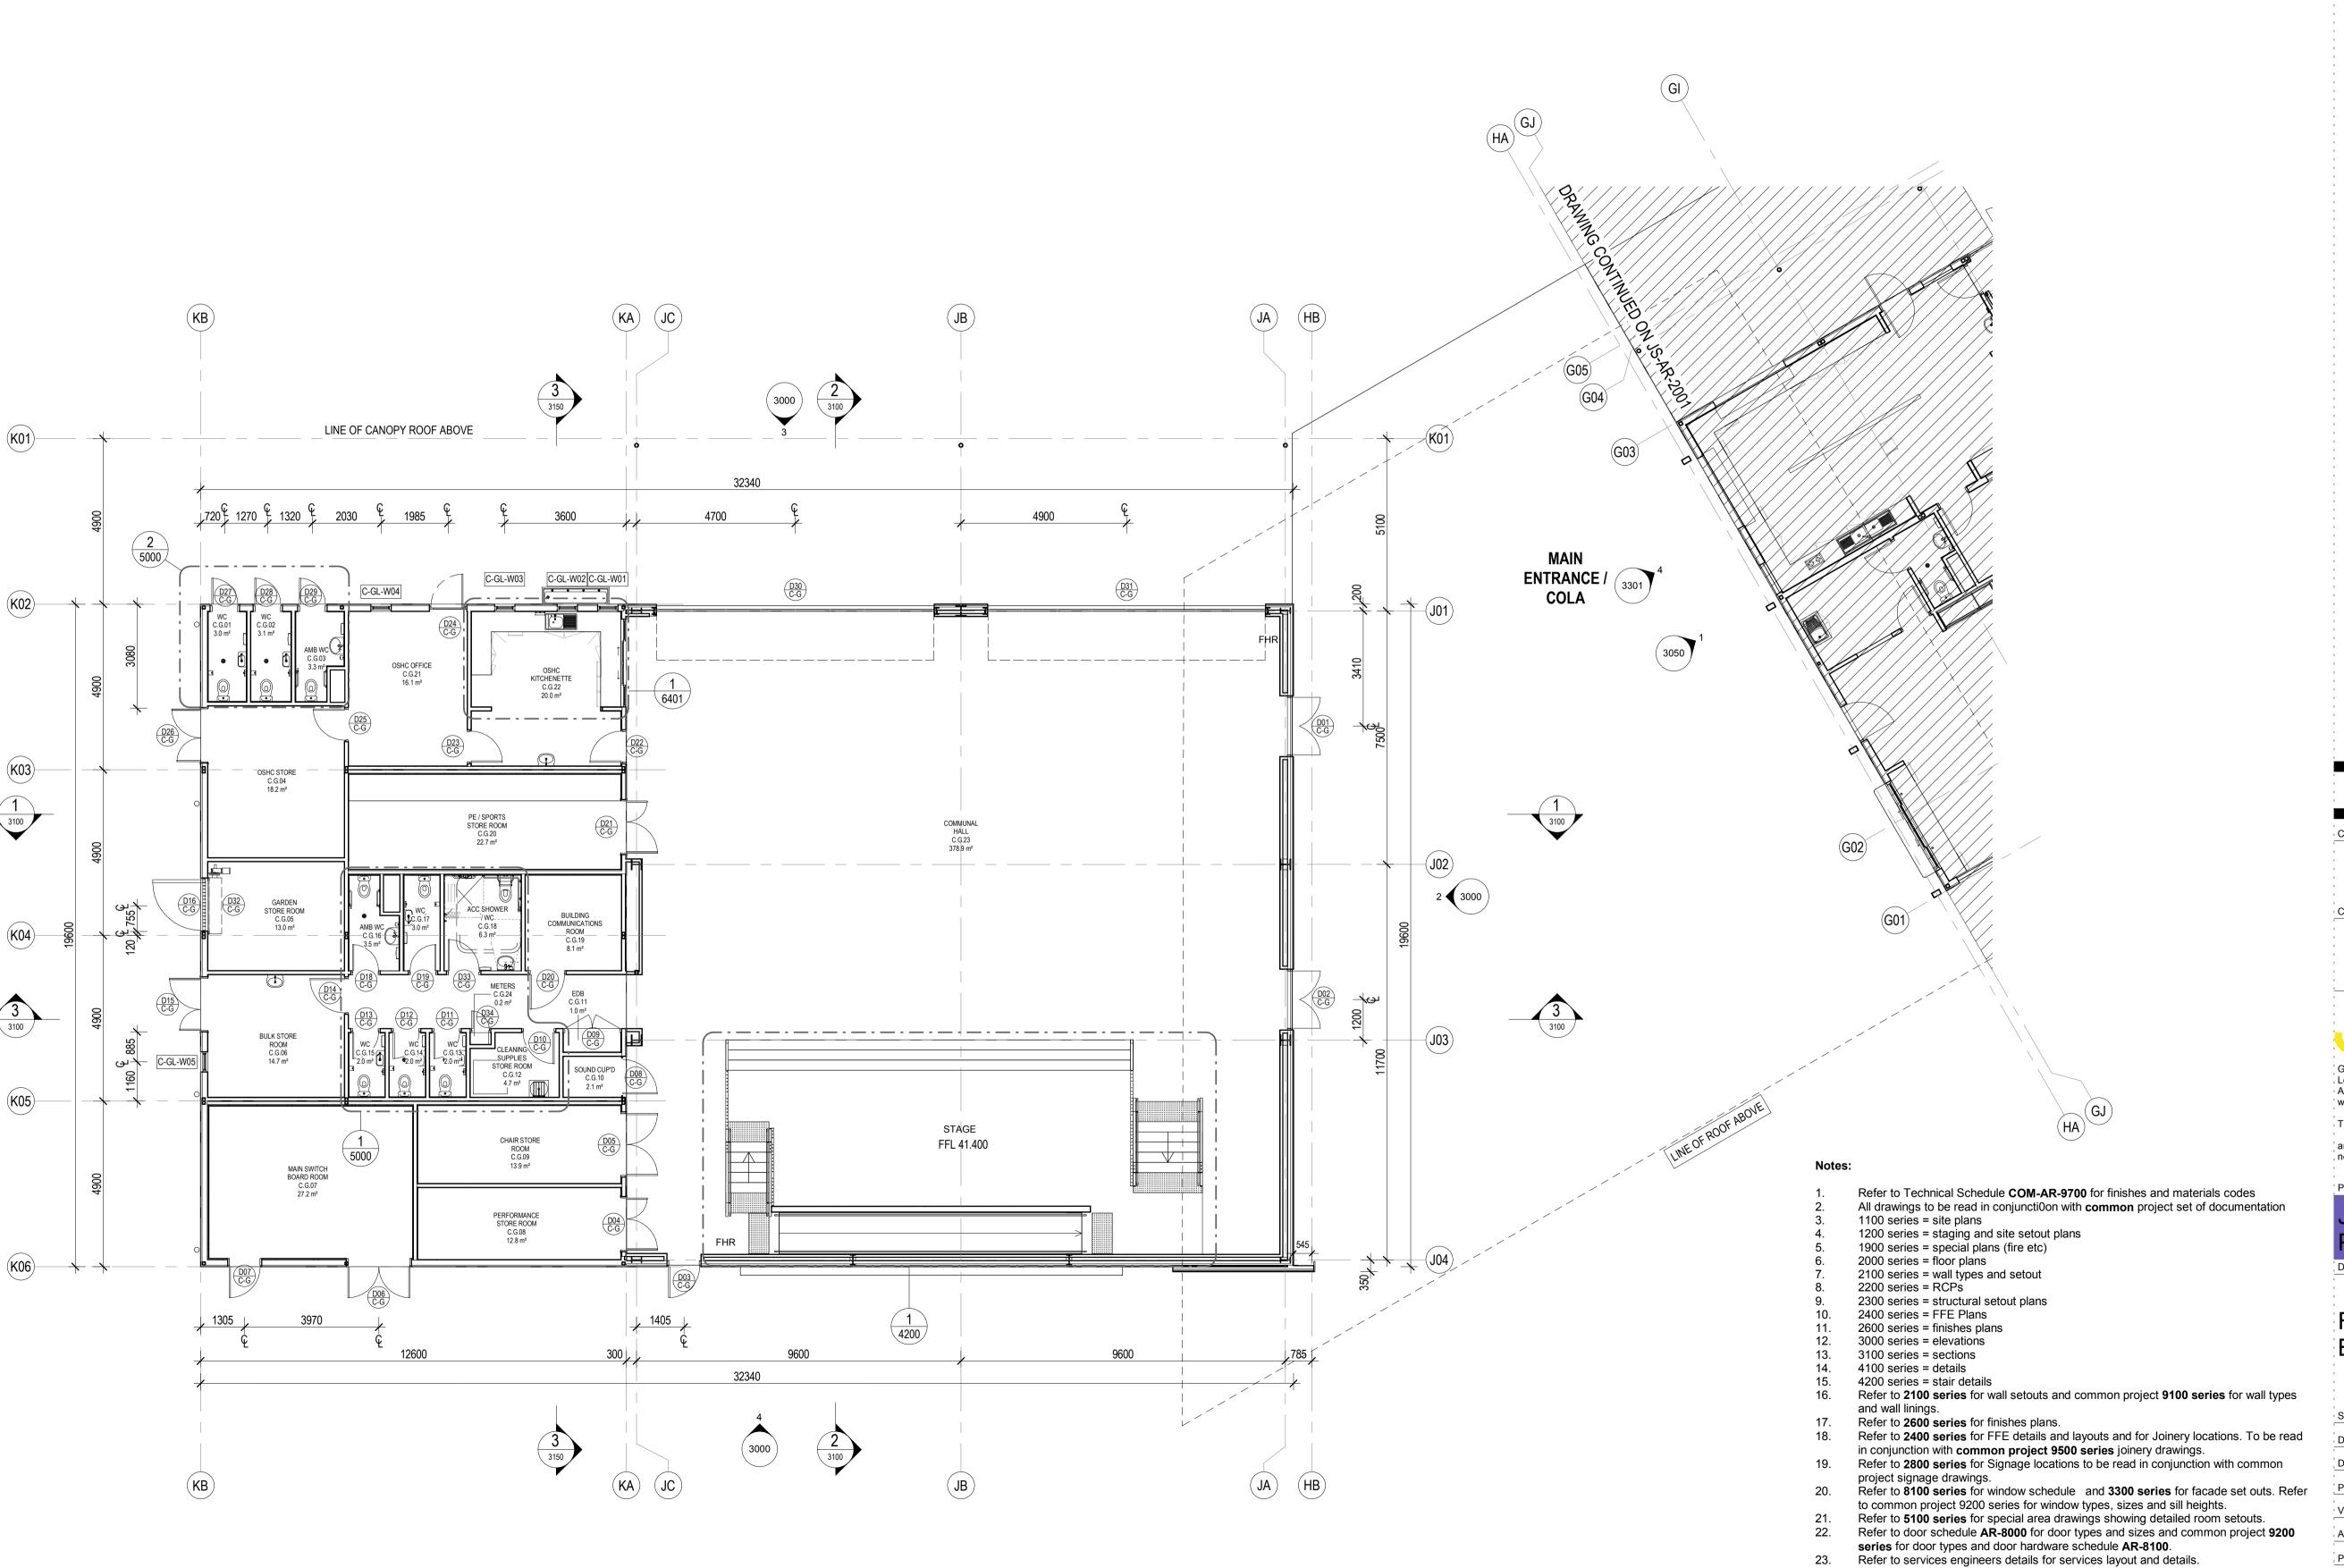


General Notes:

1. This drawing is the copyright of Group GSA Pty Ltd and may not be altered, reproduced or transmitted in any form or by any means in part or in whole without the written permission of Group GSA

Drawings to be printed in colour.
 Do not scale drawings. Dimensions govern.
 All dimensions are in millimetres unless noted otherwise.
 All dimensions shall be verified on site before proceeding
 Any areas indicated on this sheet are approximate and

indicative only. Amendments Issue Description FOR COORDINATION 27.03.2019 DRAFT DETAILED DESIGN 10.04.2019 DRAFT DETAILED DESIGN 17.04.2019 DRAFT DETAILED DESIGN 24.04.2019 DRAFT DETAIL DESIGN 01.05.2019 DOORS GENERALLY AMENDED Date 11 PROGRESS ISSUE 10.05.2019 SSD SUBMISSION 31.05.2019

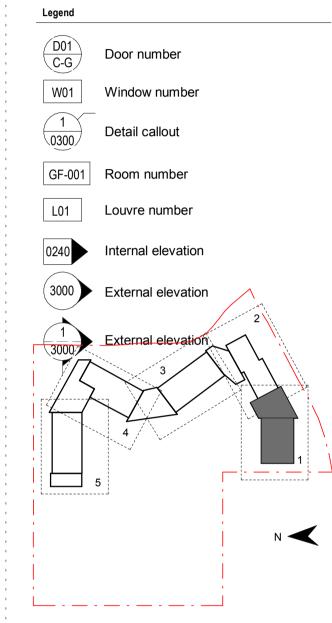







www.groupgsa.com

T +612 9361 4144 F +612 9332 3458

architecture interior design urban design landscape nom architect M. Sheldon 3990

JORDAN SPRINGS
PUBLIC SCHOOL


------<u>-</u>

FLOOR PLAN - GF -BLOCK C - PART 1

Refer also to Civil engineers drawings and Landscape drawings for External works

Refer to Modscape documentation for all details to modular buildings


Scale @ A1		As indicated
Drawing Created (da	ate)	31.05.2019
Drawing Created (by	/)	NS
Plotted and checked	d by	FT
Verified		MP &
Approved		
Project No	Drawing No	Issue 61
180646	JS-AR-20	MB MB MB M31/2019 3:37:35

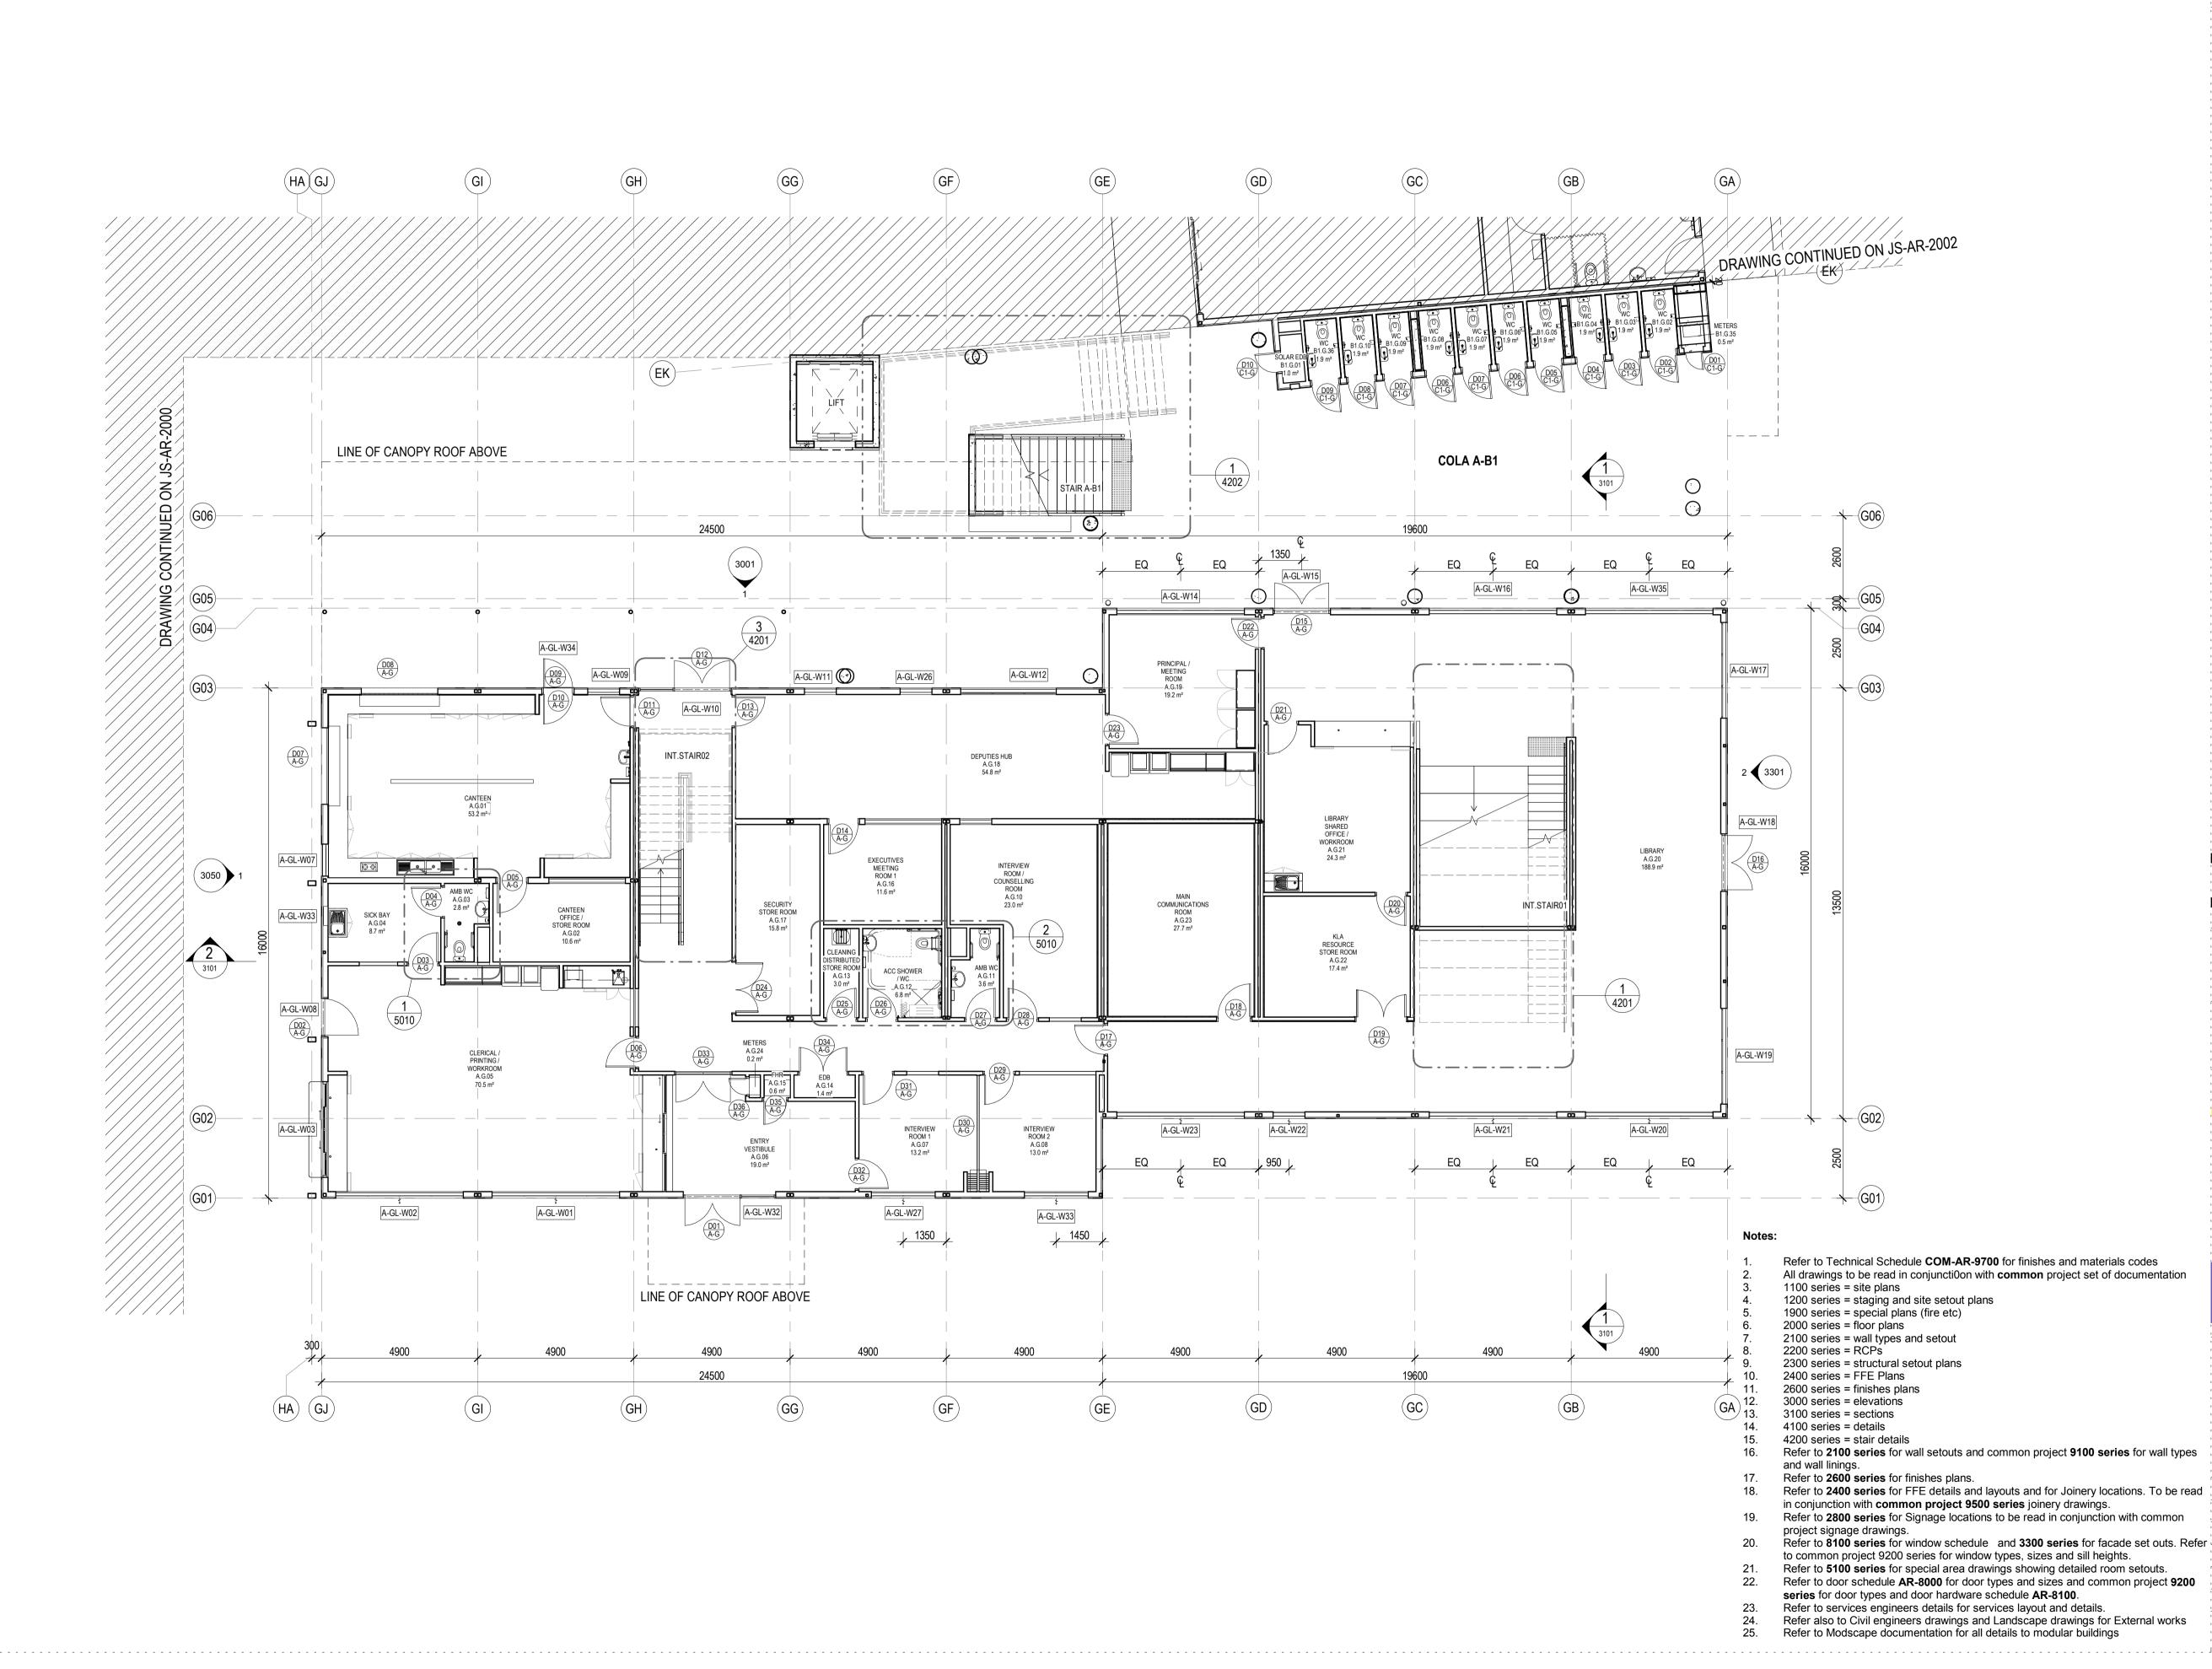

1. This drawing is the copyright of Group GSA Pty Ltd and may not be altered, reproduced or transmitted in any form or by any means in part or in whole without the written permission of Group GSA 2. Drawings to be printed in colour.

3. Do not scale drawings. Dimensions govern. 4. All dimensions are in millimetres unless noted otherwise. 5. All dimensions shall be verified on site before proceeding 6. Any areas indicated on this sheet are approximate and indicative only.

Amendments Issue Description FOR COORDINATION 27.03.2019 DRAFT DETAILED DESIGN 17.04.2019 DRAFT DETAILED DESIGN 24.04.2019 DRAFT DETAIL DESIGN 01.05.2019 AMENDED AS INDICATED 06.05.2019 PROGRESS ISSUE 10.05.2019 DOOR REINSTATED 14.05.2019 SSD SUBMISSION 31.05.2019

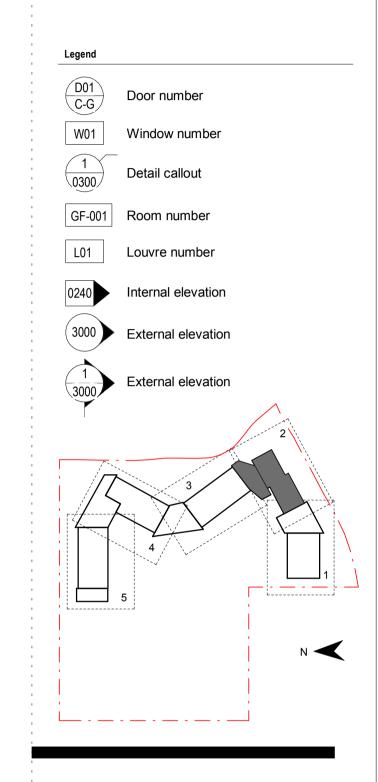





Group GSA Pty Ltd ABN 76 002 113 779 Level 7, 80 William St East Sydney NSW Australia 2011


www.groupgsa.com T +612 9361 4144 F +612 9332 3458

architecture interior design urban design landscape nom architect M. Sheldon 3990

Project Title JORDAN SPRINGS **PUBLIC SCHOOL**

FLOOR PLAN - GF -BLOCK A - PART 2

1		
Scale @ A1		As indicated
Drawing Created (dat	te)	31.05.2019
Drawing Created (by)		NS
Plotted and checked	by	FT
Verified		MP ≥
Approved		
Project No	Drawing No	Issue 6
180646	JS-AR-20	MB 97.25 15.00 15.00 
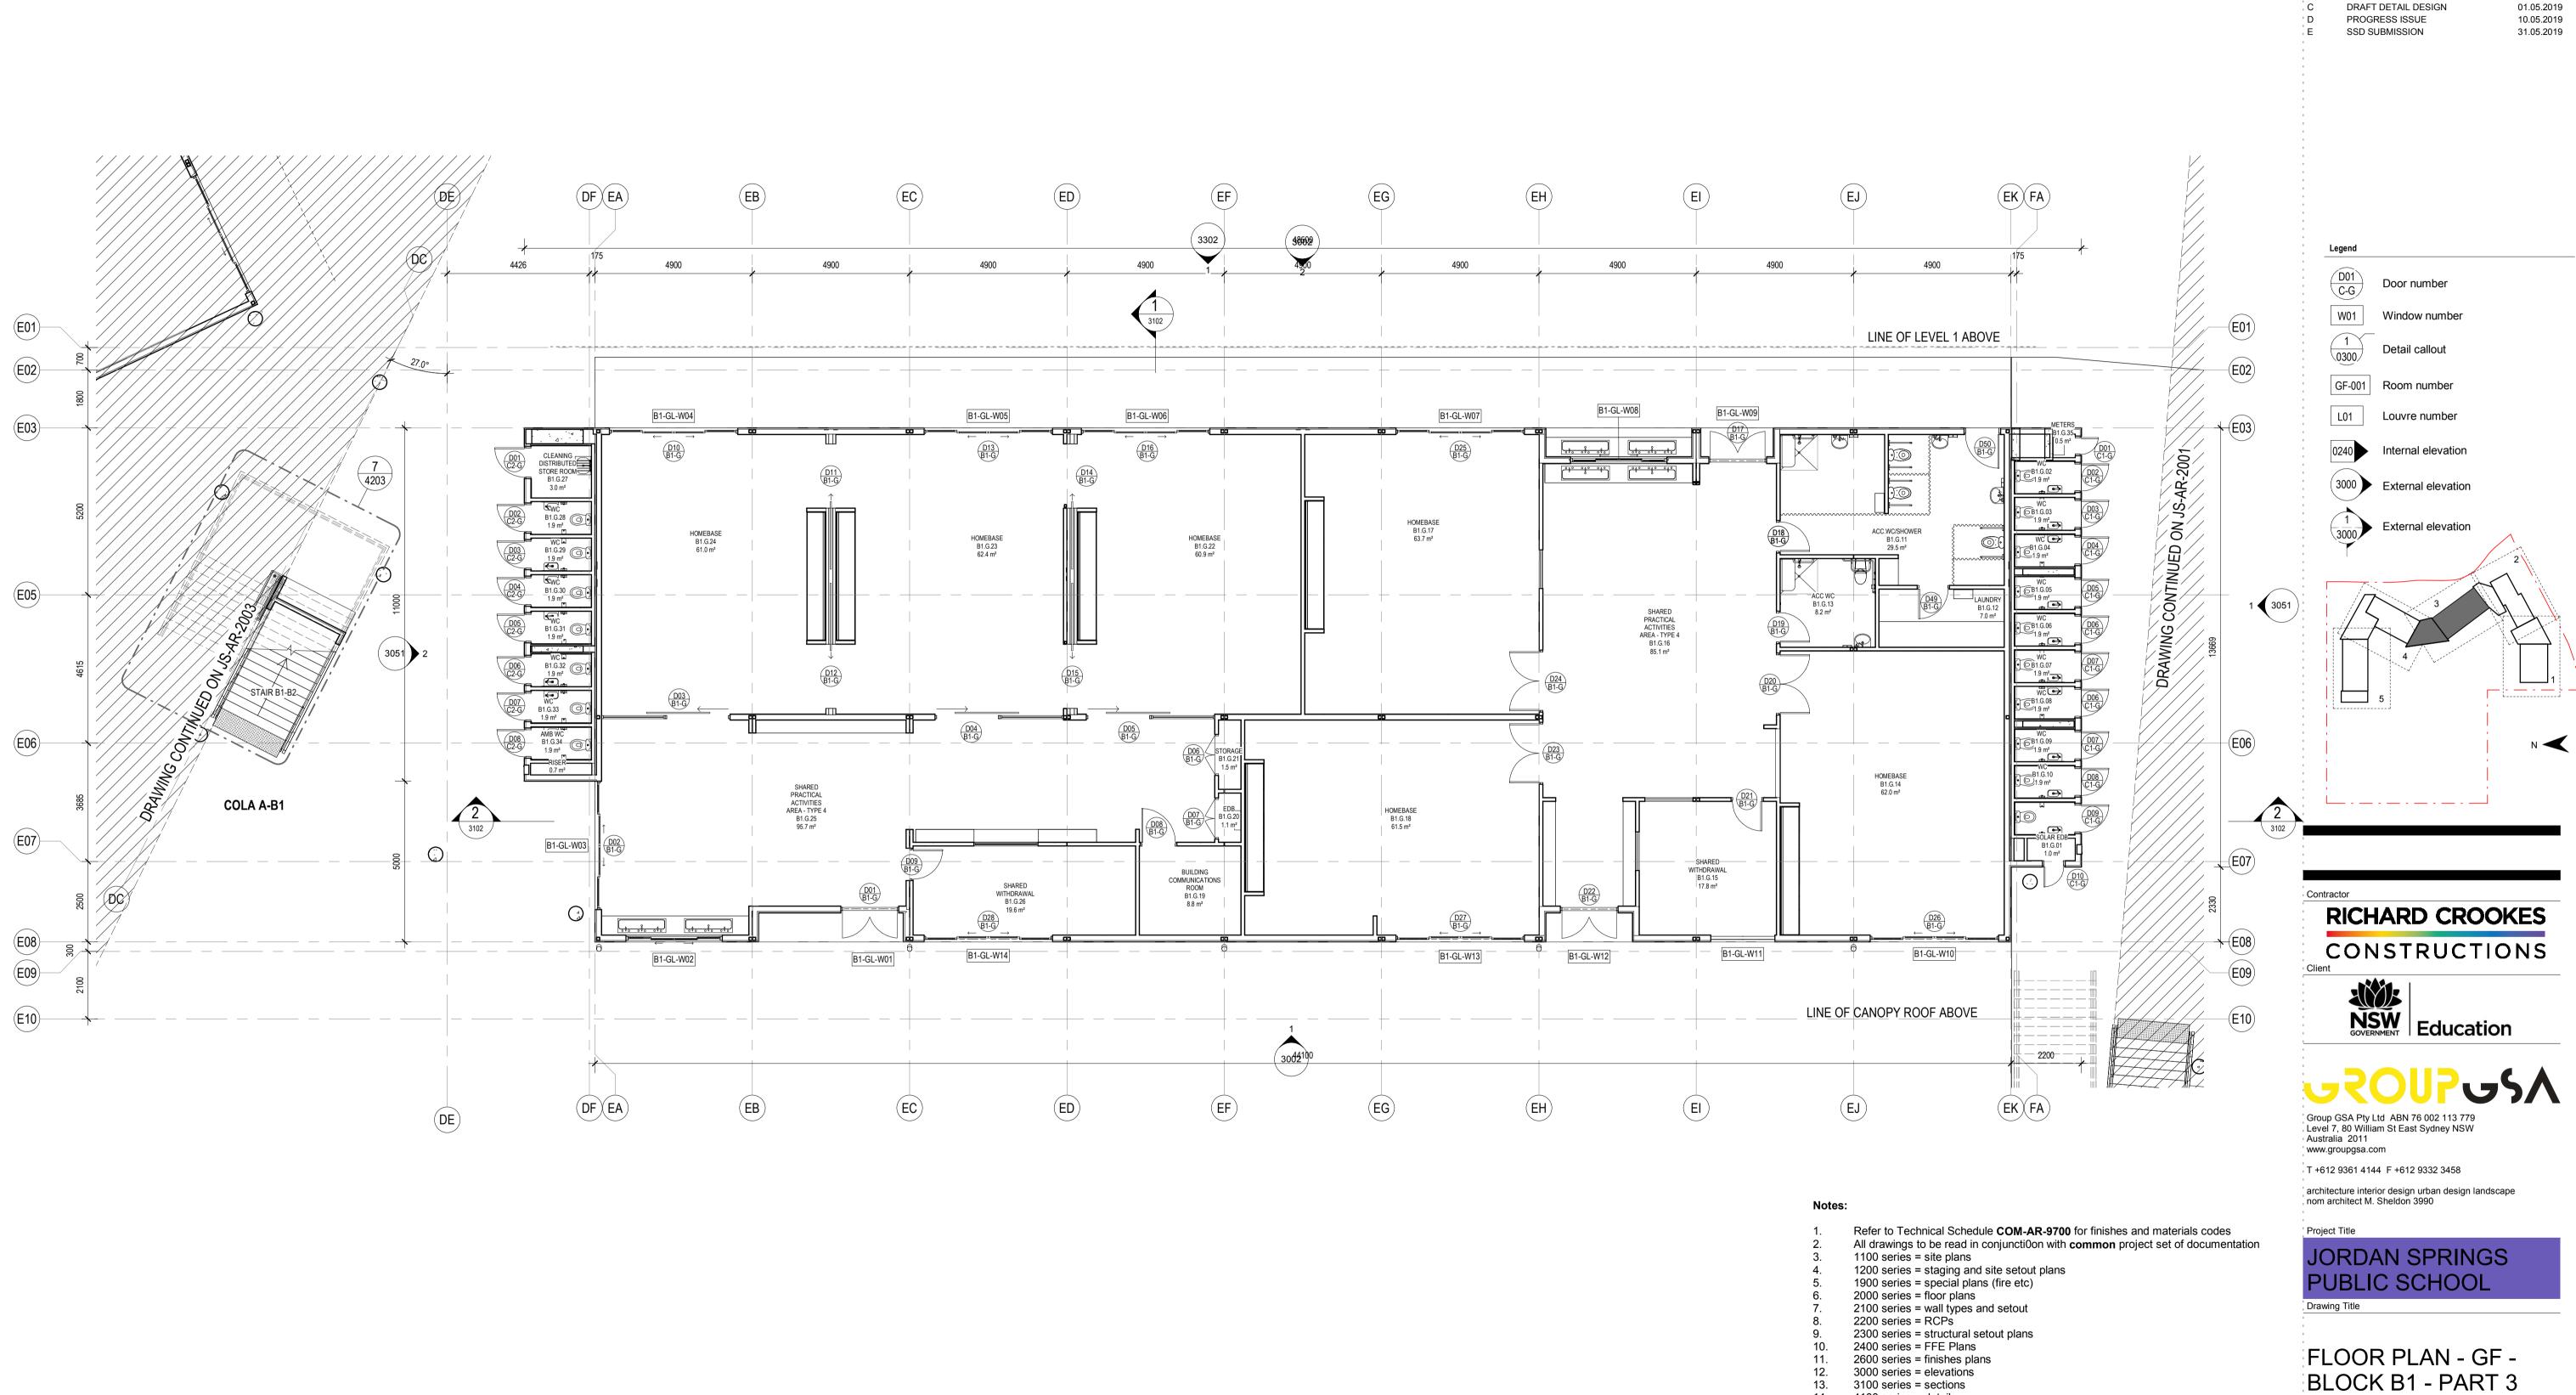

General Notes:

1. This drawing is the copyright of Group GSA Pty Ltd and may not be altered, reproduced or transmitted in any form or by any means in part or in whole without the written permission of Group GSA

2. Drawings to be printed in colour.

2. Drawings to be printed in colour.
3. Do not scale drawings. Dimensions govern.
4. All dimensions are in millimetres unless noted otherwise.
5. All dimensions shall be verified on site before proceeding
6. Any areas indicated on this sheet are approximate and indicative only.

 Amendments

 Issue
 Description
 Date

 A
 FOR COORDINATION
 27.03.2019

 B
 DRAFT DETAILED DESIGN
 24.04.2019

 C
 DRAFT DETAIL DESIGN
 01.05.2019

 D
 DROCRESS ISSUE
 10.05.2019

Scale @ A1

Drawing Created (date)

Drawing Created (by)

NS

Plotted and checked by

FT

Verified

Approved

MB

Project No

Drawing No

Issue

180646 JS-AR-2002 E

4100 series = details 4200 series = stair details

project signage drawings.

Refer to **2600 series** for finishes plans.

and wall linings.

Refer to 2100 series for wall setouts and common project 9100 series for wall types

Refer to **2400 series** for FFE details and layouts and for Joinery locations. To be read

Refer to 8100 series for window schedule and 3300 series for facade set outs. Refer

Refer to 2800 series for Signage locations to be read in conjunction with common

Refer also to Civil engineers drawings and Landscape drawings for External works

in conjunction with **common project 9500 series** joinery drawings.


to common project 9200 series for window types, sizes and sill heights.

Refer to **5100 series** for special area drawings showing detailed room setouts.

Refer to door schedule **AR-8000** for door types and sizes and common project **9200**

Refer to Modscape documentation for all details to modular buildings

series for door types and door hardware schedule AR-8100.
Refer to services engineers details for services layout and details.

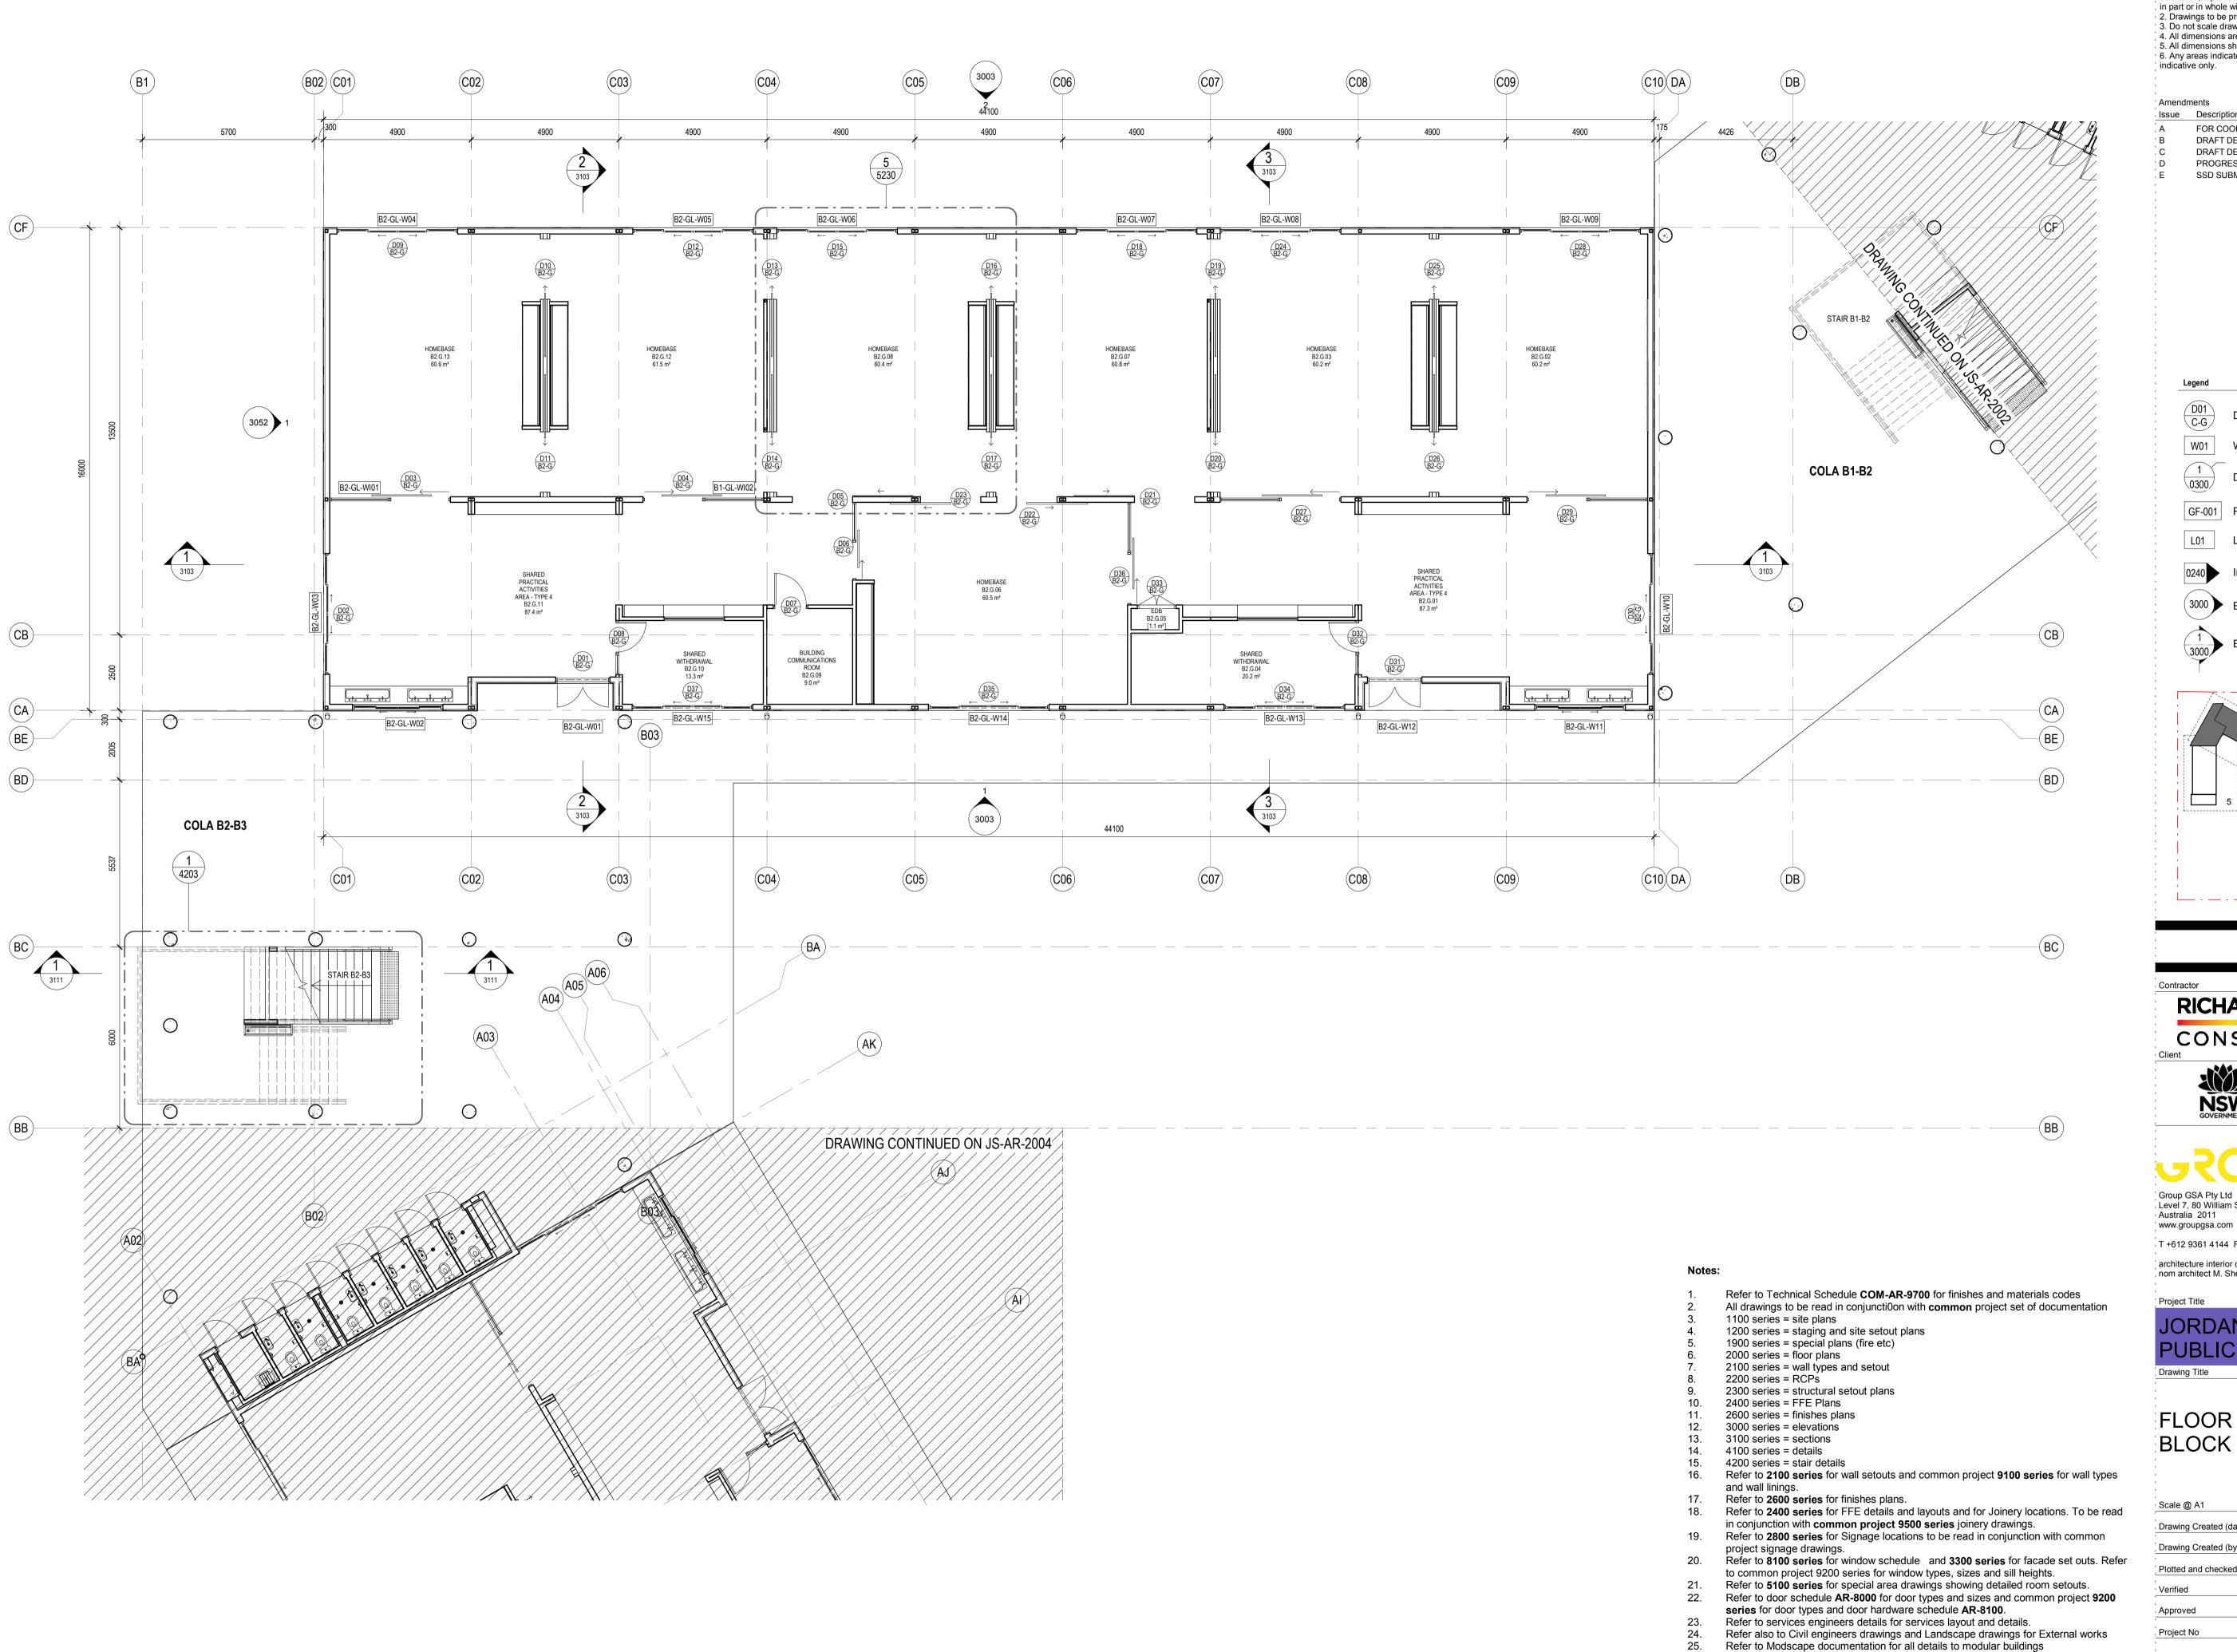

1. This drawing is the copyright of Group GSA Pty Ltd and may not be altered, reproduced or transmitted in any form or by any means in part or in whole without the written permission of Group GSA 2. Drawings to be printed in colour.3. Do not scale drawings. Dimensions govern.

FOR COORDINATION

DRAFT DETAILED DESIGN

DRAFT DETAIL DESIGN

PROGRESS ISSUE

SSD SUBMISSION

4. All dimensions are in millimetres unless noted otherwise. 5. All dimensions shall be verified on site before proceeding 6. Any areas indicated on this sheet are approximate and indicative only.

27.03.2019

24.04.2019

01.05.2019

10.05.2019 31.05.2019

Door number W01 Window number Detail callout GF-001 Room number Louvre number Internal elevation External elevation External elevation

RICHARD CROOKES CONSTRUCTIONS



Group GSA Pty Ltd ABN 76 002 113 779 Level 7, 80 William St East Sydney NSW Australia 2011

T +612 9361 4144 F +612 9332 3458

architecture interior design urban design landscape nom architect M. Sheldon 3990


Project Title

JORDAN SPRINGS **PUBLIC SCHOOL**

FLOOR PLAN - GF -BLOCK B2 - PART 4

Scale @ A1 As indicated Drawing Created (date) 10/05/19 Drawing Created (by) Plotted and checked by Approved

180646 JS-AR-2003 E

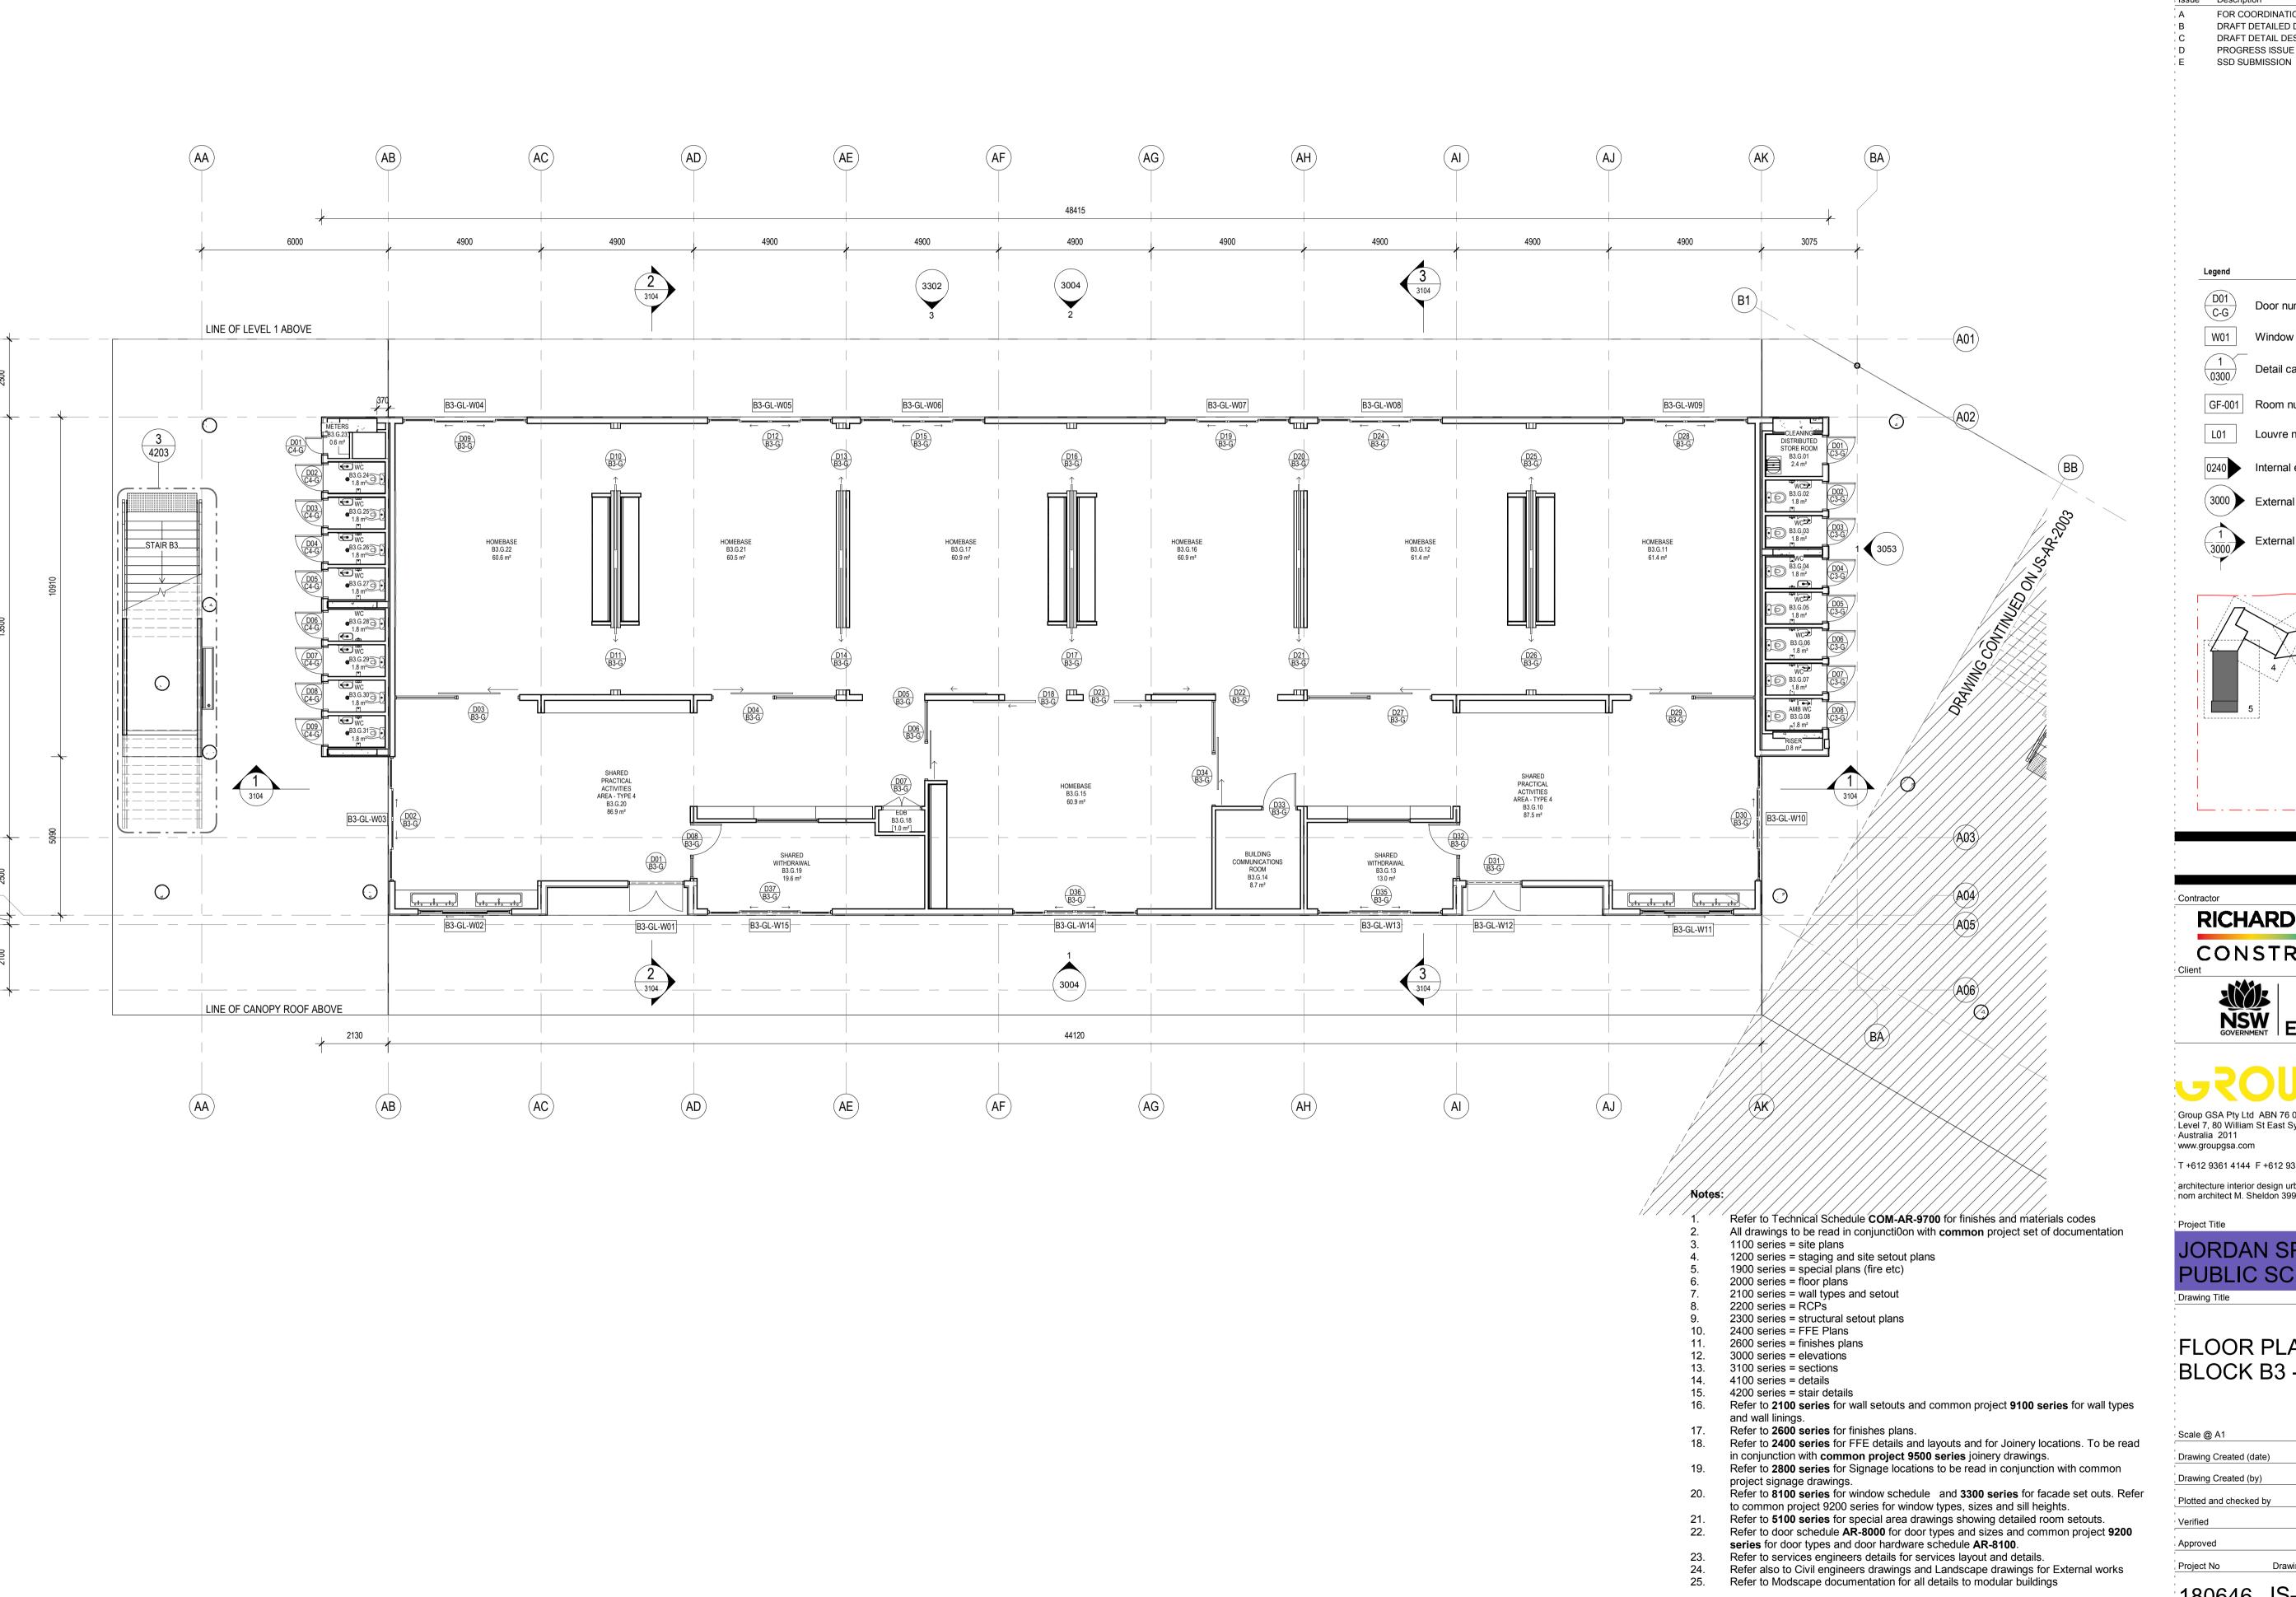

(A02)

(A03)

(A04)

A05


(A06)

1. This drawing is the copyright of Group GSA Pty Ltd and may not be altered, reproduced or transmitted in any form or by any means in part or in whole without the written permission of Group GSA

2. Drawings to be printed in colour. 3. Do not scale drawings. Dimensions govern. 4. All dimensions are in millimetres unless noted otherwise. 5. All dimensions shall be verified on site before proceeding 6. Any areas indicated on this sheet are approximate and

indicative only. ['] Amendments Issue Description FOR COORDINATION 27.03.2019 DRAFT DETAILED DESIGN 24.04.2019 DRAFT DETAIL DESIGN 01.05.2019 PROGRESS ISSUE 10.05.2019

31.05.2019

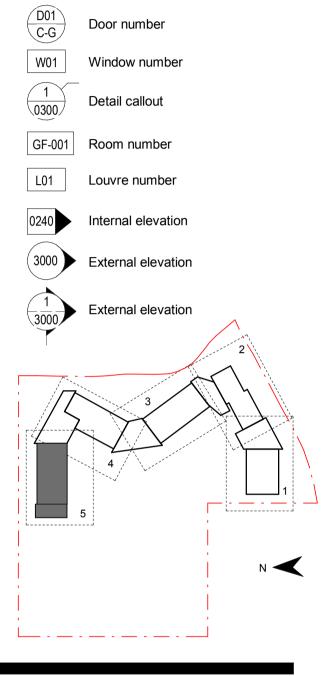

RICHARD CROOKES CONSTRUCTIONS





www.groupgsa.com


T +612 9361 4144 F +612 9332 3458 architecture interior design urban design landscape nom architect M. Sheldon 3990

JORDAN SPRINGS **PUBLIC SCHOOL**

FLOOR PLAN - GF -BLOCK B3 - PART 5

400040		004	1/2015
Project No	Drawing No	Issue	3338
Approved		MB	/2019 3:38:16 PM
Verified		MP	∑
Plotted and checke	d by	FT	
Drawing Created (b	y)	FC	
Drawing Created (d	ate)	10/05/19	
Scale @ A1		As indicated	
1			

:180646 JS-AR-2004 E है।

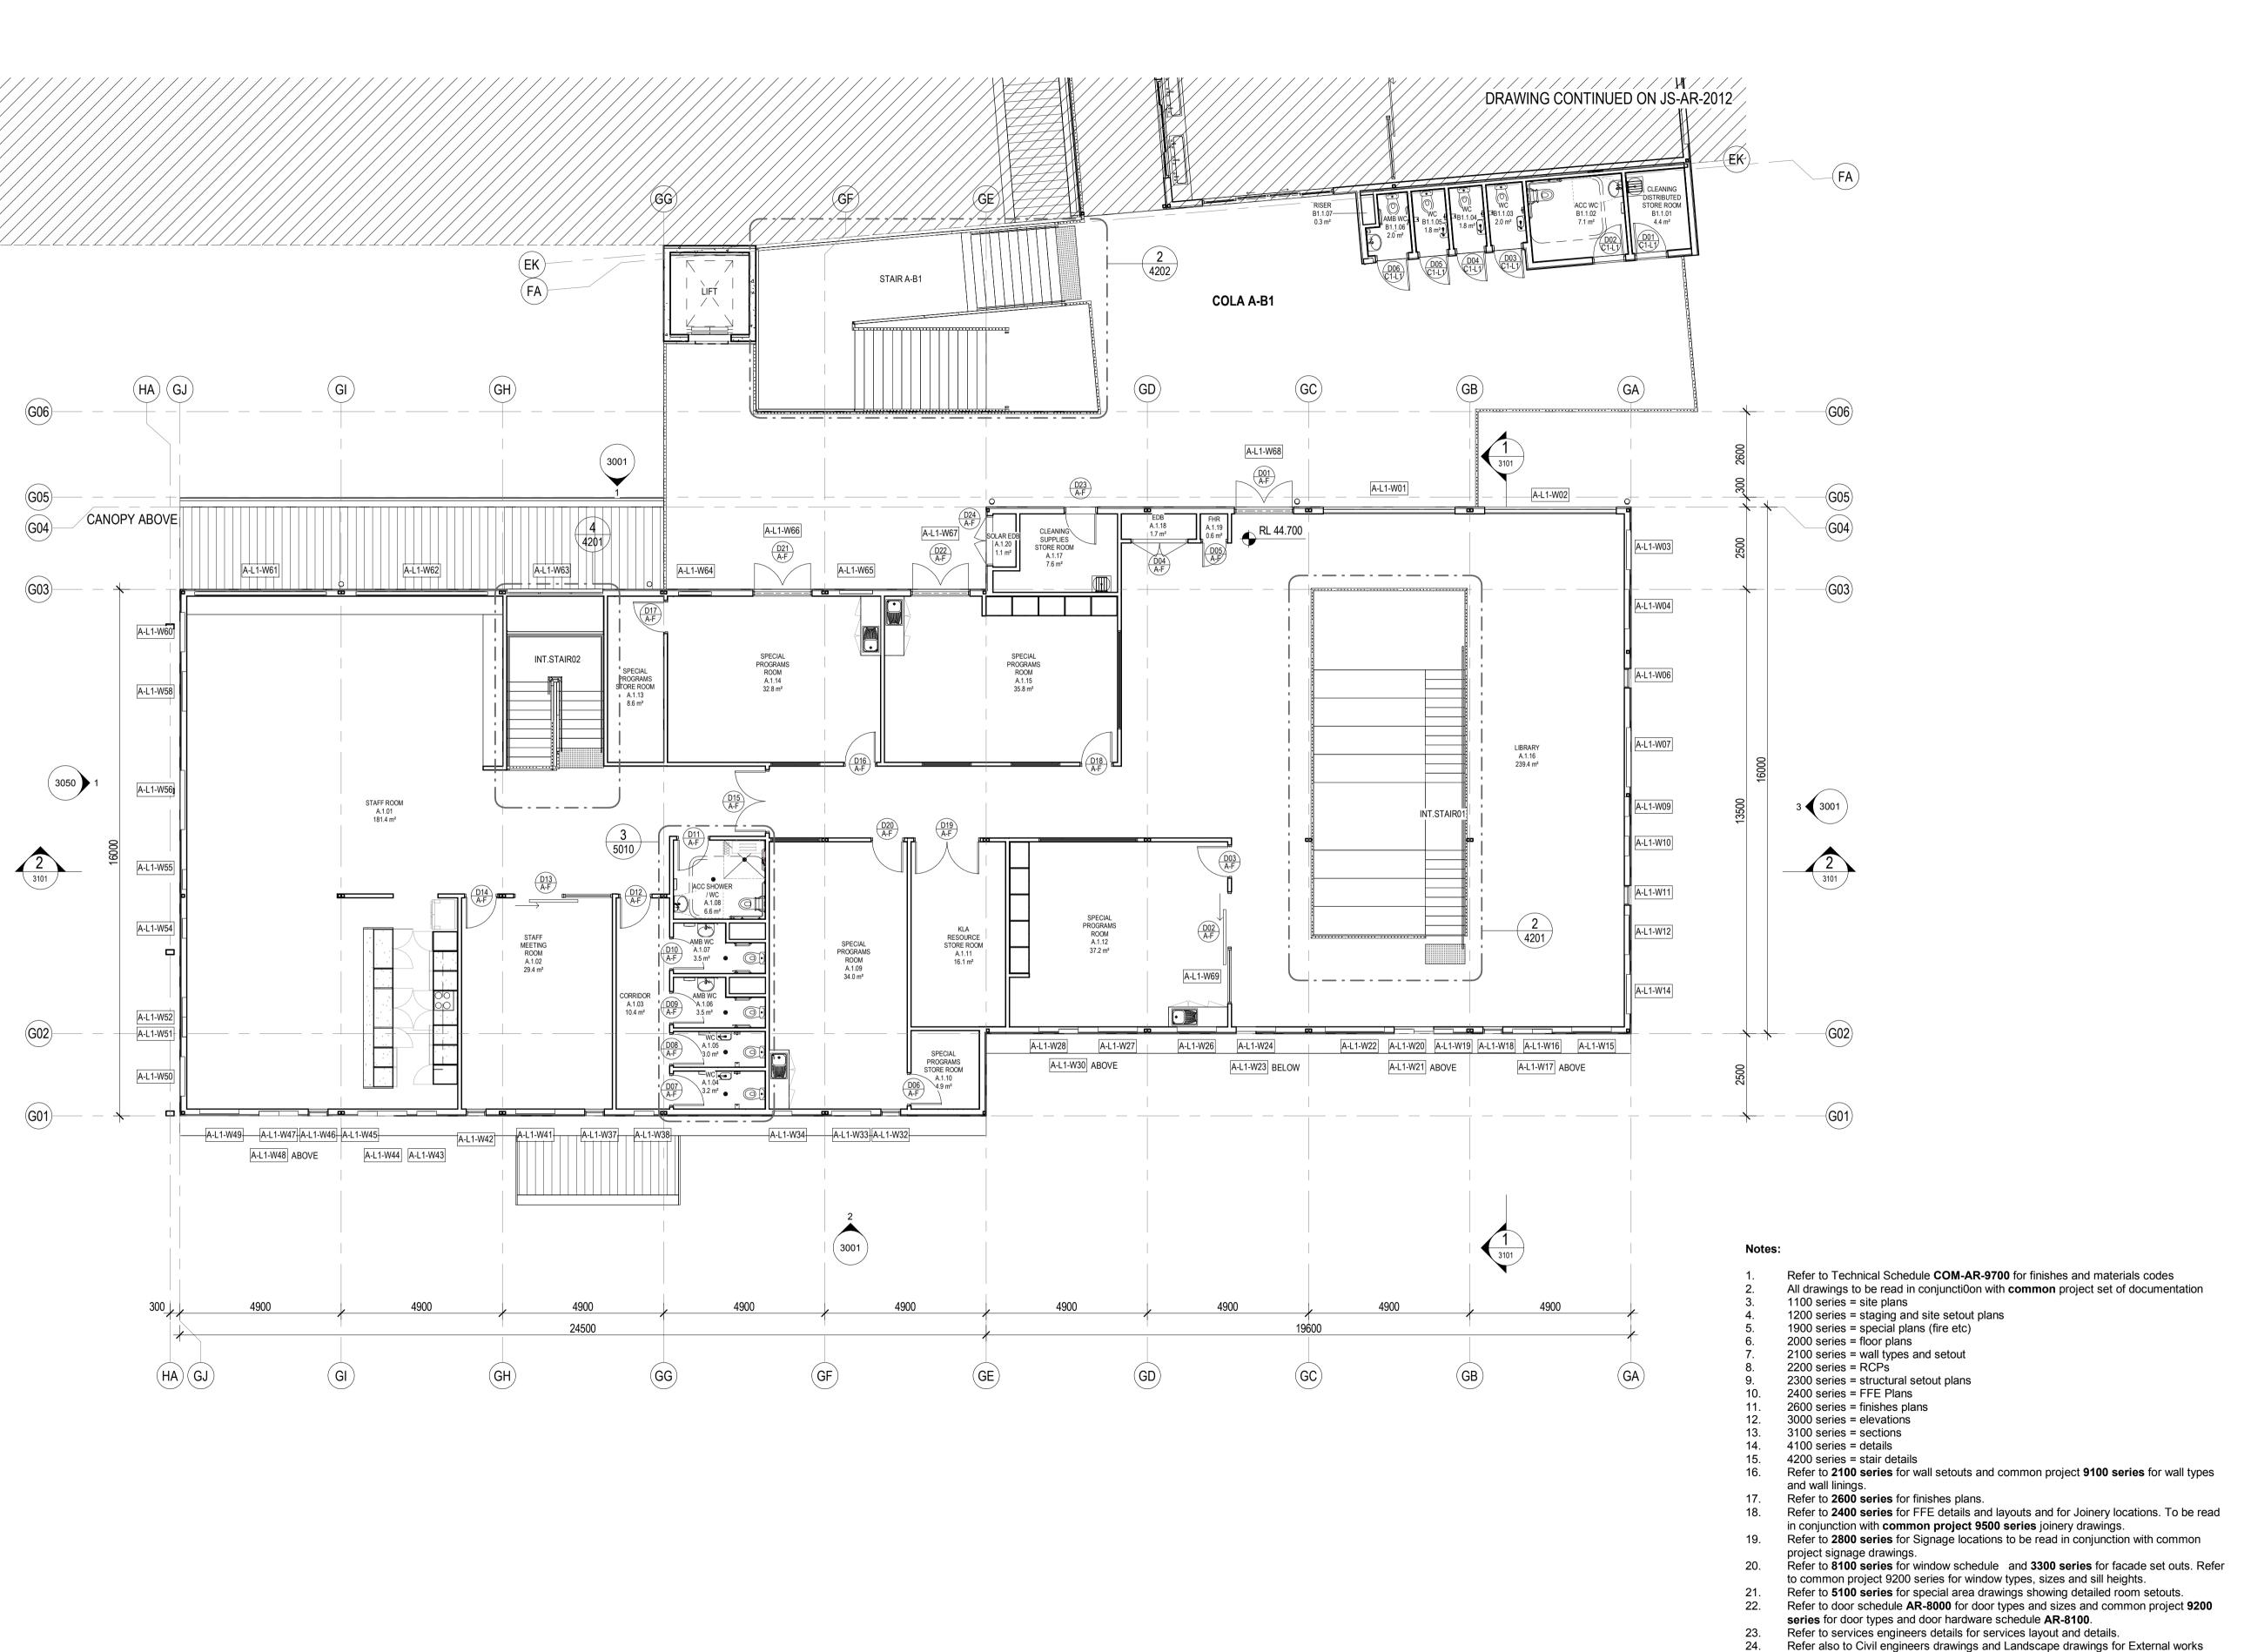

1. This drawing is the copyright of Group GSA Pty Ltd and may not be altered, reproduced or transmitted in any form or by any means in part or in whole without the written permission of Group GSA


indicative only.

2. Drawings to be printed in colour. 3. Do not scale drawings. Dimensions govern. 4. All dimensions are in millimetres unless noted otherwise. 5. All dimensions shall be verified on site before proceeding 6. Any areas indicated on this sheet are approximate and

Amendments Issue Description FOR COORDINATION 27.03.2019 DRAFT DETAILED DESIGN 17.04.2019 DRAFT DETAILED DESIGN 24.04.2019 DRAFT DETAIL DESIGN 01.05.2019 10.05.2019 PROGRESS ISSUE DOOR REINSTATED 14.05.2019 DOOR HEIGHTS AMENDED 28.05.2019

SSD SUBMISSION

31.05.2019

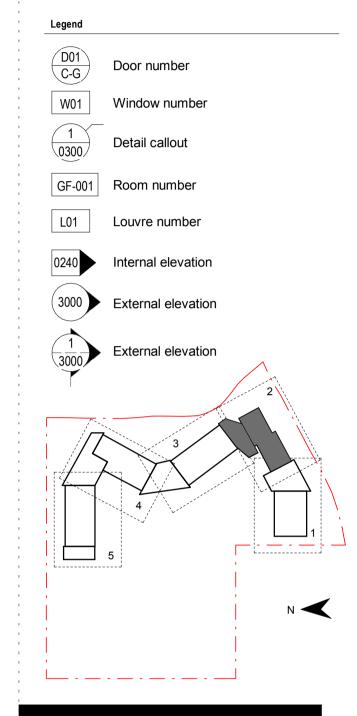





Group GSA Pty Ltd ABN 76 002 113 779 Level 7, 80 William St East Sydney NSW Australia 2011

www.groupgsa.com T +612 9361 4144 F +612 9332 3458

architecture interior design urban design landscape nom architect M. Sheldon 3990


Refer to Modscape documentation for all details to modular buildings

Project Title JORDAN SPRINGS **PUBLIC SCHOOL**

FLOOR PLAN - L1 -BLOCK A - PART 2

Project No	Drawing No	Issue
Approved		ME
Verified		MF
Plotted and checked	by	FT
Drawing Created (by))	NS
Drawing Created (date	te)	10/05/19
Scale @ A1		As indicated

180646 JS-AR-2011 H

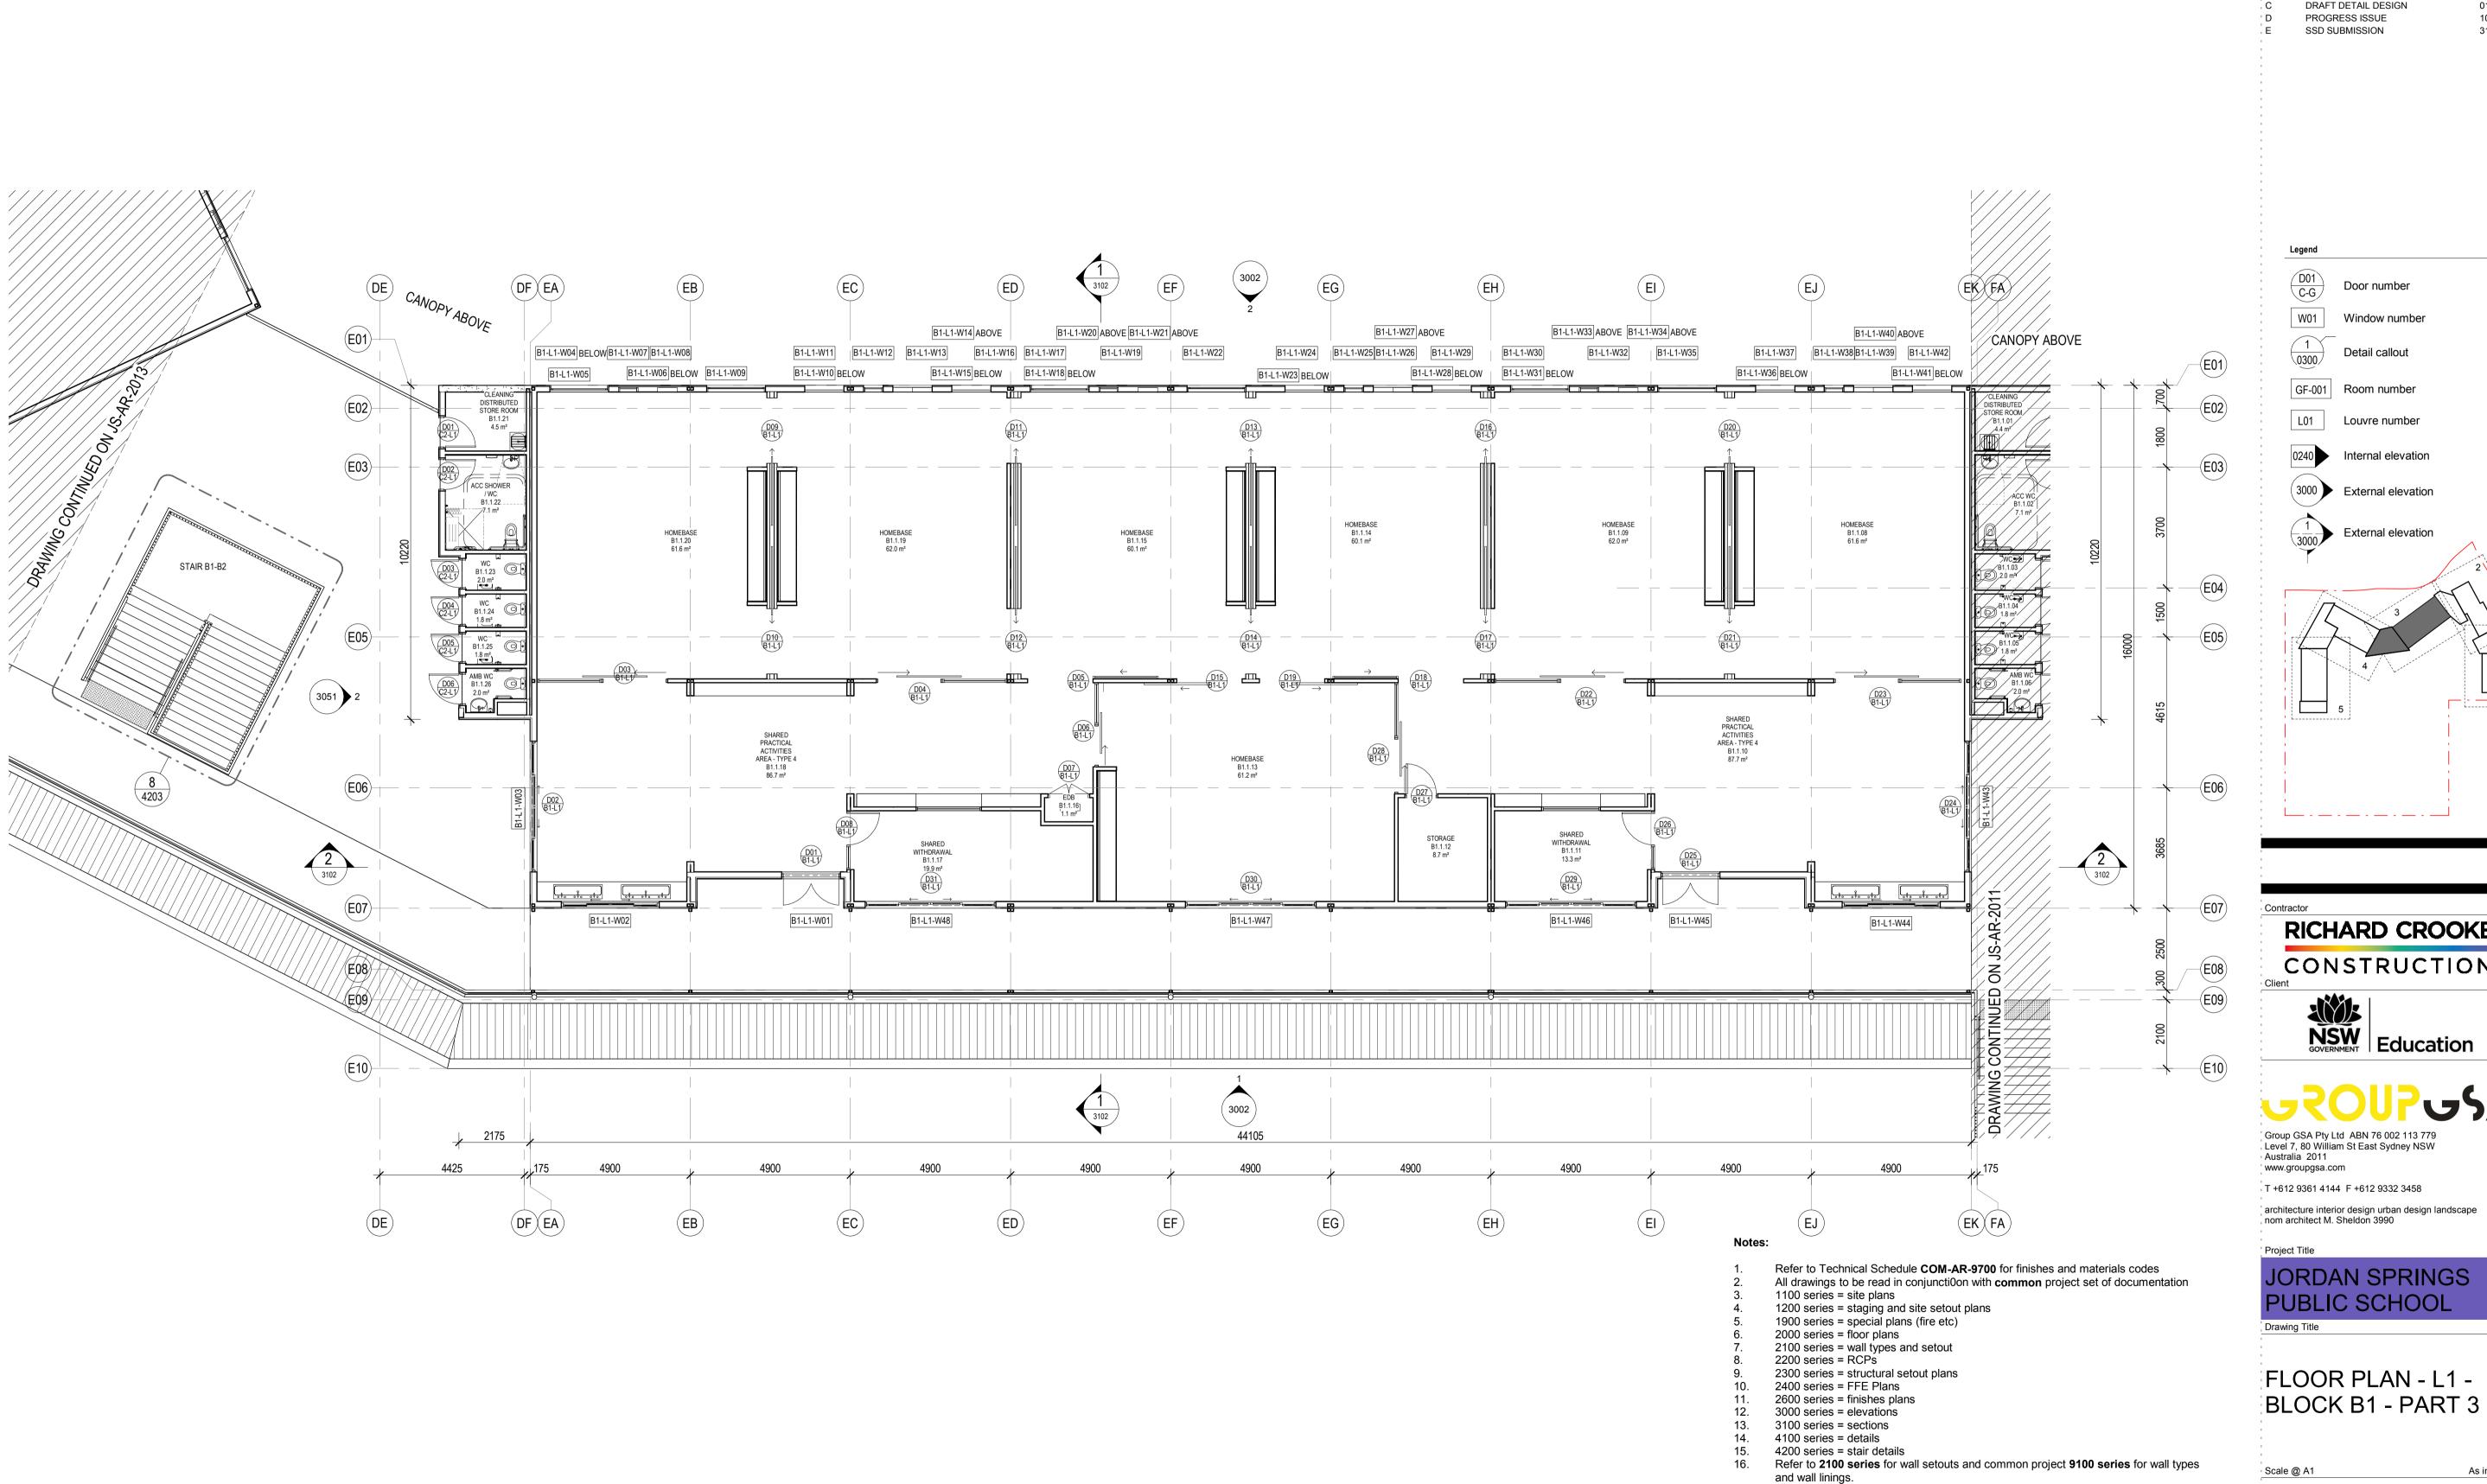


1. This drawing is the copyright of Group GSA Pty Ltd and may not be altered, reproduced or transmitted in any form or by any means in part or in whole without the written permission of Group GSA 2. Drawings to be printed in colour.

3. Do not scale drawings. Dimensions govern. 4. All dimensions are in millimetres unless noted otherwise. 5. All dimensions shall be verified on site before proceeding 6. Any areas indicated on this sheet are approximate and indicative only.

Amendments Issue Description FOR COORDINATION 27.03.2019 DRAFT DETAILED DESIGN 24.04.2019 DRAFT DETAIL DESIGN 01.05.2019 10.05.2019

31.05.2019

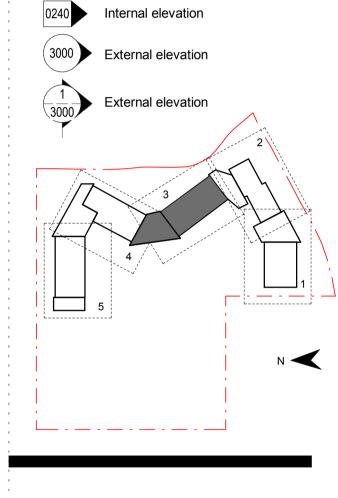





Group GSA Pty Ltd ABN 76 002 113 779 Level 7, 80 William St East Sydney NSW Australia 2011

architecture interior design urban design landscape nom architect M. Sheldon 3990

JORDAN SPRINGS **PUBLIC SCHOOL**

FLOOR PLAN - L1 -

Refer to **2600** series for finishes plans.

project signage drawings.

Refer to 2400 series for FFE details and layouts and for Joinery locations. To be read

Refer to 8100 series for window schedule and 3300 series for facade set outs. Refer

Refer to 2800 series for Signage locations to be read in conjunction with common

Refer also to Civil engineers drawings and Landscape drawings for External works


in conjunction with **common project 9500 series** joinery drawings.

to common project 9200 series for window types, sizes and sill heights. Refer to **5100 series** for special area drawings showing detailed room setouts. Refer to door schedule AR-8000 for door types and sizes and common project 9200

Refer to Modscape documentation for all details to modular buildings

series for door types and door hardware schedule AR-8100. Refer to services engineers details for services layout and details.

Scale @ A1		As indicated
Drawing Created (da	te)	10/05/19
Drawing Created (by)	NS
Plotted and checked	by	FT
Verified		MP ≥
Approved		MB 8:30
Project No	Drawing No	lssue 67
180646	JS-AR-201	MB Issue 20102/12/9

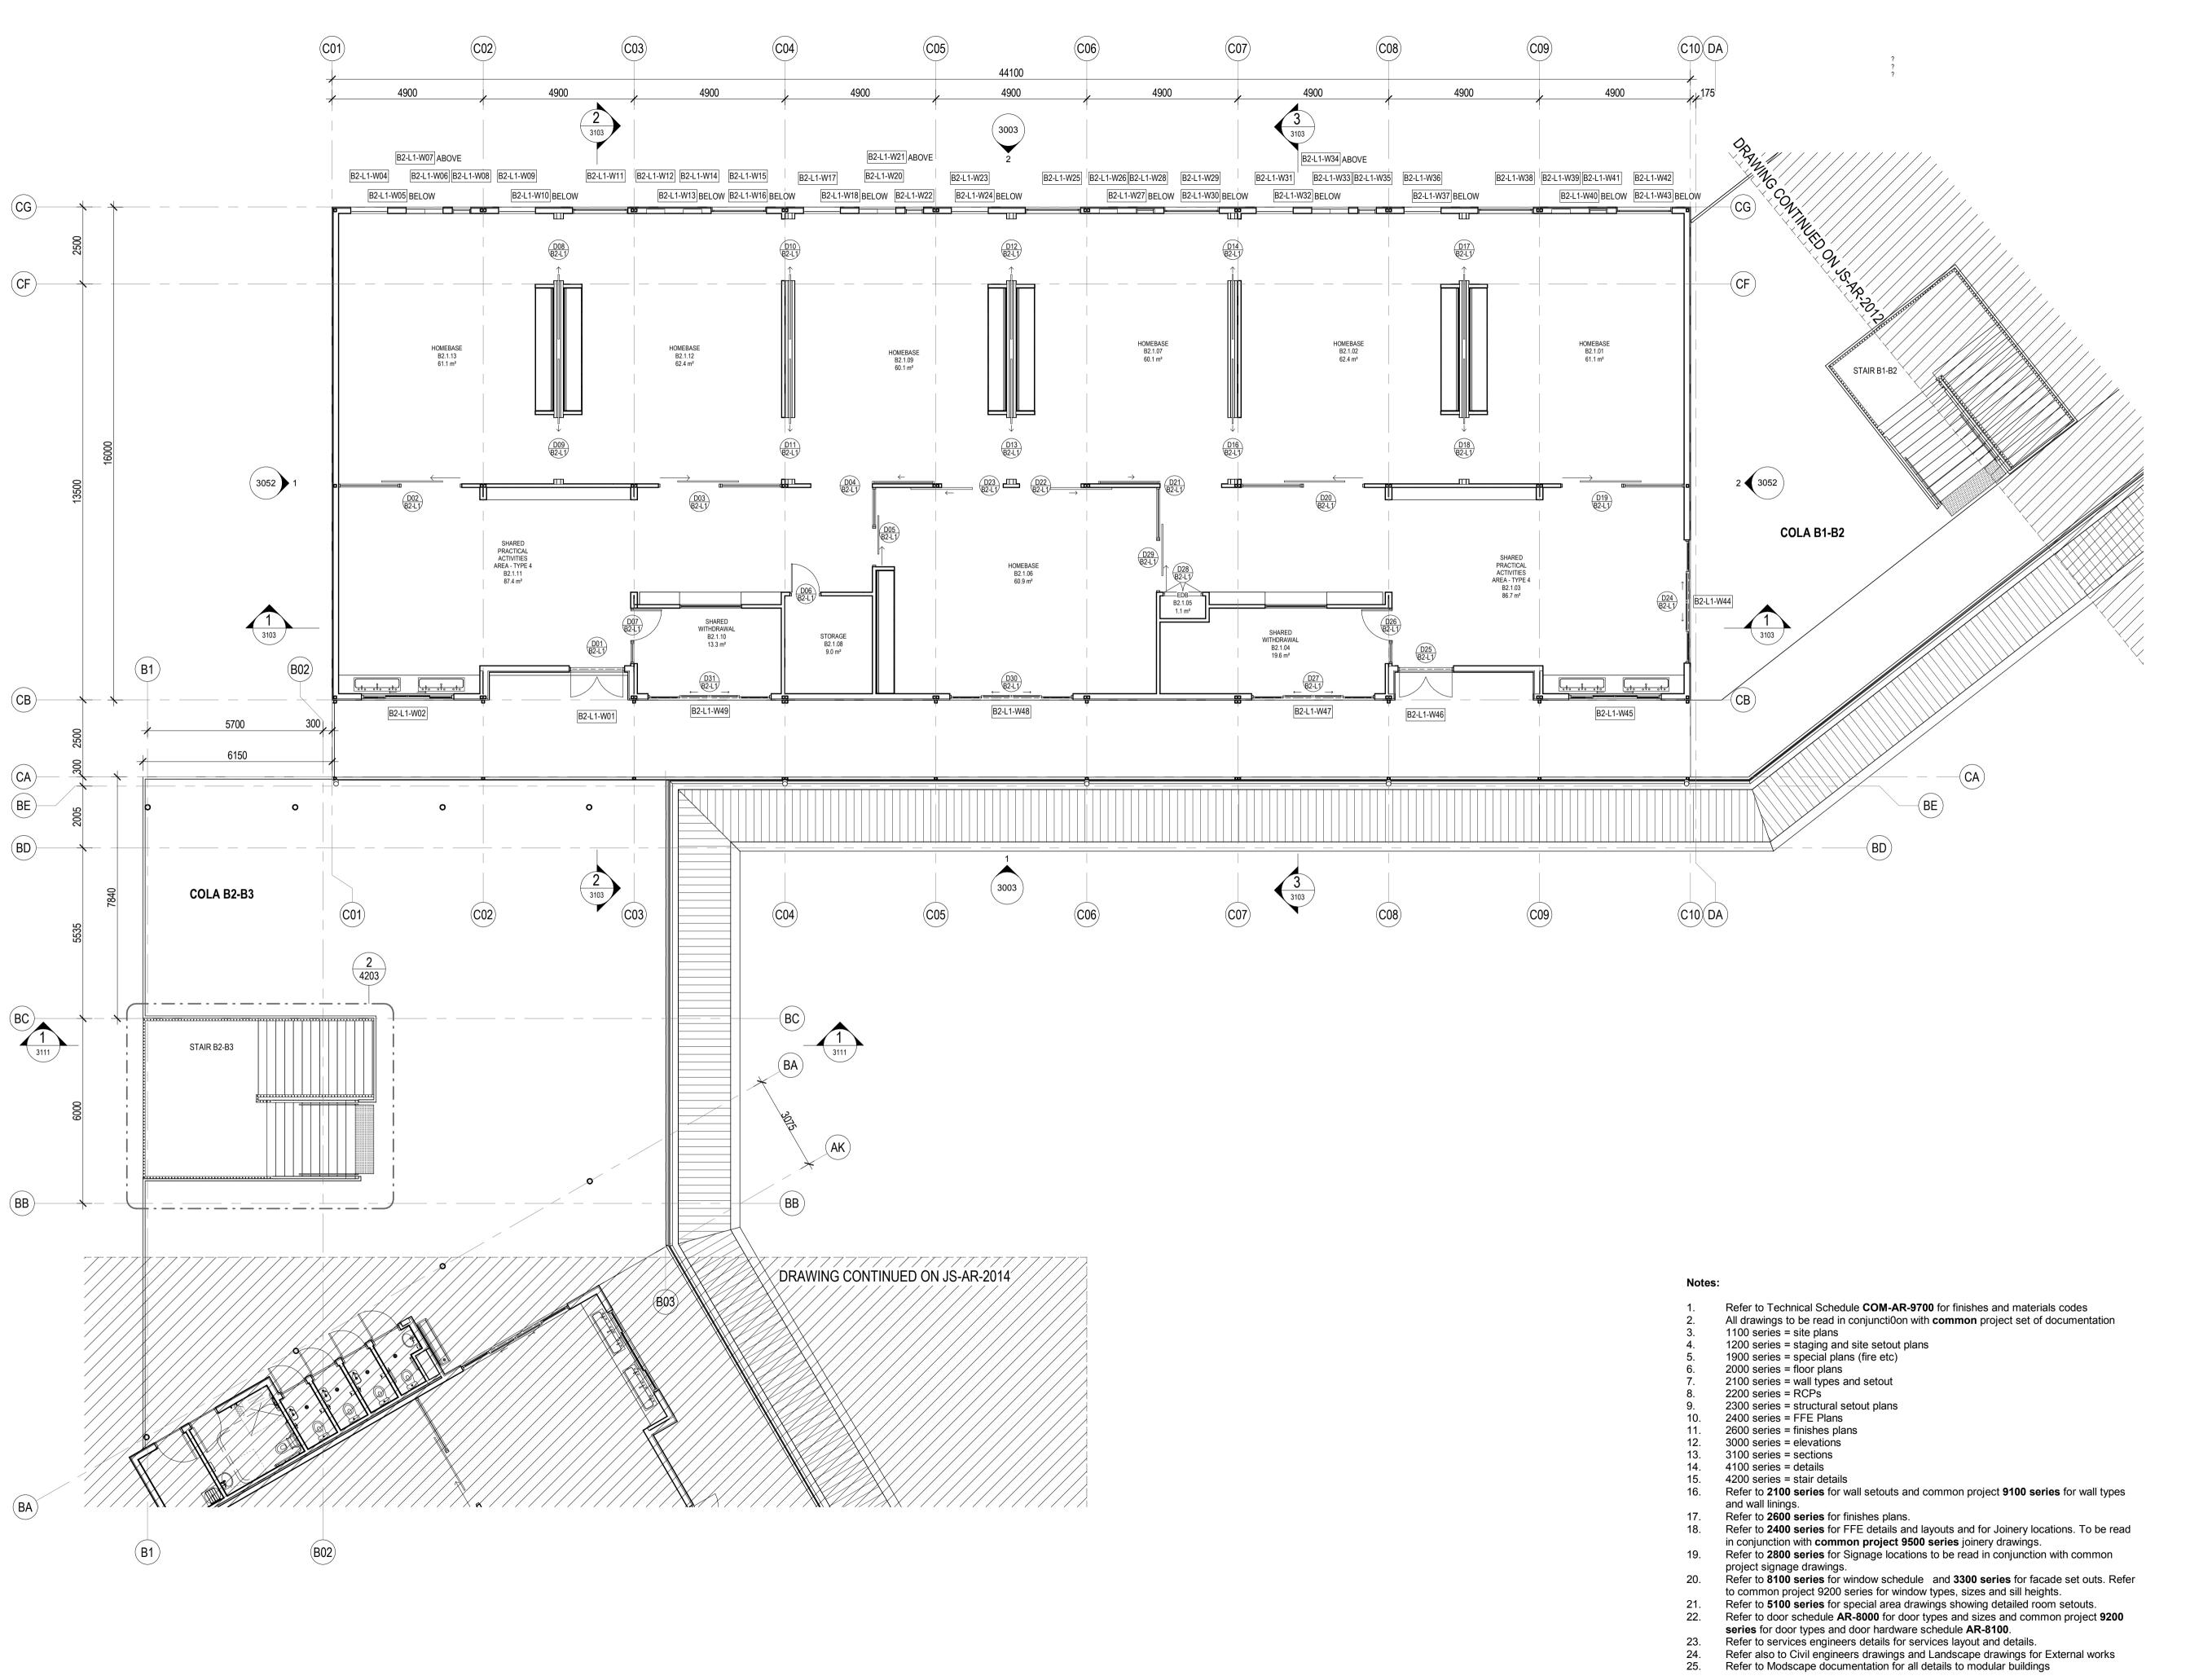

General Notes:

1. This drawing is the copyright of Group GSA Pty Ltd and may not be altered, reproduced or transmitted in any form or by any means in part or in whole without the written permission of Group GSA

Drawings to be printed in colour.
 Do not scale drawings. Dimensions govern.
 All dimensions are in millimetres unless noted otherwise.
 All dimensions shall be verified on site before proceeding
 Any areas indicated on this sheet are approximate and indicative only.

 Amendments

 Issue
 Description
 Date

 A
 FOR COORDINATION
 27.03.2019

 B
 DRAFT DETAILED DESIGN
 24.04.2019

 C
 DRAFT DETAIL DESIGN
 01.05.2019

 D
 PROGRESS ISSUE
 10.05.2019

 E
 SSD SUBMISSION
 31.05.2019

Door number

W01 Window number

Detail callout

GF-001 Room number

L01 Louvre number

0240 Internal elevation

External elevation

External elevation

RICHARD CROOKES

CONSTRUCTIONS



Group GSA Pty Ltd ABN 76 002 113 779 Level 7, 80 William St East Sydney NSW Australia 2011

www.groupgsa.com T +612 9361 4144 F +612 9332 3458

architecture interior design urban design landscape nom architect M. Sheldon 3990


1

JORDAN SPRINGS
PUBLIC SCHOOL

FLOOR PLAN - L1 -BLOCK B2 - PART 4

1			
Scale @ A1		As indicated	
Drawing Created (date)	10/05/19	
Drawing Created (by)		FC	
Plotted and checked b	у	FT	
Verified		MP	ΡM
Approved		MB	_
Project No	Drawing No	Issue	019 3:38:39

180646 JS-AR-2013 E

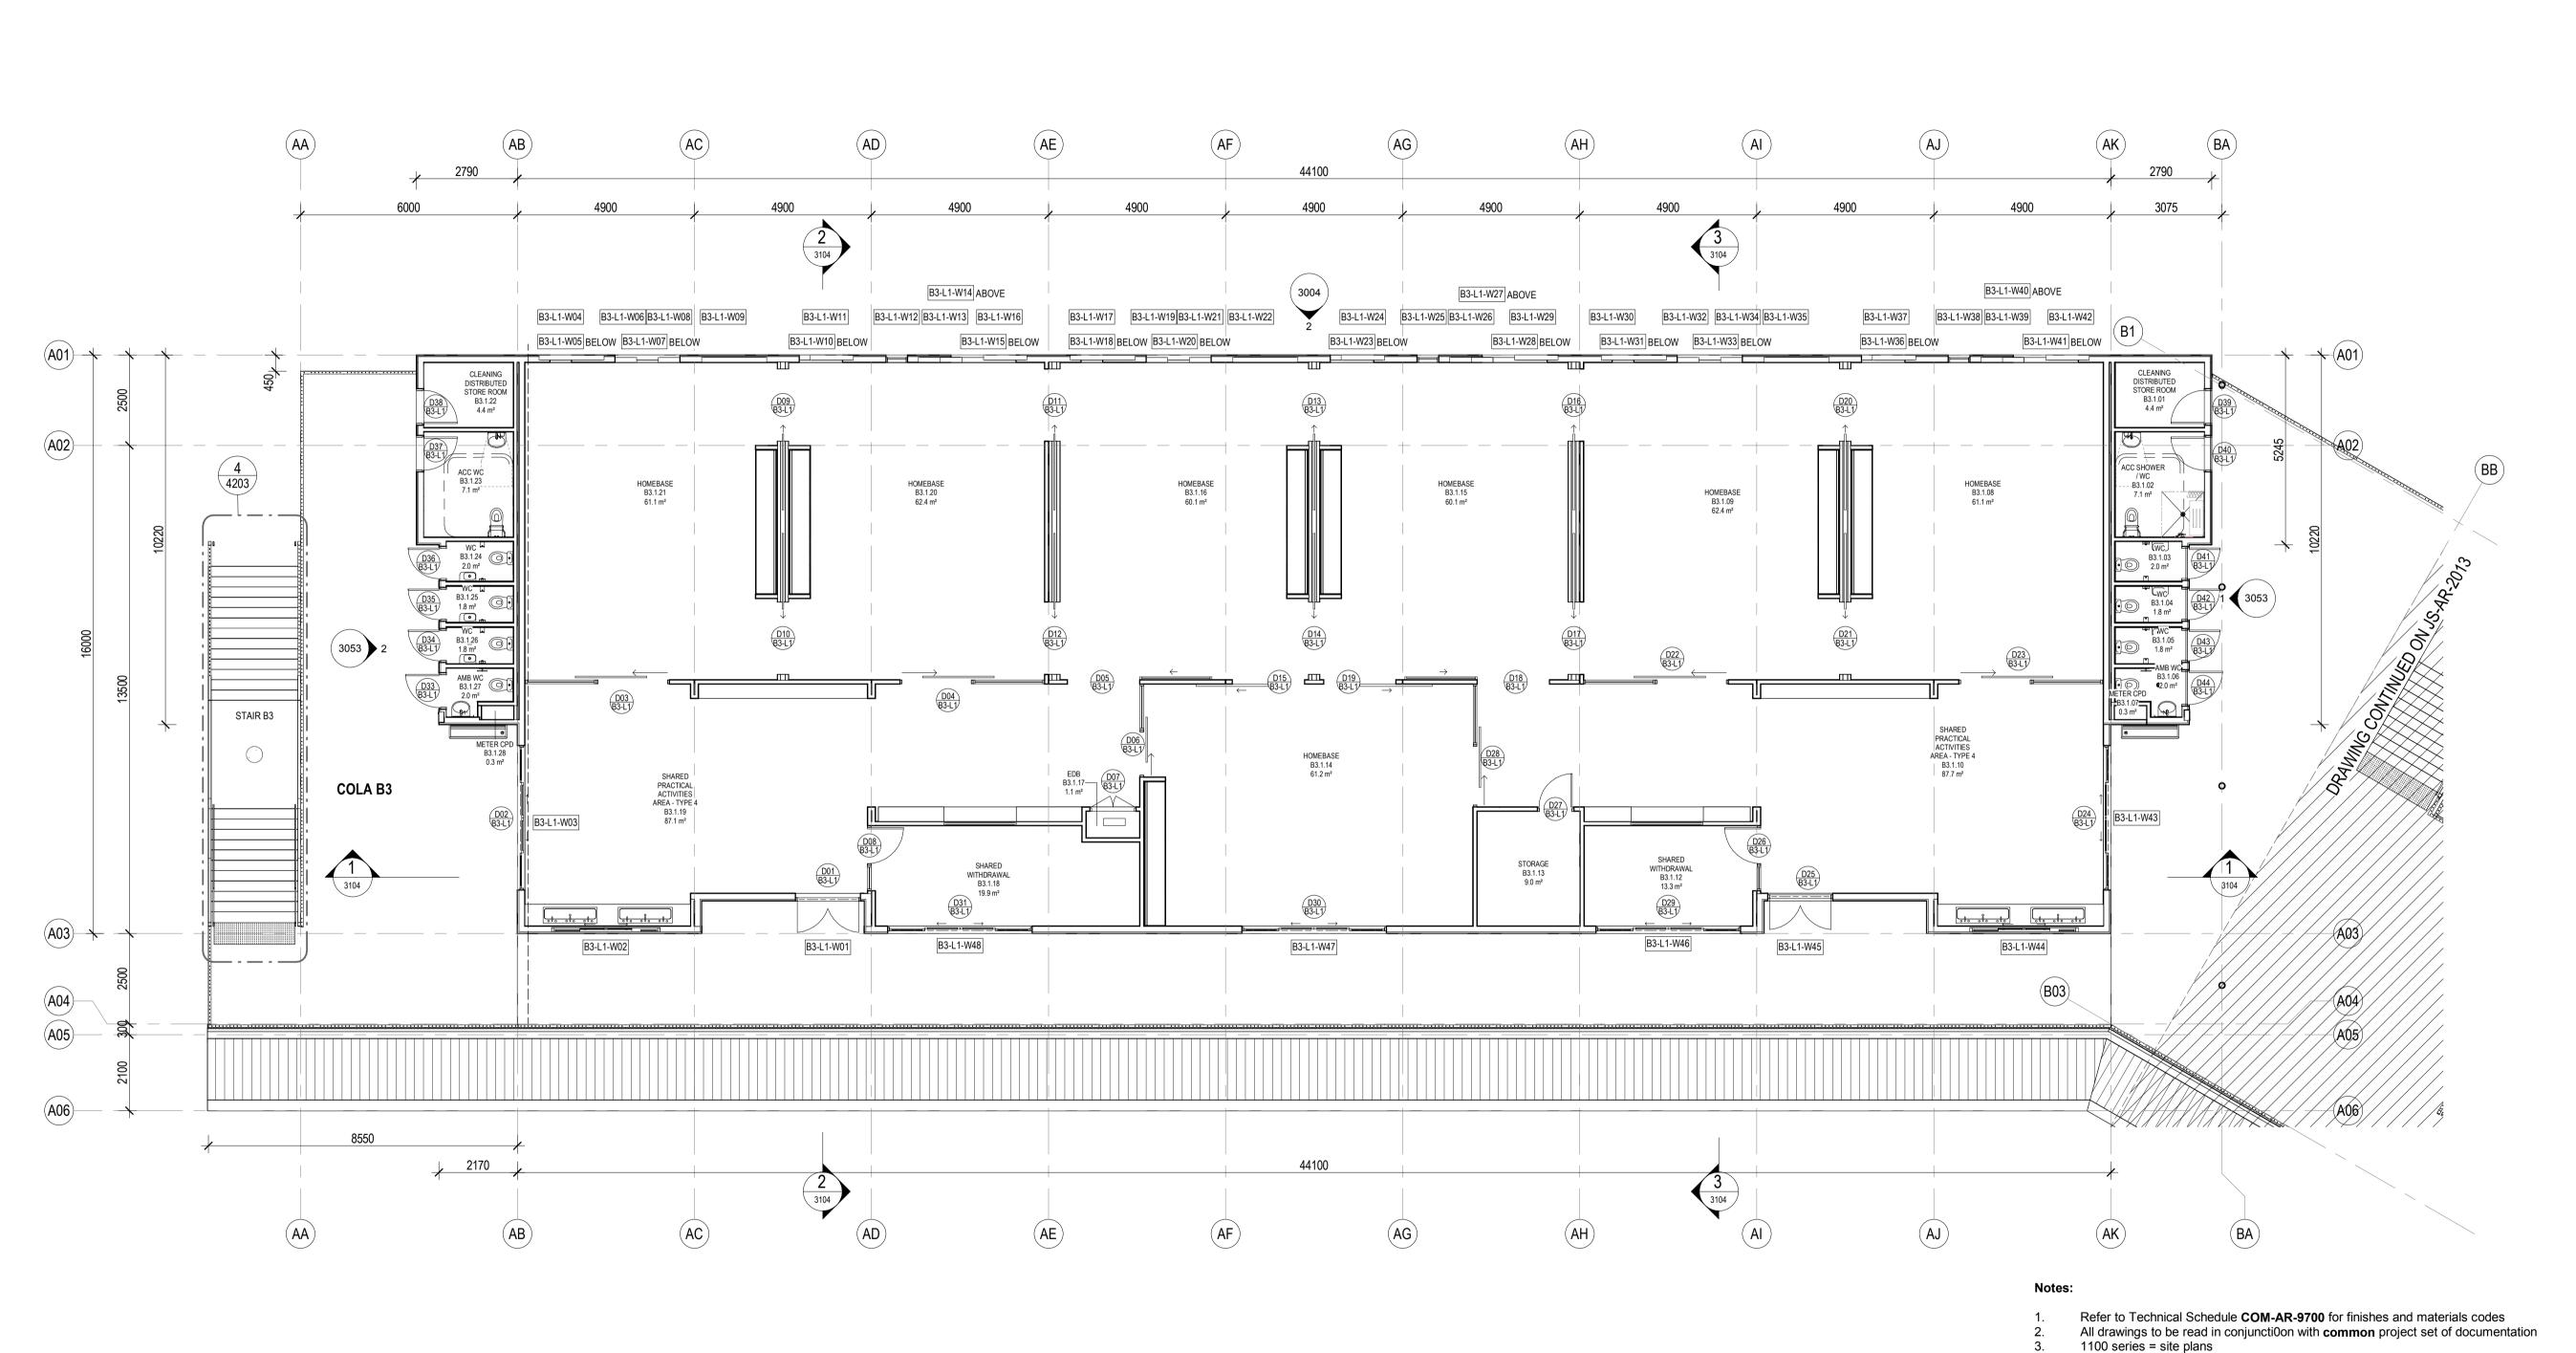

This drawing is the copyright of Group GSA Pty Ltd and may not be altered, reproduced or transmitted in any form or by any means in part or in whole without the written permission of Group GSA
 Drawings to be printed in colour.
 Do not scale drawings. Dimensions govern.
 All dimensions are in millimetres unless noted otherwise.
 All dimensions shall be verified on site before proceeding
 Any areas indicated on this sheet are approximate and indicative only.

 Amendments
 Issue
 Description
 Date


 A
 FOR COORDINATION
 27.03.2019

 B
 DRAFT DETAILED DESIGN
 24.04.2019

 C
 DRAFT DETAIL DESIGN
 01.05.2019

 D
 PROGRESS ISSUE
 10.05.2019

 E
 SSD SUBMISSION
 31.05.2019

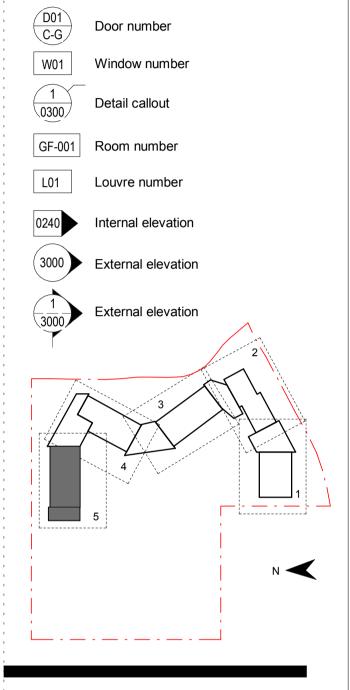







www.groupgsa.com

Drawing Title

1200 series = staging and site setout plans

Refer to **2100 series** for wall setouts and common project **9100 series** for wall types

Refer to **2400 series** for FFE details and layouts and for Joinery locations. To be read

Refer to 8100 series for window schedule and 3300 series for facade set outs. Refer

Refer to 2800 series for Signage locations to be read in conjunction with common

Refer also to Civil engineers drawings and Landscape drawings for External works

in conjunction with **common project 9500 series** joinery drawings.

series for door types and door hardware schedule AR-8100.
Refer to services engineers details for services layout and details.

to common project 9200 series for window types, sizes and sill heights.

Refer to **5100 series** for special area drawings showing detailed room setouts.

Refer to door schedule **AR-8000** for door types and sizes and common project **9200**

Refer to Modscape documentation for all details to modular buildings

1900 series = special plans (fire etc)

2100 series = wall types and setout

2300 series = structural setout plans

Refer to **2600 series** for finishes plans.

2000 series = floor plans

2400 series = FFE Plans

3000 series = elevations 3100 series = sections 4100 series = details 4200 series = stair details

project signage drawings.

2600 series = finishes plans

2200 series = RCPs

and wall linings.


T +612 9361 4144 F +612 9332 3458

architecture interior design urban design landscape nom architect M. Sheldon 3990

JORDAN SPRINGS PUBLIC SCHOOL

FLOOR PLAN - L1 -BLOCK B3 - PART 5

Scale @ A1 A	s indicated
Drawing Created (date)	10/05/19
Drawing Created (by)	FC
Plotted and checked by	FT
Verified	MP ≥
Approved	MB 8:47 P
Project No Drawing No	1ssue 6. 8:3
180646 JS-AR-2014	MB lss ue L731/2016 3:38:47

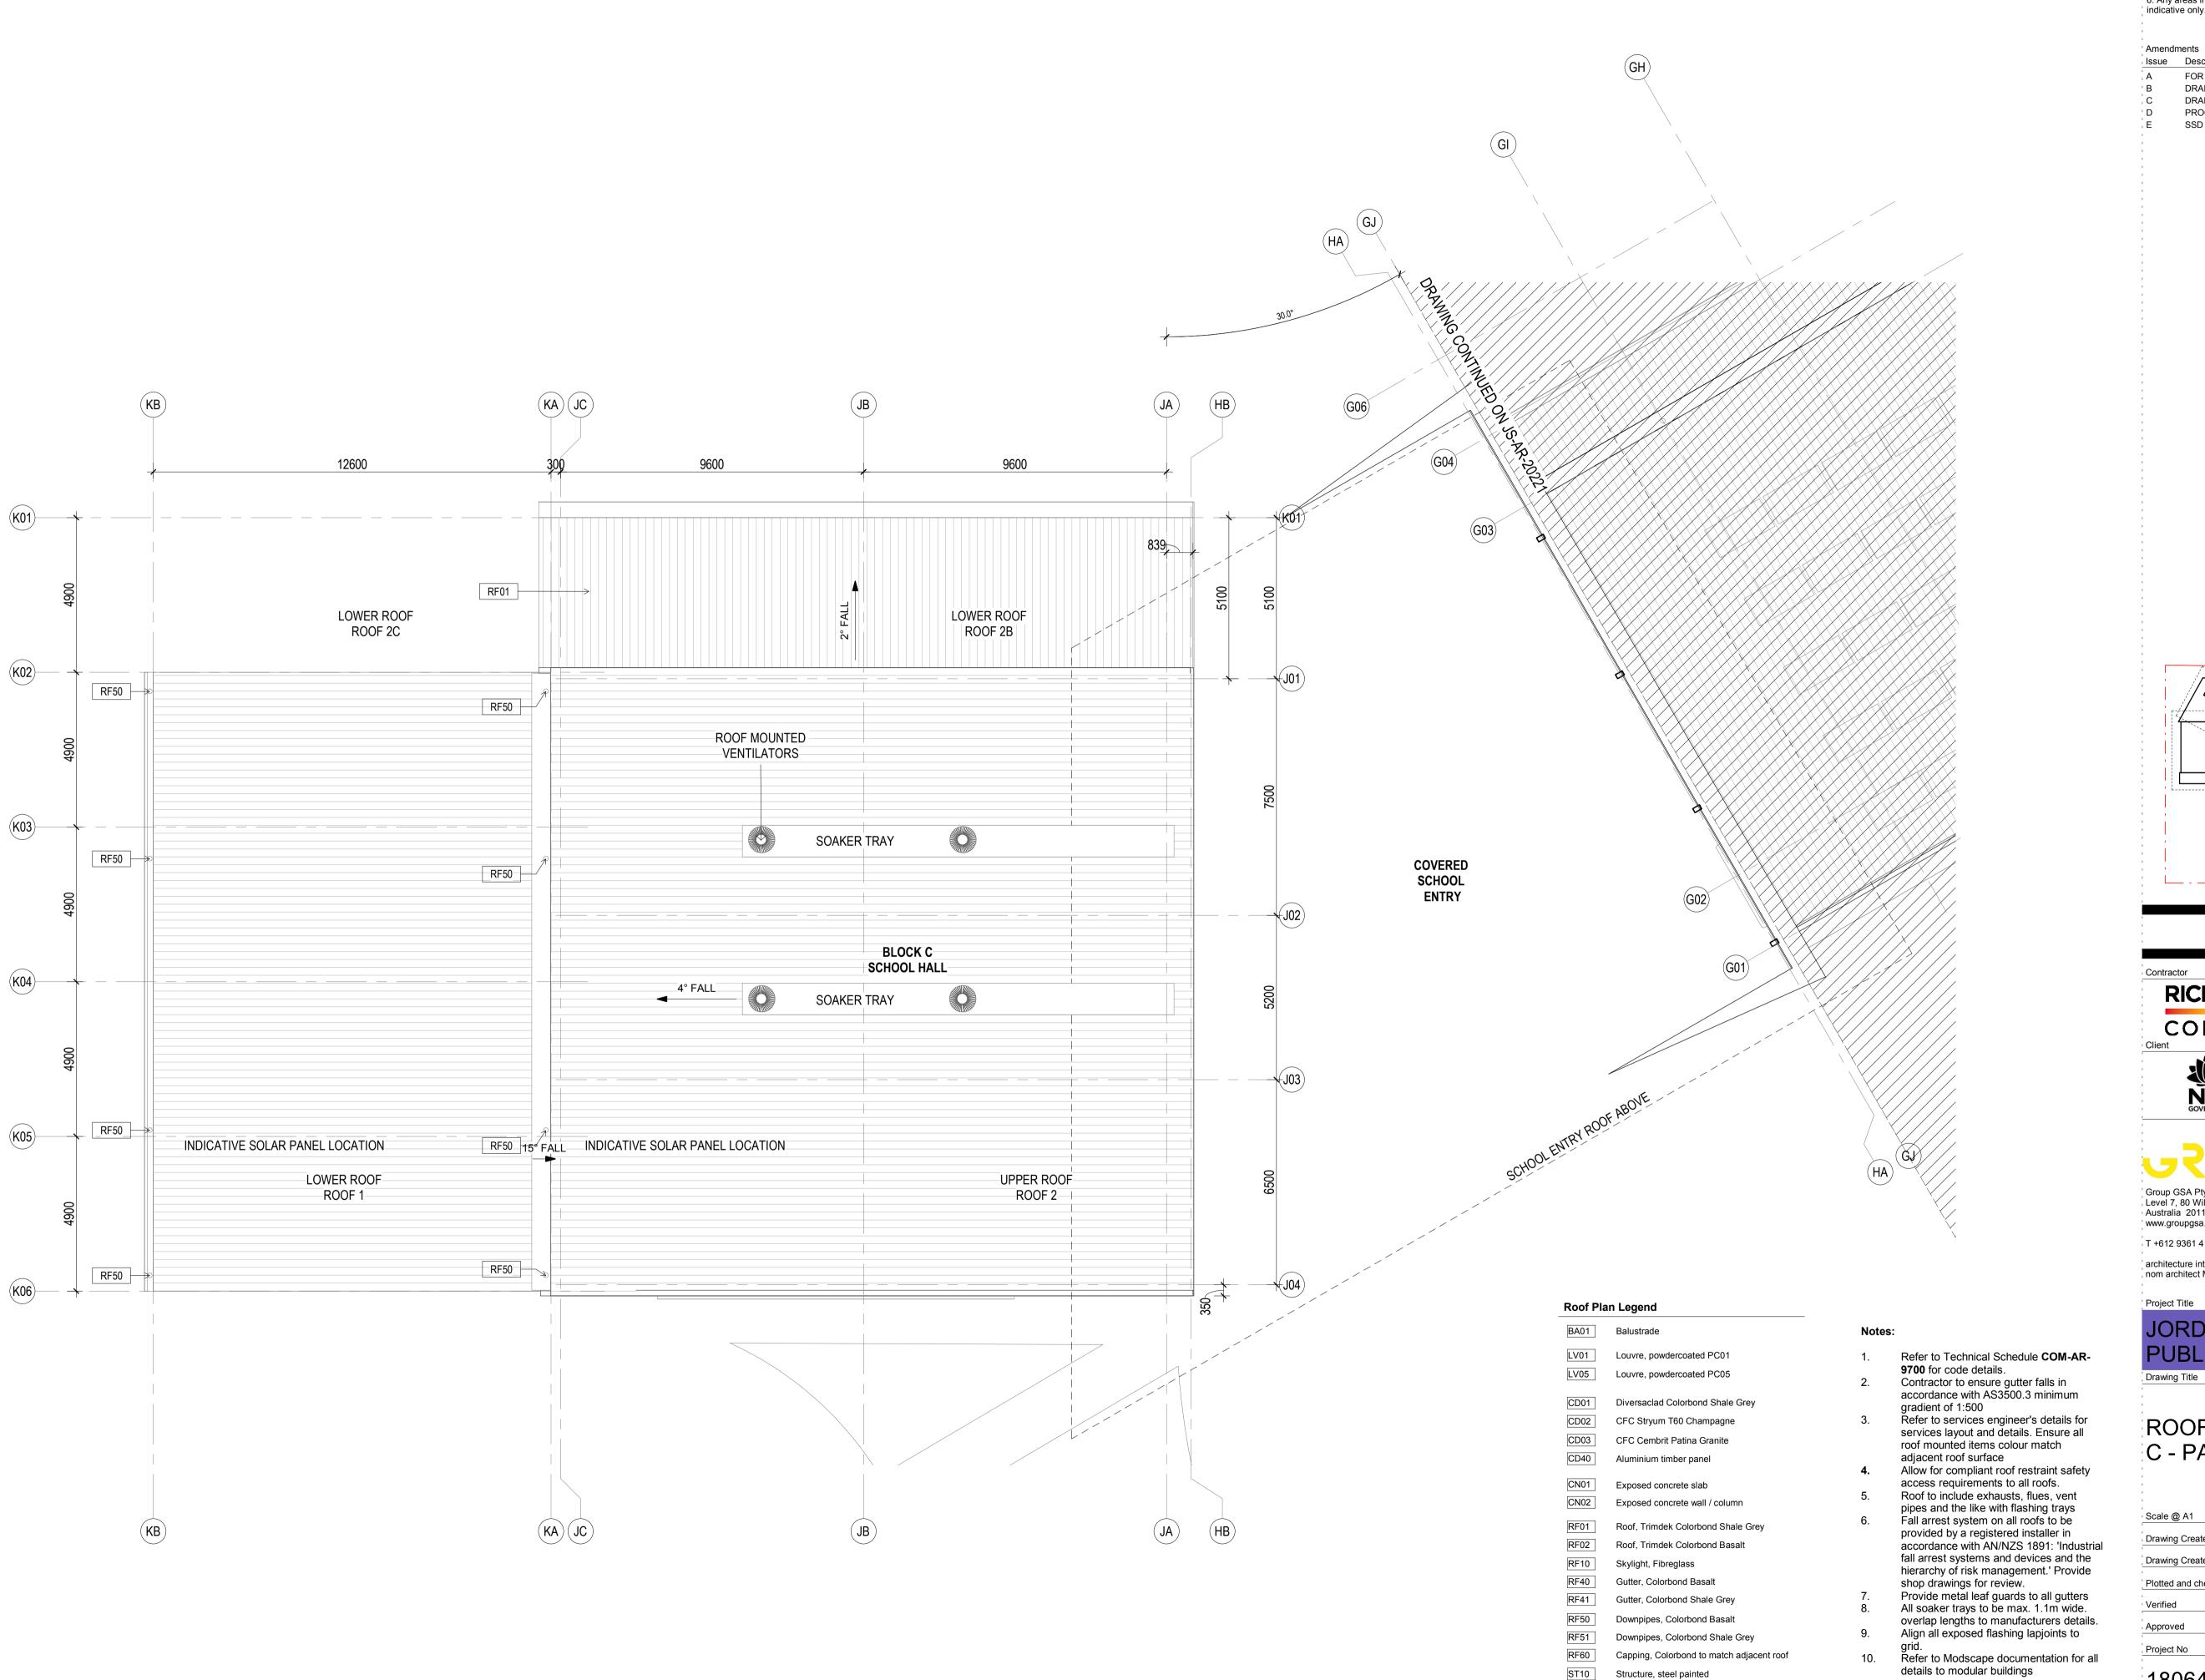

K01

K03

K04


K05

K06

1. This drawing is the copyright of Group GSA Pty Ltd and may not be altered, reproduced or transmitted in any form or by any means in part or in whole without the written permission of Group GSA

2. Drawings to be printed in colour.3. Do not scale drawings. Dimensions govern.4. All dimensions are in millimetres unless noted otherwise. 5. All dimensions shall be verified on site before proceeding
6. Any areas indicated on this sheet are approximate and indicative only.

Amend	ments	
Issue	Description	Date
Α	FOR COORDINATION	27.03.20
В	DRAFT DETAILED DESIGN	10.04.20
С	DRAFT DETAILED DESIGN	17.04.20
D	PROGRESS ISSUE	10.05.20
E	SSD SUBMISSION	31.05.20

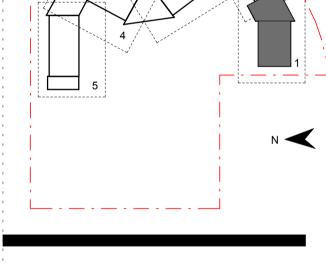

RICHARD CROOKES CONSTRUCTIONS





www.groupgsa.com


T +612 9361 4144 F +612 9332 3458

architecture interior design urban design landscape nom architect M. Sheldon 3990

Project Title JORDAN SPRINGS **PUBLIC SCHOOL**

ROOF PLAN - BLOCK C - PART 1


ı		
Scale @ A1	1:100	
Drawing Created (date)	10/05/19	
Drawing Created (by)	NS	
Plotted and checked by	FT	
Verified	MP	Σ
Approved	MB	8:53 F
Project No Drawing No	Issue	/31/2019 3:38:53
180646 JS-AR-2020	Ε	5/31/20

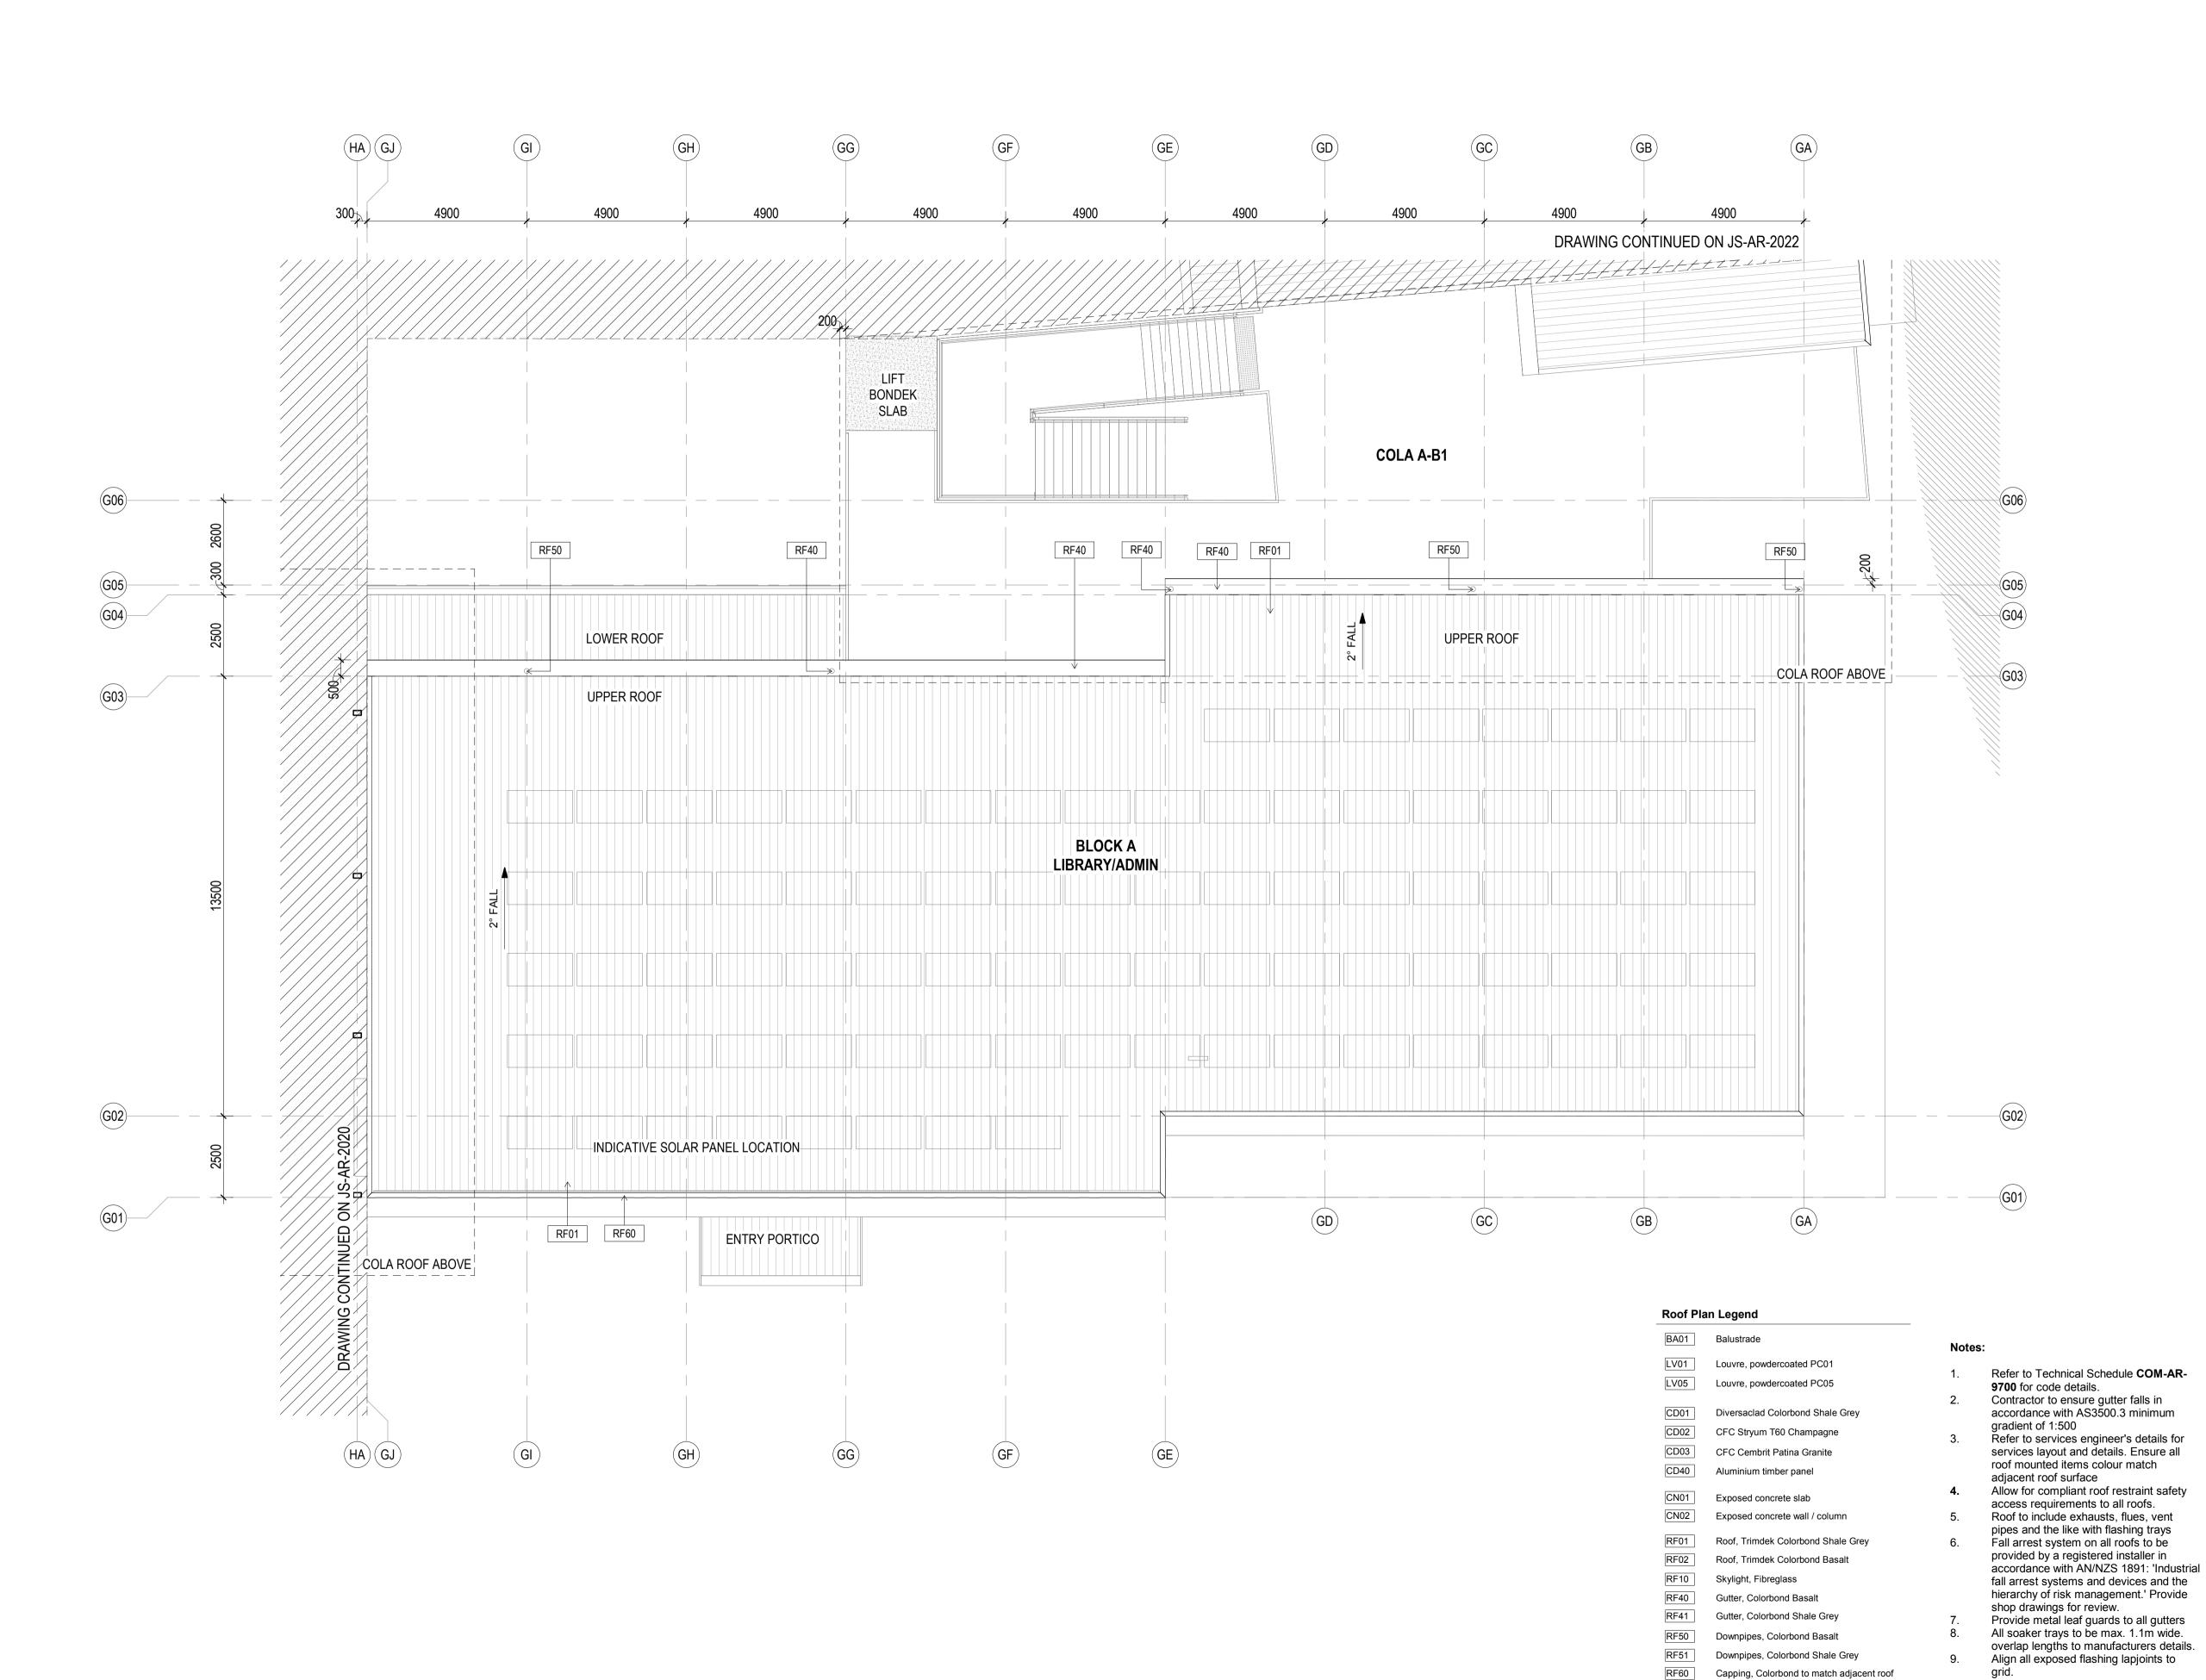

1. This drawing is the copyright of Group GSA Pty Ltd and may not be altered, reproduced or transmitted in any form or by any means in part or in whole without the written permission of Group GSA 2. Drawings to be printed in colour.3. Do not scale drawings. Dimensions govern.

4. All dimensions are in millimetres unless noted otherwise. 5. All dimensions shall be verified on site before proceeding
6. Any areas indicated on this sheet are approximate and indicative only.

nendn	nents	
sue	Description	Date
	FOR COORDINATION	27.03.2019
	DRAFT DETAILED DESIGN	17.04.2019
	PROGRESS ISSUE	10.05.2019
	SSD SUBMISSION	31.05.2019

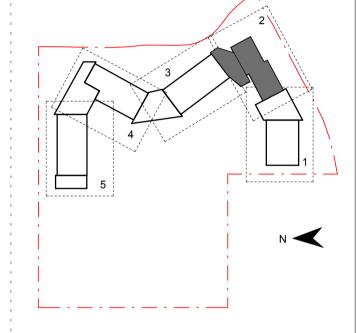







www.groupgsa.com

T +612 9361 4144 F +612 9332 3458 architecture interior design urban design landscape nom architect M. Sheldon 3990

Drawing Title

Refer to Modscape documentation for all


details to modular buildings

Structure, steel painted

Project Title JORDAN SPRINGS **PUBLIC SCHOOL**

ROOF PLAN - BLOCK A - PART 2

180646	JS-AR-2021	MB Issue D
Project No	Drawing No	lssue _6
Approved		_
Verified		MP ≥
Plotted and checked	l by	FT
Drawing Created (by	')	NS
Drawing Created (da	ate)	10/05/19
Scale @ A1		1:100

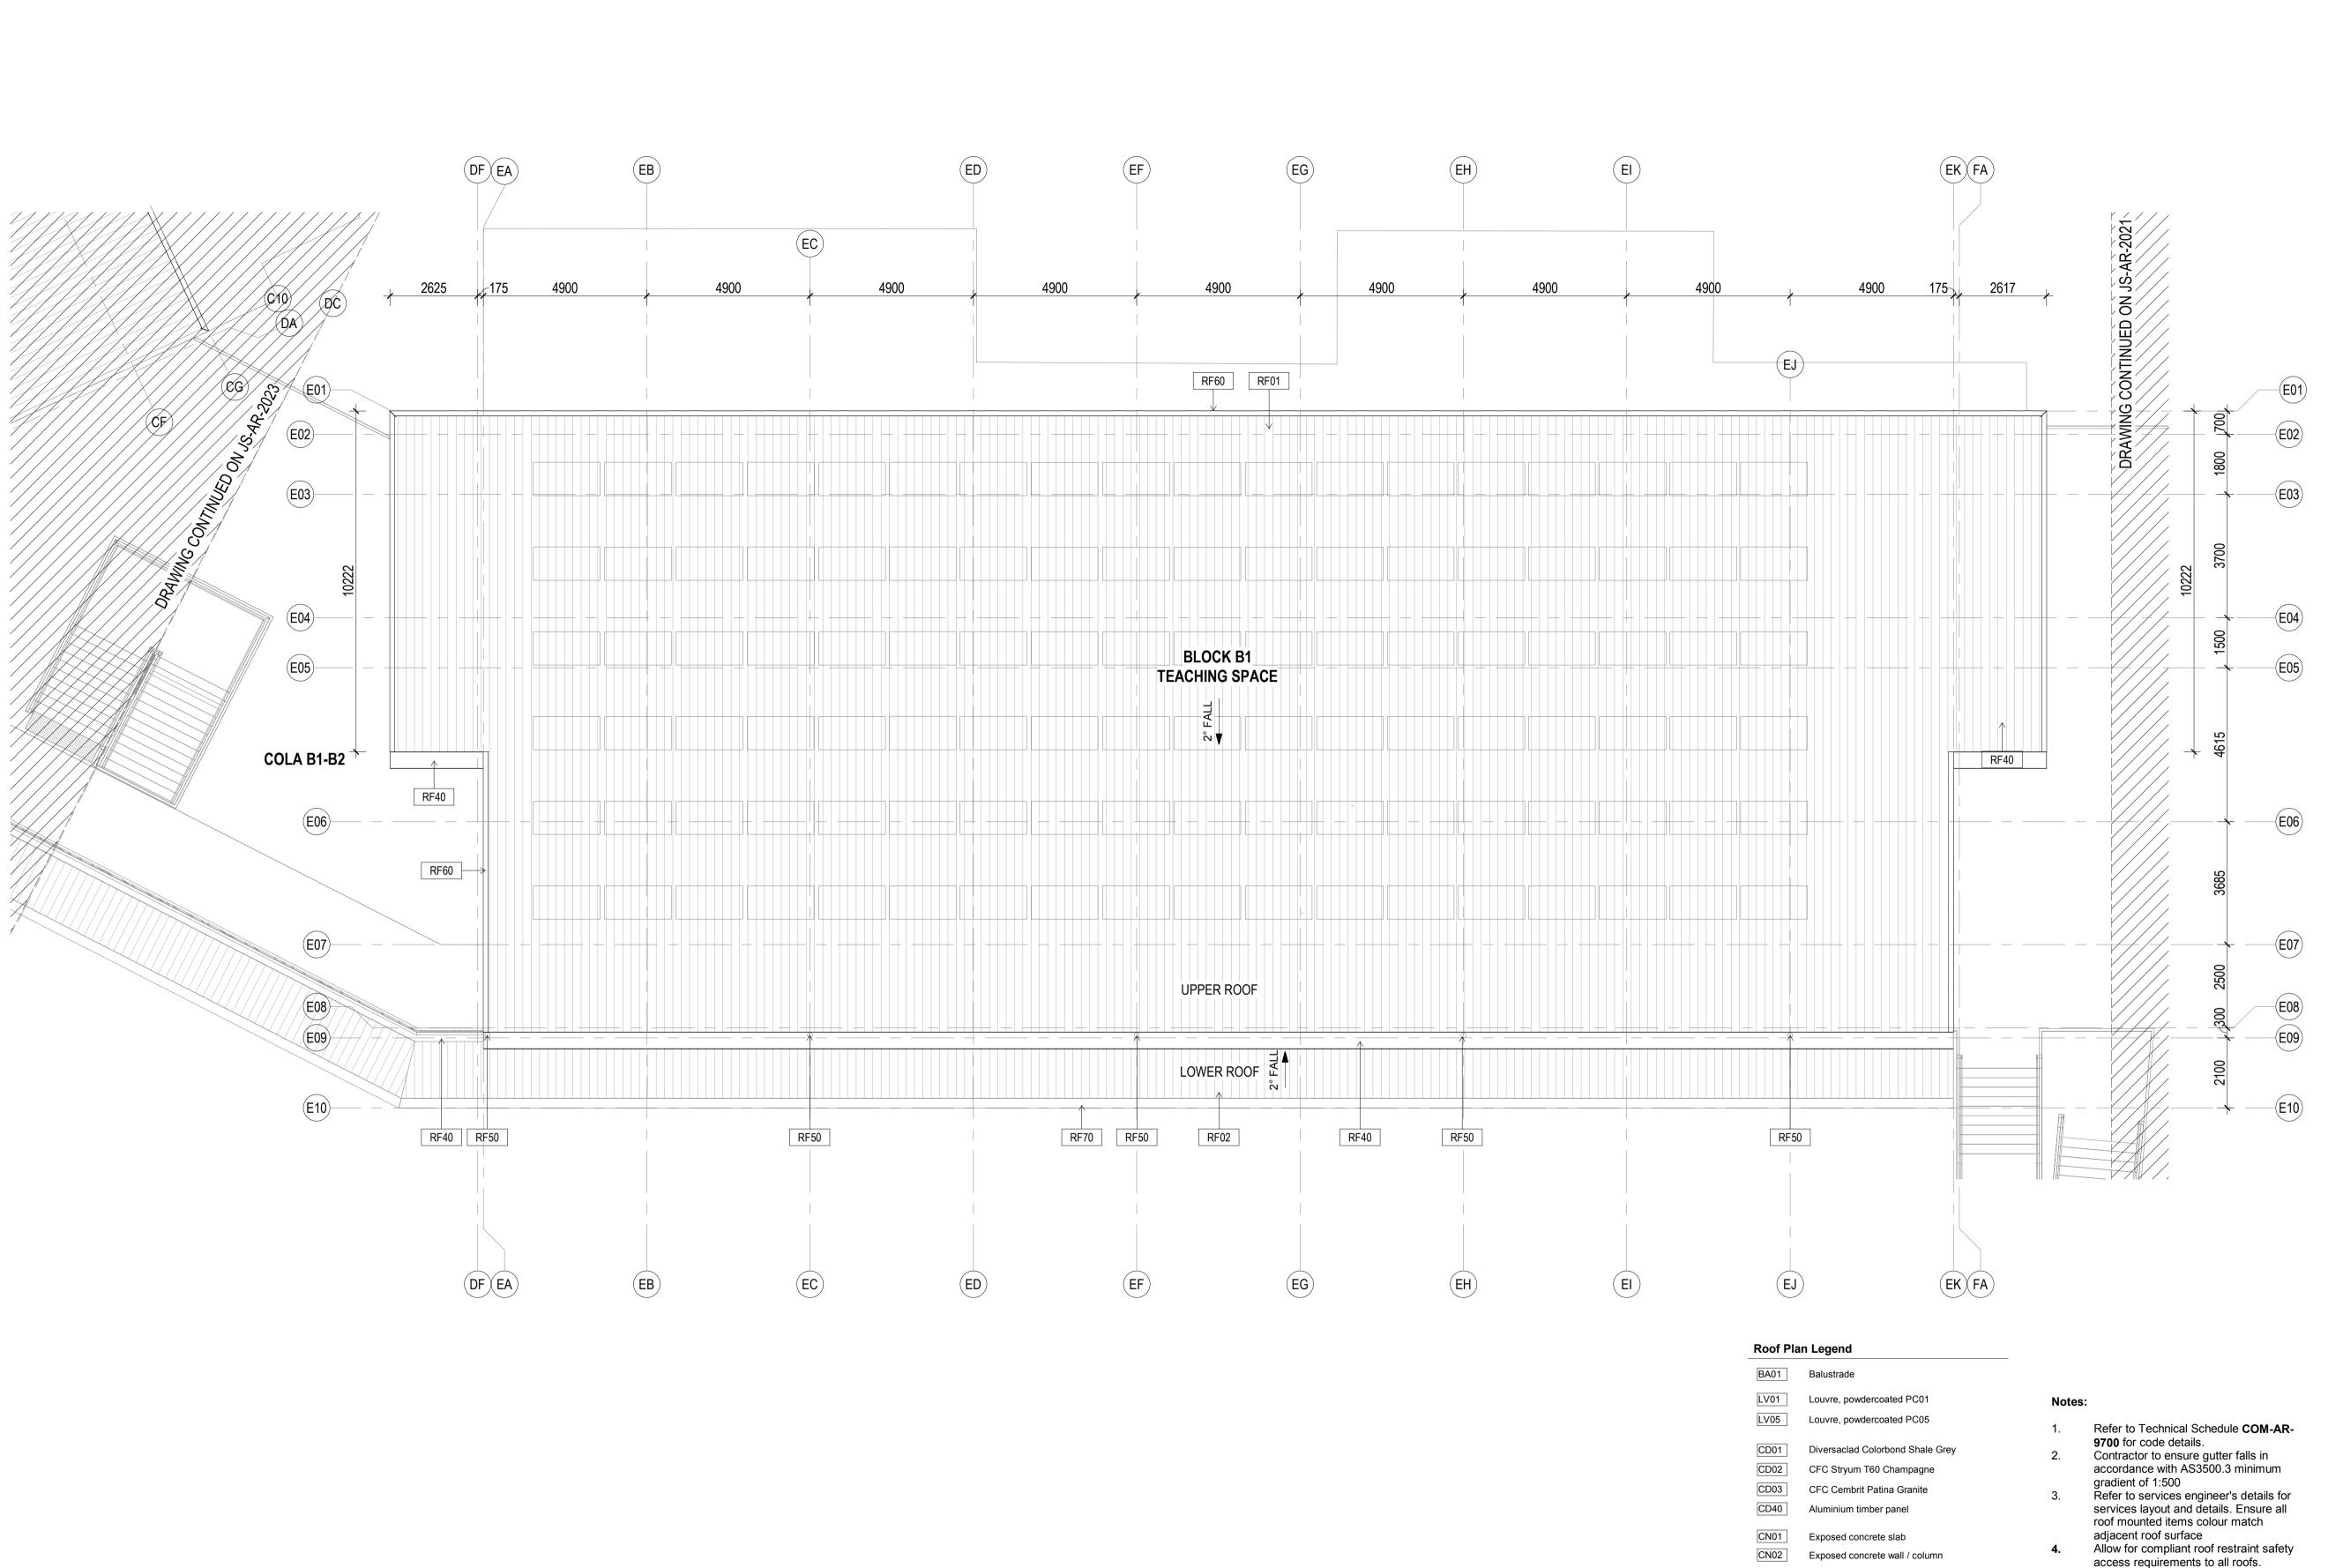

☐ General Notes:

1. This drawing is the copyright of Group GSA Pty Ltd and may not be altered, reproduced or transmitted in any form or by any means in part or in whole without the written permission of Group GSA 2. Drawings to be printed in colour.
3. Do not scale drawings. Dimensions govern.

3. Do not scale drawings. Dimensions govern.
4. All dimensions are in millimetres unless noted otherwise.
5. All dimensions shall be verified on site before proceeding
6. Any areas indicated on this sheet are approximate and indicative only.

 Amendments

 Issue
 Description
 Date

 A
 FOR COORDINATION
 27.03.2019

 B
 PROGRESS ISSUE
 10.05.2019

 C
 SSD SUBMISSION
 31.05.2019







Group GSA Pty Ltd ABN 76 002 113 779 Level 7, 80 William St East Sydney NSW Australia 2011 www.groupgsa.com

T +612 9361 4144 F +612 9332 3458

architecture interior design urban design landscape nom architect M. Sheldon 3990

Project Title

JORDAN SPRINGS

PUBLIC SCHOOL
Drawing Title

Roof to include exhausts, flues, vent

pipes and the like with flashing trays

Fall arrest system on all roofs to be provided by a registered installer in

shop drawings for review.

details to modular buildings

accordance with AN/NZS 1891: 'Industrial

fall arrest systems and devices and the hierarchy of risk management.' Provide

Provide metal leaf guards to all gutters All soaker trays to be max. 1.1m wide.

overlap lengths to manufacturers details.

Refer to Modscape documentation for all

Align all exposed flashing lapjoints to

Roof, Trimdek Colorbond Shale Grey

Roof, Trimdek Colorbond Basalt

Skylight, Fibreglass

Gutter, Colorbond Basalt

Structure, steel painted

Gutter, Colorbond Shale Grey


Downpipes, Colorbond Basalt

Downpipes, Colorbond Shale Grey

Capping, Colorbond to match adjacent roof

ROOF PLAN - BLOCK B1 - PART 3

Approved Project No	Drawing No	MB Issue	5/31/2019 3:39:12
Verified		MP	PM
Plotted and checked	by	FT	
Drawing Created (by	·)	RS	
Drawing Created (da	ite)	10/05/19	
Scale @ A1		1 : 100	

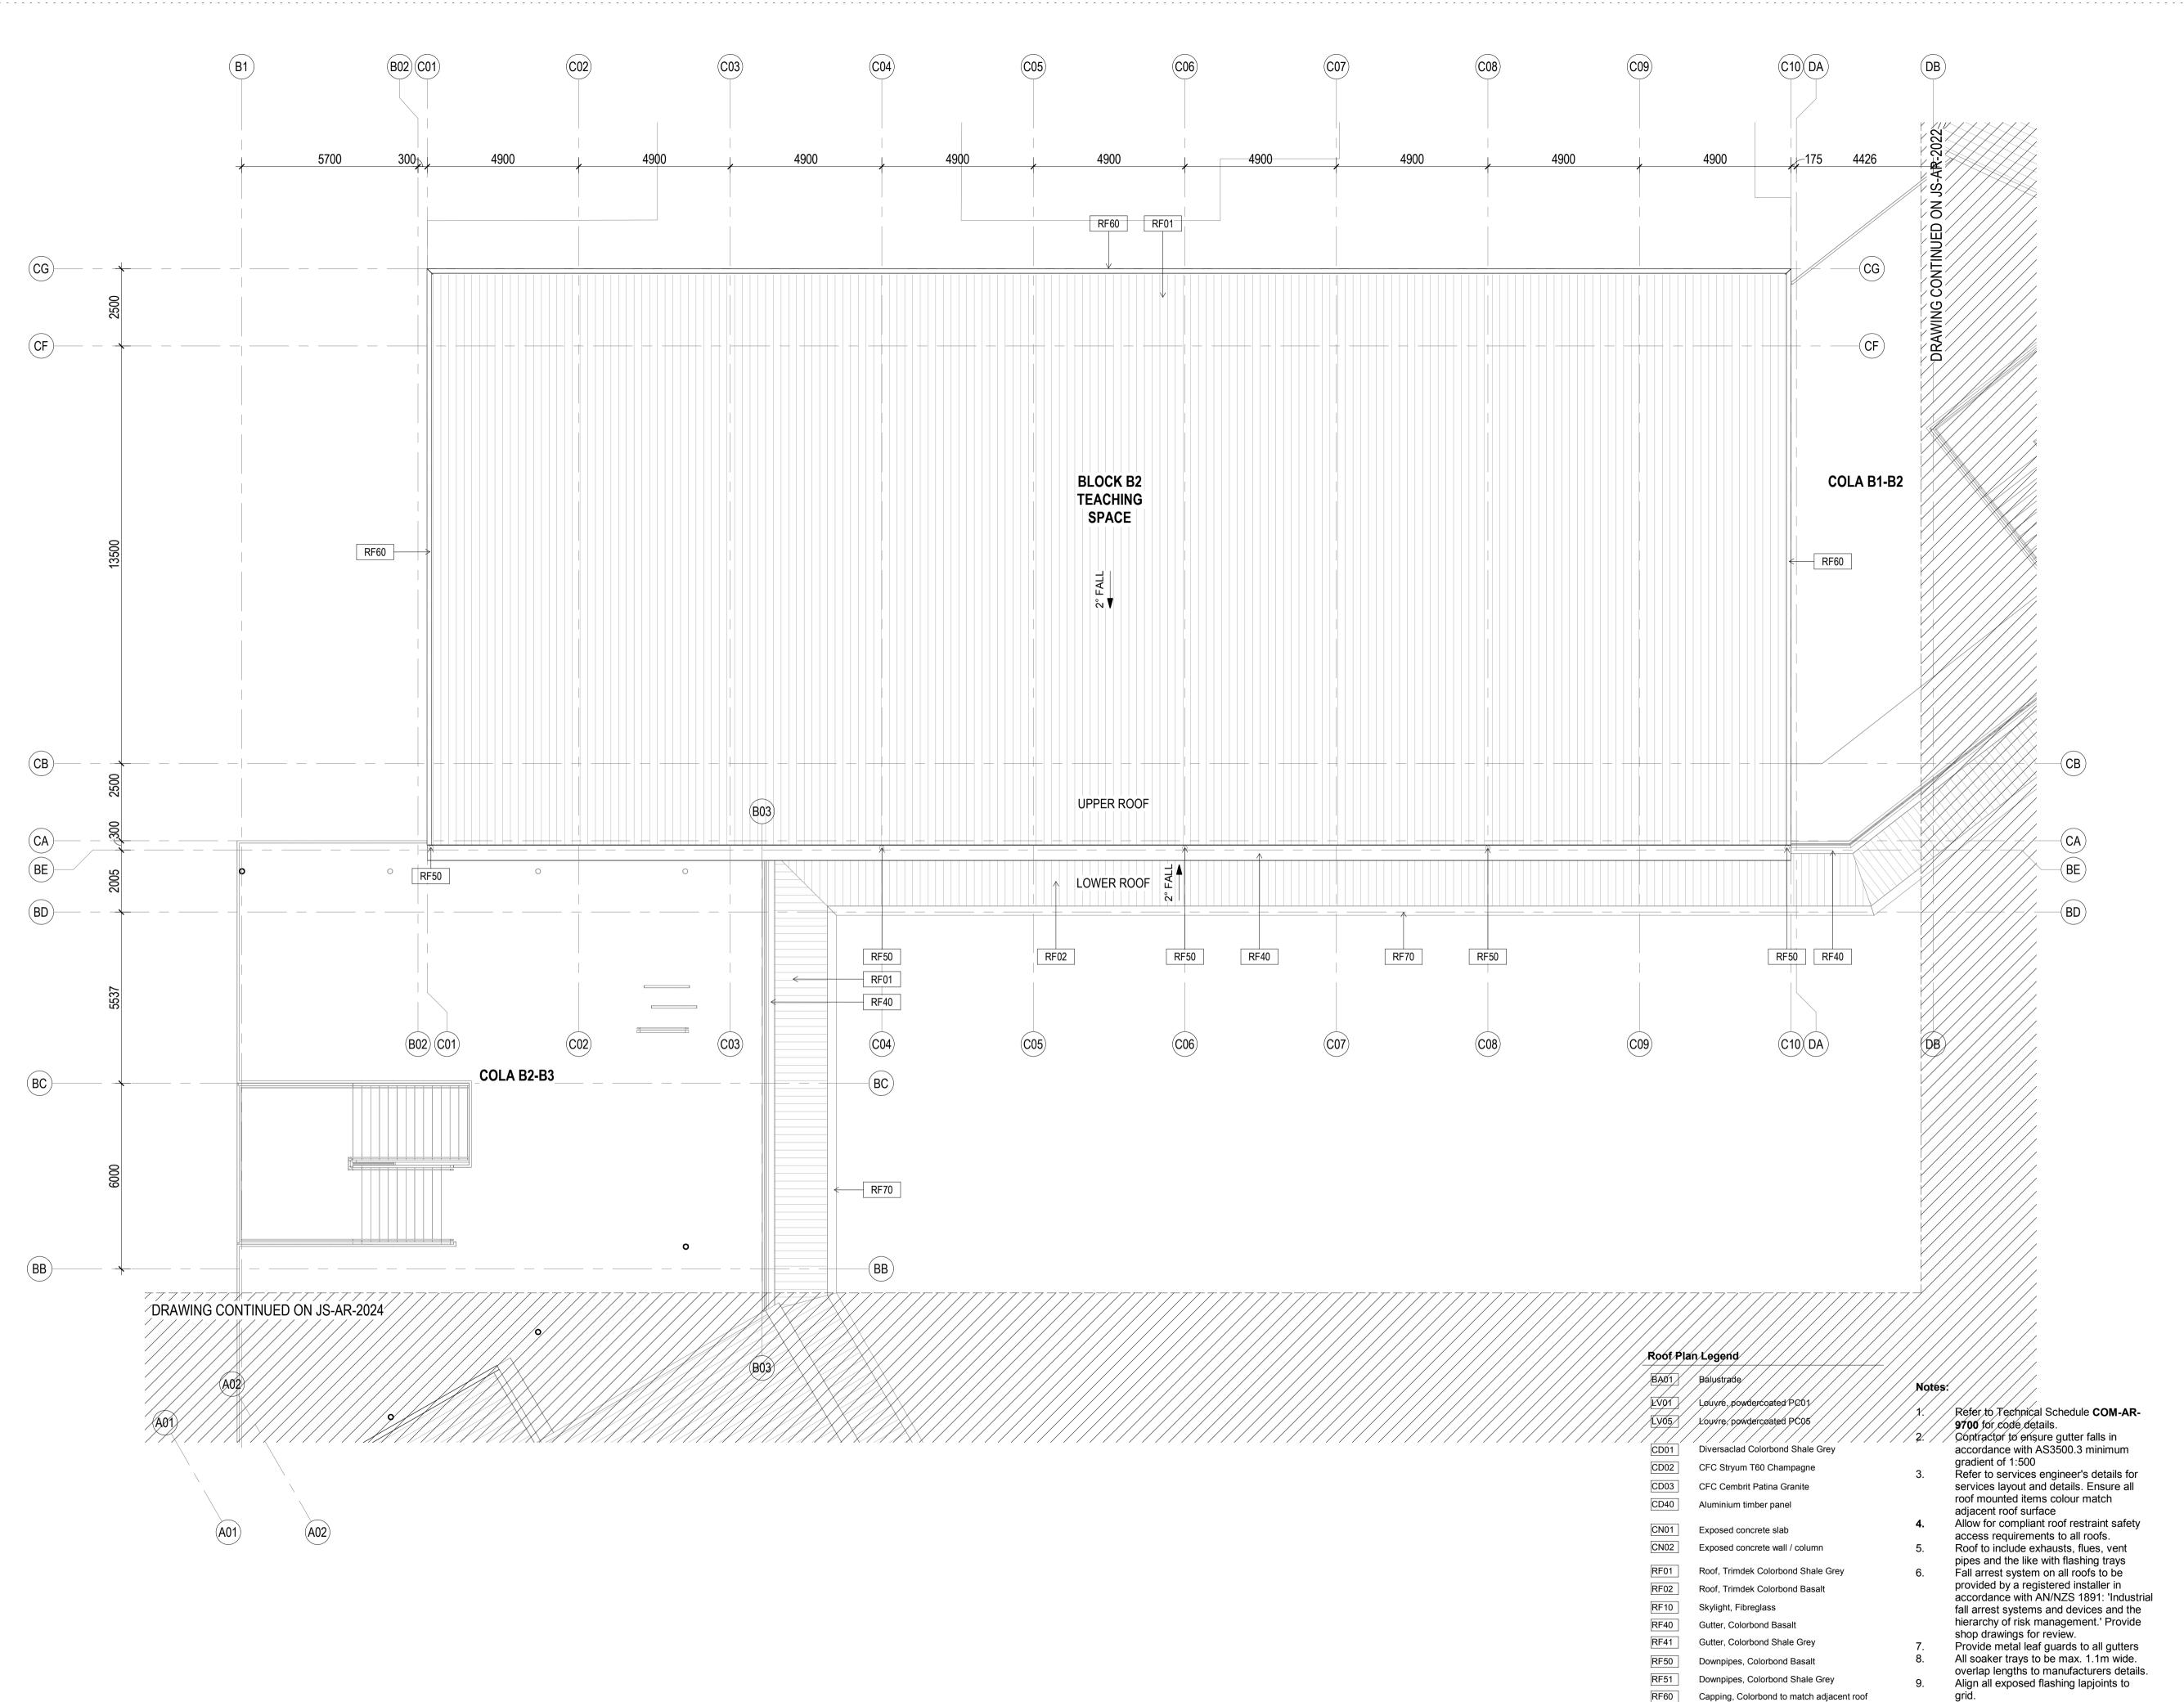


- - - ∃ General N

1. This drawing is the copyright of Group GSA Pty Ltd and may not be altered, reproduced or transmitted in any form or by any means in part or in whole without the written permission of Group GSA 2. Drawings to be printed in colour.
3. Do not scale drawings. Dimensions govern.

Drawings to be printed in colour.
 Do not scale drawings. Dimensions govern.
 All dimensions are in millimetres unless noted otherwise.
 All dimensions shall be verified on site before proceeding
 Any areas indicated on this sheet are approximate and indicative only.

Amend		
Issue	Description	Date
Α	FOR COORDINATION	27.03.2019
В	PROGRESS ISSUE	10.05.2019
С	SSD SUBMISSION	31.05.2019

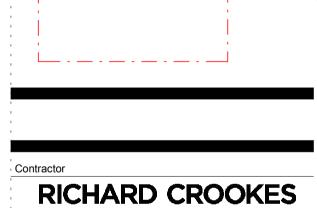



CONSTRUCTIONS



www.groupgsa.com

T +612 9361 4144 F +612 9332 3458
architecture interior design urban design landscape nom architect M. Sheldon 3990

Project Title

JORDAN SPRINGS PUBLIC SCHOOL

B2 - PART 4

Drawing Title


Refer to Modscape documentation for all

details to modular buildings

Structure, steel painted

ROOF PLAN - BLOCK

180646 JS-AR-2023	С	5/31/2019 3:39:22
Project No Drawing No	Issue	19 3:3
Approved	MB	9:22 F
Verified	MP	Σ
Plotted and checked by	FT	
Drawing Created (by)	RS	
Drawing Created (date) 1	0/05/19	
Scale @ A1	1 : 100	

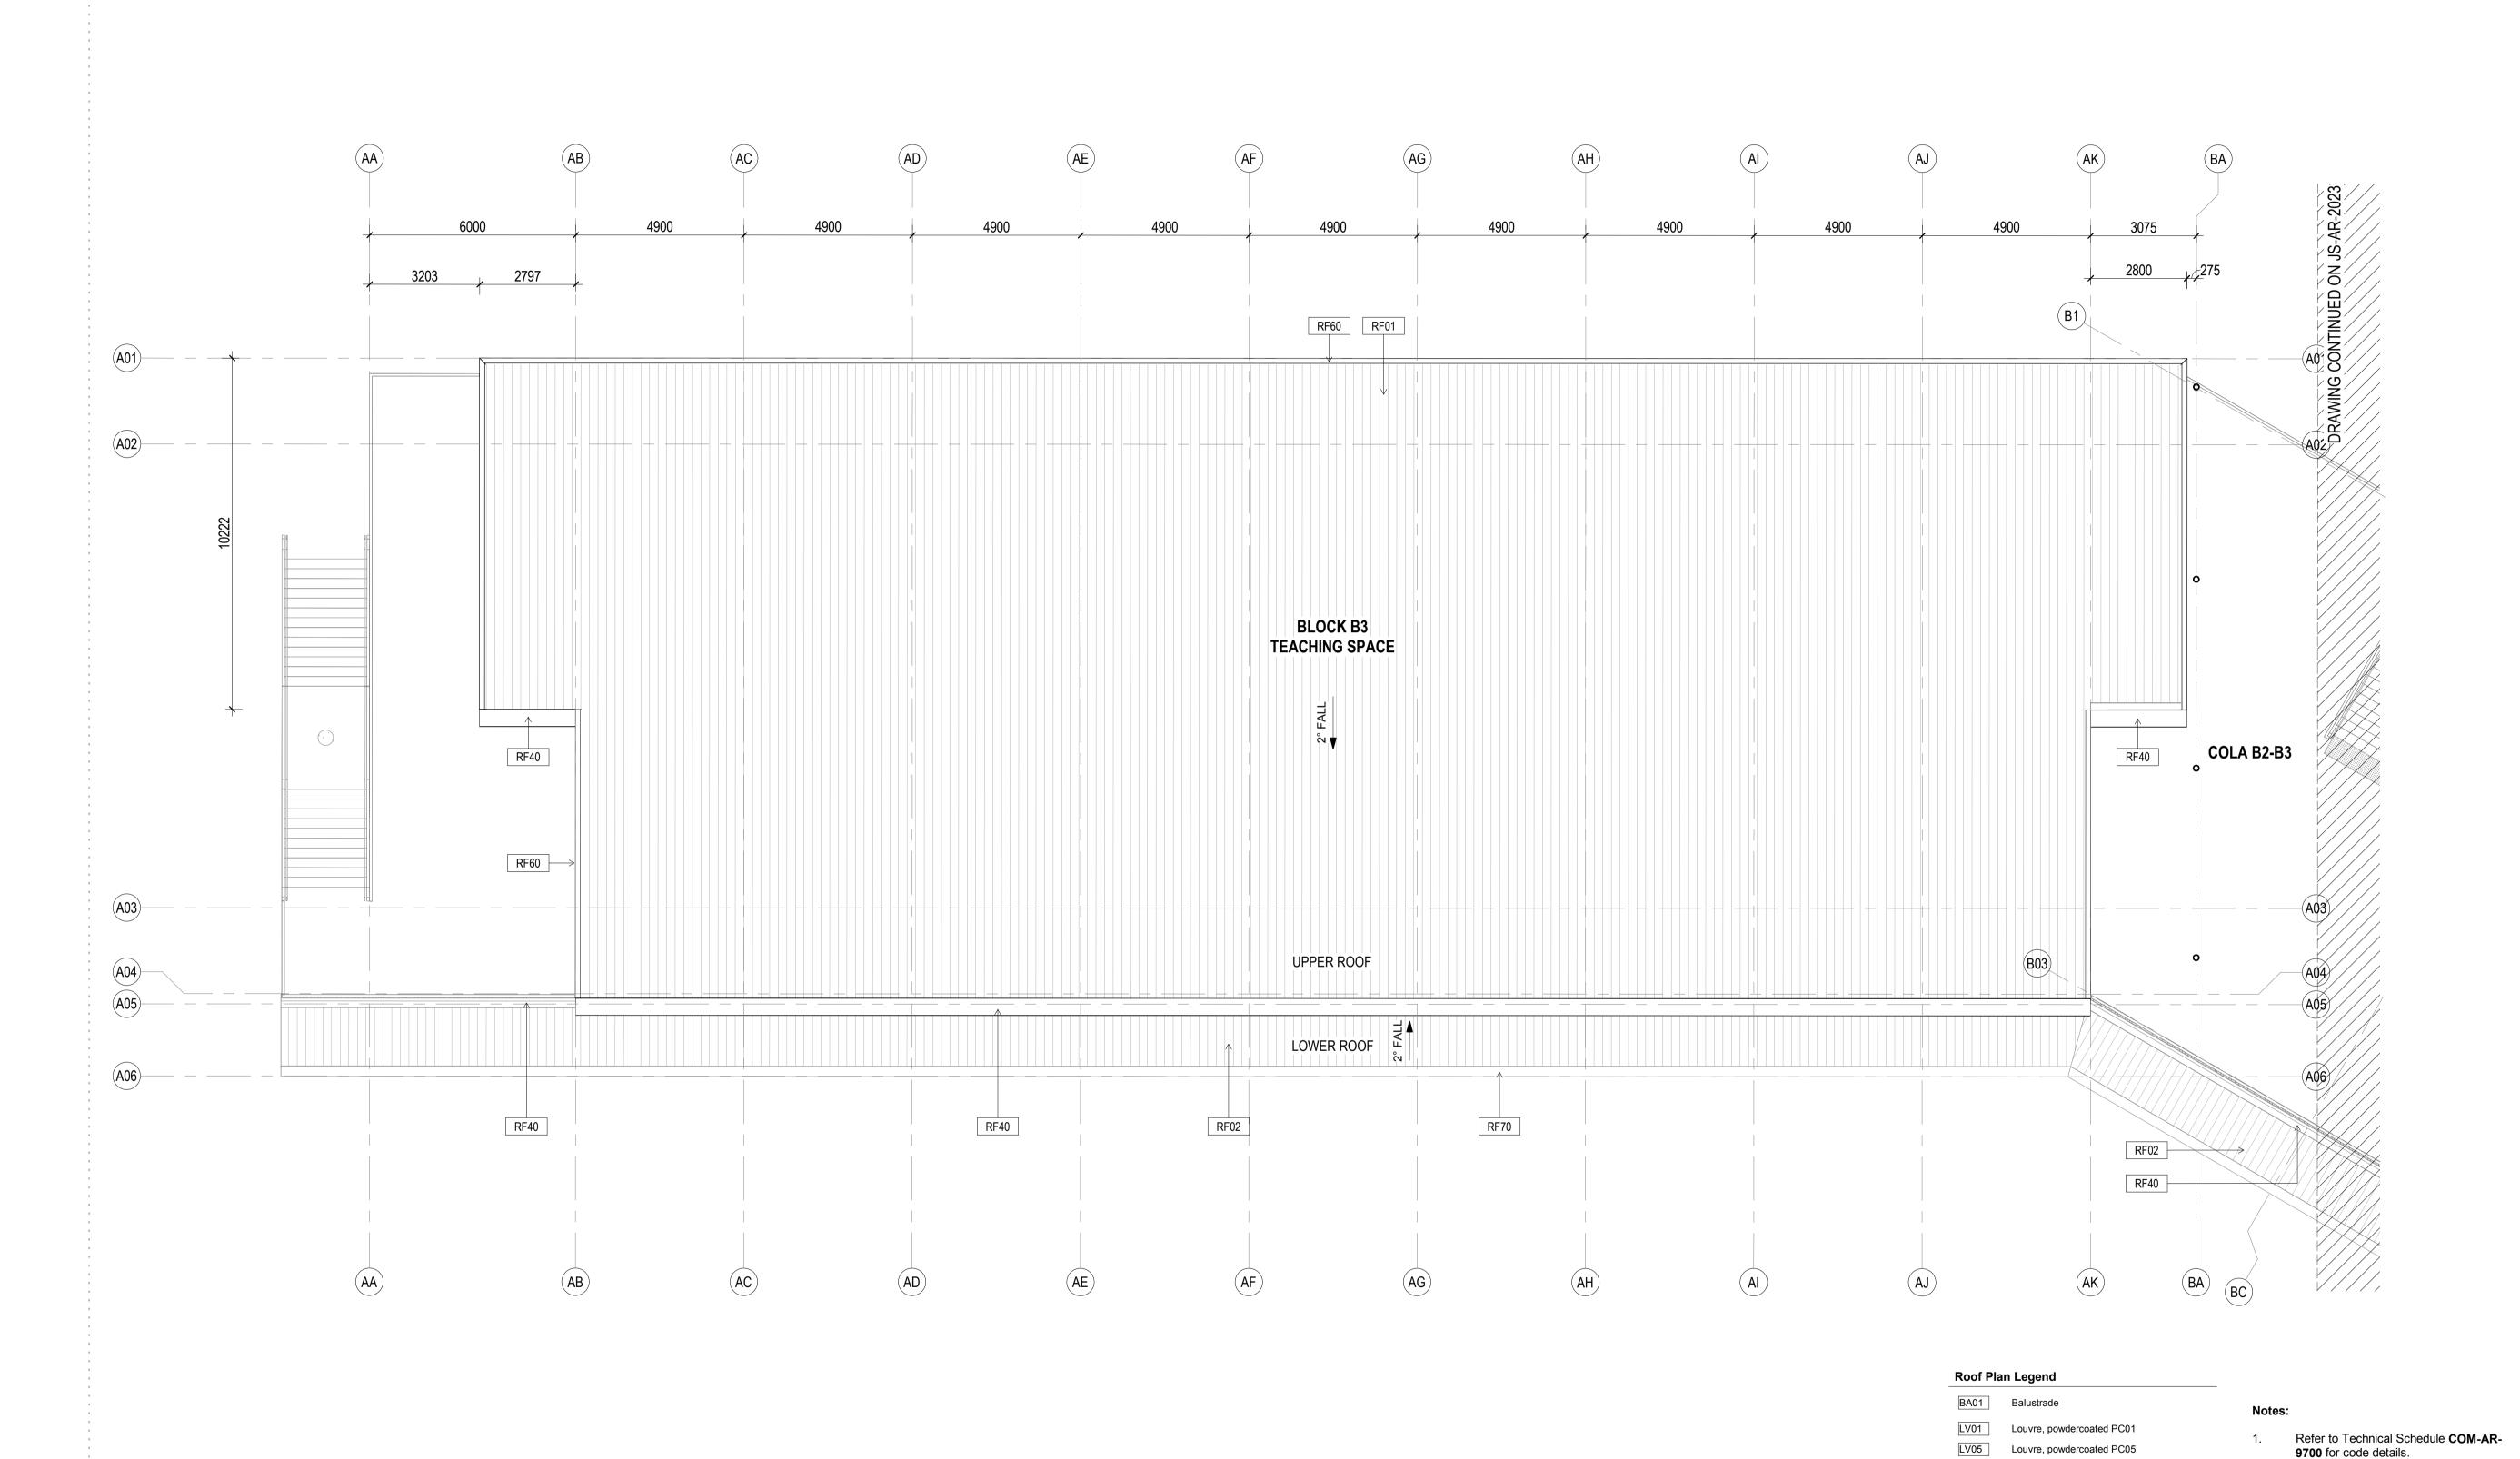

5 N

1. This drawing is the copyright of Group GSA Pty Ltd and may not be altered, reproduced or transmitted in any form or by any means in part or in whole without the written permission of Group GSA

27.03.2019

10.05.2019

31.05.2019

4. All dimensions are in millimetres unless noted otherwise.
5. All dimensions shall be verified on site before proceeding
6. Any areas indicated on this sheet are approximate and

2. Drawings to be printed in colour.

indicative only.

Amendments
Issue Description

3. Do not scale drawings. Dimensions govern.

FOR COORDINATION

PROGRESS ISSUE

SSD SUBMISSION







www.groupgsa.com T +612 9361 4144 F +612 9332 3458

Drawing Title

Contractor to ensure gutter falls in

gradient of 1:500

adjacent roof surface

shop drawings for review.

details to modular buildings

accordance with AS3500.3 minimum

Refer to services engineer's details for services layout and details. Ensure all

Allow for compliant roof restraint safety

roof mounted items colour match

access requirements to all roofs. Roof to include exhausts, flues, vent

pipes and the like with flashing trays

Fall arrest system on all roofs to be provided by a registered installer in

accordance with AN/NZS 1891: 'Industrial

fall arrest systems and devices and the hierarchy of risk management.' Provide

Provide metal leaf guards to all gutters All soaker trays to be max. 1.1m wide.

overlap lengths to manufacturers details.

Refer to Modscape documentation for all

Align all exposed flashing lapjoints to

CD01

CD40

Diversaclad Colorbond Shale Grey

CFC Stryum T60 Champagne

CFC Cembrit Patina Granite

Exposed concrete wall / column

Roof, Trimdek Colorbond Basalt

Roof, Trimdek Colorbond Shale Grey

Aluminium timber panel

Exposed concrete slab

Skylight, Fibreglass

Gutter, Colorbond Basalt

Structure, steel painted

Gutter, Colorbond Shale Grey

Downpipes, Colorbond Basalt

Downpipes, Colorbond Shale Grey


Capping, Colorbond to match adjacent roof

architecture interior design urban design landscape nom architect M. Sheldon 3990

JORDAN SPRINGS
PUBLIC SCHOOL


ROOF PLAN - BLOCK B3 - PART 5

180646 JS-AR-2024	С	5/31/20
Project No Drawing No	Issue	/31/2019 3:39:29
Approved	МВ	9:29 F
Verified	MP	≥
Plotted and checked by	FT	
Drawing Created (by)	RS	
Drawing Created (date)	10/05/19	
Scale @ A1	1 : 100	

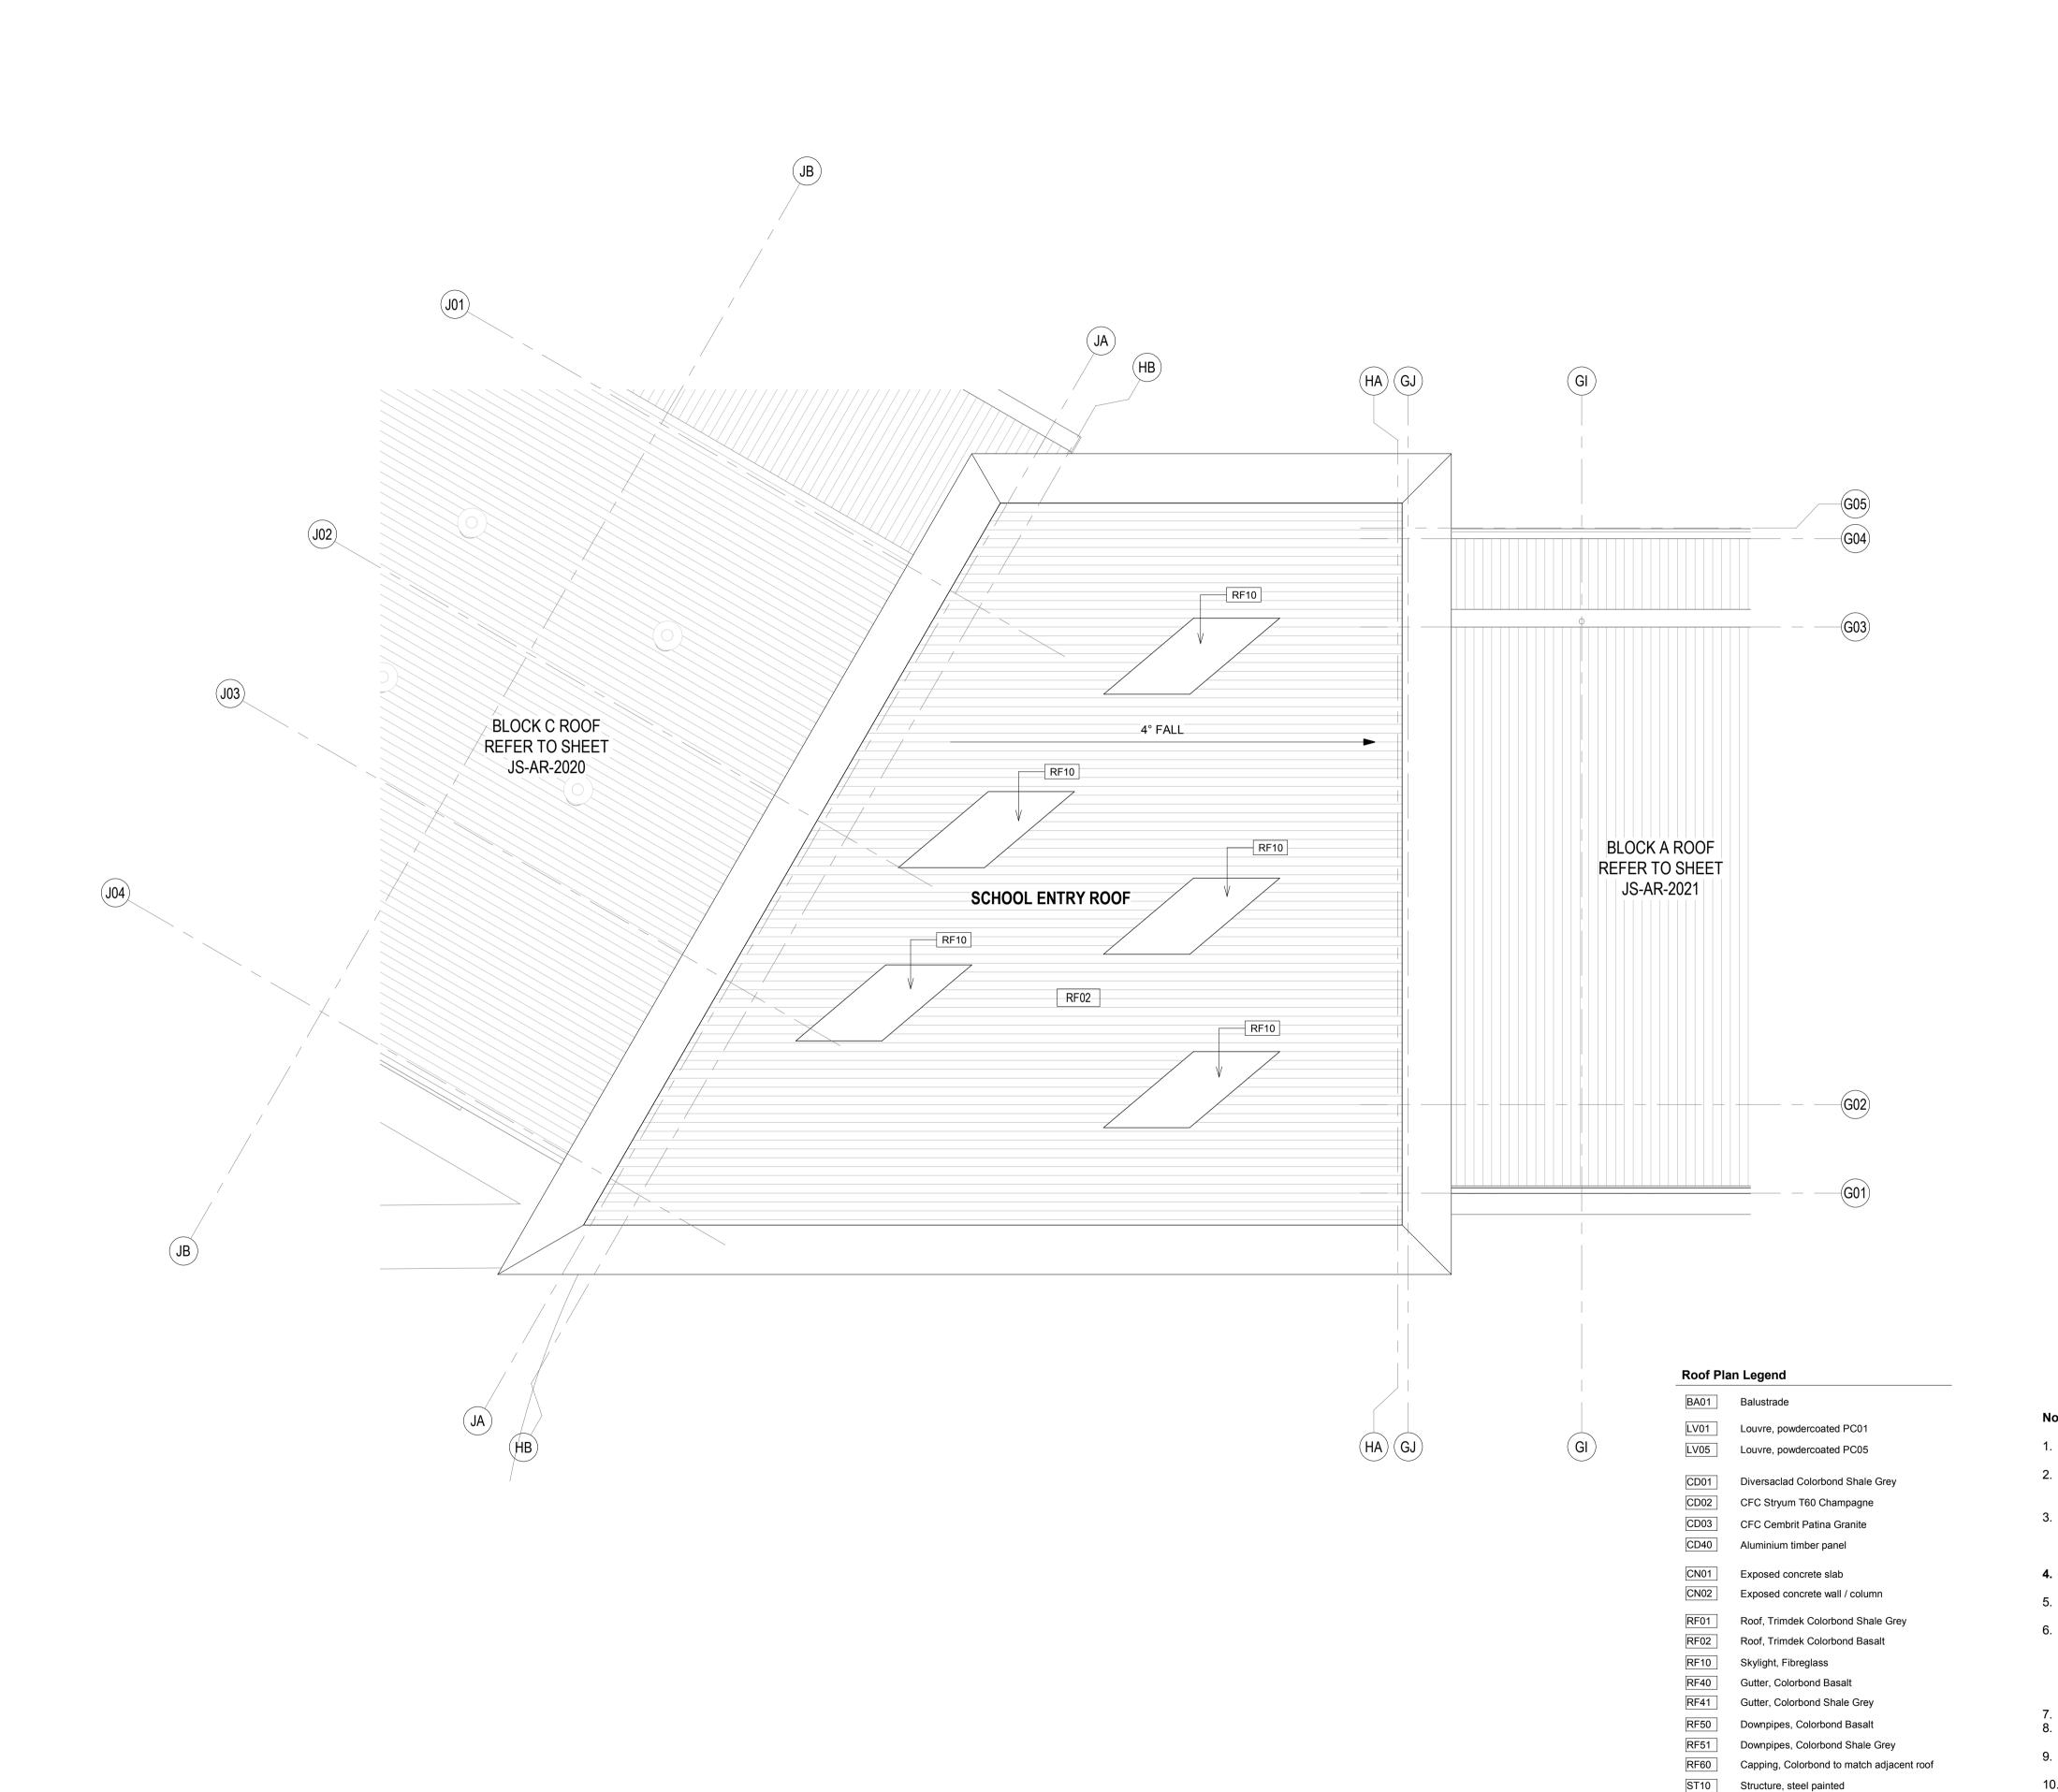

- 1. This drawing is the copyright of Group GSA Pty Ltd and may not be altered, reproduced or transmitted in any form or by any means in part or in whole without the written permission of Group GSA 2. Drawings to be printed in colour.
- 3. Do not scale drawings. Dimensions govern.
 4. All dimensions are in millimetres unless noted otherwise.
 5. All dimensions shall be verified on site before proceeding
 6. Any areas indicated on this sheet are approximate and indicative only.

1		
Amend	ments	
Issue	Description	Date
A	PROGRESS ISSUE	10.05.2019
' B	COLA Roof Progress Issue	24.05.2019
c	SSD SUBMISSION	31.05.2019

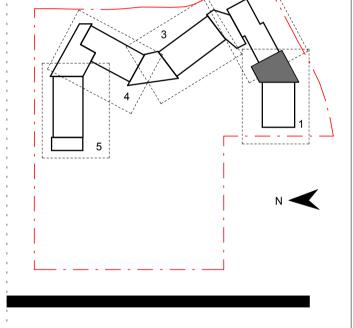

RICHARD CROOKES

CONSTRUCTIONS





www.groupgsa.com

T +612 9361 4144 F +612 9332 3458

architecture interior design urban design landscape nom architect M. Sheldon 3990

Refer to Technical Schedule COM-AR-

accordance with AS3500.3 minimum

Refer to services engineer's details for

services layout and details. Ensure all

Allow for compliant roof restraint safety

Roof to include exhausts, flues, vent pipes and the like with flashing trays

Fall arrest system on all roofs to be

provided by a registered installer in accordance with AN/NZS 1891: 'Industrial

fall arrest systems and devices and the

hierarchy of risk management.' Provide

Provide metal leaf guards to all gutters All soaker trays to be max. 1.1m wide.

Align all exposed flashing lapjoints to

grid.
Refer to Modscape documentation for all

overlap lengths to manufacturers details.

Contractor to ensure gutter falls in

roof mounted items colour match

access requirements to all roofs.

9700 for code details.

adjacent roof surface

shop drawings for review.

details to modular buildings


gradient of 1:500

JORDAN SPRINGS
PUBLIC SCHOOL

ROOF PLAN - SCHOOL ENTRY

1			
Scale @ A1		1:100	
Drawing Created (date)	10/05/19	
Drawing Created (by)	RS	
Plotted and check	ed by	MB	
Verified		RF	PM
Approved		MB	9:36 F
Project No	Drawing No	Issue	019 3:39:36

180646 JS-AR-2030 C

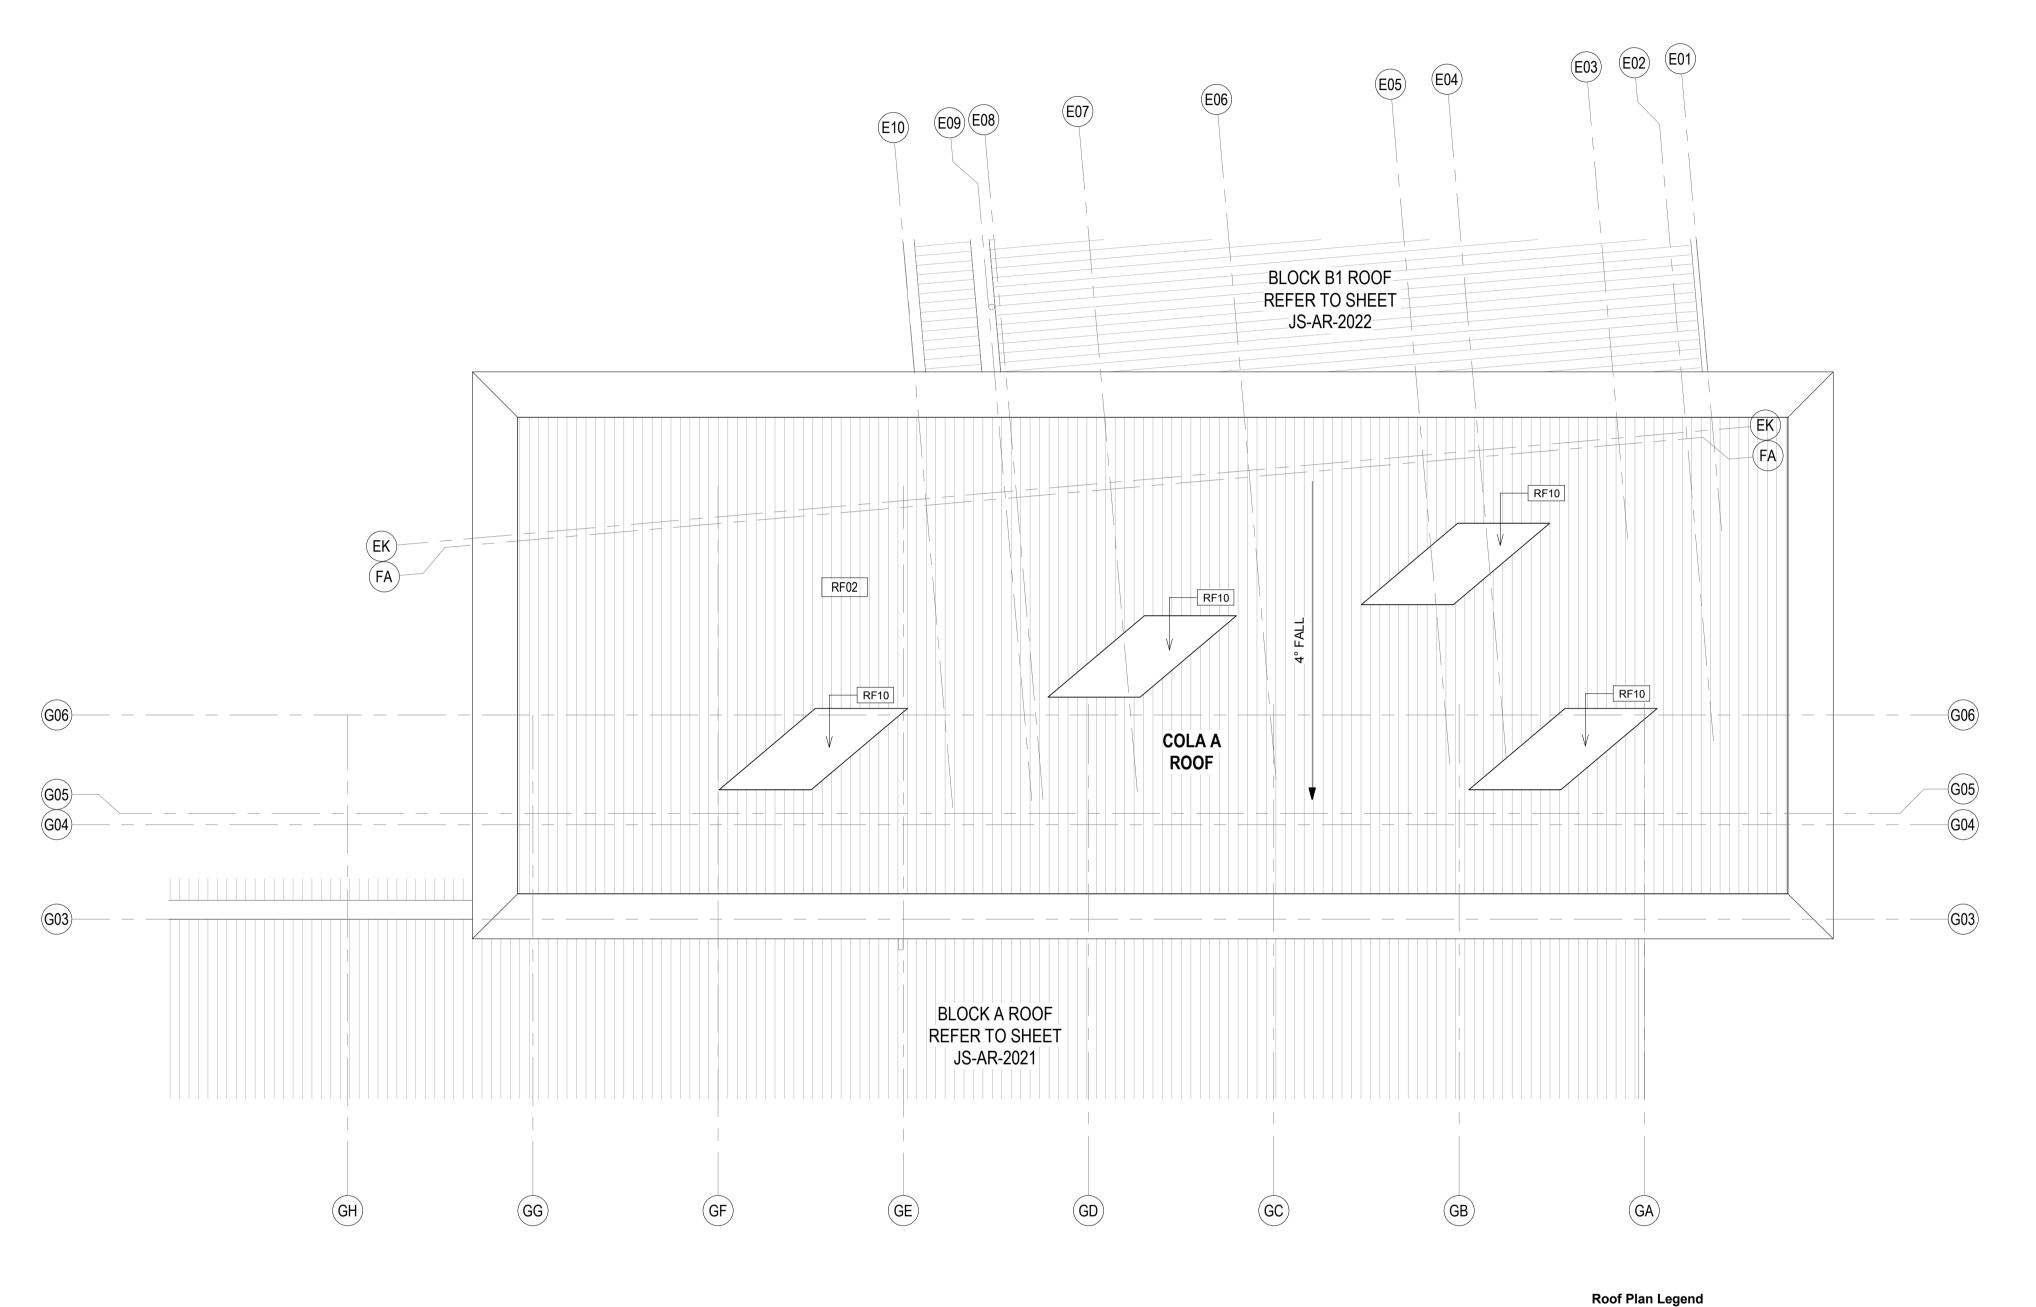

 Refer to Technical Schedule COM-AR-9700 for code details. Contractor to ensure gutter falls in accordance with AS3500.3 minimum

BA01 Balustrade

CD03

LV01 Louvre, powdercoated PC01

LV05 Louvre, powdercoated PC05

Diversaclad Colorbond Shale Grey

CFC Stryum T60 Champagne

CFC Cembrit Patina Granite

Aluminium timber panel

Exposed concrete slab

RF01 Roof, Trimdek Colorbond Shale Grey

Gutter, Colorbond Basalt

Gutter, Colorbond Shale Grey

Downpipes, Colorbond Basalt

Downpipes, Colorbond Shale Grey

Capping, Colorbond to match adjacent roof

Roof, Trimdek Colorbond Basalt

CN02 Exposed concrete wall / column

Skylight, Fibreglass

ST10 Structure, steel painted

gradient of 1:500 Refer to services engineer's details for services layout and details. Ensure all roof mounted items colour match adjacent roof surface

Allow for compliant roof restraint safety access requirements to all roofs.


Roof to include exhausts, flues, vent pipes and the like with flashing trays Fall arrest system on all roofs to be provided by a registered installer in

fall arrest systems and devices and the hierarchy of risk management.' Provide shop drawings for review. Provide metal leaf guards to all gutters All soaker trays to be max. 1.1m wide. overlap lengths to manufacturers details.

Align all exposed flashing lapjoints to

grid. Refer to Modscape documentation for all details to modular buildings

accordance with AN/NZS 1891: 'Industrial

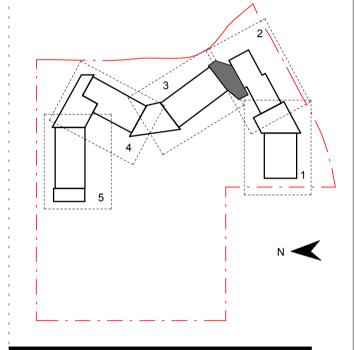

1. This drawing is the copyright of Group GSA Pty Ltd and may not be altered, reproduced or transmitted in any form or by any means in part or in whole without the written permission of Group GSA

10.05.2019

24.05.2019

31.05.2019

4. All dimensions are in millimetres unless noted otherwise. 5. All dimensions shall be verified on site before proceeding
6. Any areas indicated on this sheet are approximate and indicative only.

2. Drawings to be printed in colour.3. Do not scale drawings. Dimensions govern.

PROGRESS ISSUE

SSD SUBMISSION

COLA Roof Progress Issue

['] Amendments

RICHARD CROOKES CONSTRUCTIONS



Group GSA Pty Ltd ABN 76 002 113 779 Level 7, 80 William St East Sydney NSW Australia 2011 www.groupgsa.com

T +612 9361 4144 F +612 9332 3458

architecture interior design urban design landscape nom architect M. Sheldon 3990


Project Title JORDAN SPRINGS

PUBLIC SCHOOL

ROOF PLAN - COLA A

Scale @ A1		1 : 100
Drawing Created (da	te)	10/05/19
Drawing Created (by)	RS
Plotted and checked	by	ME
Verified		RI
Approved		ME
Project No	Drawing No	Issue

180646 JS-AR-2031 C 🖁

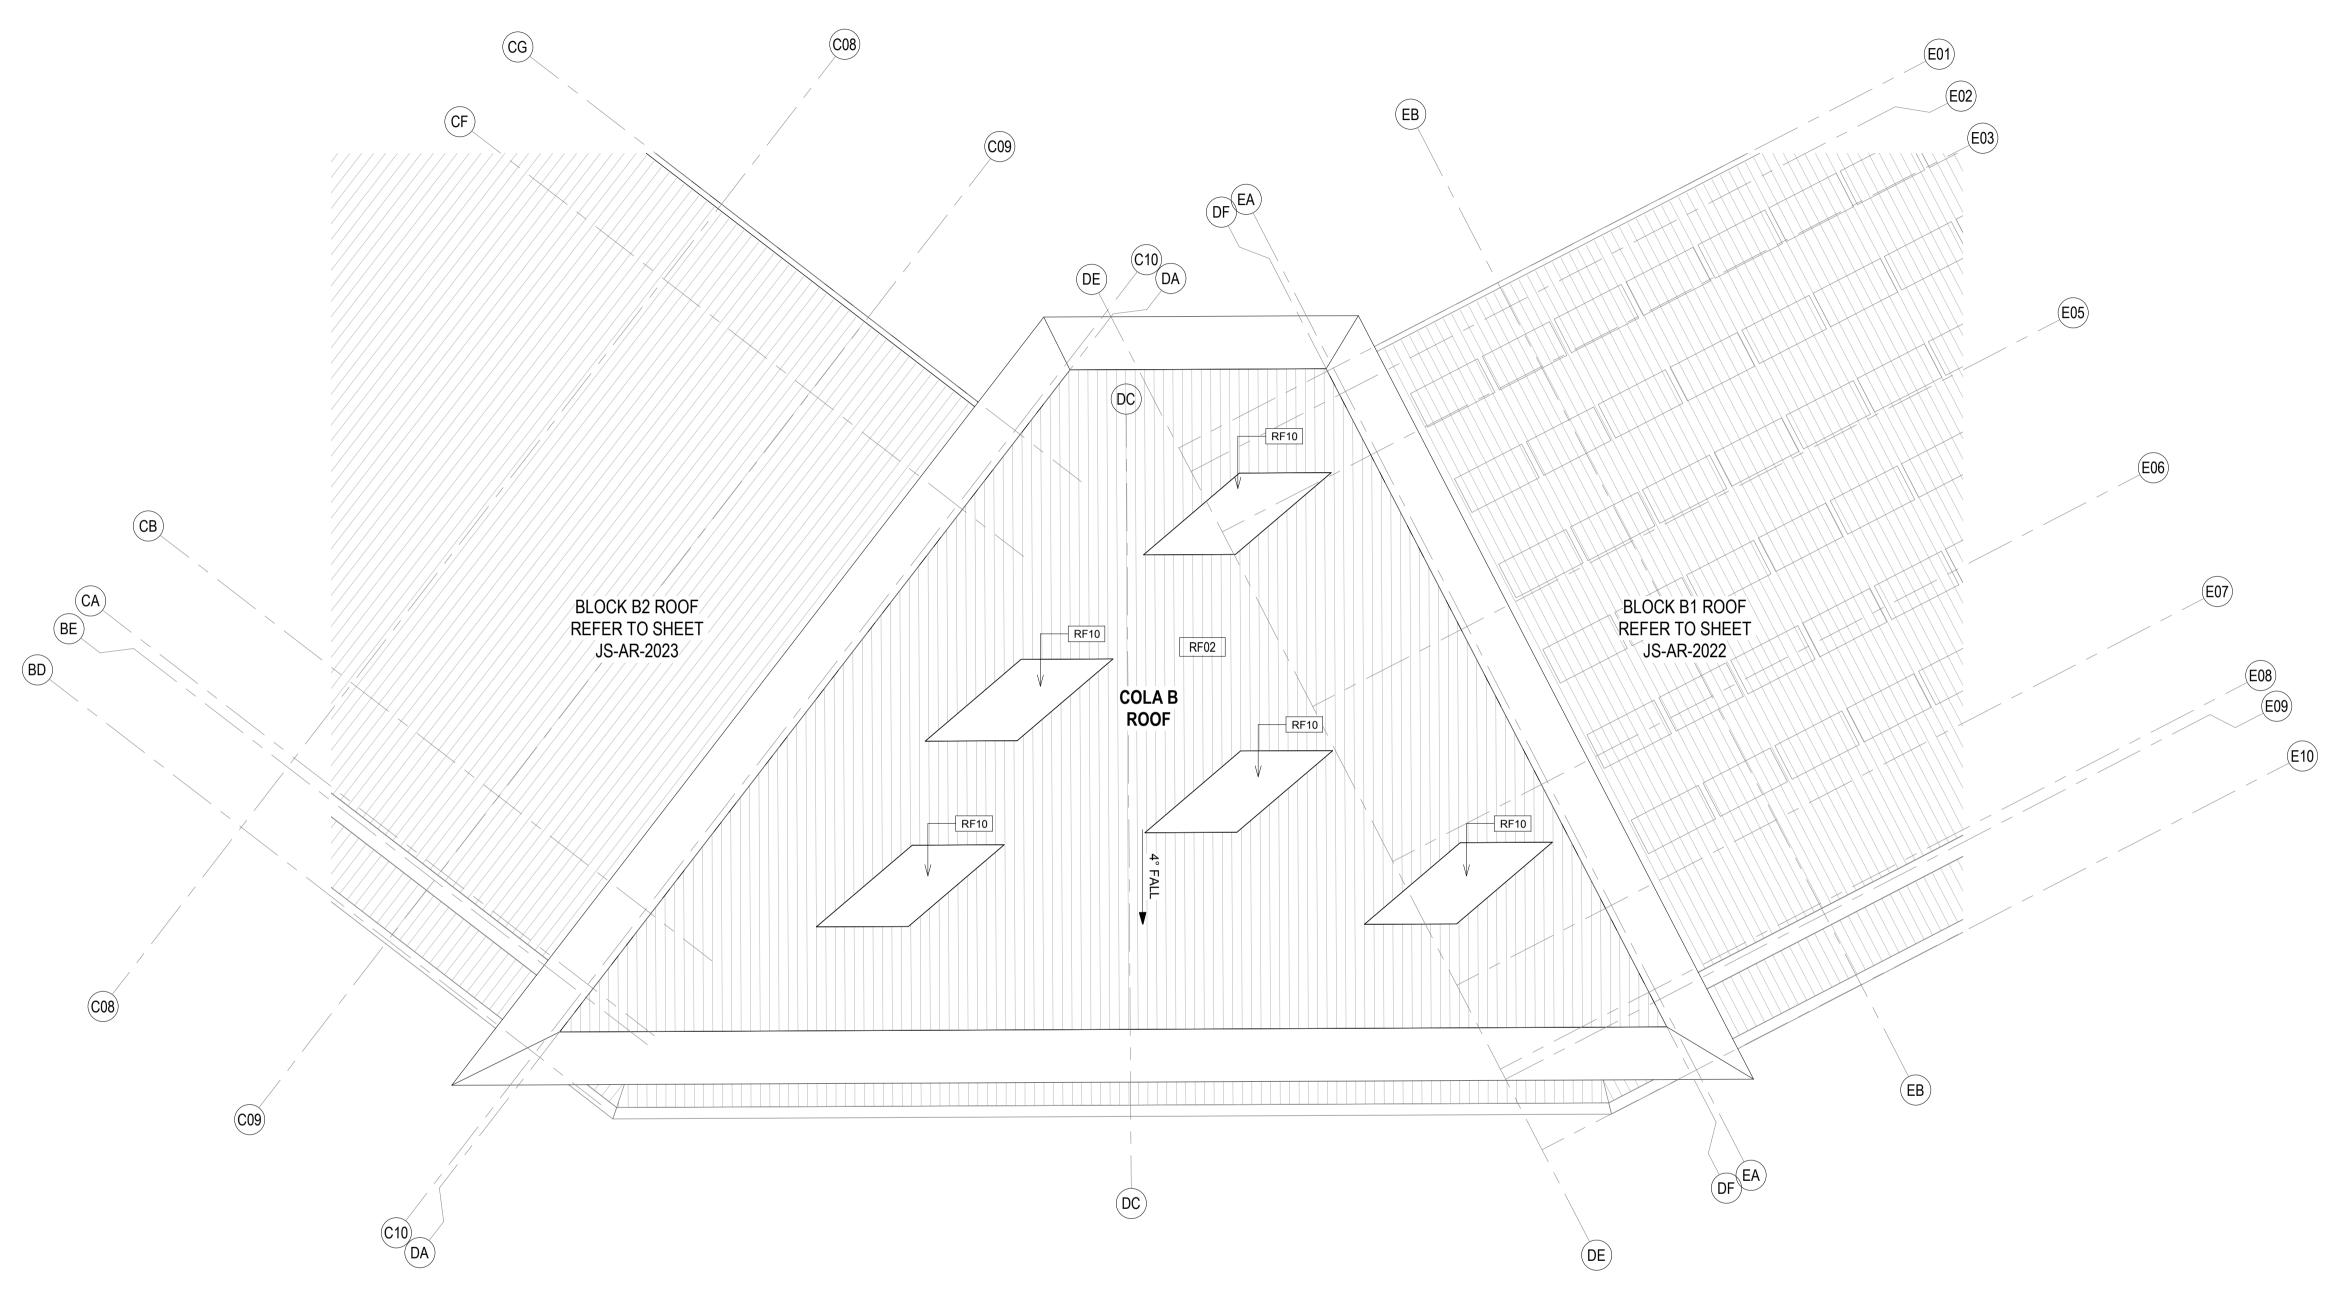

- 1. Refer to Technical Schedule COM-AR-9700 for code details. Contractor to ensure gutter falls in accordance with AS3500.3 minimum
- gradient of 1:500 Refer to services engineer's details for services layout and details. Ensure all roof mounted items colour match
- adjacent roof surface Allow for compliant roof restraint safety
- access requirements to all roofs. Roof to include exhausts, flues, vent
- pipes and the like with flashing trays Fall arrest system on all roofs to be provided by a registered installer in accordance with AN/NZS 1891: 'Industrial fall arrest systems and devices and the hierarchy of risk management.' Provide
- shop drawings for review.

 Provide metal leaf guards to all gutters
 All soaker trays to be max. 1.1m wide. overlap lengths to manufacturers details.

Align all exposed flashing lapjoints to

grid. Refer to Modscape documentation for all details to modular buildings

General Notes:

1. This drawing is the copyright of Group GSA Pty Ltd and may not be altered, reproduced or transmitted in any form or by any means in part or in whole without the written permission of Group GSA

2. Drawings to be printed in colour.

3. Do not scale drawings. Dimensions govern.


4. All dimensions are in millimetres unless noted otherwise.

5. All dimensions shall be verified on site before proceeding

6. Any areas indicated on this sheet are approximate and indicative only.

Issue	Description	Date
Α	PROGRESS ISSUE	10.05.2019
В	COLA Roof Progress Issue	24.05.2019
С	SSD SUBMISSION	31.05.2019

U	33D SUBMISSION		31.05.2019
_	Roof Plar		
	BA01	Balustrade	
	LV01	Louvre, powdercoated PC01	
	LV05	Louvre, powdercoated PC05	
	CD01	Diversaclad Colorbond Shale Grey	<i>y</i>
	CD02	CFC Stryum T60 Champagne	
	CD03	CFC Cembrit Patina Granite	
	CD40	Aluminium timber panel	
	CN01	Exposed concrete slab	
	CN02	Exposed concrete wall / column	
	RF01	Roof, Trimdek Colorbond Shale G	rey
	RF02	Roof, Trimdek Colorbond Basalt	
	RF10	Skylight, Fibreglass	
	RF40	Gutter, Colorbond Basalt	
	RF41	Gutter, Colorbond Shale Grey	
	RF50	Downpipes, Colorbond Basalt	
	RF51	Downpipes, Colorbond Shale Grey	1
	RF60	Capping, Colorbond to match adja	cent roof
	ST10	Structure, steel painted	

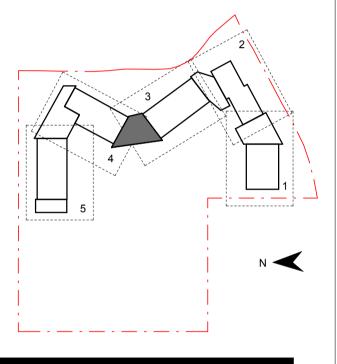







Group GSA Pty Ltd ABN 76 002 113 779 Level 7, 80 William St East Sydney NSW Australia 2011 www.groupgsa.com

T +612 9361 4144 F +612 9332 3458


architecture interior design urban design landscape nom architect M. Sheldon 3990

Project Title JORDAN SPRINGS **PUBLIC SCHOOL**

ROOF PLAN - COLA B

Project No	Drawing No	Issue
Approved		MB
Verified		RF
Plotted and checl	ked by	MB
Drawing Created	(by)	RS
Drawing Created	(date)	10/05/19
Scale @ A1		1 : 100

180646 JS-AR-2032 C 🖁

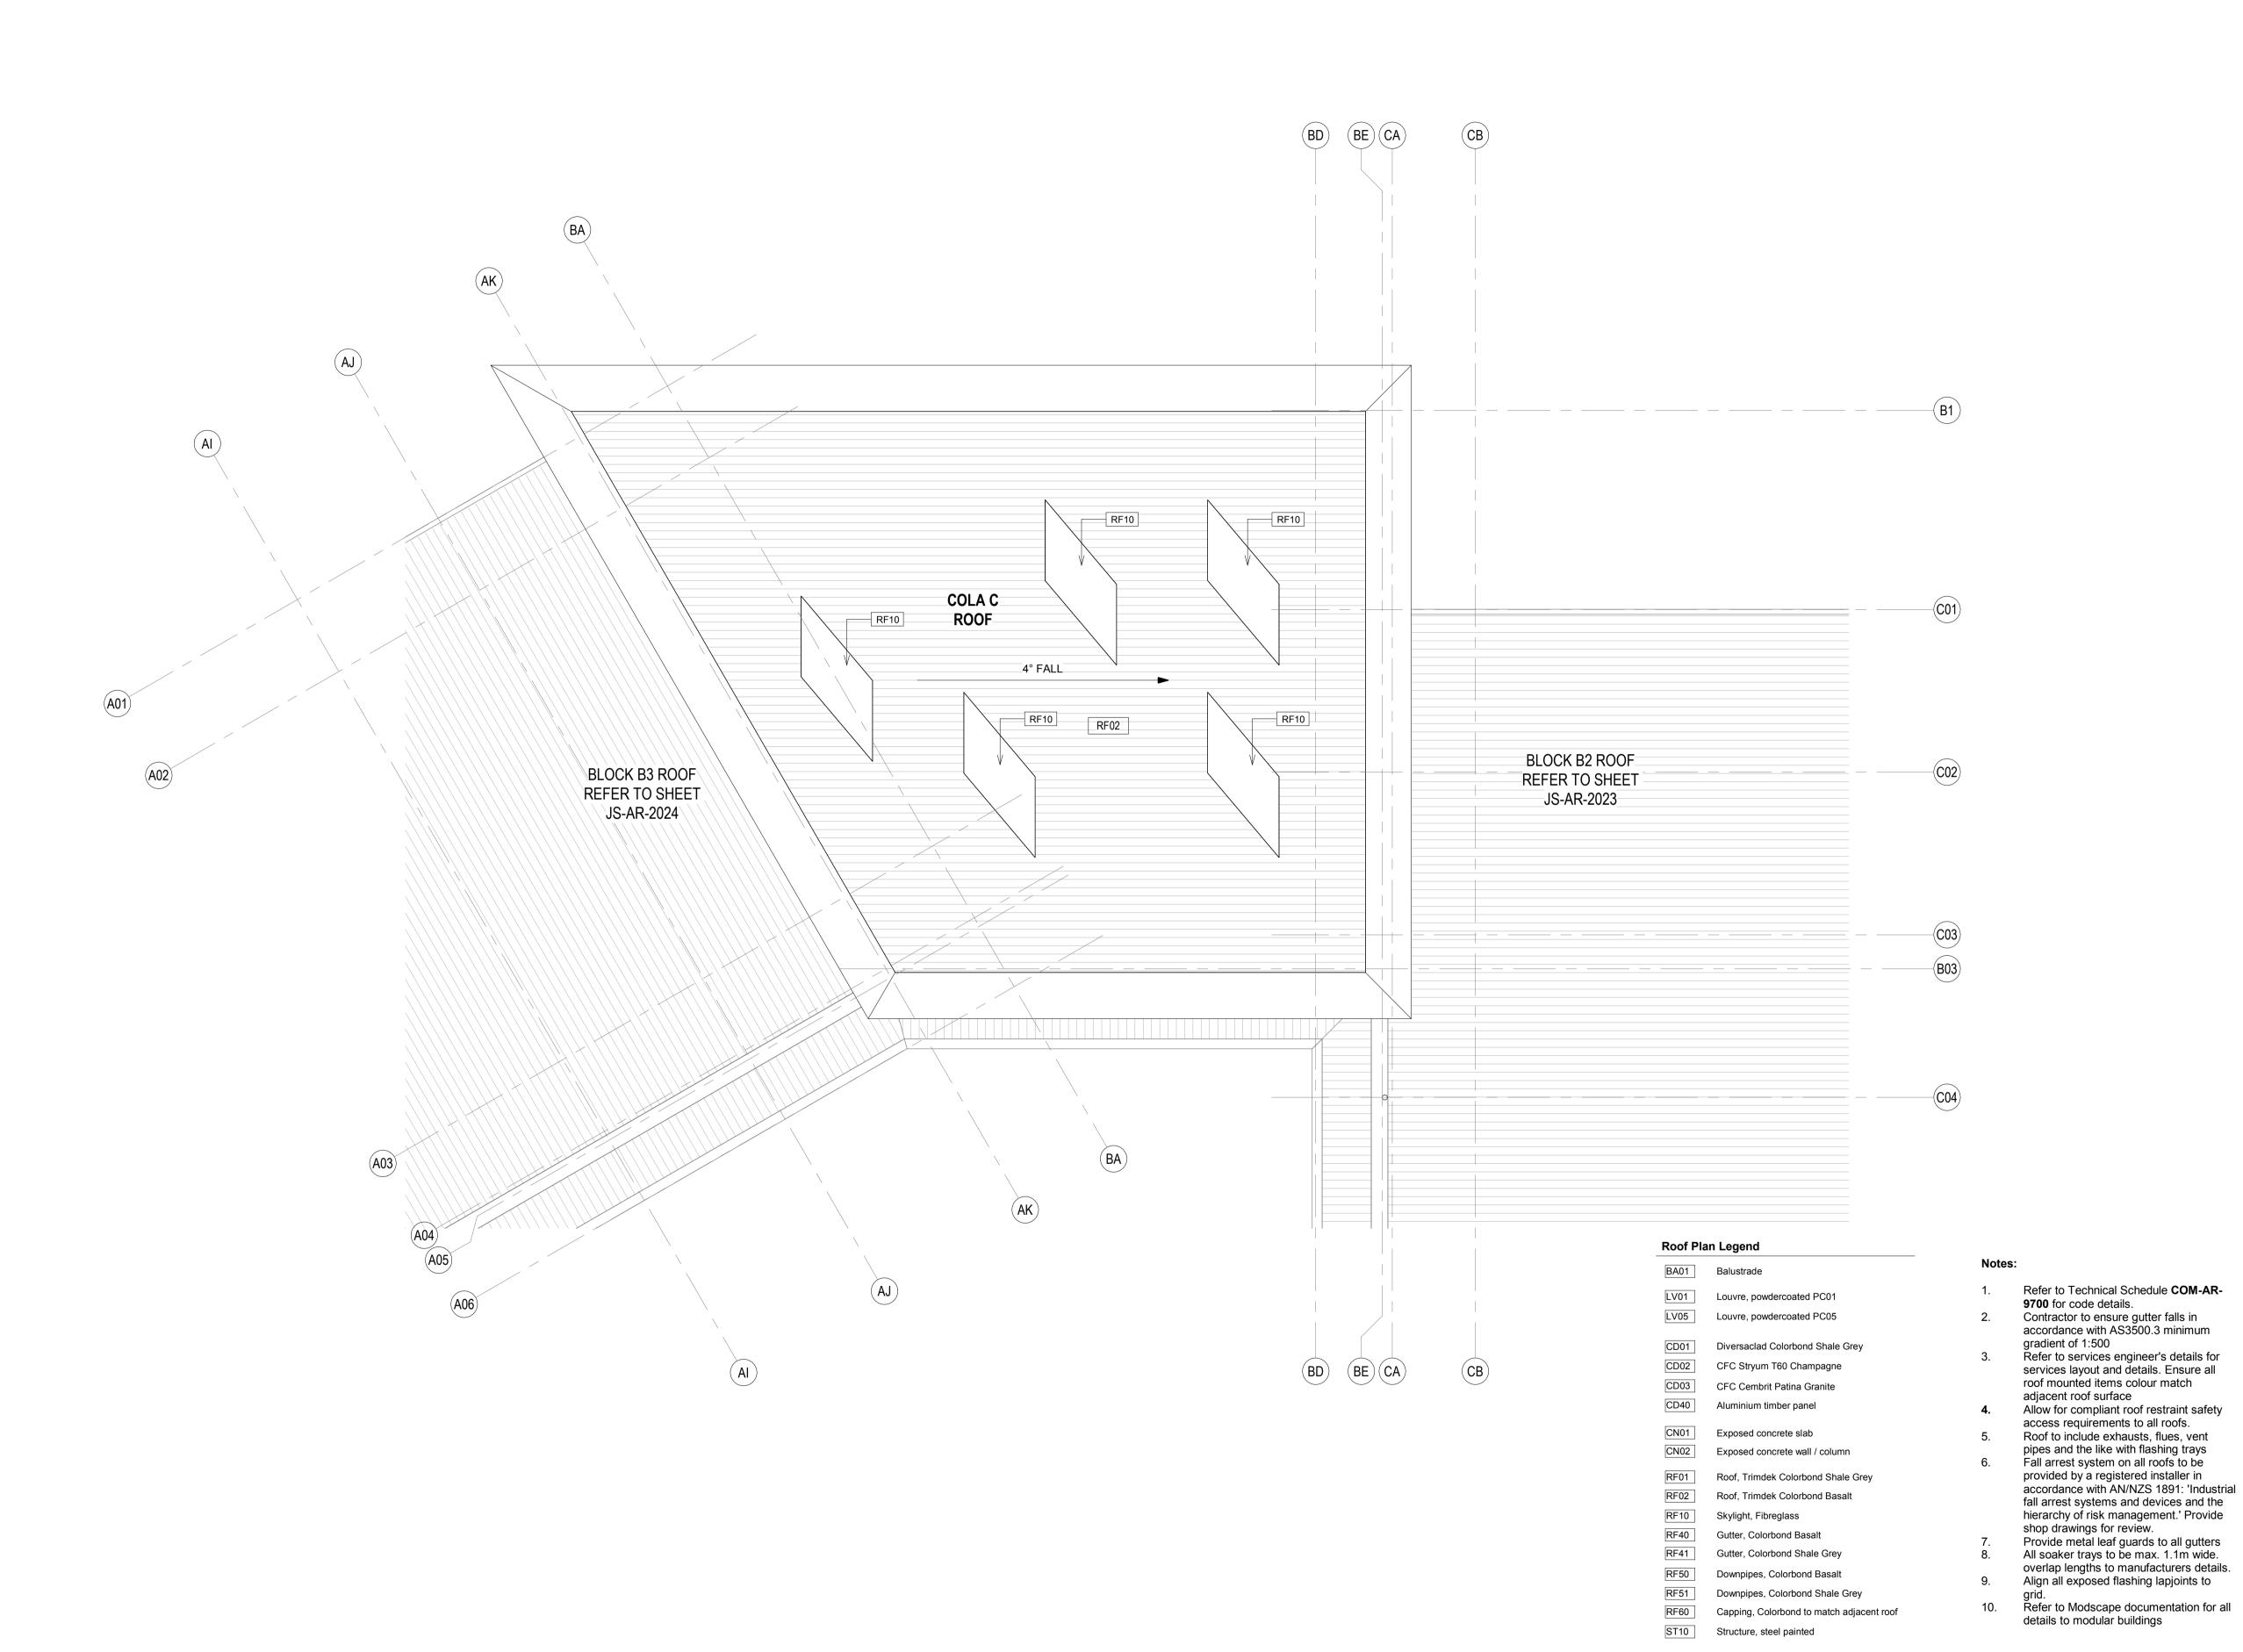


General Notes:

- 1. This drawing is the copyright of Group GSA Pty Ltd and may not be altered, reproduced or transmitted in any form or by any means in part or in whole without the written permission of Group GSA

 2. Drawings to be printed in colour.

 3. Do not scale drawings. Dimensions govern.
- 3. Do not scale drawings. Dimensions govern.
 4. All dimensions are in millimetres unless noted otherwise.
 5. All dimensions shall be verified on site before proceeding
 6. Any areas indicated on this sheet are approximate and indicative only.

1		
Amendr	ments	
Issue	Description	Date
A	PROGRESS ISSUE	10.05.2019
' B	COLA Roof Progress Issue	24.05.2019
c	SSD SUBMISSION	31.05.2019
1		

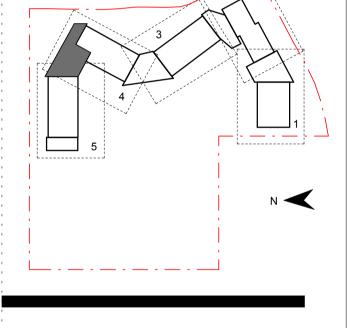

RICHARD CROOKES

CONSTRUCTIONS



Group GSA Pty Ltd ABN 76 002 113 779 Level 7, 80 William St East Sydney NSW Australia 2011

www.groupgsa.com

T +612 9361 4144 F +612 9332 3458
architecture interior design urban design landscape nom architect M. Sheldon 3990

1 1



ROOF PLAN - COLA C

Scale @ A1	1 : 100
Drawing Created (date)	10/05/19
Drawing Created (by)	RS
Plotted and checked by	MB
Verified	RF
Approved	MB
Project No Drawing No	Issue
180646 JS-AR-2033	3 C

RF02 **COLA D BLOCK B3 ROOF** REFER TO SHEET JS-AR-2024 (A06) A06

BA01 Balustrade Louvre, powdercoated PC01 Louvre, powdercoated PC05

Roof Plan Legend

Diversaclad Colorbond Shale Grey CD02 CFC Stryum T60 Champagne

CD03 CFC Cembrit Patina Granite CD40 Aluminium timber panel Exposed concrete slab

Exposed concrete wall / column Roof, Trimdek Colorbond Shale Grey RF02 Roof, Trimdek Colorbond Basalt

Skylight, Fibreglass Gutter, Colorbond Basalt Gutter, Colorbond Shale Grey

Downpipes, Colorbond Basalt Downpipes, Colorbond Shale Grey

Capping, Colorbond to match adjacent roof Structure, steel painted

Refer to Technical Schedule COM-AR-9700 for code details.

Contractor to ensure gutter falls in accordance with AS3500.3 minimum gradient of 1:500 Refer to services engineer's details for services layout and details. Ensure all

roof mounted items colour match adjacent roof surface Allow for compliant roof restraint safety

access requirements to all roofs. Roof to include exhausts, flues, vent pipes and the like with flashing trays

Fall arrest system on all roofs to be provided by a registered installer in accordance with AN/NZS 1891: 'Industrial fall arrest systems and devices and the hierarchy of risk management.' Provide shop drawings for review.

Provide metal leaf guards to all gutters All soaker trays to be max. 1.1m wide. overlap lengths to manufacturers details.

Align all exposed flashing lapjoints to

Refer to Modscape documentation for all details to modular buildings

1. This drawing is the copyright of Group GSA Pty Ltd and may not be altered, reproduced or transmitted in any form or by any means in part or in whole without the written permission of Group GSA

> 10.05.2019 24.05.2019

> 31.05.2019

4. All dimensions are in millimetres unless noted otherwise. 5. All dimensions shall be verified on site before proceeding 6. Any areas indicated on this sheet are approximate and

2. Drawings to be printed in colour.

PROGRESS ISSUE

COLA Roof Progress Issue SSD SUBMISSION

indicative only.

['] Amendments Issue Description

3. Do not scale drawings. Dimensions govern.







Group GSA Pty Ltd ABN 76 002 113 779 Level 7, 80 William St East Sydney NSW Australia 2011 www.groupgsa.com

T +612 9361 4144 F +612 9332 3458 architecture interior design urban design landscape nom architect M. Sheldon 3990


Project Title

JORDAN SPRINGS **PUBLIC SCHOOL**

ROOF PLAN - COLA D

Project No	Drawing No	Issue
Approved		ME
Verified		RF
Plotted and checke	ed by	ME
Drawing Created (b	py)	RS
Drawing Created (c	date)	10/05/19
Scale @ A1		1 : 100

180646 JS-AR-2034 C

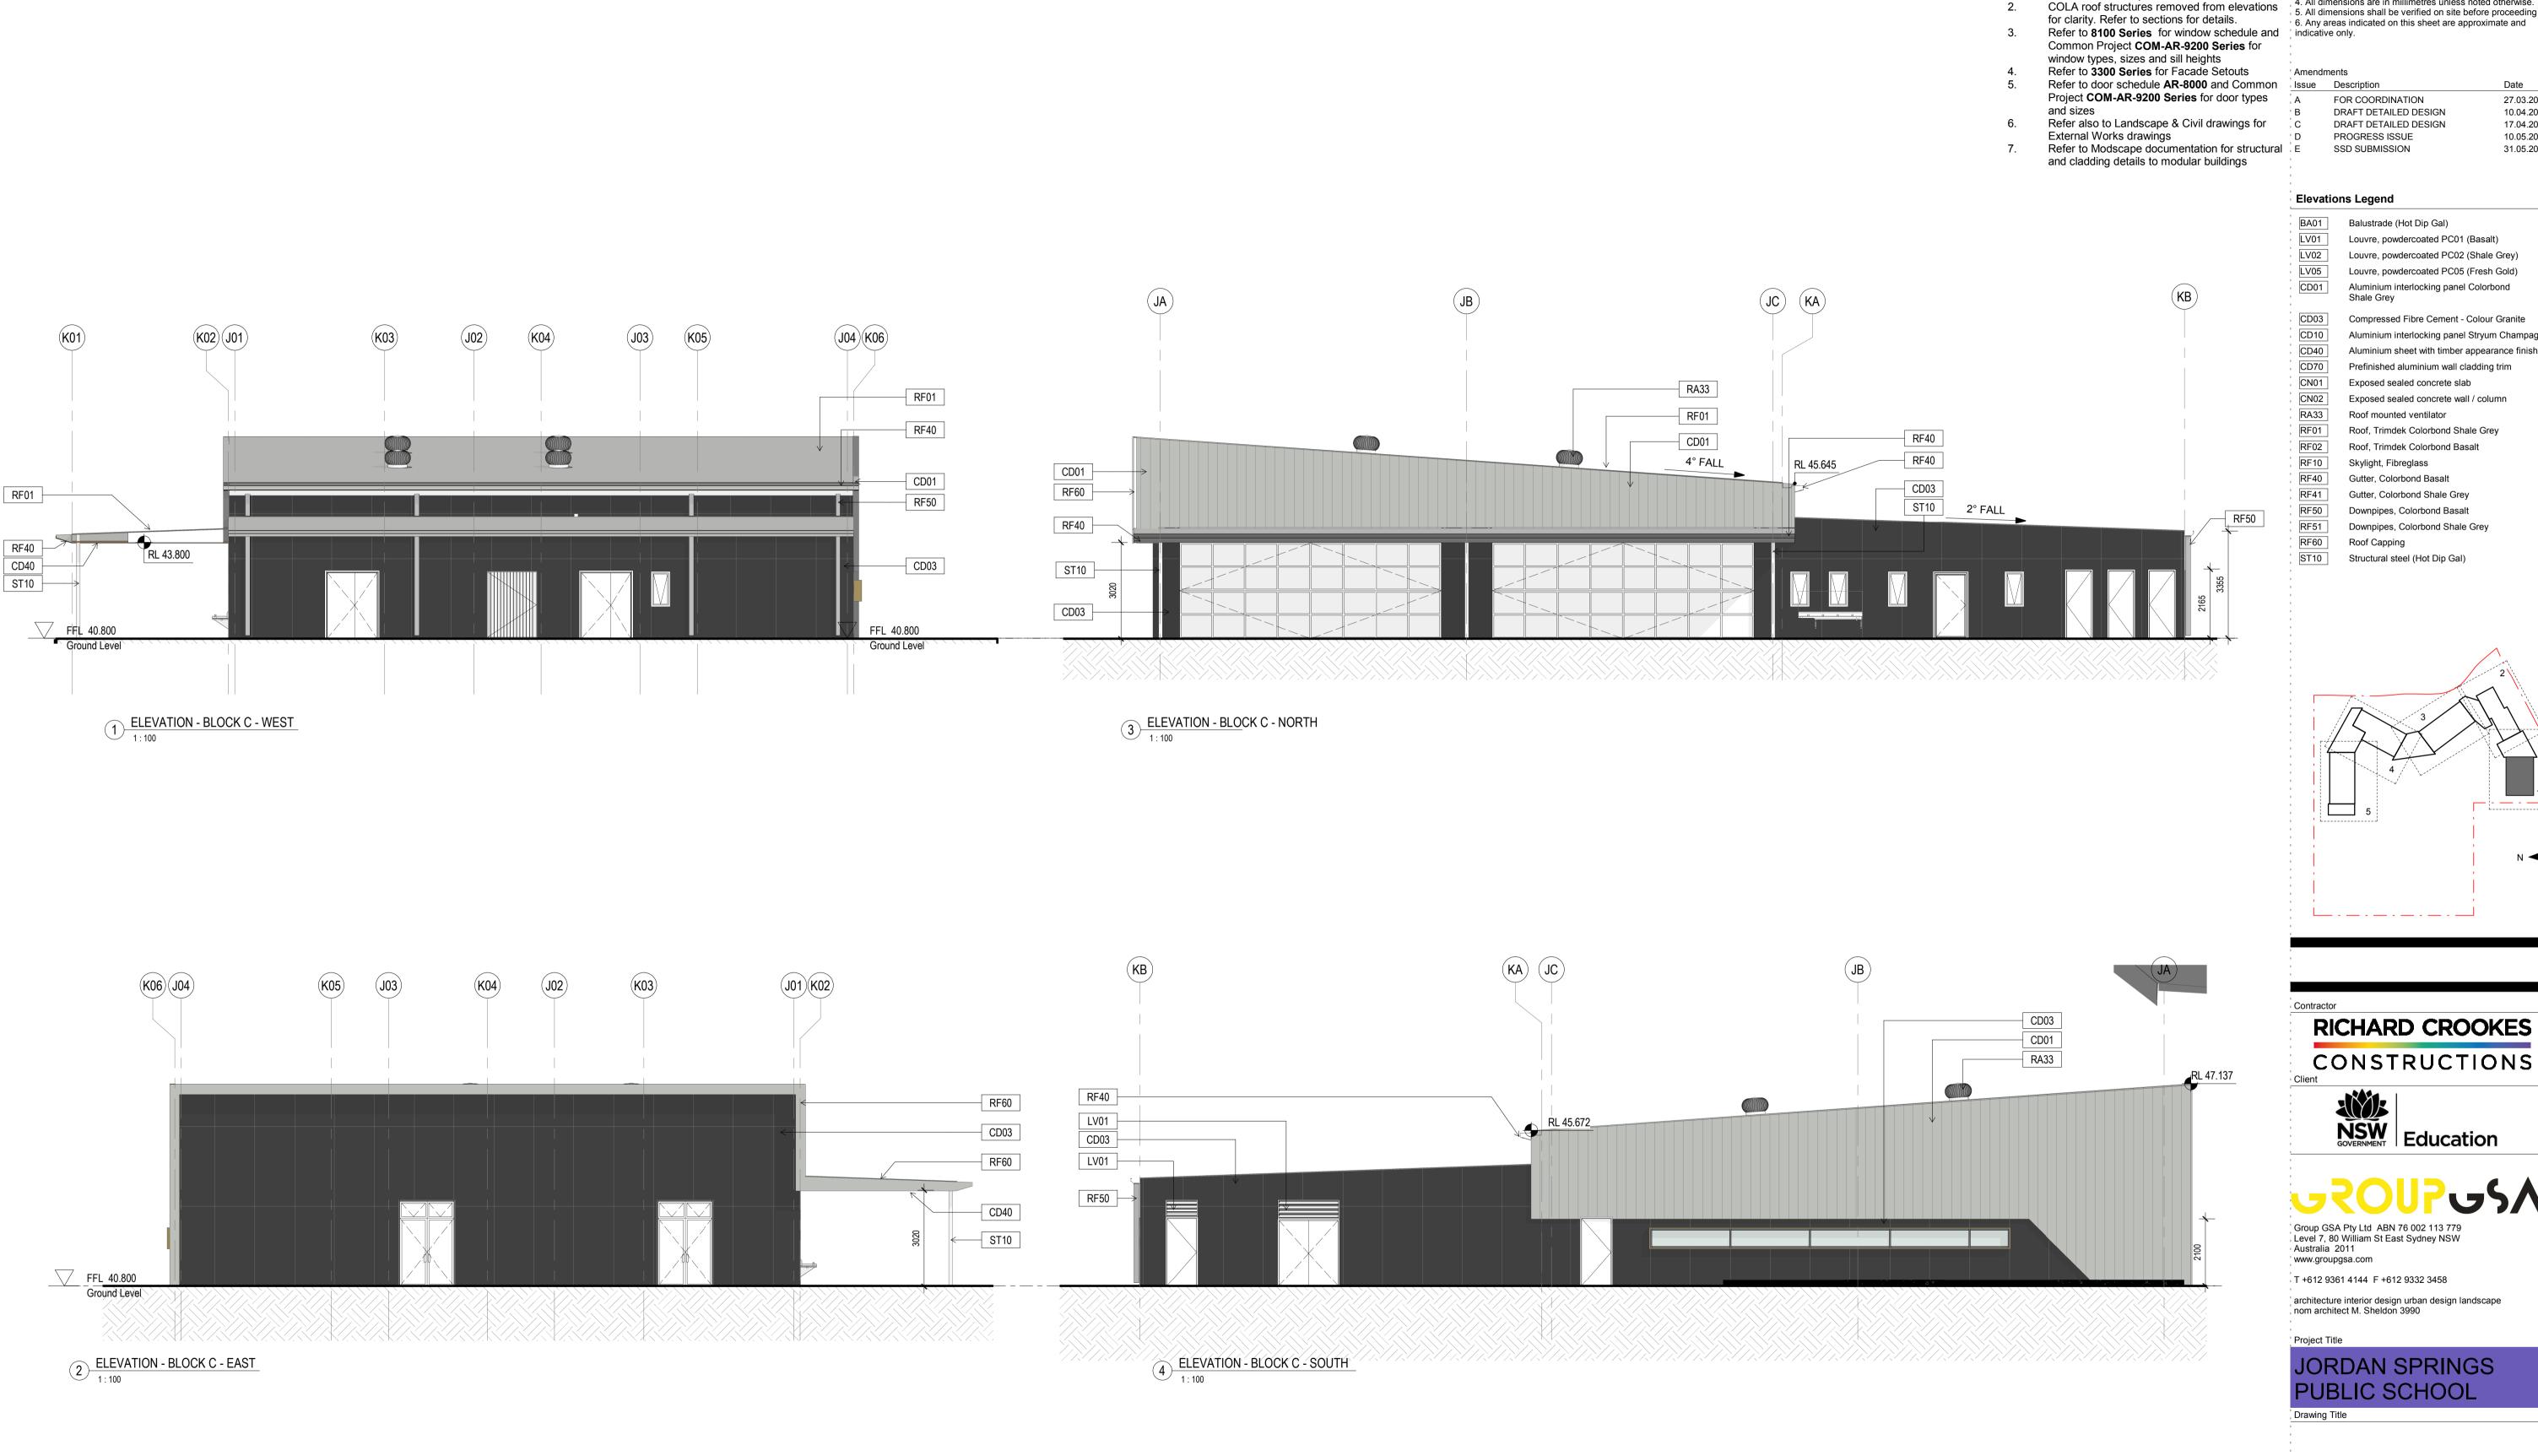

boxed code descriptions


1. This drawing is the copyright of Group GSA Pty Ltd and may not be altered, reproduced or transmitted in any form or by any means in part or in whole without the written permission of Group GSA Refer to technical schedule **COM-AR-9700** for boxed code descriptions

2. Drawings to be printed in colour.
3. Do not scale drawings. Dimensions govern.

4. All dimensions are in millimetres unless noted otherwise. 5. All dimensions shall be verified on site before proceeding

ue	Description	Date
	FOR COORDINATION	27.03.201
	DRAFT DETAILED DESIGN	10.04.201
	DRAFT DETAILED DESIGN	17.04.201
	PROGRESS ISSUE	10.05.201
	SSD SUBMISSION	31.05.201

BA01	Balustrade (Hot Dip Gal)
LV01	Louvre, powdercoated PC01 (Basalt)
LV02	Louvre, powdercoated PC02 (Shale Grey)
LV05	Louvre, powdercoated PC05 (Fresh Gold)
CD01	Aluminium interlocking panel Colorbond Shale Grey
CD03	Compressed Fibre Cement - Colour Granite
CD10	Aluminium interlocking panel Stryum Champag
CD40	Aluminium sheet with timber appearance finish
CD70	Prefinished aluminium wall cladding trim
CN01	Exposed sealed concrete slab
CN02	Exposed sealed concrete wall / column
RA33	Roof mounted ventilator
RF01	Roof, Trimdek Colorbond Shale Grey
RF02	Roof, Trimdek Colorbond Basalt
RF10	Skylight, Fibreglass
RF40	Gutter, Colorbond Basalt
RF41	Gutter, Colorbond Shale Grey
RF50	Downpipes, Colorbond Basalt
RF51	Downpipes, Colorbond Shale Grey
RF60	Roof Capping
ST10	Structural steel (Hot Dip Gal)

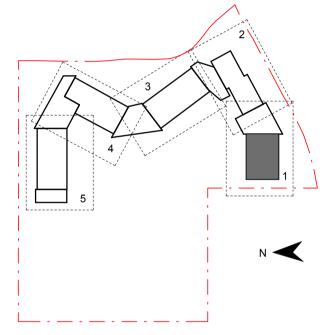







www.groupgsa.com


architecture interior design urban design landscape nom architect M. Sheldon 3990

JORDAN SPRINGS PUBLIC SCHOOL

BUILDING 'C' ELEVATIONS

Scale @ A1		As indicated
Drawing Created	(date)	10/05/19
Drawing Created	(by)	FC
Plotted and check	ked by	FT
Verified		MP
Approved		MB
Project No	Drawing No	Issue

180646 JS-AR-3000 E

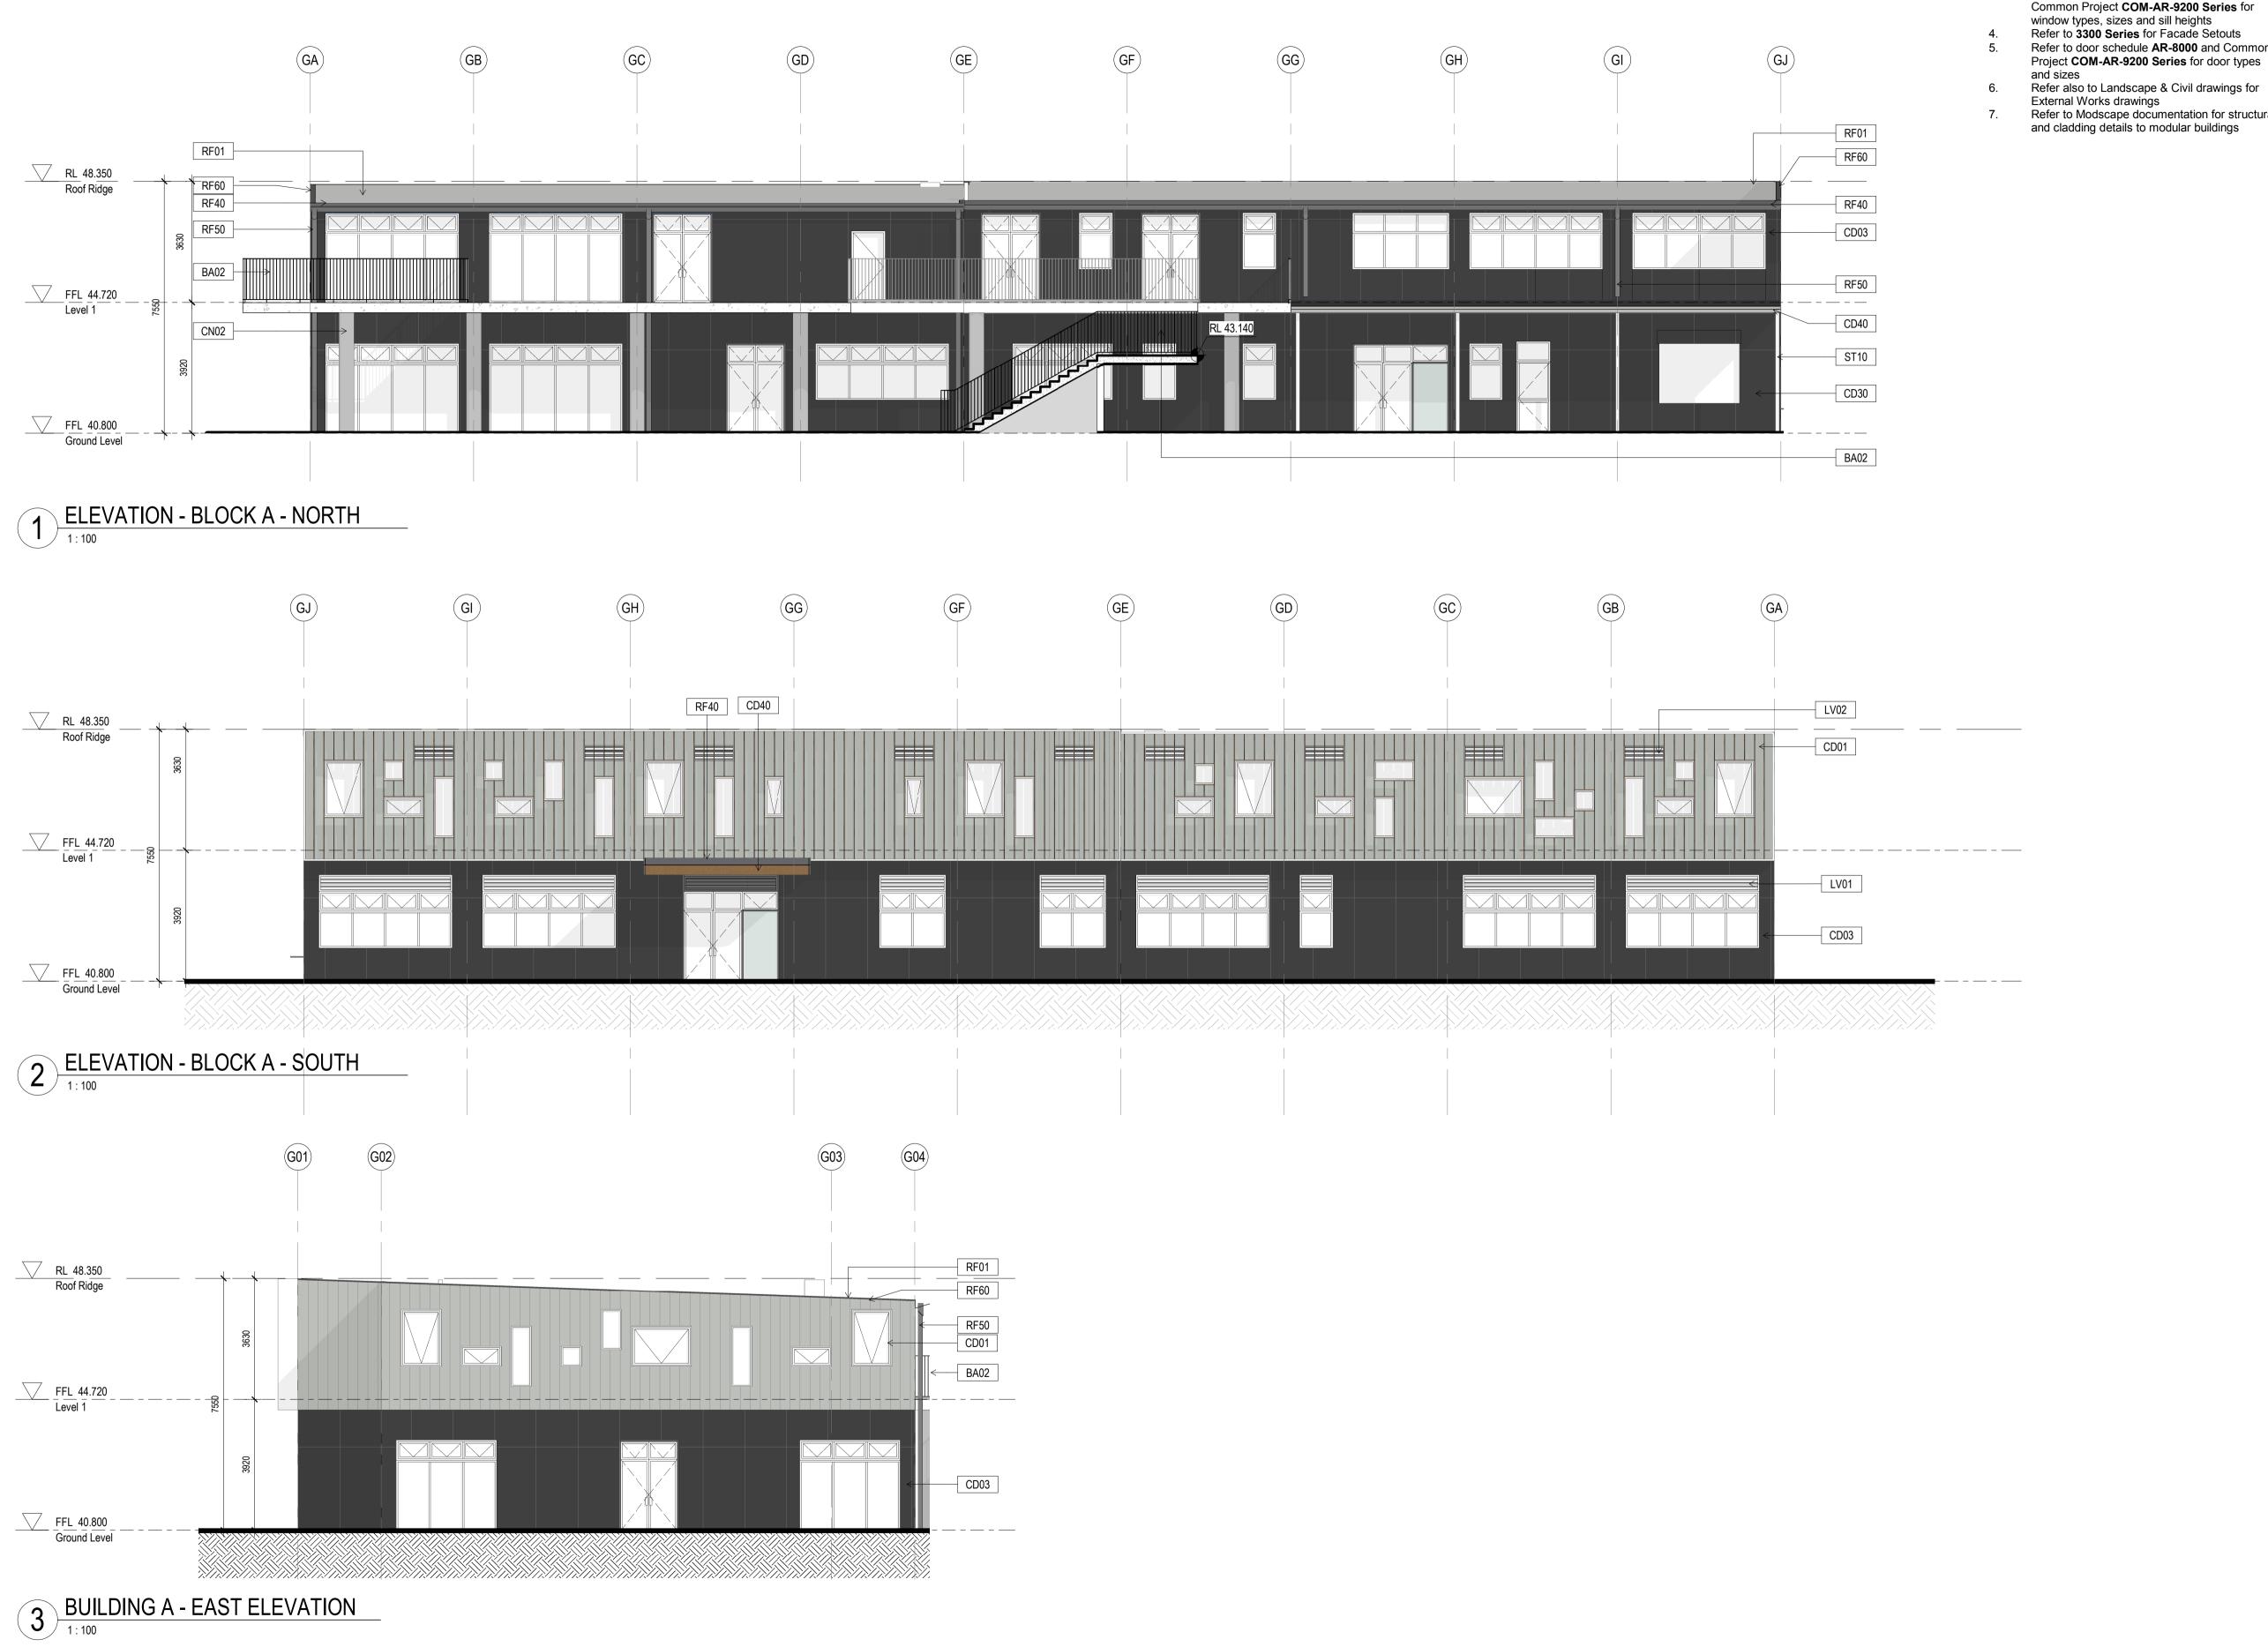

- Refer to technical schedule COM-AR-9700 for
- boxed code descriptions COLA roof structures removed from elevations for clarity. Refer to sections for details. Refer to 8100 Series for window schedule and
- Common Project COM-AR-9200 Series for window types, sizes and sill heights Refer to 3300 Series for Facade Setouts Refer to door schedule AR-8000 and Common
- Refer also to Landscape & Civil drawings for
- External Works drawings Refer to Modscape documentation for structural and cladding details to modular buildings

1. This drawing is the copyright of Group GSA Pty Ltd and may not be altered, reproduced or transmitted in any form or by any means in part or in whole without the written permission of Group GSA 2. Drawings to be printed in colour. 3. Do not scale drawings. Dimensions govern. 4. All dimensions are in millimetres unless noted otherwise.

5. All dimensions shall be verified on site before proceeding

6. Any areas indicated on this sheet are approximate and

indicative only.

Amendi	Amendments			
Issue	Description	Date		
A	FOR COORDINATION	27.03.201		
' B	DRAFT DETAILED DESIGN	17.04.201		
c	DRAFT DETAIL DESIGN	01.05.201		
' D	PROGRESS ISSUE	10.05.201		
Ė	SSD SUBMISSION	31.05.201		
1				

Elevations Legend

/01	Louvre, powdercoated PC01 (Basalt)	
/02	Louvre, powdercoated PC02 (Shale Grey)	
/05	Louvre, powdercoated PC05 (Fresh Gold)	
D01	Aluminium interlocking panel Colorbond Shale Grey	
003	Compressed Fibre Cement - Colour Granite	
D03	Compressed Fibre Cement - Colour Granite Aluminium interlocking panel Stryum Champagne	
	'	
D10	Aluminium interlocking panel Stryum Champagne	

Exposed sealed concrete wall / column Roof mounted ventilator


Balustrade (Hot Dip Gal)

Roof, Trimdek Colorbond Shale Grey Roof, Trimdek Colorbond Basalt Skylight, Fibreglass

Gutter, Colorbond Basalt Gutter, Colorbond Shale Grey Downpipes, Colorbond Basalt

Downpipes, Colorbond Shale Grey Roof Capping

Structural steel (Hot Dip Gal)

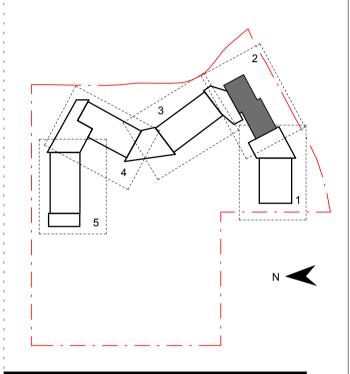

RICHARD CROOKES CONSTRUCTIONS





www.groupgsa.com T +612 9361 4144 F +612 9332 3458

architecture interior design urban design landscape nom architect M. Sheldon 3990

Project Title

JORDAN SPRINGS **PUBLIC SCHOOL**

BUILDING 'A' ELEVATIONS

Scale @ A1	As indicated
Drawing Created (date)	10/05/19
Drawing Created (by)	RS
Plotted and checked by	FT
Verified	MP
Approved	MB

180646 JS-AR-3001 E

- Refer to technical schedule **COM-AR-9700** for 2. Drawings to be printed in colour.
- boxed code descriptions
- Refer to **8100 Series** for window schedule and Common Project **COM_AR_9200 Series** for
 - Common Project COM-AR-9200 Series for window types, sizes and sill heights Refer to 3300 Series for Facade Setouts
- Refer to door schedule AR-8000 and Common Project COM-AR-9200 Series for door types and sizes
- Refer also to Landscape & Civil drawings for External Works drawings
- Refer to Modscape documentation for structural and cladding details to modular buildings

1. This drawing is the copyright of Group GSA Pty Ltd and may not be altered, reproduced or transmitted in any form or by any means in part or in whole without the written permission of Group GSA

3. Do not scale drawings. Dimensions govern. COLA roof structures removed from elevations for clarity. Pefor to sections for details


5. Both scale drawings. Emissions gets in the section of the sectio

	Amendments			
1	Issue	Description	Date	
	A	FOR COORDINATION	27.03.2019	
	' B	DRAFT DETAILED DESIGN	24.04.2019	
	C	PROGRESS ISSUE	10.05.2019	
	' D	SSD SUBMISSION	31.05.2019	
al				

Elevations Legend

BA01	Balustrade (Hot Dip Gal)
LV01	Louvre, powdercoated PC01 (Basalt)
LV02	Louvre, powdercoated PC02 (Shale Grey)
LV05	Louvre, powdercoated PC05 (Fresh Gold)
CD01	Aluminium interlocking panel Colorbond Shale Grey
CD03	Compressed Fibre Cement - Colour Granite
CD10	Aluminium interlocking panel Stryum Champagne
CD40	Aluminium sheet with timber appearance finish
CD70	Prefinished aluminium wall cladding trim
CN01	Exposed sealed concrete slab
CN02	Exposed sealed concrete wall / column
RA33	Roof mounted ventilator
RF01	Roof, Trimdek Colorbond Shale Grey
RF02	Roof, Trimdek Colorbond Basalt
RF10	Skylight, Fibreglass
RF40	Gutter, Colorbond Basalt
RF41	Gutter, Colorbond Shale Grey
RF50	Downpipes, Colorbond Basalt
RF51	Downpipes, Colorbond Shale Grey
RF60	Roof Capping

ST10 Structural steel (Hot Dip Gal)

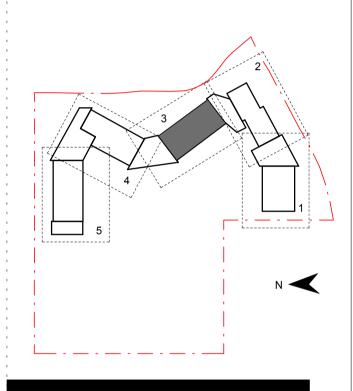

RICHARD CROOKES CONSTRUCTIONS





www.groupgsa.com T +612 9361 4144 F +612 9332 3458

architecture interior design urban design landscape nom architect M. Sheldon 3990


Project Title

JORDAN SPRINGS PUBLIC SCHOOL

BUILDING 'B1' ELEVATIONS

Scale @ A1		As indicated
Drawing Created (date)	10/05/19
Drawing Created (by)	RS
Plotted and check	ed by	FT
Verified		MP
Approved		MB
Project No	Drawing No	Issue

180646 JS-AR-3002 D \(\frac{1}{5} \)

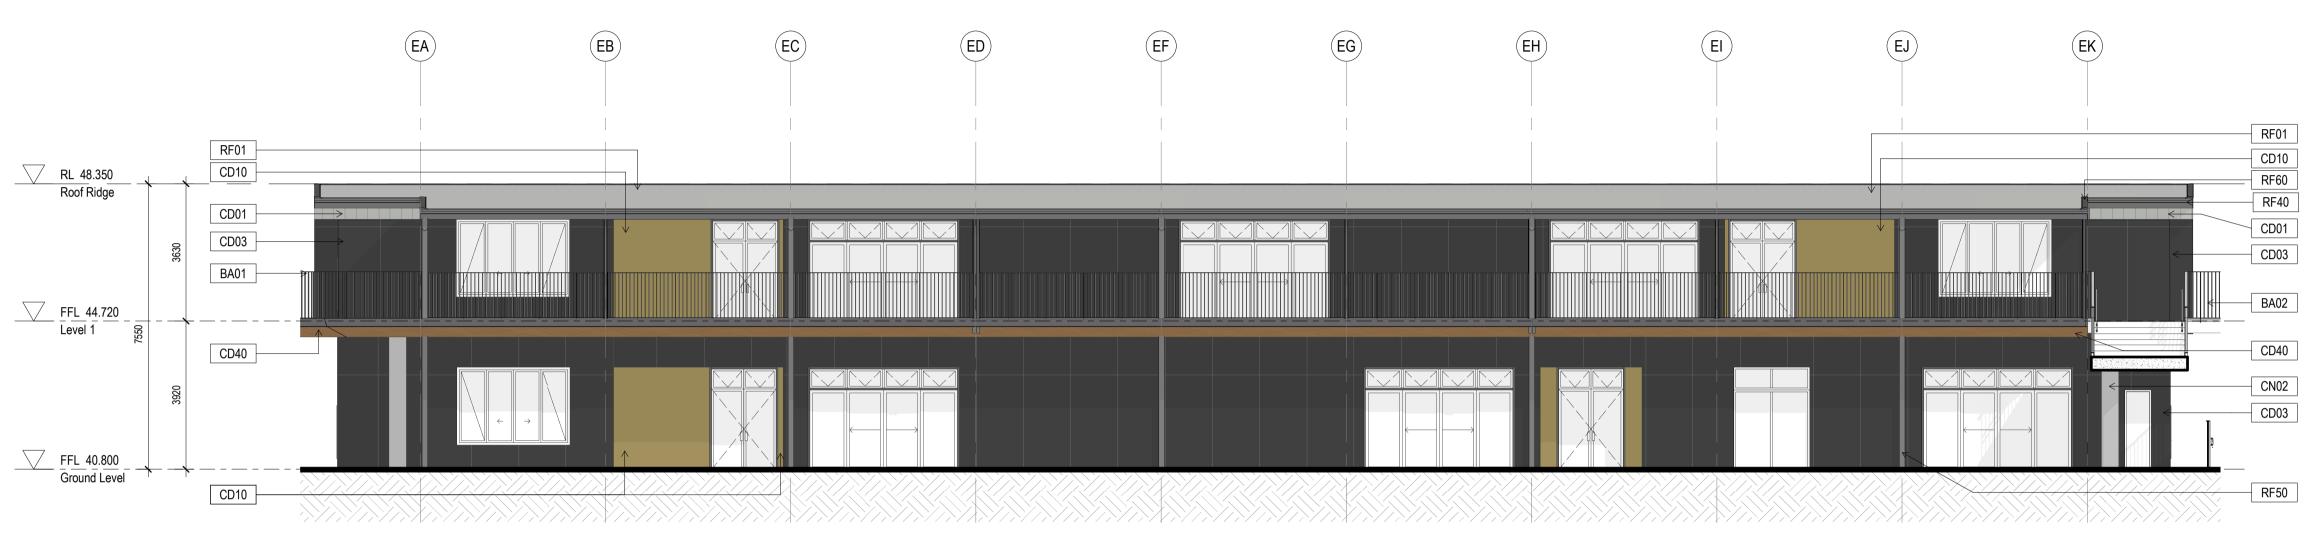

ELEVATION - BLOCK B1 - WEST



2 ELEVATION - BLOCK B1 - EAST

- Refer to technical schedule **COM-AR-9700** for
- boxed code descriptions

 COLA roof structures removed from elevations
- for clarity. Refer to sections for details.

 3. Refer to **8100 Series** for window schedule and Common Project **COM-AR-9200 Series** for window types, sizes and sill heights
- Project COM-AR-9200 Series for door types and sizes

 Refer also to Landscape & Civil drawings for
- External Works drawings

 7. Refer to Modscape documentation for structural and cladding details to modular buildings
- Refer to 3300 Series for Facade Setouts
 Refer to door schedule AR-8000 and Common
 Project COM-AR-9200 Series for door types

 Amenda Issue

Issue	Description	Date
Α	FOR COORDINATION	27.03.2019
В	DRAFT DETAILED DESIGN	24.04.2019
С	PROGRESS ISSUE	10.05.2019
D	SSD SUBMISSION	31.05.2019

1. This drawing is the copyright of Group GSA Pty Ltd and may not

be altered, reproduced or transmitted in any form or by any means in part or in whole without the written permission of Group GSA

4. All dimensions are in millimetres unless noted otherwise.
5. All dimensions shall be verified on site before proceeding

6. Any areas indicated on this sheet are approximate and

2. Drawings to be printed in colour.

indicative only.


3. Do not scale drawings. Dimensions govern.

Elevations Legend	

	BA01	Balustrade (Hot Dip Gal)
,	LV01	Louvre, powdercoated PC01 (Basalt)
,	LV02	Louvre, powdercoated PC02 (Shale Grey)
,	LV05	Louvre, powdercoated PC05 (Fresh Gold)
	CD01	Aluminium interlocking panel Colorbond Shale Grey
1	CD03	Compressed Fibre Cement - Colour Granit
	CD10	Aluminium interlocking panel Stryum Chan
	CD40	Aluminium sheet with timber appearance fi
,	CD70	Prefinished aluminium wall cladding trim
	CN01	Exposed sealed concrete slab
	CN02	Exposed sealed concrete wall / column
	RA33	Roof mounted ventilator
	RF01	Roof, Trimdek Colorbond Shale Grey
	RF02	Roof, Trimdek Colorbond Basalt
1	RF10	Skylight, Fibreglass
	RF40	Gutter, Colorbond Basalt
	RF41	Gutter, Colorbond Shale Grey
	RF50	Downpipes, Colorbond Basalt
	RF51	Downpipes, Colorbond Shale Grey

Roof Capping

ST10 Structural steel (Hot Dip Gal)

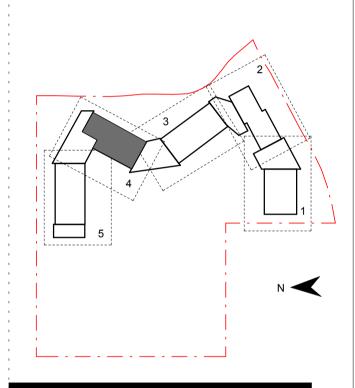





Group GSA Pty Ltd ABN 76 002 113 779 Level 7, 80 William St East Sydney NSW Australia 2011 www.groupgsa.com

T +612 9361 4144 F +612 9332 3458

architecture interior design urban design landscape nom architect M. Sheldon 3990

Project Title

JORDAN SPRINGS PUBLIC SCHOOL

BUILDING 'B2' ELEVATIONS

Scale @ A1	Α	s indicated	
Drawing Created (date)		10/05/19	
Drawing Created (by)		RS	
Plotted and checked by		FT	
Verified		MP	Σ
Approved		MB	14 P
Project No	Drawing No	Issue	9 4:03
180646 J	S-AR-3000	3 D	5/31/2019 4:03:14 PM





2 ELEVATION - BLOCK B2 - EAST



- Refer to technical schedule COM-AR-9700 for
- boxed code descriptions COLA roof structures removed from elevations
- for clarity. Refer to sections for details. Refer to 8100 Series for window schedule and Common Project COM-AR-9200 Series for
- window types, sizes and sill heights Refer to 3300 Series for Facade Setouts Refer to door schedule AR-8000 and Common
- Project COM-AR-9200 Series for door types and sizes Refer also to Landscape & Civil drawings for
- External Works drawings
- Refer to Modscape documentation for structural and cladding details to modular buildings

1. This drawing is the copyright of Group GSA Pty Ltd and may not be altered, reproduced or transmitted in any form or by any means in part or in whole without the written permission of Group GSA 2. Drawings to be printed in colour. 3. Do not scale drawings. Dimensions govern. 4. All dimensions are in millimetres unless noted otherwise. 5. All dimensions shall be verified on site before proceeding 6. Any areas indicated on this sheet are approximate and indicative only.

1		
•		


Amendments		
Issue	Description	Date
A	FOR COORDINATION	27.03.2019
' B	DRAFT DETAILED DESIGN	24.04.2019
c	PROGRESS ISSUE	10.05.2019
' D	SSD SUBMISSION	31.05.2019

Elevations Legend

BA01 Balustrade (Hot Dip Gal)

		(()
,	LV01	Louvre, powdercoated PC01 (Basalt)
	LV02	Louvre, powdercoated PC02 (Shale Grey)
,	LV05	Louvre, powdercoated PC05 (Fresh Gold)
1	CD01	Aluminium interlocking panel Colorbond Shale Grey
1	CD03	Compressed Fibre Cement - Colour Grani
,	CD10	Aluminium interlocking panel Stryum Char
,	CD40	Aluminium sheet with timber appearance to
1	CD70	Prefinished aluminium wall cladding trim
,	CN01	Exposed sealed concrete slab
1	CN02	Exposed sealed concrete wall / column
,	RA33	Roof mounted ventilator
1	RF01	Roof, Trimdek Colorbond Shale Grey
1	RF02	Roof, Trimdek Colorbond Basalt
1	RF10	Skylight, Fibreglass
1	RF40	Gutter, Colorbond Basalt
1	RF41	Gutter, Colorbond Shale Grey
1	RF50	Downpipes, Colorbond Basalt
1	RF51	Downpipes, Colorbond Shale Grey
1	RF60	Roof Capping

ST10 Structural steel (Hot Dip Gal)

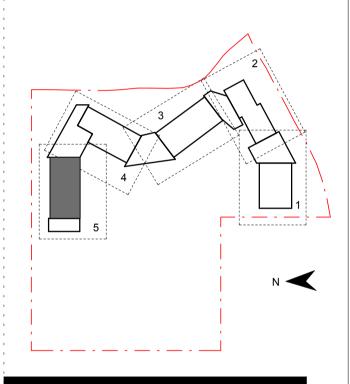





Group GSA Pty Ltd ABN 76 002 113 779 Level 7, 80 William St East Sydney NSW Australia 2011

www.groupgsa.com T +612 9361 4144 F +612 9332 3458

architecture interior design urban design landscape nom architect M. Sheldon 3990


Project Title JORDAN SPRINGS PUBLIC SCHOOL

BUILDING 'B3' ELEVATIONS


Scale @ A1	As indicated	
Scale @ A1	As indicated	
Drawing Created (date)	10/05/19	
Drawing Created (by)	RS	
Plotted and checked by	FT	
Verified	MP :	∑
Approved	MB S	3:40 F
Project No Drawing No	Issue	19 4:0
180646 JS-AR-300)4 D	5/31/2019 4:03:40



ELEVATION - BLOCK B3 - SOUTH

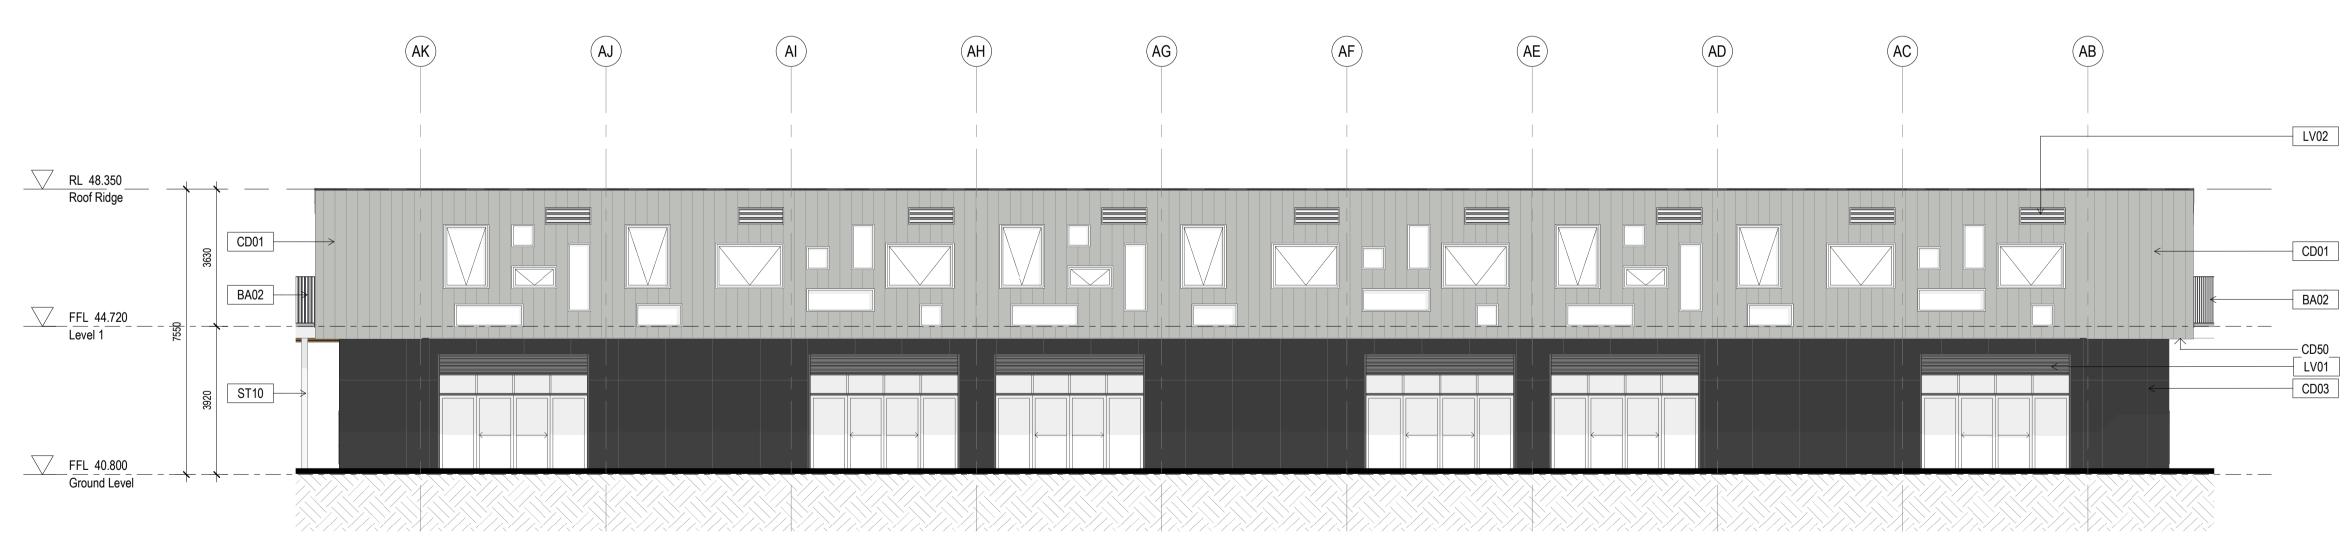

2 ELEVATION - BLOCK B3 - NORTH

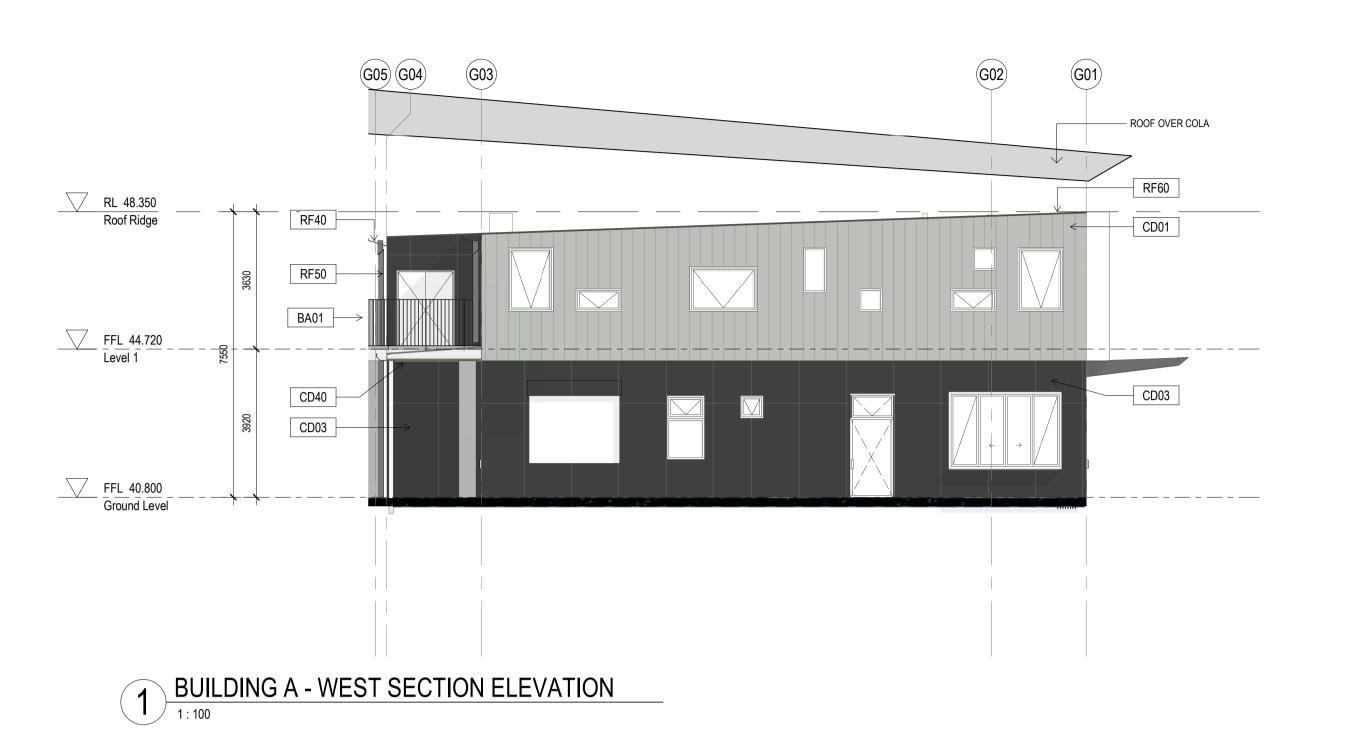

- Refer to technical schedule COM-AR-9700 for boxed code descriptions
- COLA roof structures removed from elevations for clarity. Refer to sections for details. indicative only.
- Refer to 8100 Series for window schedule and Common Project COM-AR-9200 Series for window types, sizes and sill heights Refer to 3300 Series for Facade Setouts
- Project COM-AR-9200 Series for door types and sizes
- Refer also to Landscape & Civil drawings for
- External Works drawings
 Refer to Modscape documentation for structural and cladding details to modular buildings

1. This drawing is the copyright of Group GSA Pty Ltd and may not be altered, reproduced or transmitted in any form or by any means in part or in whole without the written permission of Group GSA 2. Drawings to be printed in colour.3. Do not scale drawings. Dimensions govern. 4. All dimensions are in millimetres unless noted otherwise. 5. All dimensions shall be verified on site before proceeding
6. Any areas indicated on this sheet are approximate and

' Amendments

Refer to door schedule AR-8000 and Common	Issue	Description	Date
Project COM-AR-9200 Series for door types	A	SSD SUBMISSION	31.05.2019

Elevations Legend

_V01	Louvre, powdercoated PC01 (Basalt)
V02	Louvre, powdercoated PC02 (Shale Grey)
_V05	Louvre, powdercoated PC05 (Fresh Gold)
CD01	Aluminium interlocking panel Colorbond Shale Grey
CD03	Compressed Fibre Cement - Colour Granite
CD10	Aluminium interlocking panel Stryum Cham
CD40	Aluminium sheet with timber appearance fi
CD70	Prefinished aluminium wall cladding trim
CN01	Exposed sealed concrete slab
CN02	Exposed sealed concrete wall / column
RA33	Roof mounted ventilator
RF01	Roof, Trimdek Colorbond Shale Grey


Roof, Trimdek Colorbond Basalt

Balustrade (Hot Dip Gal)





Roof Capping Structural steel (Hot Dip Gal)

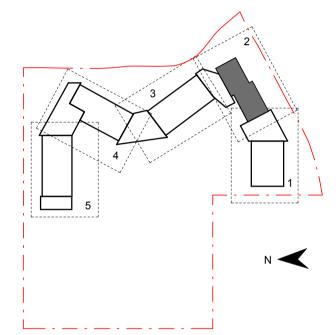








www.groupgsa.com T +612 9361 4144 F +612 9332 3458

architecture interior design urban design landscape nom architect M. Sheldon 3990




BUILDING 'A' SECTION-ELEVATIONS

Drawing Created (,	05/30/19
Drawing Created ((Dy)	Author
Plotted and check	ed by	Designer
Verified		Checker
Approved		Approver
Project No	Drawing No	Issue

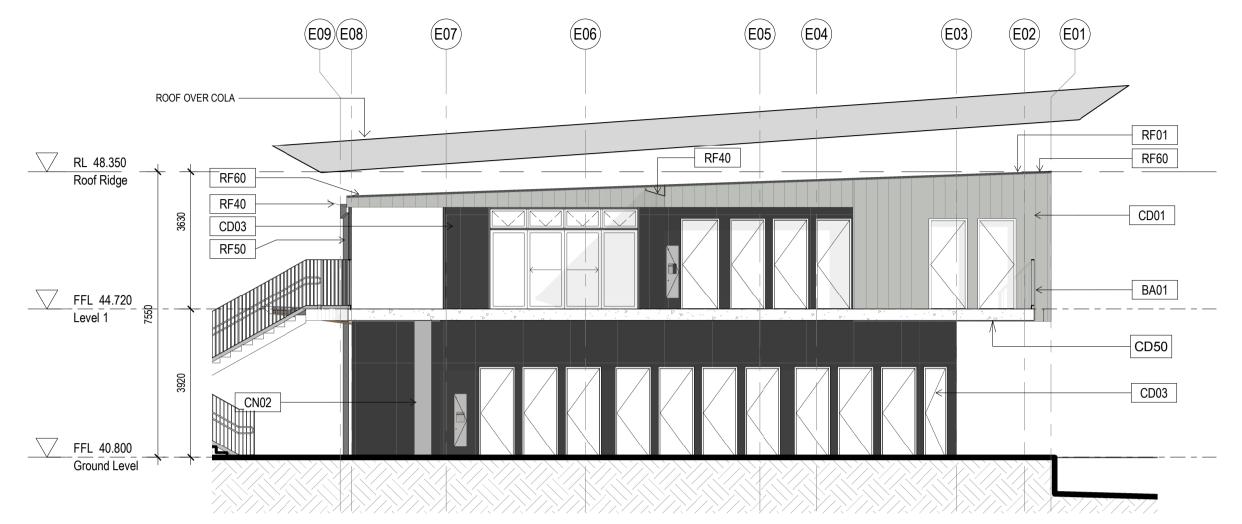

1 HOMEBASE B1 - SOUTH SECTION ELEVATION
1:100

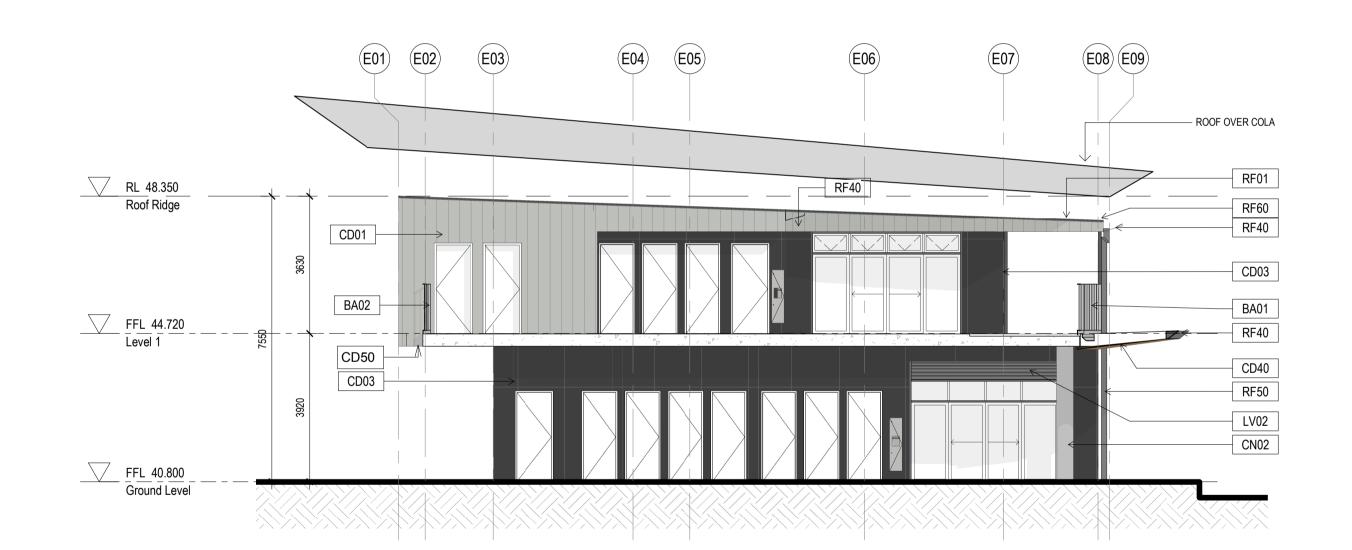

2 HOMEBASE B1 -NORTH SECTION ELEVATION

Elevation Notes:

- Refer to technical schedule COM-AR-9700 for
- boxed code descriptions COLA roof structures removed from elevations for clarity. Refer to sections for details.
- Refer to 8100 Series for window schedule and Common Project COM-AR-9200 Series for window types, sizes and sill heights
- Refer to **3300 Series** for Facade Setouts Refer to door schedule AR-8000 and Common Project COM-AR-9200 Series for door types and sizes
- Refer also to Landscape & Civil drawings for
- External Works drawings Refer to Modscape documentation for structural and cladding details to modular buildings

1. This drawing is the copyright of Group GSA Pty Ltd and may not

be altered, reproduced or transmitted in any form or by any means in part or in whole without the written permission of Group GSA 2. Drawings to be printed in colour. 3. Do not scale drawings. Dimensions govern. 4. All dimensions are in millimetres unless noted otherwise. 5. All dimensions shall be verified on site before proceeding 6. Any areas indicated on this sheet are approximate and

indicative only.

Issue Description SSD SUBMISSION 31.05.2019

Elevations Legend

BA01	Balustrade (Hot Dip Gal)
LV01	Louvre, powdercoated PC01 (Basalt)
LV02	Louvre, powdercoated PC02 (Shale Grey)
LV05	Louvre, powdercoated PC05 (Fresh Gold)
CD01	Aluminium interlocking panel Colorbond Shale Grey
CD03	Compressed Fibre Cement - Colour Granite

Compressed Fibre Cement - Colour Granite Aluminium interlocking panel Stryum Champagne Aluminium sheet with timber appearance finish Prefinished aluminium wall cladding trim


CD70 Exposed sealed concrete slab Exposed sealed concrete wall / column

Roof mounted ventilator Roof, Trimdek Colorbond Shale Grey

Roof, Trimdek Colorbond Basalt Skylight, Fibreglass Gutter, Colorbond Basalt Gutter, Colorbond Shale Grey

RF50 Downpipes, Colorbond Basalt RF51 Downpipes, Colorbond Shale Grey

Roof Capping Structural steel (Hot Dip Gal)

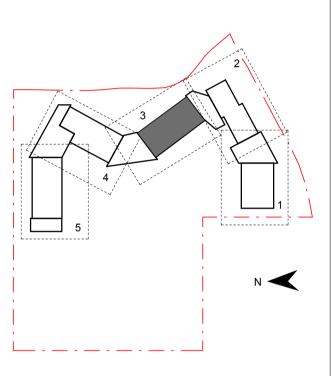

RICHARD CROOKES CONSTRUCTIONS





www.groupgsa.com T +612 9361 4144 F +612 9332 3458

architecture interior design urban design landscape nom architect M. Sheldon 3990


Project Title




BUILDING 'B1' SECTION-ELEVATIONS

Scale @ A1		As indicated
Drawing Created (date	e)	05/30/19
Drawing Created (by)		Autho
Plotted and checked I	ру	Designe
Verified		Checke
Approved		Approve
Project No	Drawing No	Issue

180646 JS-AR-3051 A 🖁

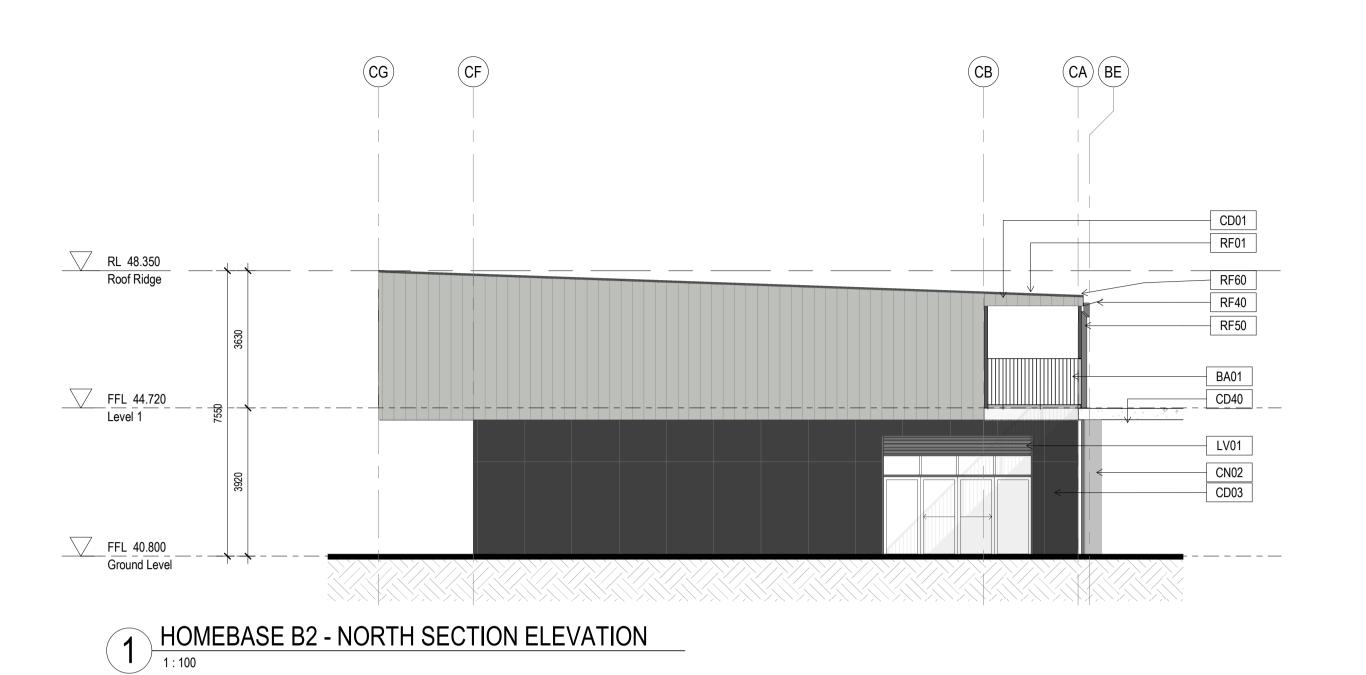

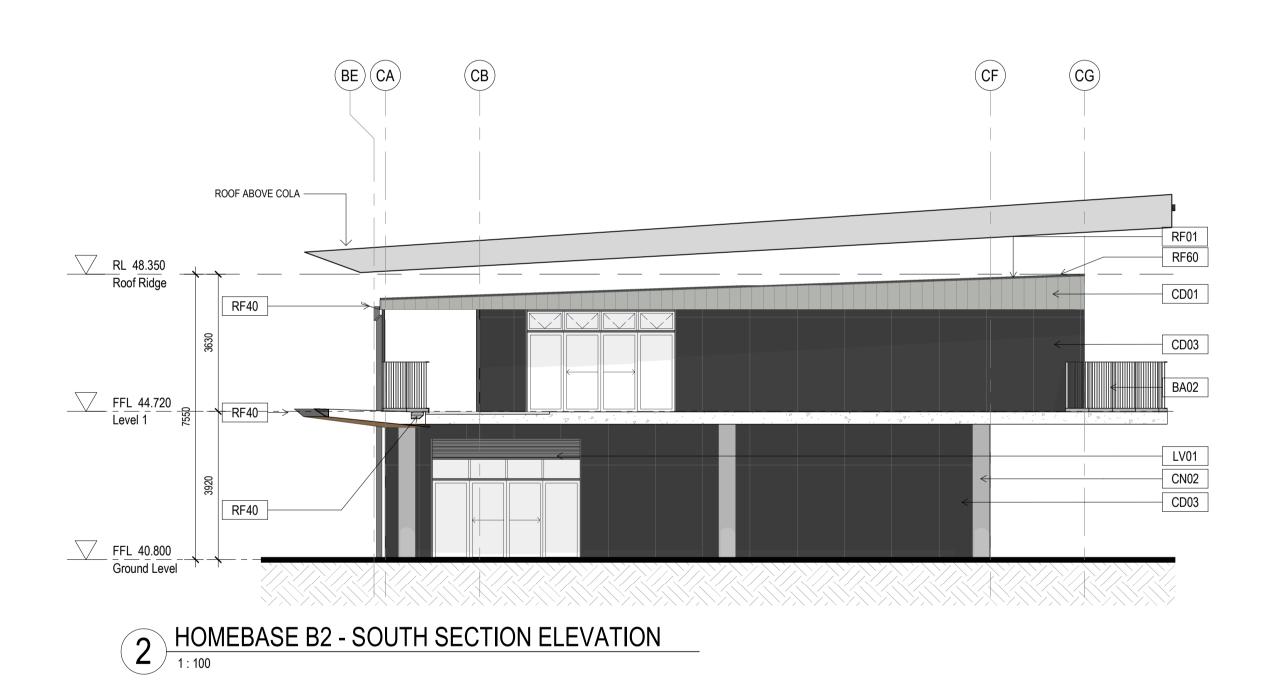

Elevation Notes:

- boxed code descriptions COLA roof structures removed from elevations
 - Refer to 8100 Series for window schedule and Common Project COM-AR-9200 Series for window types, sizes and sill heights
- External Works drawings Refer to Modscape documentation for structural

- Refer to technical schedule COM-AR-9700 for
- for clarity. Refer to sections for details.
- Refer to **3300 Series** for Facade Setouts Refer to door schedule AR-8000 and Common Project COM-AR-9200 Series for door types
- Refer also to Landscape & Civil drawings for
- and cladding details to modular buildings

1. This drawing is the copyright of Group GSA Pty Ltd and may not be altered, reproduced or transmitted in any form or by any means in part or in whole without the written permission of Group GSA 2. Drawings to be printed in colour.3. Do not scale drawings. Dimensions govern. 4. All dimensions are in millimetres unless noted otherwise. 5. All dimensions shall be verified on site before proceeding
6. Any areas indicated on this sheet are approximate and

indicative only.


	Issue	Description	Date
l	A	SSD SUBMISSION	31.05.201
	1		

Elevations Legend

BA01	Balustrade (Hot Dip Gal)
LV01	Louvre, powdercoated PC01 (Basalt)
LV02	Louvre, powdercoated PC02 (Shale Grey)
LV05	Louvre, powdercoated PC05 (Fresh Gold)
CD01	Aluminium interlocking panel Colorbond Shale Grey
CD03	Compressed Fibre Cement - Colour Granite
CD10	Aluminium interlocking panel Stryum Cham
CD40	Aluminium sheet with timber appearance fire
CD70	Prefinished aluminium wall cladding trim
CN01	Exposed sealed concrete slab
CN02	Exposed sealed concrete wall / column
RA33	Roof mounted ventilator
RF01	Roof, Trimdek Colorbond Shale Grey
RF02	Roof, Trimdek Colorbond Basalt
RF10	Skylight, Fibreglass
RF40	Gutter, Colorbond Basalt
RF41	Gutter, Colorbond Shale Grey
RF50	Downpipes, Colorbond Basalt
RF51	Downpipes, Colorbond Shale Grey

Roof Capping

Structural steel (Hot Dip Gal)

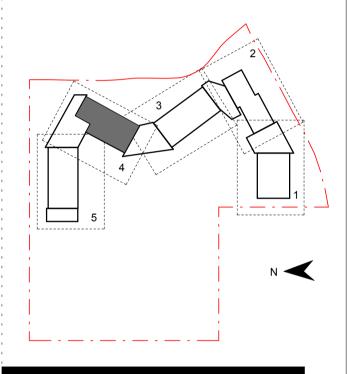

RICHARD CROOKES CONSTRUCTIONS





www.groupgsa.com T +612 9361 4144 F +612 9332 3458


architecture interior design urban design landscape nom architect M. Sheldon 3990




BUILDING 'B2' SECTION-ELEVATIONS

Project No	Drawing No	Issue
Approved		Approve
Verified		Checke
Plotted and check	ked by	Designe
Drawing Created	(by)	Autho
Drawing Created	(date)	05/30/19
Scale @ A1		As indicated

180646 JS-AR-3052 A 🖫

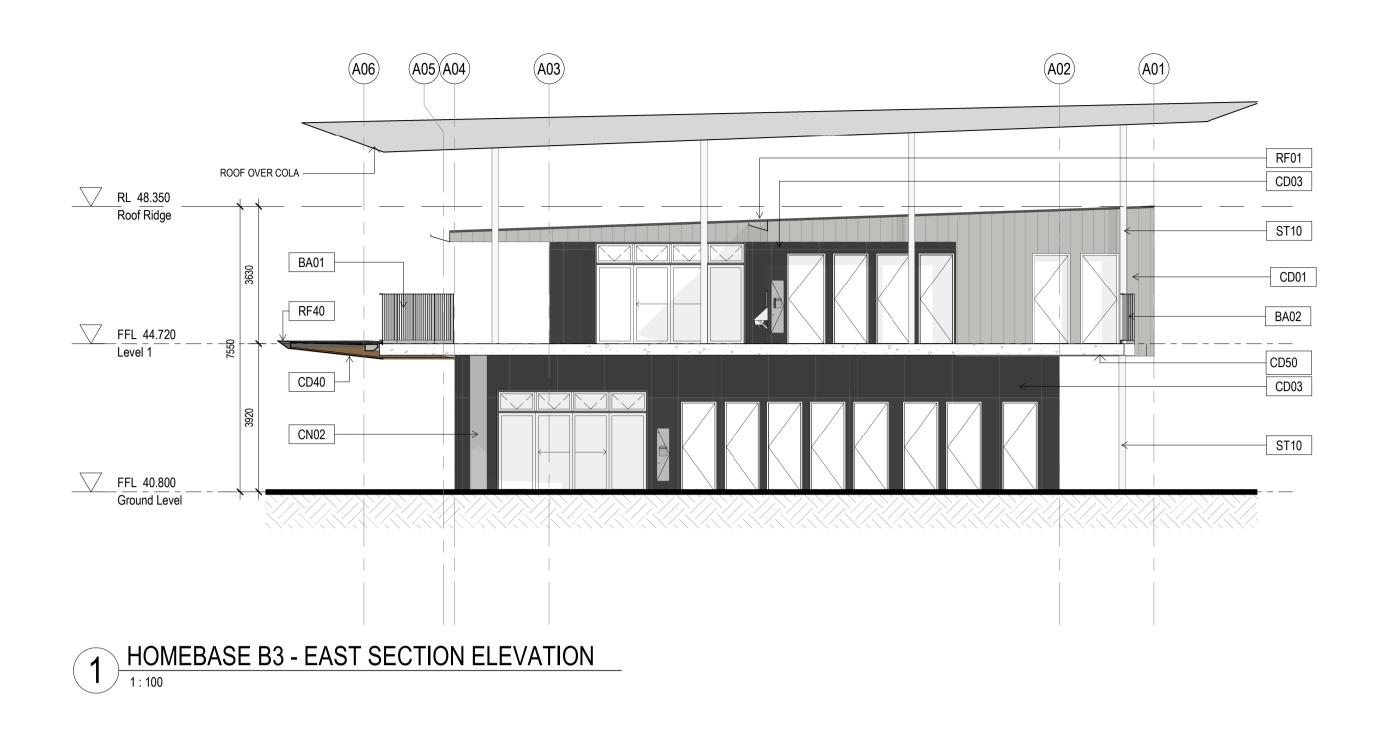

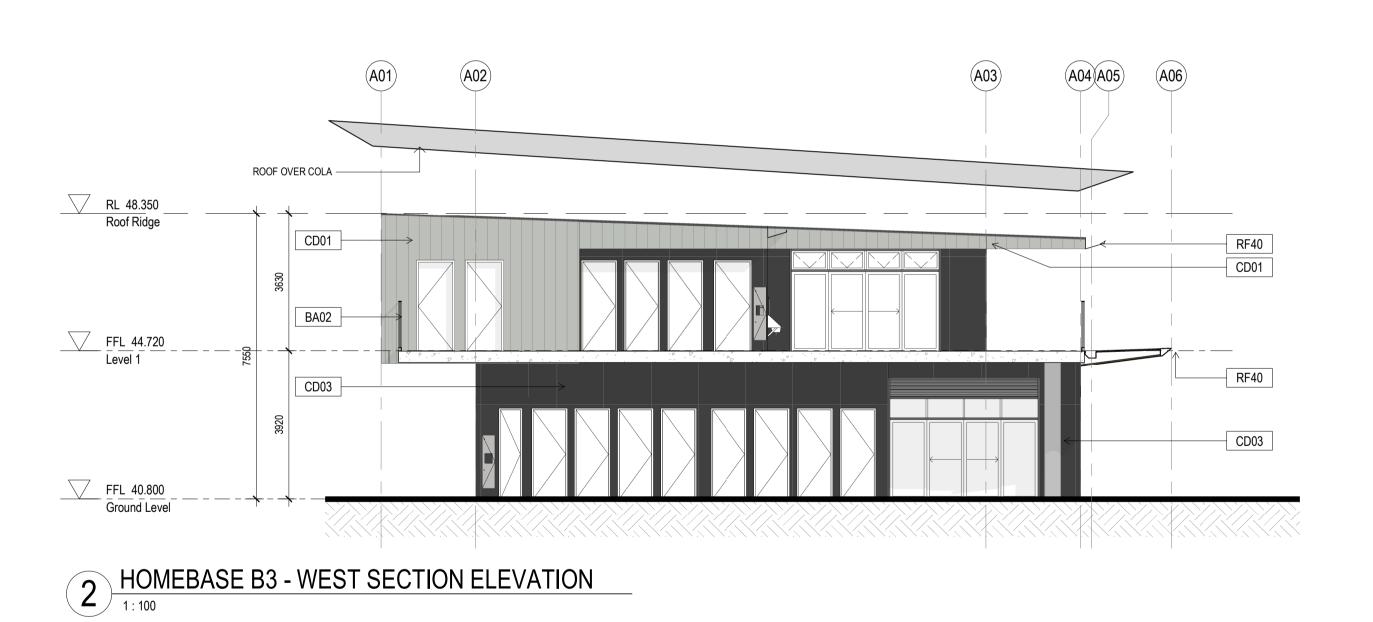

- Refer to technical schedule COM-AR-9700 for
- boxed code descriptions COLA roof structures removed from elevations
- for clarity. Refer to sections for details. Refer to 8100 Series for window schedule and Common Project COM-AR-9200 Series for window types, sizes and sill heights
- Refer to 3300 Series for Facade Setouts Refer to door schedule AR-8000 and Common Project COM-AR-9200 Series for door types
- Refer also to Landscape & Civil drawings for External Works drawings
- Refer to Modscape documentation for structural and cladding details to modular buildings

be altered, reproduced or transmitted in any form or by any means in part or in whole without the written permission of Group GSA 2. Drawings to be printed in colour. 3. Do not scale drawings. Dimensions govern. 4. All dimensions are in millimetres unless noted otherwise. 5. All dimensions shall be verified on site before proceeding 6. Any areas indicated on this sheet are approximate and

1. This drawing is the copyright of Group GSA Pty Ltd and may not

['] Amendments

indicative only.

Issue Description A SSD SUBMISSION 31.05.2019

Elevations Legend

\01	Balustrade (Hot Dip Gal)
/01	Louvre, powdercoated PC01 (Basalt)
/02	Louvre, powdercoated PC02 (Shale Grey)
/05	Louvre, powdercoated PC05 (Fresh Gold)
001	Aluminium interlocking panel Colorbond Shale Grey


Compressed Fibre Cement - Colour Granite Aluminium interlocking panel Stryum Champagne Aluminium sheet with timber appearance finish

Prefinished aluminium wall cladding trim Exposed sealed concrete slab Exposed sealed concrete wall / column Roof mounted ventilator

Roof, Trimdek Colorbond Shale Grey Roof, Trimdek Colorbond Basalt Skylight, Fibreglass

Gutter, Colorbond Basalt Gutter, Colorbond Shale Grey Downpipes, Colorbond Basalt Downpipes, Colorbond Shale Grey

Roof Capping Structural steel (Hot Dip Gal)

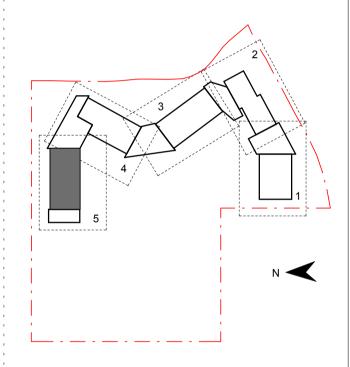

RICHARD CROOKES CONSTRUCTIONS





www.groupgsa.com T +612 9361 4144 F +612 9332 3458

architecture interior design urban design landscape nom architect M. Sheldon 3990


Project Title


JORDAN SPRINGS **PUBLIC SCHOOL**


BUILDING 'B3' SECTION-ELEVATIONS

Scale @ A1	As indicated
Drawing Created (date)	05/29/19
Drawing Created (by)	Autho
Plotted and checked by	Designe
Verified	Checke
Approved	Approve
Project No Drawing No	Issue

180646 JS-AR-3053 A 🖁

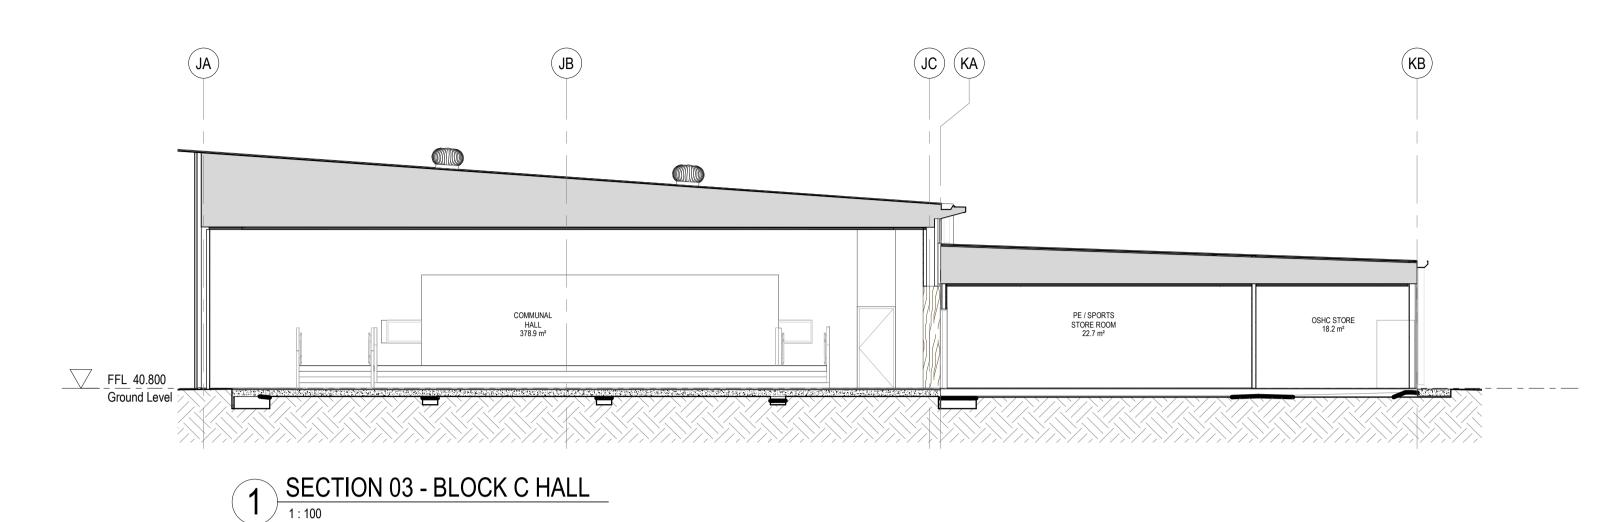

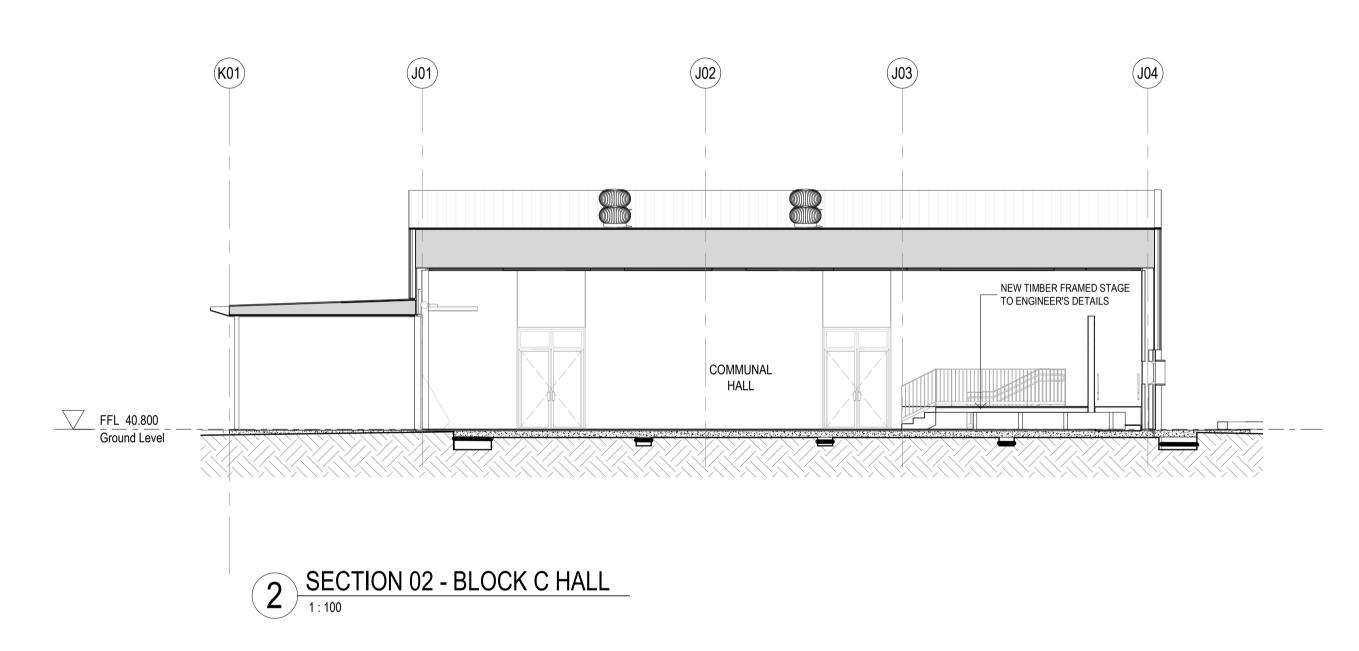

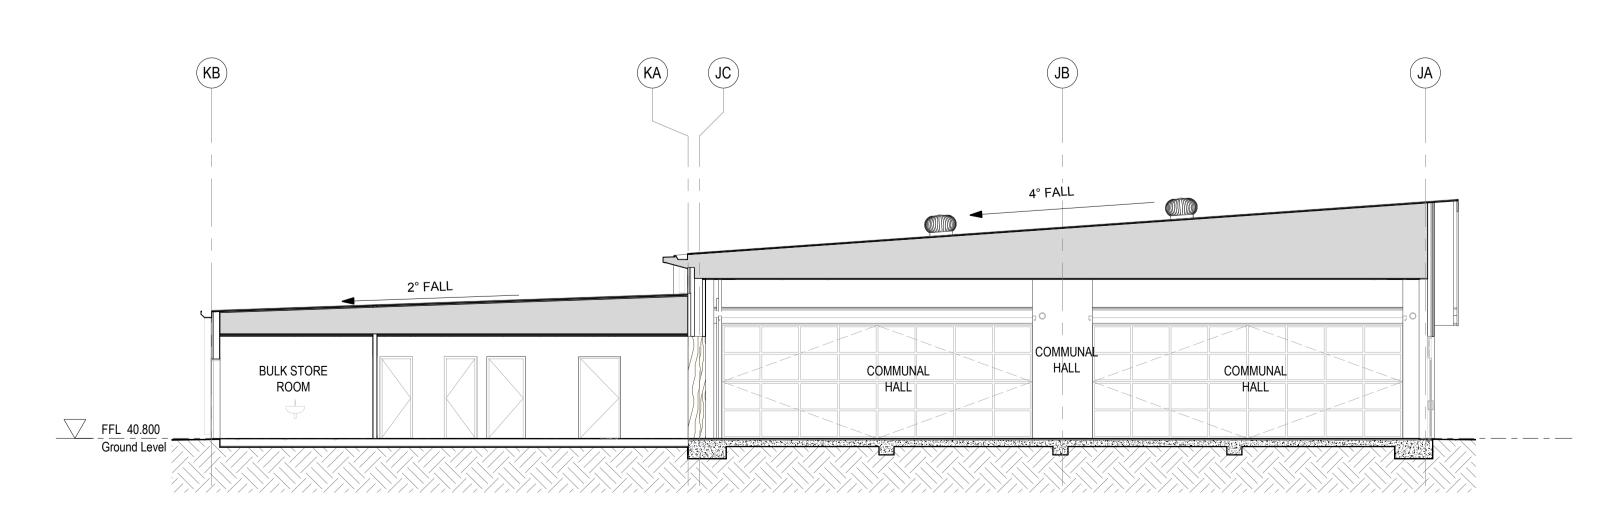

3 SECTION 01 - BLOCK C HALL


Section Notes:

- Refer to technical schedule **COM-AR-9700** for boxed code descriptions
- 2. All light switches to be at 1000mm above FFL and no less
- than 500 from internal corner

 3. All inground stormwater connections to terminate at concrete
- Refer to 8100 Series for window schedule and Common Project COM-AR-9200 Series for window types, sizes and
- 5. Refer to **2300 Series** for structural setout of insitu concrete and steel columns. To be read in conjunction with structural engineers details.
 - Refer to door schedule **AR-8000** and Common Project **COM-AR-9200 Series** for door types and sizes
- 7. Refer also to Landscape & Civil drawings for External Works
- 8. Refer to Modscape documentation for all details to modular buildings

- 1. This drawing is the copyright of Group GSA Pty Ltd and may not be altered, reproduced or transmitted in any form or by any means in part or in whole without the written permission of Group GSA 2. Drawings to be printed in colour.
- 3. Do not scale drawings. Dimensions govern.
 4. All dimensions are in millimetres unless noted otherwise.
 5. All dimensions shall be verified on site before proceeding
 6. Any areas indicated on this sheet are approximate and indicative only.

i i		
Amend	ments	
Issue	Description	Date
A	PROGRESS ISSUE	10.05.2019
<u>'</u> B	SSD SUBMISSION	31.05.2019

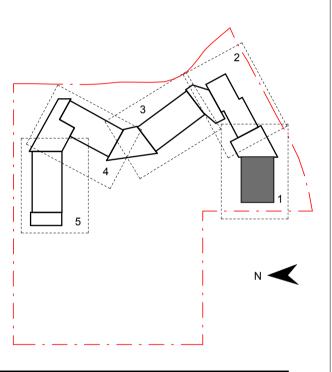







www.groupgsa.com
T +612 9361 4144 F +612 9332 3458

architecture interior design urban design landscape nom architect M. Sheldon 3990

Project Title





Drawing Title

SECTIONS - BLOCK C

Scale @ A1	As indicated
Drawing Created (date)	10/05/19
Drawing Created (by)	FC
Plotted and checked by	НК
Verified	FC
Approved	MP
Project No Drawing No	Issue

180646 JS-AR-3100 B

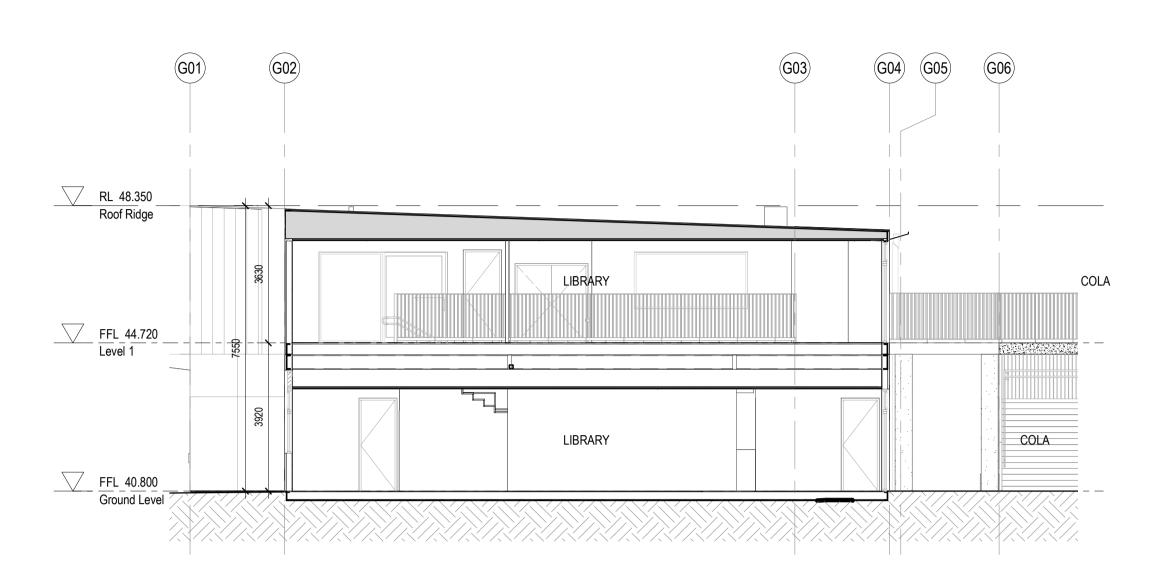

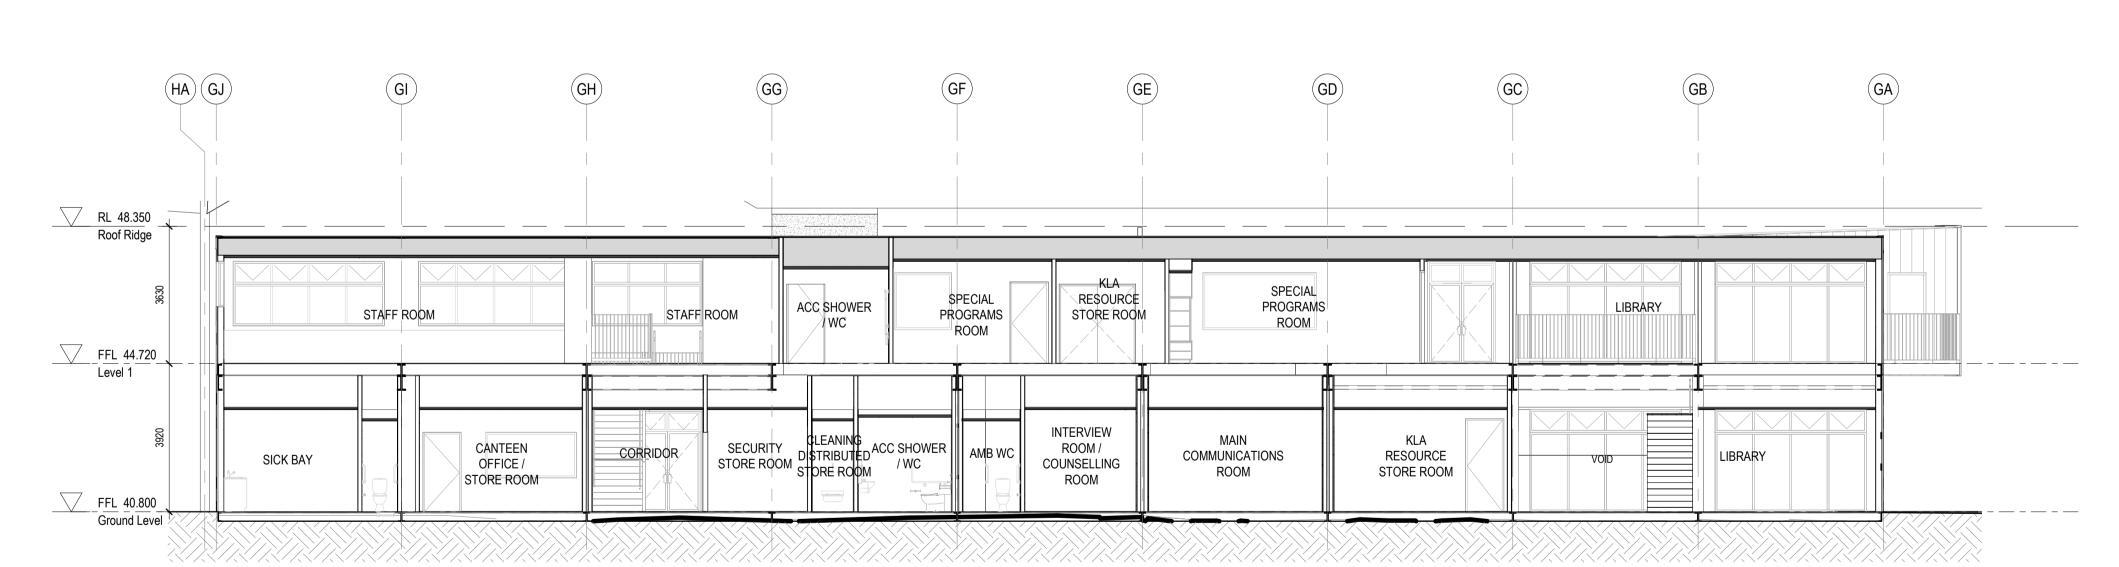


2 SECTION 02 - BLOCK A ADMIN

1 SECTION 01 - BLOCK A ADMIN

- Refer to technical schedule COM-AR-9700 for boxed code
- descriptions All light switches to be at 1000mm above FFL and no less
- than 500 from internal corner All inground stormwater connections to terminate at concrete
- Refer to **8100 Series** for window schedule and Common Project COM-AR-9200 Series for window types, sizes and sill heights Refer to 2300 Series for structural setout of insitu concrete
- and steel columns. To be read in conjunction with structural engineers details.
- Refer to door schedule AR-8000 and Common Project COM-AR-9200 Series for door types and sizes
- Refer also to Landscape & Civil drawings for External Works drawings
- Refer to Modscape documentation for all details to modular buildings

- 1. This drawing is the copyright of Group GSA Pty Ltd and may not be altered, reproduced or transmitted in any form or by any means in part or in whole without the written permission of Group GSA 2. Drawings to be printed in colour. 3. Do not scale drawings. Dimensions govern. 4. All dimensions are in millimetres unless noted otherwise.
- 5. All dimensions shall be verified on site before proceeding 6. Any areas indicated on this sheet are approximate and indicative only.

Issue Description PROGRESS ISSUE 10.05.2019 SSD SUBMISSION 31.05.2019

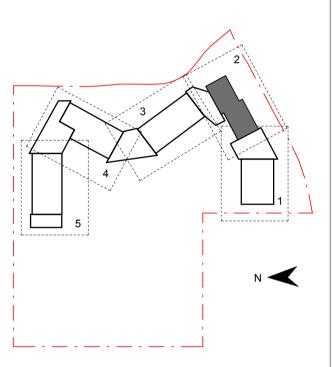







www.groupgsa.com T +612 9361 4144 F +612 9332 3458

architecture interior design urban design landscape nom architect M. Sheldon 3990


Project Title




SECTIONS - BLOCK A

Scale @ A1	As indicated
Drawing Created (date)	10/05/19
Drawing Created (by)	FC
Plotted and checked by	НК
Verified	FC
Approved	MP
Project No Drawing No	Issue

180646 JS-AR-3101 B

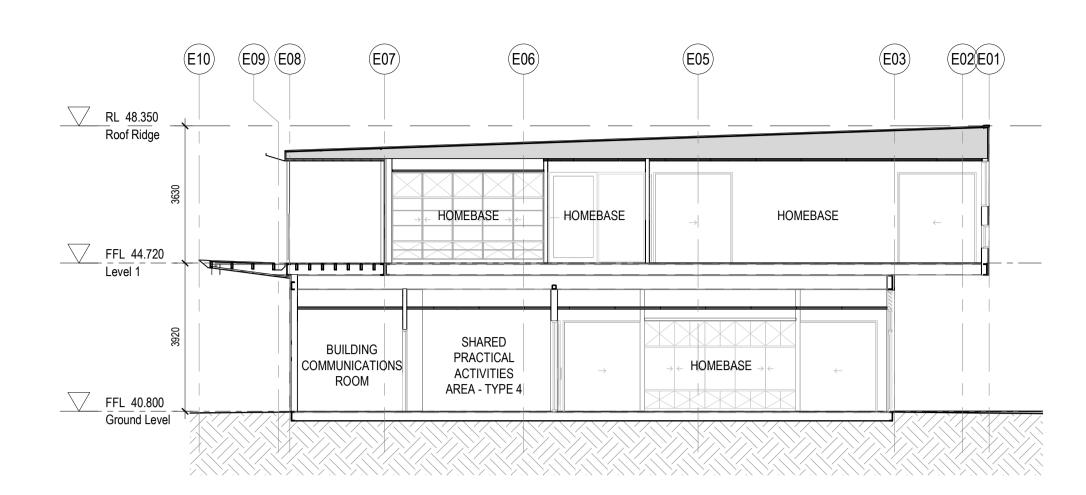

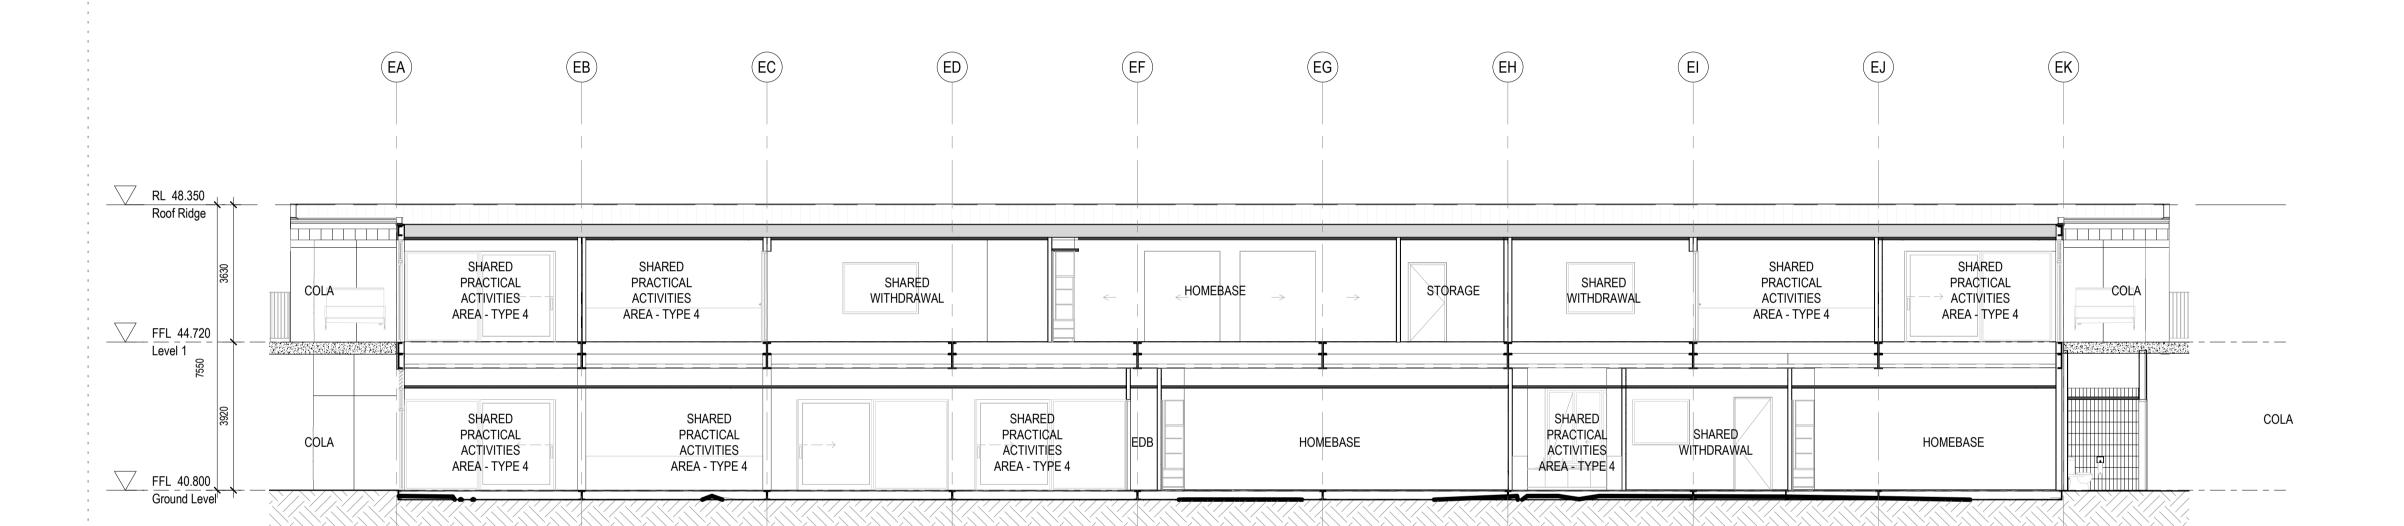

2 SECTION 02 - BLOCK B1


1 SECTION 01 - BLOCK B1

- 1. Refer to technical schedule **COM-AR-9700** for boxed code
- All light switches to be at 1000mm above FFL and no less
- than 500 from internal corner All inground stormwater connections to terminate at concrete
- Refer to **8100 Series** for window schedule and Common Project **COM-AR-9200 Series** for window types, sizes and
- Refer to 2300 Series for structural setout of insitu concrete and steel columns. To be read in conjunction with structural engineers details.
- Refer to door schedule AR-8000 and Common Project COM-AR-9200 Series for door types and sizes
- Refer also to Landscape & Civil drawings for External Works drawings
- Refer to Modscape documentation for all details to modular

1. This drawing is the copyright of Group GSA Pty Ltd and may not be altered, reproduced or transmitted in any form or by any means in part or in whole without the written permission of Group GSA 2. Drawings to be printed in colour. 3. Do not scale drawings. Dimensions govern.

4. All dimensions are in millimetres unless noted otherwise. 5. All dimensions shall be verified on site before proceeding
6. Any areas indicated on this sheet are approximate and indicative only.

Amendi	Helits	
Issue	Description	Date
A	PROGRESS ISSUE	10.05.2019
' B	SSD SUBMISSION	31.05.2019

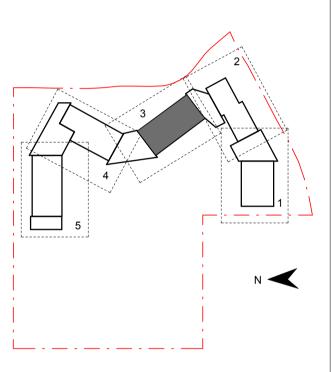







www.groupgsa.com T +612 9361 4144 F +612 9332 3458

architecture interior design urban design landscape nom architect M. Sheldon 3990

Project Title




SECTIONS - BLOCK B1

Scale @ A1		As indicated
Drawing Created (dat	10/05/19	
Drawing Created (by)	FC	
Plotted and checked	НК	
Verified		FC
Approved		MP
Project No	Drawing No	Issue


180646 JS-AR-3102 B \(\frac{\text{N}}{5} \)

Section Notes:


- descriptions All light switches to be at 1000mm above FFL and no less
- All inground stormwater connections to terminate at concrete
- Refer to **8100 Series** for window schedule and Common Project **COM-AR-9200 Series** for window types, sizes and sill heights
- engineers details.
- COM-AR-9200 Series for door types and sizes
- Refer to Modscape documentation for all details to modular

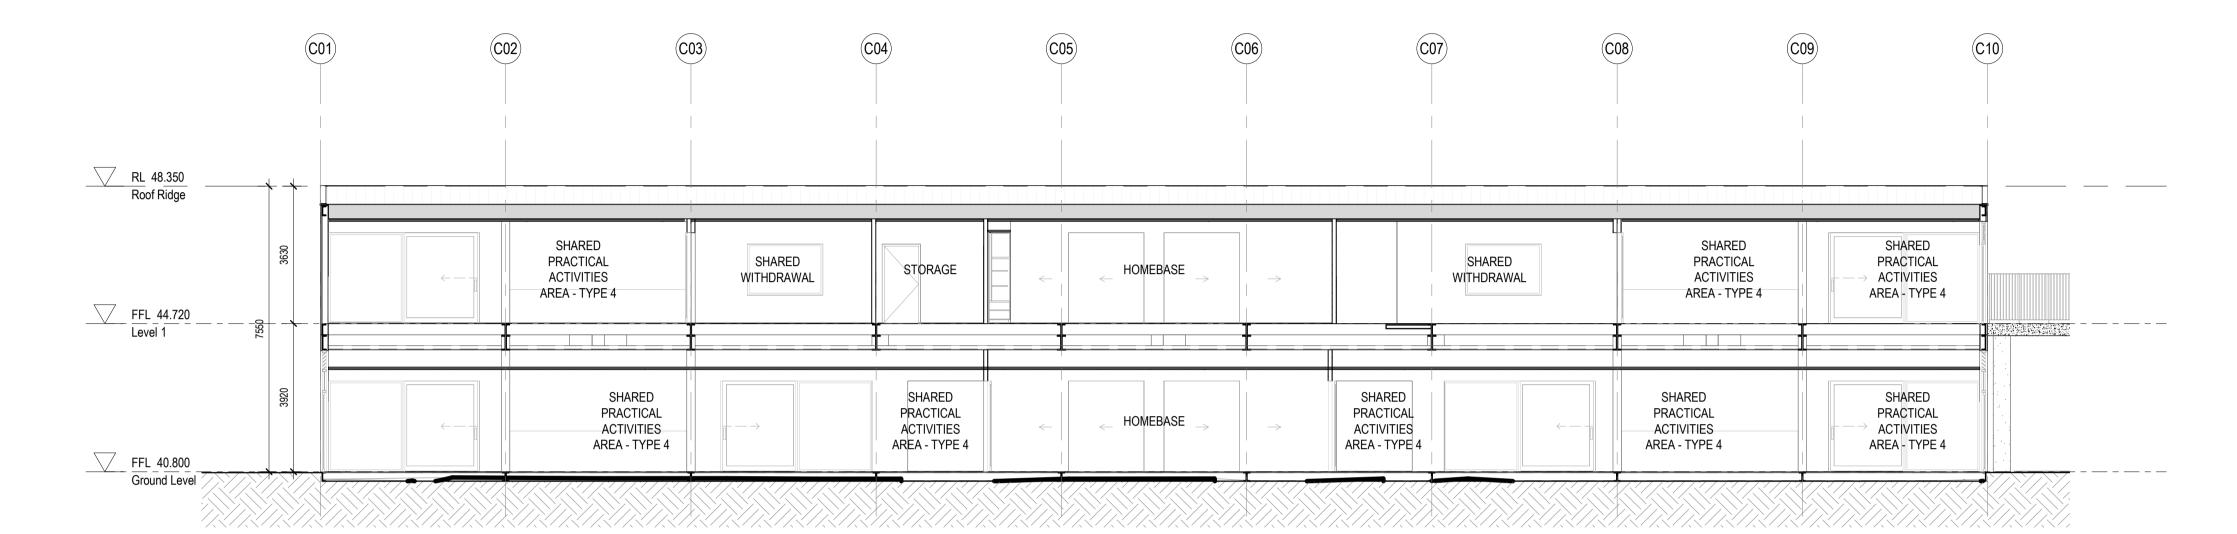

1 SECTION 01 - BLOCK B2

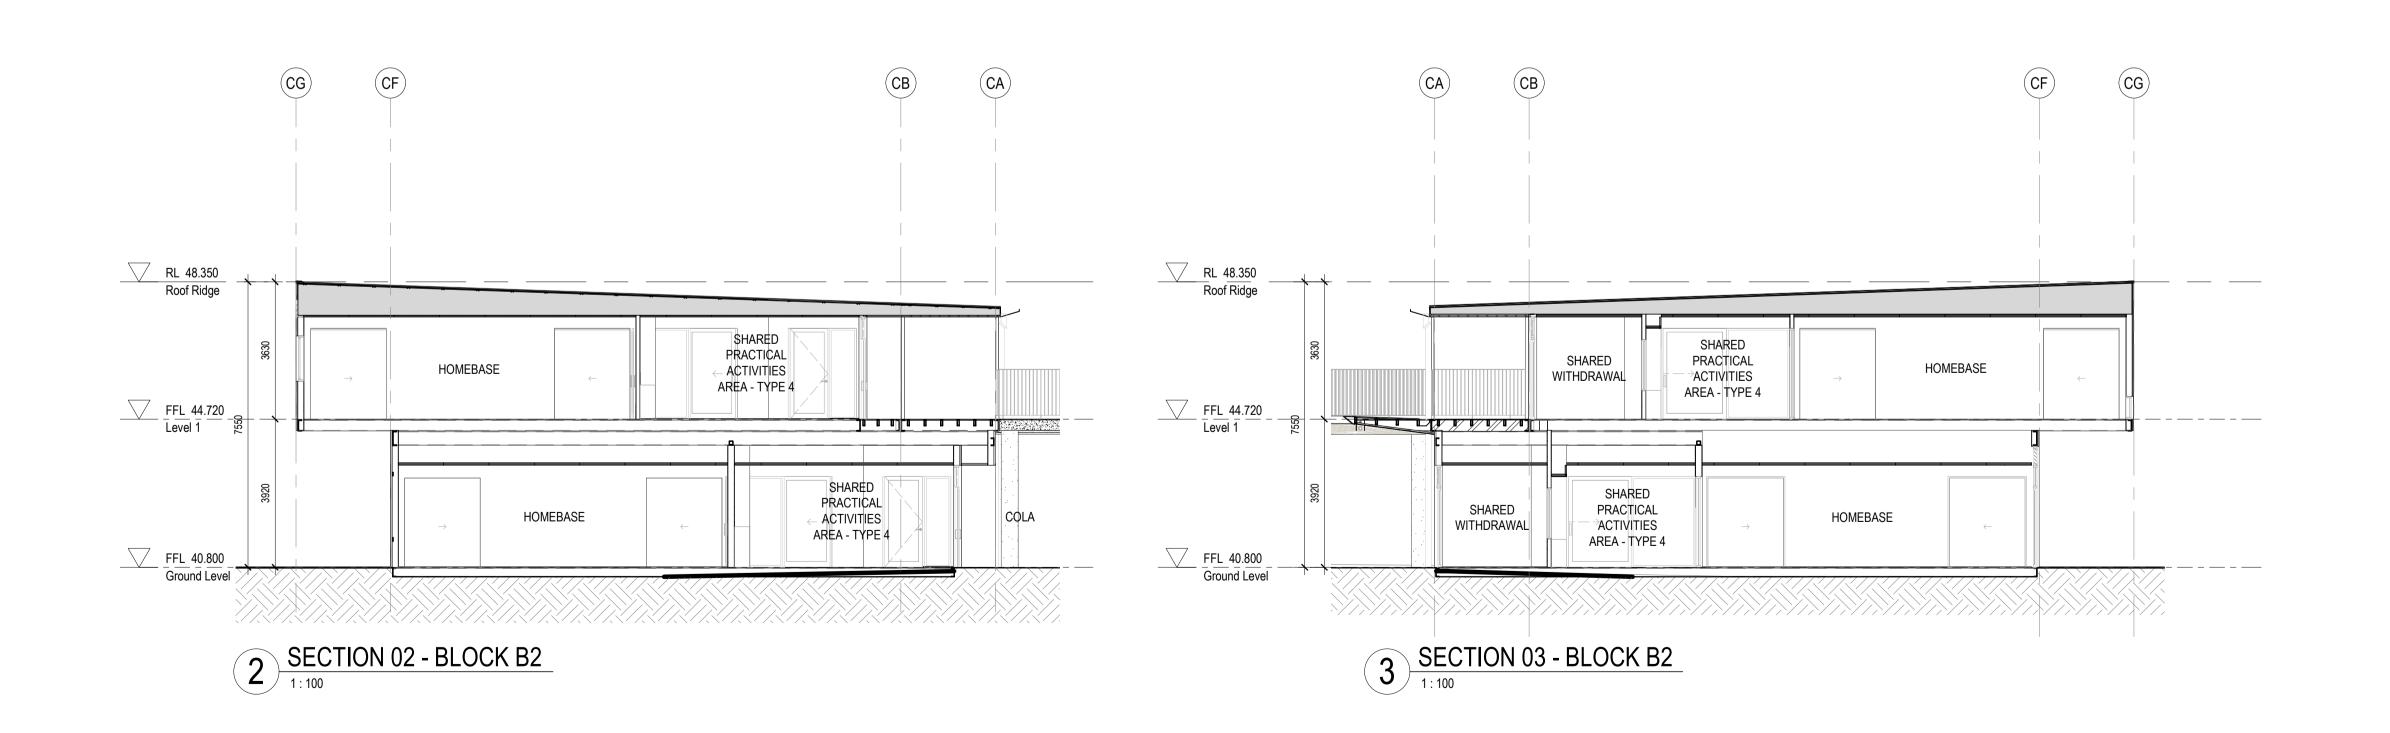

- Refer to technical schedule **COM-AR-9700** for boxed code
- than 500 from internal corner
- Refer to 2300 Series for structural setout of insitu concrete and steel columns. To be read in conjunction with structural
 - Refer to door schedule AR-8000 and Common Project
 - Refer also to Landscape & Civil drawings for External Works drawings
- buildings

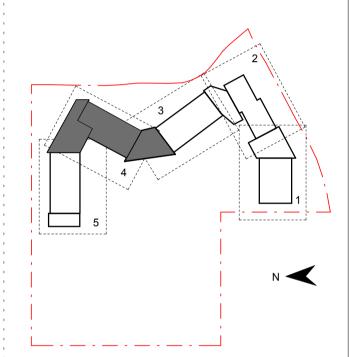

1. This drawing is the copyright of Group GSA Pty Ltd and may not be altered, reproduced or transmitted in any form or by any means

10.05.2019

31.05.2019

in part or in whole without the written permission of Group GSA

4. All dimensions are in millimetres unless noted otherwise.

5. All dimensions shall be verified on site before proceeding

6. Any areas indicated on this sheet are approximate and

2. Drawings to be printed in colour.

PROGRESS ISSUE

SSD SUBMISSION

indicative only.

['] Amendments Issue Description

3. Do not scale drawings. Dimensions govern.







www.groupgsa.com T +612 9361 4144 F +612 9332 3458

architecture interior design urban design landscape nom architect M. Sheldon 3990

Project Title JORDAN SPRINGS **PUBLIC SCHOOL**

SECTIONS - BLOCK B2

Drawing Created (date) Drawing Created (by) Plotted and checked by Verified Approved ME	100646	IC AD	2102 D
Drawing Created (date) 10/05/19 Drawing Created (by) ON Plotted and checked by ON Verified ON	Project No	Drawing No	Issue
Drawing Created (date) 10/05/19 Drawing Created (by) ON Plotted and checked by ON	Approved		ME
Drawing Created (date) 10/05/19 Drawing Created (by) ON	Verified		ON
Drawing Created (date) 10/05/19	Plotted and checked	by	ON
-	Drawing Created (by)	ON
Scale @ A1 As indicated	Drawing Created (da	te)	10/05/19
	Scale @ A1		As indicated

:180646 JS-AR-3103 B 🖁


Section Notes:


- . Refer to technical schedule **COM-AR-9700** for boxed code
- descriptions

 2. All light switches to be at 1000mm above FFL and no less
- than 500 from internal corner

 3. All inground stormwater connections to terminate at concrete
- Refer to 8100 Series for window schedule and Common Project COM-AR-9200 Series for window types, sizes and sill heights
- 5. Refer to **2300 Series** for structural setout of insitu concrete and steel columns. To be read in conjunction with structural engineers details.
- . Refer to door schedule **AR-8000** and Common Project **COM-AR-9200 Series** for door types and sizes
- Refer also to Landscape & Civil drawings for External Works
- 8. Refer to Modscape documentation for all details to modular buildings

	AB	A		D) (A	AE) (/	AF	AG	AH	Al	AJ	AK	BA
RL 48.350 Roof Ridge												
FFL 44.720 Level 1	COLA	<	SHARED PRACTICAL ACTIVITIES AREA - TYPE 4	SHARED WITHDRAWAL		HOMEBASE →	STOF	SHARE WITHDRA	D WAL	SHARED PRACTICAL ACTIVITIES AREA - TYPE 4	COLA	
3920		SHARED PRACTICAL ACTIVITIES AREA - TYPE 4	SHARED PRACTICAL ACTIVITIES AREA - TYPE 4	SHAREI PRACTIC ACTIVITII AREA - TYI	AL ES	HOMEBASE ->	→	SHARED PRACTICAL ACTIVITIES AREA - TYPE 4	—————————————————————————————————————	SHARED PRACTICAL ACTIVITIES AREA - TYPE 4	COLA	
FFL 40.800 Ground Level		N 01 - BLOCK B										

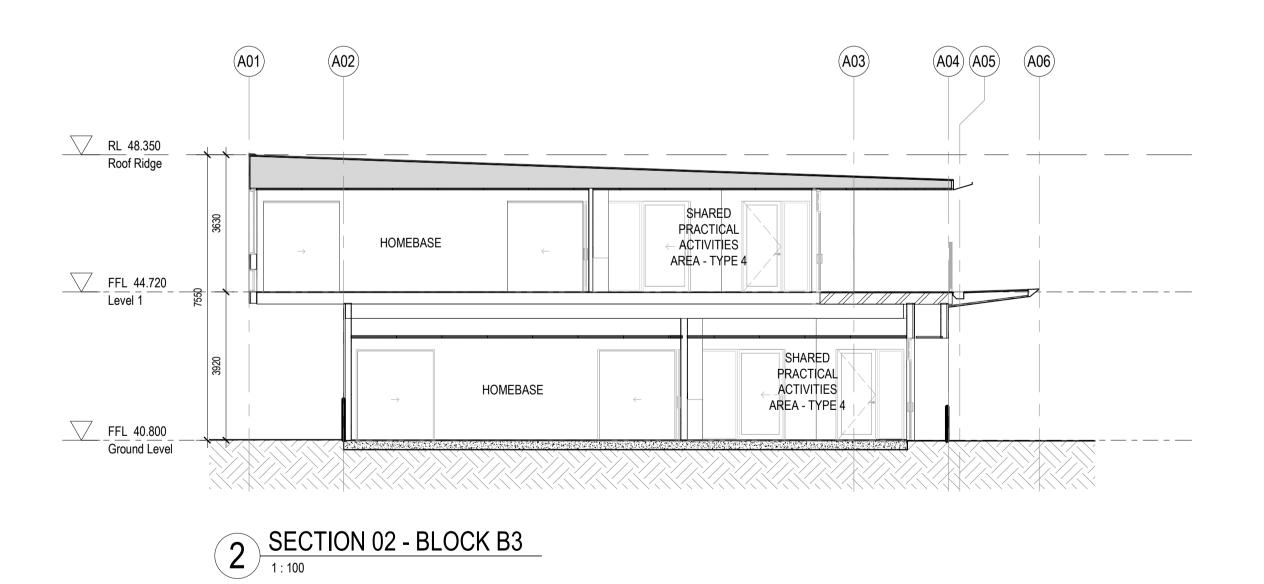

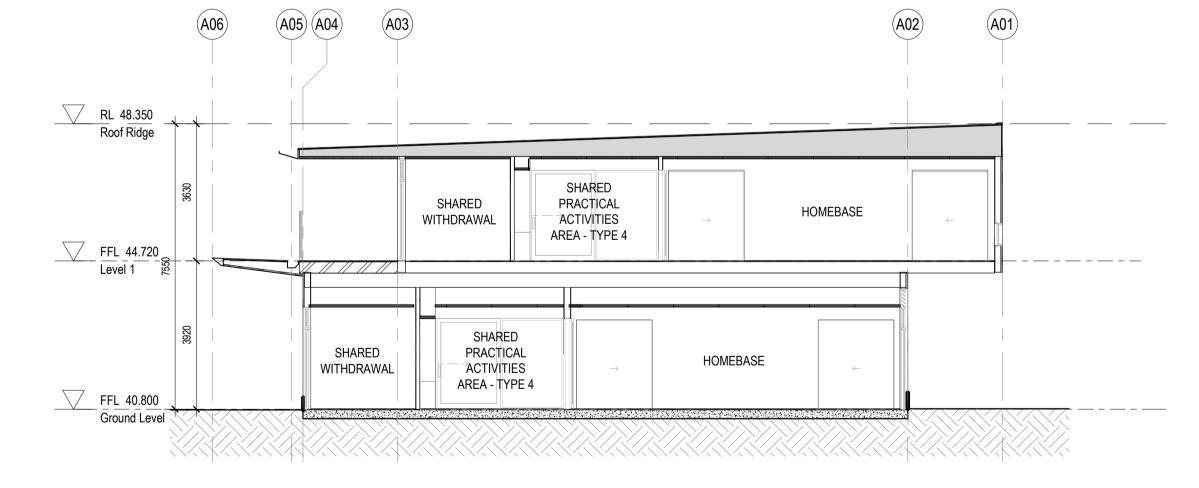


3 SECTION 03 - BLOCK B3

General Note

- This drawing is the copyright of Group GSA Pty Ltd and may not be altered, reproduced or transmitted in any form or by any means in part or in whole without the written permission of Group GSA
 Drawings to be printed in colour.
 Do not scale drawings. Dimensions govern.
 All dimensions are in millimetres unless noted otherwise.
- 3. Do not scale drawings. Dimensions govern.
 4. All dimensions are in millimetres unless noted otherwise.
 5. All dimensions shall be verified on site before proceeding
 6. Any areas indicated on this sheet are approximate and indicative only.

Amendments

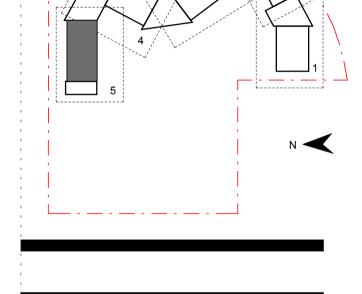





Group GSA Pty Ltd ABN 76 002 113 779 Level 7, 80 William St East Sydney NSW Australia 2011 www.groupgsa.com

T +612 9361 4144 F +612 9332 3458

architecture interior design urban design landscape nom architect M. Sheldon 3990

Project Title



SECTIONS - BLOCK B3

Scale @ A1		As indicated
Drawing Created (da	ate)	10/05/19
Drawing Created (by	()	ОМ
Plotted and checked	l by	ОМ
Verified		ОМ
Approved		
Project No	Drawing No	Issue
180646	JS-AR-310	Issue A B


1 AVENUE STREET SCAPE ELEVATION 1:300



2 SITE SECTION EAST -WEST



3 SITE SECTION NORTH -SOUTH

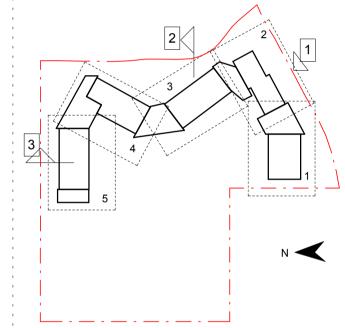

1. This drawing is the copyright of Group GSA Pty Ltd and may not be altered, reproduced or transmitted in any form or by any means in part or in whole without the written permission of Group GSA

31.05.2019

4. All dimensions are in millimetres unless noted otherwise.5. All dimensions shall be verified on site before proceeding6. Any areas indicated on this sheet are approximate and

2. Drawings to be printed in colour.3. Do not scale drawings. Dimensions govern.

indicative only.

Amendments
Sue Description

A SSD SUBMISSION

PRELIMINARY

RICHARD CROOKES

CONSTRUCTIONS



Group GSA Pty Ltd ABN 76 002 113 779 Level 7, 80 William St East Sydney NSW Australia 2011

www.groupgsa.com

T +612 9361 4144 F +612 9332 3458
architecture interior design urban design landscape nom architect M. Sheldon 3990

oject Title

JORDAN SPRINGS PUBLIC SCHOOL

STREETSCAPE ELEVATION & SITE SECTIONS

Project No	JS-AR-3150	Issue
Approved Project No.	Drawing No.	Approver
Verified		Checker
Plotted and checked	d by	Designer
Drawing Created (b)	y)	Author
Drawing Created (d	ate)	05/29/19
Scale @ A1		1 : 300

JORDAN SPRINGS PUBLIC SCHOOL - 14-28 CULLEN AVE, JORDAN SPRINGS CIVIL ENGINEERING WORKS PACKAGE




CIVIL DRAWING SCHEDULE


	THE SCHEDOLL
DWG No.	DRAWING TITLE
DAC01.01	COVER SHEET, DRAWING SCHEDULE AND LOCALITY PLAN
DAC01.11	SPECIFICATION NOTES
DAC01.21	GENERAL ARRANGEMENT PLAN
DAC02.01	SEDIMENT AND SOIL EROSION CONTROL PLAN
DAC02.11	SEDIMENT AND SOIL EROSION CONTROL DETAILS
DAC03.01	BULK EARTHWORKS CUT AND FILL PLAN
DAC04.01	SITEWORKS AND STORMWATER MANAGEMENT PLAN - SHEET 01
DAC04.02	SITEWORKS AND STORMWATER MANAGEMENT PLAN - SHEET 02
DAC04.03	SITEWORKS AND STORMWATER MANAGEMENT PLAN - SHEET 03
DAC04.21	STOMRWATER LONGITUDINAL SECTIONS - SHEET 01
DAC04.22	STOMRWATER LONGITUDINAL SECTIONS - SHEET 02
DAC04.23	STOMRWATER LONGITUDINAL SECTIONS - SHEET 03
DAC04.31	BIORETENTION BASIN DETAILS - SHEET 01
DAC09.01	DETAILS - SHEET 01

NOT FOR CONSTRUCTION

REVISION	DESCRIPTION	ISSUED	VER'D	APP'D	DATE	CLIENT
1	ISSUED FOR SSDA	VC		JG	25.01.19	1
2	ISSUED FOR REF APPROVAL	JRG		JG	06.02.19	
3	ISSUED FOR DEVELOPMENT APPLICATION	JRG		JG	13.02.19	
4	ISSUED FOR SSDA	VC		JG	31.05.19	_
						DRAWIN
						\ \ \ \ \ \ \ \ \ \ \ \ \ \ \ \ \ \ \

RICHARD CROOKES **CONSTRUCTIONS** VERIFICATION SIGNATURE HAS BEEN ADDED

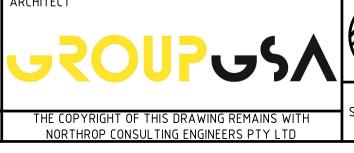

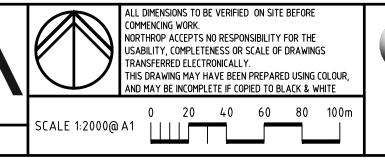



sydney@northrop.com.au ABN 81 094 433 100

JORDAN SPRINGS PRIMARY SCHOOL 14-28 CULLEN AVENUE,

JORDAN SPRINGS

CIVIL ENGINEERING PACKAGE **DEVELOPMENT APPLICATION**

> **COVER SHEET, DRAWING** SCHEDULE AND LOCALITY PLAN

182535 DRAWING NUMBER

STORMWATER DRAINAGE

- 1. ALL DRAINAGE LINES SHALL BE UPVC (CLASS SN4) SEWER GRADE
- DRAINAGE PIPE, U.N.O. 2. ALL DRAINAGE LINES SHALL BE LAID AT 1% MIN. FALL, UNO.
- 3. ALL LEVELS ARE AUSTRALIAN HEIGHT DATUM (AHD). 4. ALL DOWNPIPES GUTTERS TO BE DESIGNED IN ACCORDANCE WITH
- AS/NZS 3500.3.2 2003 'STORMWATER' DRAINAGE. 5. THE STORMWATER DRAINAGE DESIGN HAS BEEN CARRIED OUT IN ACCORDANCE WITH AS/NZS 3500.3.2-2003 'STORMWATER'
- 6. ANY VARIATIONS TO THE NOMINATED LEVELS SHALL BE REFERRED TO ENGINEER IMMEDIATELY.
- SUBSOIL DRAINAGE SHALL BE PROVIDED TO ALL RETAINING WALLS & EMBANKMENTS, WITH THE LINES FEEDING INTO THE STORMWATER DRAINAGE SYSTEM.
- 8. ALL GRATES TO BE GALVANISED STEEL WITH HINGES AND CHILD

PROOF LOCK.

COUNCILS STORMWATER CODE.

9. ALL GRATES TO BE HEEL SAFE WITHIN AGED CARE DEVELOPMENTS. 10. THE STORMWATER DRAINAGE IS DESIGNED IN ACCORDANCE WITH

RAINWATER RE-USE

- PROVIDE RAINWATER RE-USE SYSTEM TO SUPPLY WATER FOR TOILET FLUSHING.
- GUTTER GUARD TO BE INSTALLED ON ALL EAVES GUTTERS. 3. A PERMANENT SIGN IS TO BE LOCATED IN THE VICINITY OF THE TANK

STATING THE WATER IS "NON POTABLE WATER" WITH APPROPRIATE

- HAZARD IDENTIFICATION. 4. PIPEWORK USED FOR RAINWATER SERVICES SHALL BE COLOURED LILAC IN ACCORDANCE WITH AS1345.
- ALL VALVES AND APERTURES SHALL BE CLEARLY AND PERMANENTLY LABELLED WITH SAFETY SIGNS TO COMPLY WITH
- RAINWATER TANK RETICULATION SYSTEM AND MAINS WATER BYPASS ARRANGEMENT TO BE INSTALLED IN ACCORDANCE WITH AS/NZS 3500.1.2-2003 AND THE NSW CODE OF PRACTICE: PLUMBING AND DRAINING.
- A FIRST FLUSH FILTRATION DEVICE IS TO BE PROVIDED AT RAINWATER TANK.

GENERAL NOTES

THESE DRAWINGS SHALL BE READ IN CONJUNCTION WITH OTHER CONSULTANTS' DRAWINGS AND SPECIFICATIONS AND WITH OTHER SUCH WRITTEN INSTRUCTIONS AS MAY BE ISSUED DURING THE COURSE OF THE CONTRACT. ANY DISCREPANCY SHALL BE REFERRED TO THE ENGINEER BEFORE PROCEEDING WITH THE WORK.

ALL DIMENSIONS ARE IN MILLIMETRES & ALL LEVELS ARE IN METRES, UNO (UNLESS NOTED OTHERWISE).

NO DIMENSION SHALL BE OBTAINED BY SCALING THE DRAWINGS.

ALL LEVELS AND SETTING OUT DIMENSIONS SHOWN ON THE DRAWINGS SHALL BE CHECKED ON SITE PRIOR TO THE COMMENCEMENT OF THE WORK.

DETAIL SURVEY DATA WAS SUPPLIED BY LTS LOCKLEY, DRAWING DATED 16/05/2018.

EXISTING SERVICES WHERE SHOWN HAVE BEEN PLOTTED FROM SUPPLIED DATA AND SUCH THEIR ACCURACY CAN NOT BE GUARANTEED. IT IS THE RESPONSIBILITY OF THE CONTRACTOR TO ESTABLISH THE LEVEL OF ALL EXISTING SERVICES PRIOR TO THE COMMENCEMENT OF WORK.

ON COMPLETION OF STORMWATER INSTALLATION, ALL DISTURBED AREAS MUST BE RESTORED TO ORIGINAL CONDITION, INCLUDING KERBS, FOOTPATHS, CONCRETE AREAS, GRAVEL AND GRASSED AREAS AND ROAD PAVEMENTS, UNLESS DIRECTED OTHERWISE.

ALL STORMWATER MANAGEMENT MEASURES SHOWN ON THIS DRAWING HAVE BEEN PREPARED FOR DEVELOPMENT APPLICATION PURPOSES TO DEMONSTRATE FEASIBILITY. ALL MEASURES WILL BE SUBJECT TO DETAIL DESIGN AT THE CONSTRUCTION CERTIFICATE STAGE AND MAY BE SUBJECT TO VARIATION PROVIDED THAT THE DESIGN INTENT IS MAINTAINED.

DESIGN SUMMARY

WATER QUALITY:

MUSIC MODEL SUMMA	ARY:	
SOURCE NODE	<u>CATCHMENT</u>	<u>AREA</u>
MIXED	LANDSCAPING	11,900m²
ROOF	ROOF	6,250m²
MIXED	HARDSTAND (TO BIO-RETENTION BASIN)	7,620m²
MIXED	HARDSTAND (BYPASS BIO-RETENTION BASIN)	4,160m²
		TOTAL 29,930m ²

TREATMENT NODES:

- RAINWATER RE-USE TANK
- ON-SITE DETENTION TANK HUMES 'HYDROFILTER HF1000'
- STORMWATER 360 'STORMFILTER' CARTRIDGE

VEGETATIVE SWALE TREATMENT STANDARDS:

- 1			
	<u>POLLUTANT</u>	REDUCTION STANDARDS	REDUCTION ACHIEVED
	GROSS POLLUTANTS	-	100%
	TOTAL SUSPENDED SOLIDS	85%	89.7%
	TOTAL PHOSPHORUS	60%	64%
	TOTAL NITROGEN	45%	51.6%

MUSIC MODEL PARAMETERS IN ACCORDANCE WITH PENRITH CITY COUNCILS MUSIC MODELLING GUIDELINES 2015.

STANDARD DETAILS ANY DISCREPANCIES TO BE REPORTED IMMEDIATELY TO NORTHROP ENGINEERS FOR CLARIFICATION COUNCIL DETAILS - BLACKTOWN CITY COUNCIL OMPONENT DWG REFERENCE DRAWING TITLE KERB AND GUTTER A(BS) 101M STD KERBS AND GUTTERS STANDARD RESIDENTIAL LAYBACK A(BS) 102S FOOTWAY AND LAYBACK CROSSING STD INDUSTRIAL & LAYBACK A(BS) 103S COMMERCIAL FOOTWAY CROSSINGS PATH PAVING AT KERB RAMP A(BS) 104M INTERSECTIONS AND KERB RAMP DETAILS

NOT FOR CONSTRUCTION

TRANSFERRED ELECTRONICALLY. THIS DRAWING MAY HAVE BEEN PREPARED USING COLOUR AND MAY BE INCOMPLETE IF COPIED TO BLACK & WHITE Sydney 14-28 CULLEN AVENUE, Level 11 345 George Street, Sydney NSW 2000 Ph (02) 9241 4188 Fax (02) 9241 4324 JORDAN SPRINGS THE COPYRIGHT OF THIS DRAWING REMAINS WITH Email sydney@northrop.com.au ABN 81 094 433 100

Commencing work.

NORTHROP ACCEPTS NO RESPONSIBILITY FOR THE

USABILITY, COMPLETENESS OR SCALE OF DRAWINGS

JORDAN SPRINGS PRIMARY SCHOOL

DEVELOPMENT APPLICATION

SPECIFICATION NOTES

DRAWING TITLE

CIVIL ENGINEERING PACKAGE 182535 DRAWING NUMBER REVISION

DRAWING SHEET SIZE = A1

DESCRIPTION REVISION 1 ISSUED FOR SSDA 2 ISSUED FOR REF APPROVAL 3 ISSUED FOR DEVELOPMENT APPLICATION ISSUED FOR SSDA

RICHARD CROOKES CONSTRUCTIONS

DRAWING NOT TO BE USED FOR CONSTRUCTION UNLESS

VERIFICATION SIGNATURE HAS BEEN ADDED

| ISSUED | VER'D | APP'D | DATE

JRG

JRG


JG 25.01.19


JG 06.02.19

JG 13.02.19

JG 31.05.19

ARCHITECT NORTHROP CONSULTING ENGINEERS PTY LTD

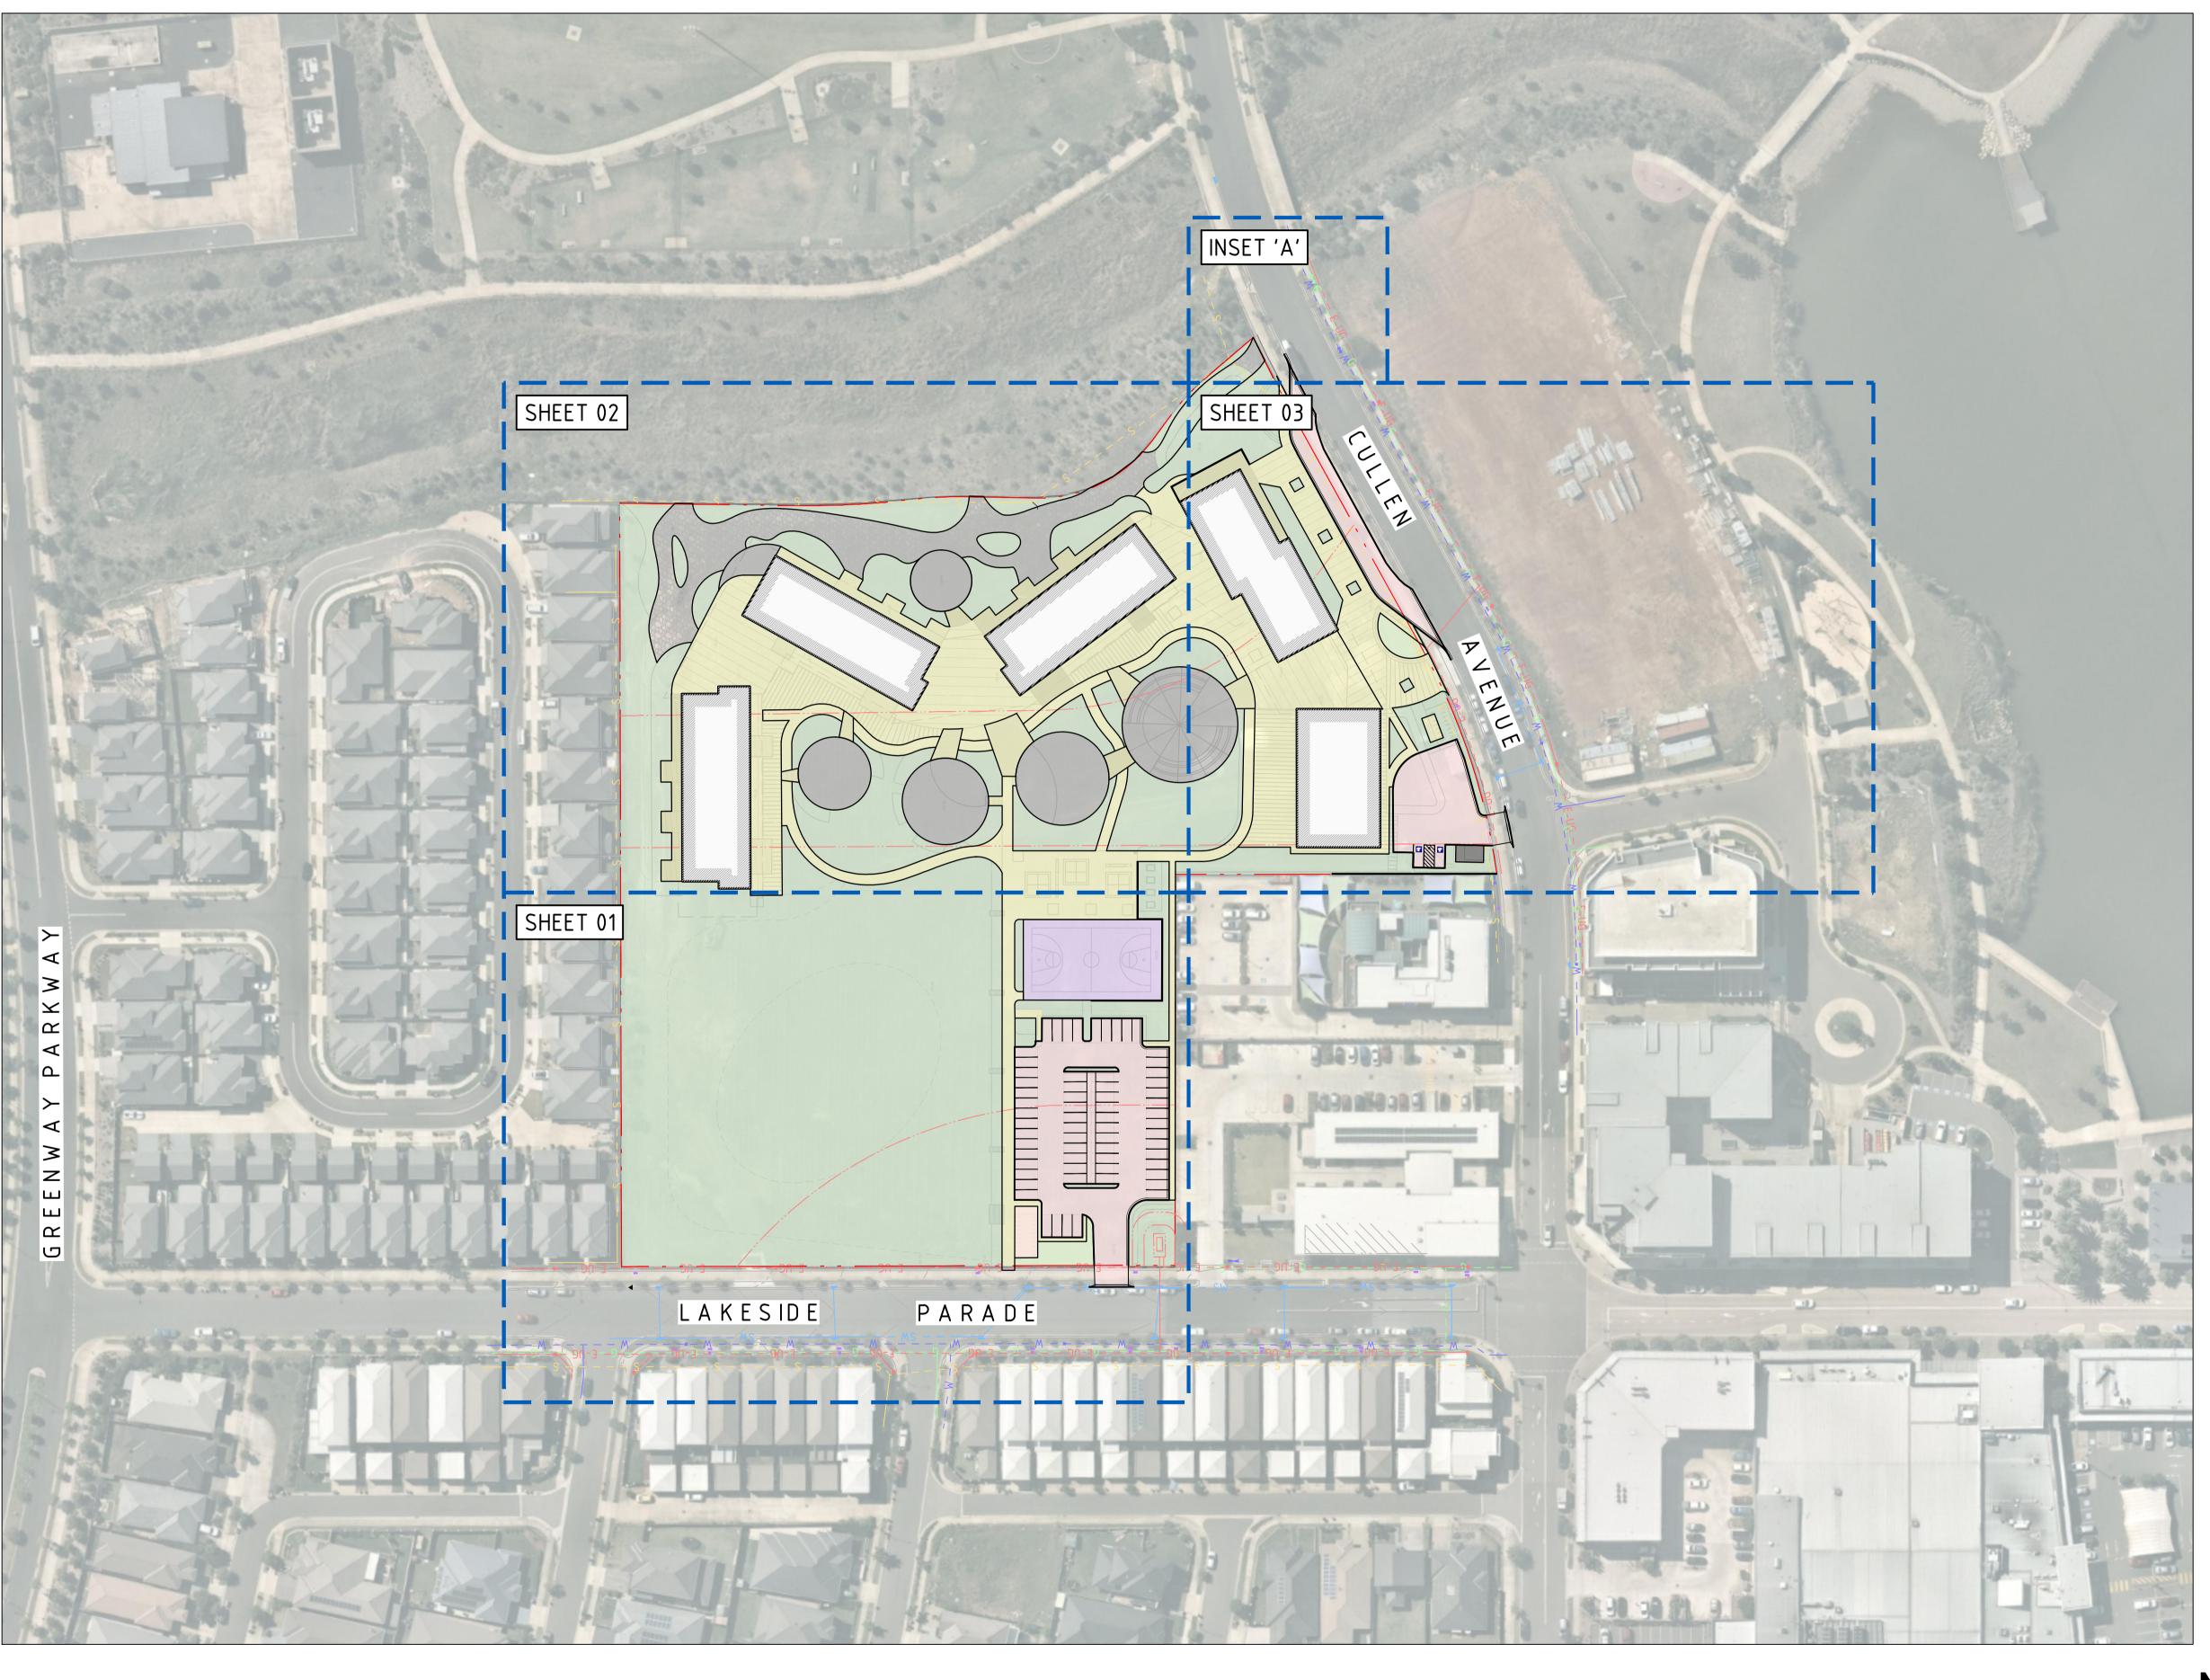

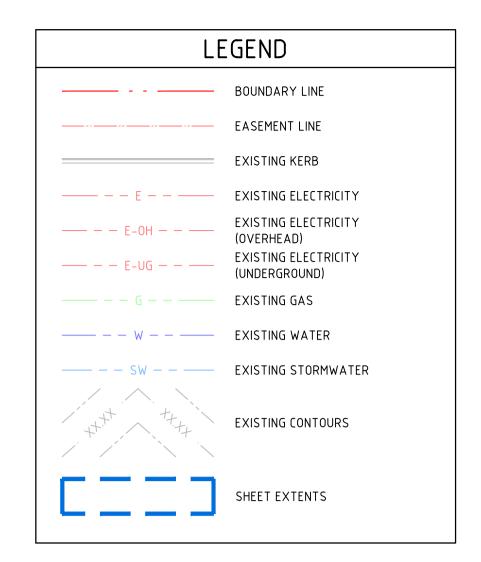

GENERAL NOTES:


- 1. SURVEY SUPPLIED BY: LTS LOCKLEY
 1.1. REFERENCE NUMBER: 43776 002DT 1.2. DATE: 16/05/2018
- 1.3. REVISION: 1 2. ALL UTILITY SERVICES INDICATED ON THE DRAWINGS ORIGINATE FROM SUPPLIED DATA OR DIAL BEFORE YOU DIG SEARCHES, THEREFORE THEIR ACCURACY AND COMPLETENESS IS NOT GUARANTEED. IT IS THE RESPONSIBILITY OF THE CONTRACTOR TO DETERMINE AND CONFIRM THE LOCATION AND LEVEL OF ALL EXISTING SERVICES PRIOR TO THE COMMENCEMENT OF ANY WORK. ANY DISCREPANCIES SHALL BE REPORTED TO THE SUPERINTENDENT. CLEARANCES SHALL BE OBTAINED FROM THE RELEVANT SERVICE AUTHORITY. NOTE SERVICE AUTHORITY REQUIREMENTS FOR LOCATING OF
- SERVICES PRIOR TO COMMENCEMENT OF WORKS.
 NORTHROP TAKE NO RESPONSIBILITY FOR THE ACCURACY AND/OR USE OF THIS SURVEY AND ITS CONTENTS

NOT FOR CONSTRUCTION

REVISION	DESCRIPTION	ISSUED	VER'D	APP'D	DATE	CLIENT
1	ISSUED FOR SSDA	VC		JG	25.01.19	D.
2	ISSUED FOR REF APPROVAL	JRG		JG	06.02.19	RI
3	ISSUED FOR DEVELOPMENT APPLICATION	JRG		JG	13.02.19	C
4	ISSUED FOR SSDA	VC		JG	31.05.19	
						DRAWING N

RICHARD CROOKES CONSTRUCTIONS IG NOT TO BE USED FOR CONSTRUCTION UNLESS ERIFICATION SIGNATURE HAS BEEN ADDED



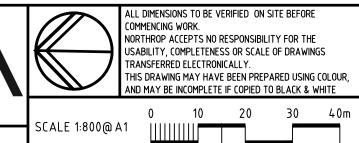




Level 11 345 George Street, Sydney NSW 2000
Ph (02) 9241 4188 Fax (02) 9241 4324
Email sydney@northrop.com.au ABN 81 094 433 100

JORDAN SPRINGS PRIMARY SCHOOL

14-28 CULLEN AVENUE, **JORDAN SPRINGS**

CIVIL ENGINEERING PACKAGE **DEVELOPMENT APPLICATION**


182535 DRAWING NUMBER **GENERAL ARRANGEMENT PLAN**

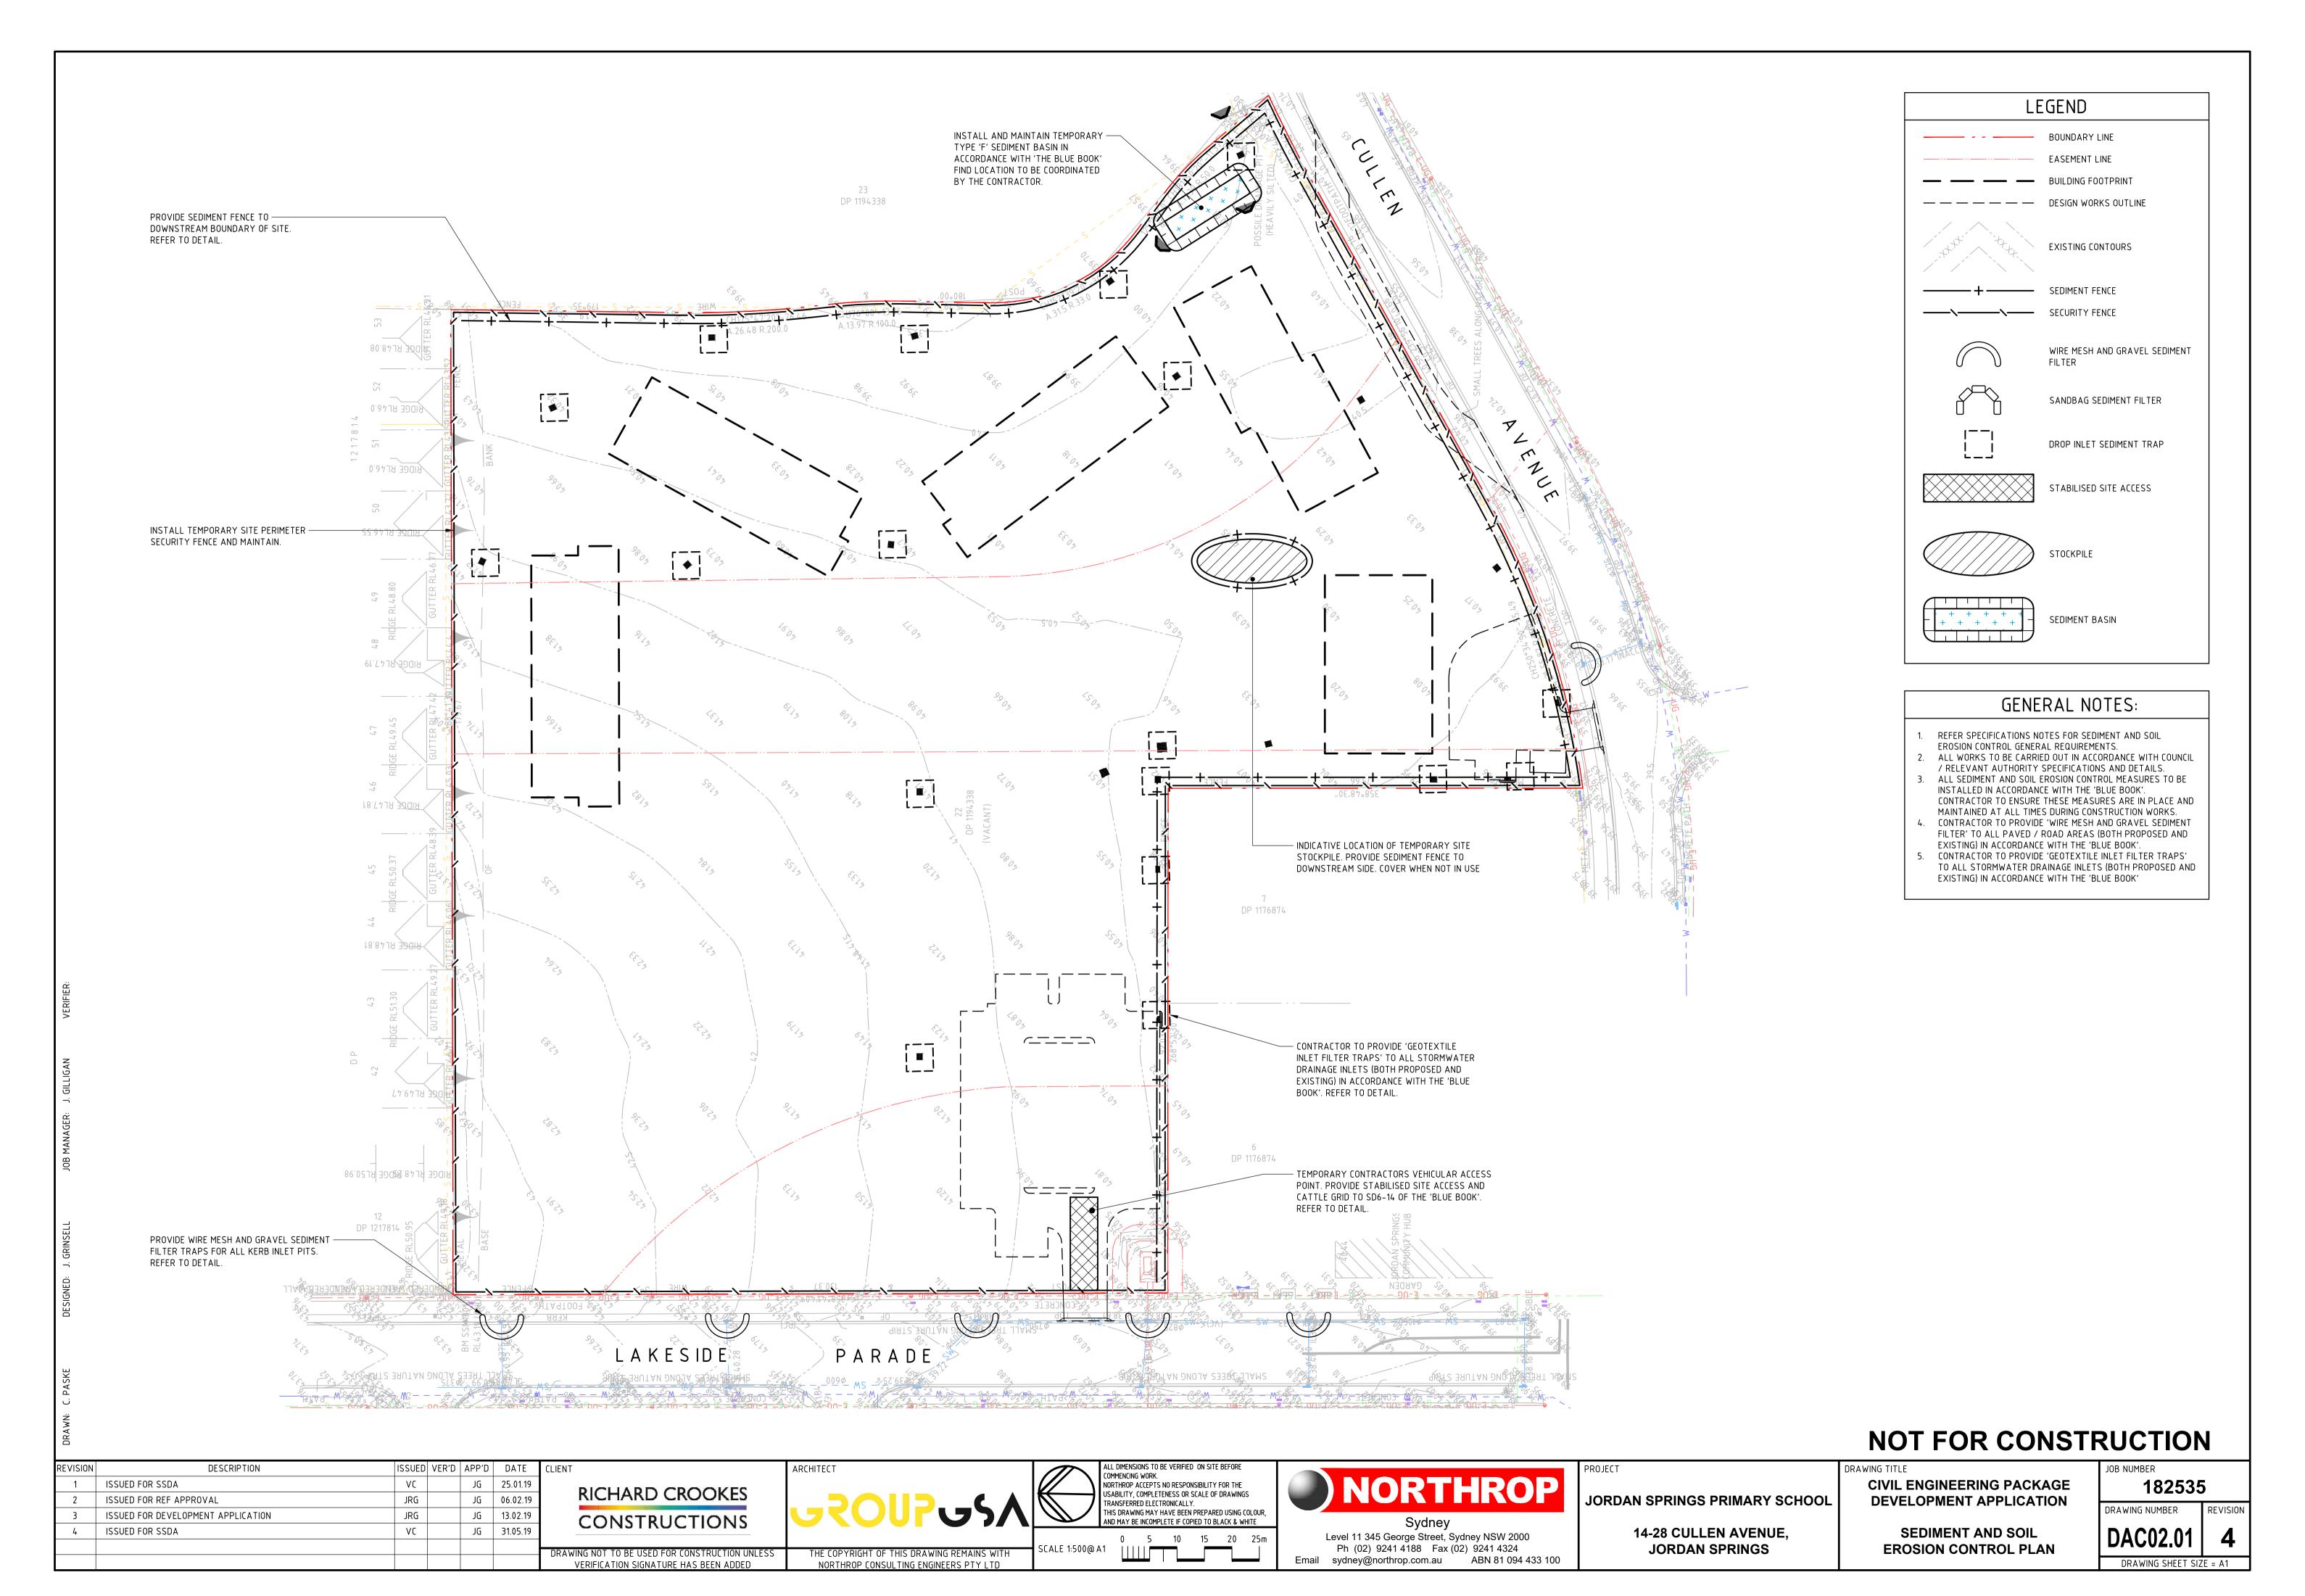

CONSTRUCTION NOTES

- 1. PLACE STOCKPILES MORE THAN 2m (PREFERABLY 5m) FROM EXISTING VEGETATION, CONCENTRATED WATER FLOW, ROADS AND HAZARD AREAS.
- 2. CONSTRUCT ON THE CONTOUR AS LOW, FLAT, ELONGATED MOUNDS.
- WHERE THERE IS SUFFICIENT AREA, TOPSOIL STOCKPILES SHALL BE LESS THAN 2m IN HEIGHT.
- 4. WHERE THEY ARE TO BE IN PLACE FOR MORE THAN 10 DAYS, STABILISE FOLLOWING THE APPROVED ESCP OR SWMP TO REDUCE THE C-FACTOR TO LESS THAN 0.10.
- 5. CONSTRUCT EARTH BANKS (STANDARD DRAWING 5-5) ON THE UPSLOPE SIDE TO DIVERT WATER AROUND STOCKPILES AND SEDIMENT FENCES (STANDARD DRAWING 6-8) 1 TO 2m DOWNSLOPE

STOCKPILES (SD 4-1)

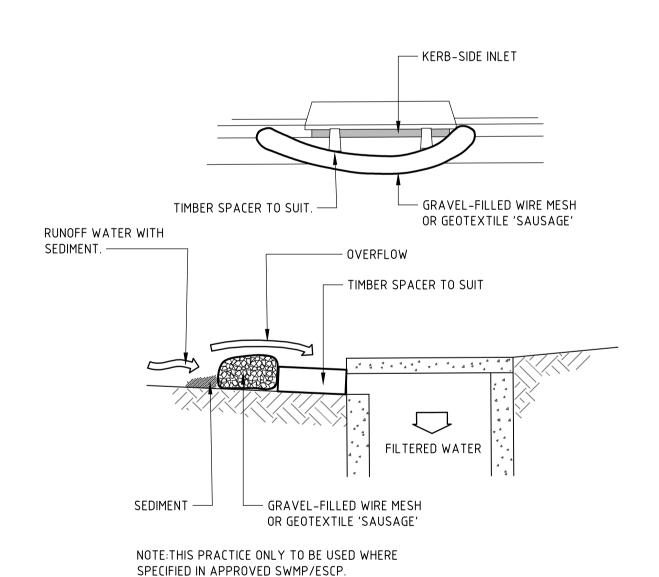


CONSTRUCTION NOTES

1. INSTALL FILTERS TO KERB INLETS ONLY AT SAG POINTS.

- 2. FABRICATE A SLEEVE MADE FROM GEOTEXTILE OR WIRE MESH LONGER THAN THE LENGTH OF THE INLET PIT AND FILL IT WITH 25mm TO 50mm GRAVEL.
- 3. FORM AN ELLIPTICAL CROSS-SECTION ABOUT 150mm HIGH x 400mm WIDE.
- 4. PLACE THE FILTER AT THE OPENING LEAVING AT LEAST A 100mm SPACE BETWEEN IT AND THE KERB INLET. MAINTAIN THE OPENING WITH SPACER BLOCKS.
- 5. FORM A SEAL WITH THE KERB TO PREVENT SEDIMENT BYPASSING THE FILTER.
- SANDBAGS FILLED WITH GRAVEL CAN SUBSTITUTE FOR THE MESH OR GEOTEXTILE PROVIDING THEY ARE PLACED SO THAT THEY FIRMLY ABUT EACH OTHER AND SEDIMENT-LADEN WATERS CANNOT PASS BETWEEN.


WIRE MESH AND GRAVEL SEDIMENT FILTER (SD 6-11)

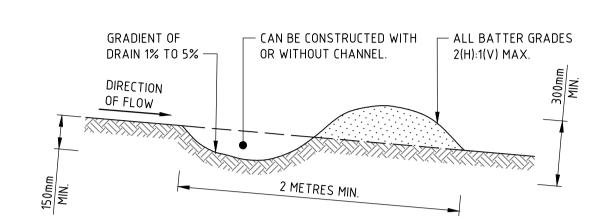

CONSTRUCTION NOTES

- 1. BUILD WITH GRADIENTS BETWEEN 1 AND 5 PERCENT.
- 2. AVOID REMOVING TREES AND SHRUBS IF POSSIBLE WORK AROUND THEM.
- 3. ENSURE THE STRUCTURES ARE FREE OF PROJECTIONS OR OTHER IRREGULARITIES THAT COULD IMPEDE WATER FLOW.
- 4. BUILD THE DRAINS WITH CIRCULAR, PARABOLIC OR TRAPEZOIDAL CROSS SECTIONS, NOT V SHAPED.
- 5. ENSURE THE BANKS ARE PROPERLY COMPACTED TO PREVENT FAILURE.
- 6. COMPLETE PERMANENT OR TEMPORARY STABILISATION WITHIN 10 DAYS OF CONSTRUCTION.


NOTE: ONLY TO BE USED AS TEMPORARY BANK WHERE MAXIMUM UPSLOPE LENGTH IS 80 METRES. EARTH BANK - LOW FLOW (SD 5-5)

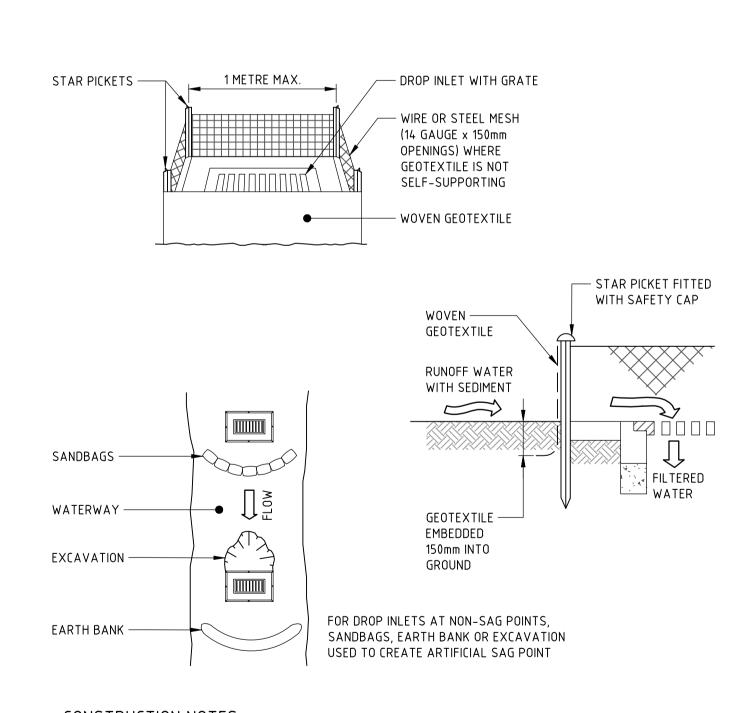

CONSTRUCTION NOTES

- 1. FABRICATE A SEDIMENT BARRIER MADE FROM GEOTEXTILE OR STRAW BALES. 2. FOLLOW STANDARD DRAWING 6-7 AND STANDARD DRAWING 6-8 FOR INSTALLATION PROCEDURES FOR THE
- STRAW BALES OR GEOFABRIC. REDUCE THE PICKET SPACING TO 1 METRE CENTRES.
- 3. IN WATERWAYS, ARTIFICIAL SAG POINTS CAN BE CREATED WITH SANDBAGS OR EARTH BANKS AS SHOWN IN
- 4. DO NOT COVER THE INLET WITH GEOTEXTILE UNLESS THE DESIGN IS ADEQUATE TO ALLOW FOR ALL WATERS


GEOTEXTILE INLET FILTER (SD 6-12)

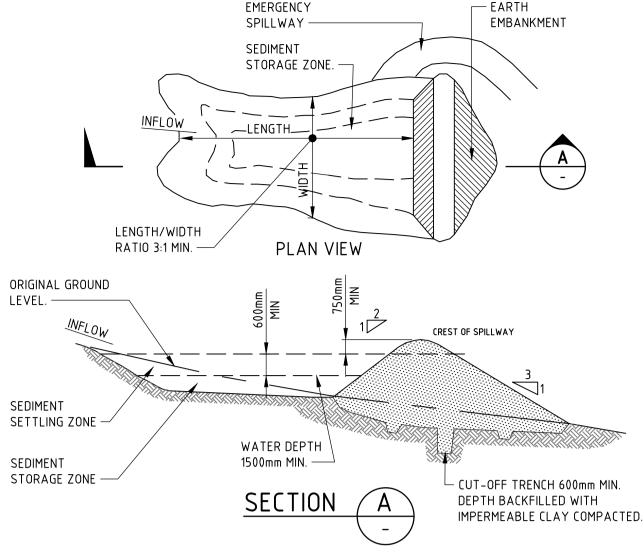

- REMOVE ALL VEGETATION AND TOPSOIL FROM UNDER THE DAM WALL AND FROM WITHIN THE STORAGE AREA.
- 2. CONSTRUCT A CUT-OFF TRENCH 500mm DEEP AND 1200mm WIDE ALONG THE CENTRELINE OF THE EMBANKMENT EXTENDING TO A POINT ON THE GULLY WALL LEVEL WITH THE RISER CREST.
- 3. MAINTAIN THE TRENCH FREE OF WATER AND RECOMPACT THE MATERIALS WITH EQUIPMENT AS SPECIFIED IN THE SWMP TO 95 PER CENT STANDARD PROCTOR DENSITY.
- 4. SELECT FILL FOLLOWING THE SWMP THAT IS FREE OF ROOTS, WOOD, ROCK, LARGE STONE OR FOREIGN MATERIAL. 5. PREPARE THE SITE UNDER THE EMBANKMENT BY RIPPING TO AT LEAST 100mm TO HELP BOND COMPACTED FILL TO THE EXISTING SUBSTRATE.
- 6. SPREAD THE FILL IN 100mm TO 150mm LAYERS AND COMPACT IT AT OPTIMUM MOISTURE CONTENT FOLLOWING THE
- CONSTRUCT THE EMERGENCY SPILLWAY.
- 8. REHABILITATE THE STRUCTURE FOLLOWING THE SWMP.

(APPLIES TO 'TYPE D' AND 'TYPE F' SOILS ONLY)


EARTH BASIN - WET (SD 6-4)

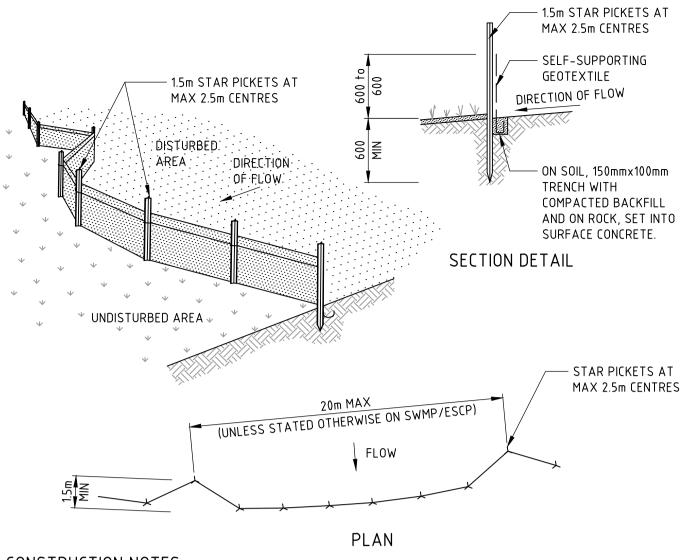

CONSTRUCTION NOTES

- CONSTRUCT SEDIMENT FENCES AS CLOSE AS POSSIBLE TO BEING PARALLEL TO THE CONTOURS OF THE SITE, BUT WITH SMALL RETURNS AS SHOWN IN THE DRAWING TO LIMIT THE CATCHMENT AREA OF ANY ONE SECTION. THE CATCHMENT AREA SHOULD BE SMALL ENOUGH TO LIMIT WATER FLOW IF CONCENTRATED AT ONE POINT TO 50 LITRES PER SECOND IN THE DESIGN STORM EVENT, USUALLY THE 10-YEAR EVENT.
- 2. CUT A 150mm DEEP TRENCH ALONG THE UPSLOPE LINE OF THE FENCE FOR THE BOTTOM OF THE FABRIC TO BE ENTRENCHED.
- 3. DRIVE 1.5 METRE LONG STAR PICKETS INTO GROUND AT 2.5 METRE INTERVALS (MAX) AT THE DOWNSLOPE EDGE OF THE TRENCH. ENSURE ANY STAR PICKETS ARE FITTED WITH SAFETY CAPS.
- 4. FIX SELF-SUPPORTING GEOTEXTILE TO THE UPSLOPE SIDE OF THE POSTS ENSURING IT GOES TO THE BASE OF THE TRENCH. FIX THE GEOTEXTILE WITH WIRE TIES OR AS RECOMMENDED BY THE MANUFACTURER. ONLY USE GEOTEXTILE SPECIFICALLY PRODUCED FOR SEDIMENT FENCING. THE USE OF SHADE CLOTH FOR THIS PURPOSE IS NOT SATISFACTORY.
- 5. JOIN SECTIONS OF FABRIC AT A SUPPORT POST WITH A 150mm OVERLAP.
- 6. BACKFILL THE TRENCH OVER THE BASE OF THE FABRIC AND COMPACT IT THOROUGHLY OVER THE GEOTEXTILE.

SEDIMENT FENCE (SD 6-8)

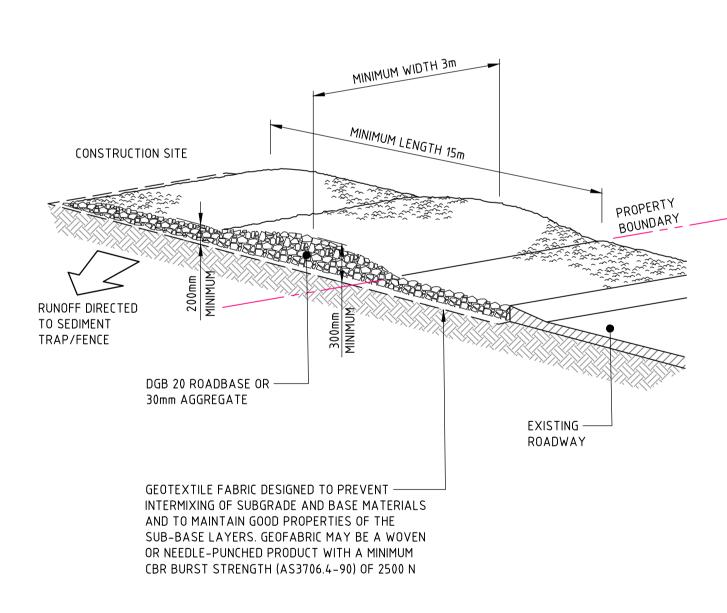

CONSTRUCTION NOTES


- 1. STRIP THE TOPSOIL, LEVEL THE SITE AND COMPACT THE SUBGRADE.
- 2. COVER THE AREA WITH NEEDLE-PUNCHED GEOTEXTILE.
- 3. CONSTRUCT A 200mm THICK PAD OVER THE GEOTEXTILE USING ROAD BASE OR 30mm AGGREGATE
- 4. ENSURE THE STRUCTURE IS AT LEAST 15 METRES LONG OR TO BUILDING ALIGNMENT AND AT LEAST 3 METRES
- 5. WHERE A SEDIMENT FENCE JOINS ONTO THE STABILISED ACCESS, CONSTRUCT A HUMP IN THE STABILISED ACCESS TO DIVERT WATER TO THE SEDIMENT FENCE.

STABILISED SITE ACCESS (SD 6-14)

NOT FOR CONSTRUCTION

EVISION DESCRIPTION ISSUED VER'D APP'D DATE ISSUED FOR SSDA JG 25.01.19 JG 06.02.19 2 ISSUED FOR REF APPROVAL JRG ISSUED FOR DEVELOPMENT APPLICATION JRG JG 13.02.19 ISSUED FOR SSDA VC JG 31.05.19

RICHARD CROOKES CONSTRUCTIONS VERIFICATION SIGNATURE HAS BEEN ADDED

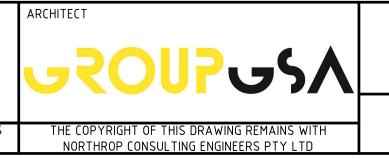

NORTHROP ACCEPTS NO RESPONSIBILITY FOR THE JSABILITY, COMPLETENESS OR SCALE OF DRAWINGS TRANSFERRED ELECTRONICALLY THIS DRAWING MAY HAVE BEEN PREPARED USING COLOUR AND MAY BE INCOMPLETE IF COPIED TO BLACK & WHITE

NOT TO SCALE

Level 11 345 George Street, Sydney NSW 2000 Ph (02) 9241 4188 Fax (02) 9241 4324 Email sydney@northrop.com.au ABN 81 094 433 100


JORDAN SPRINGS PRIMARY SCHOOL


14-28 CULLEN AVENUE. JORDAN SPRINGS

CIVIL ENGINEERING PACKAGE **DEVELOPMENT APPLICATION**

> SEDIMENT AND SOIL **EROSION CONTROL DETAILS**

182535 DRAWING NUMBER

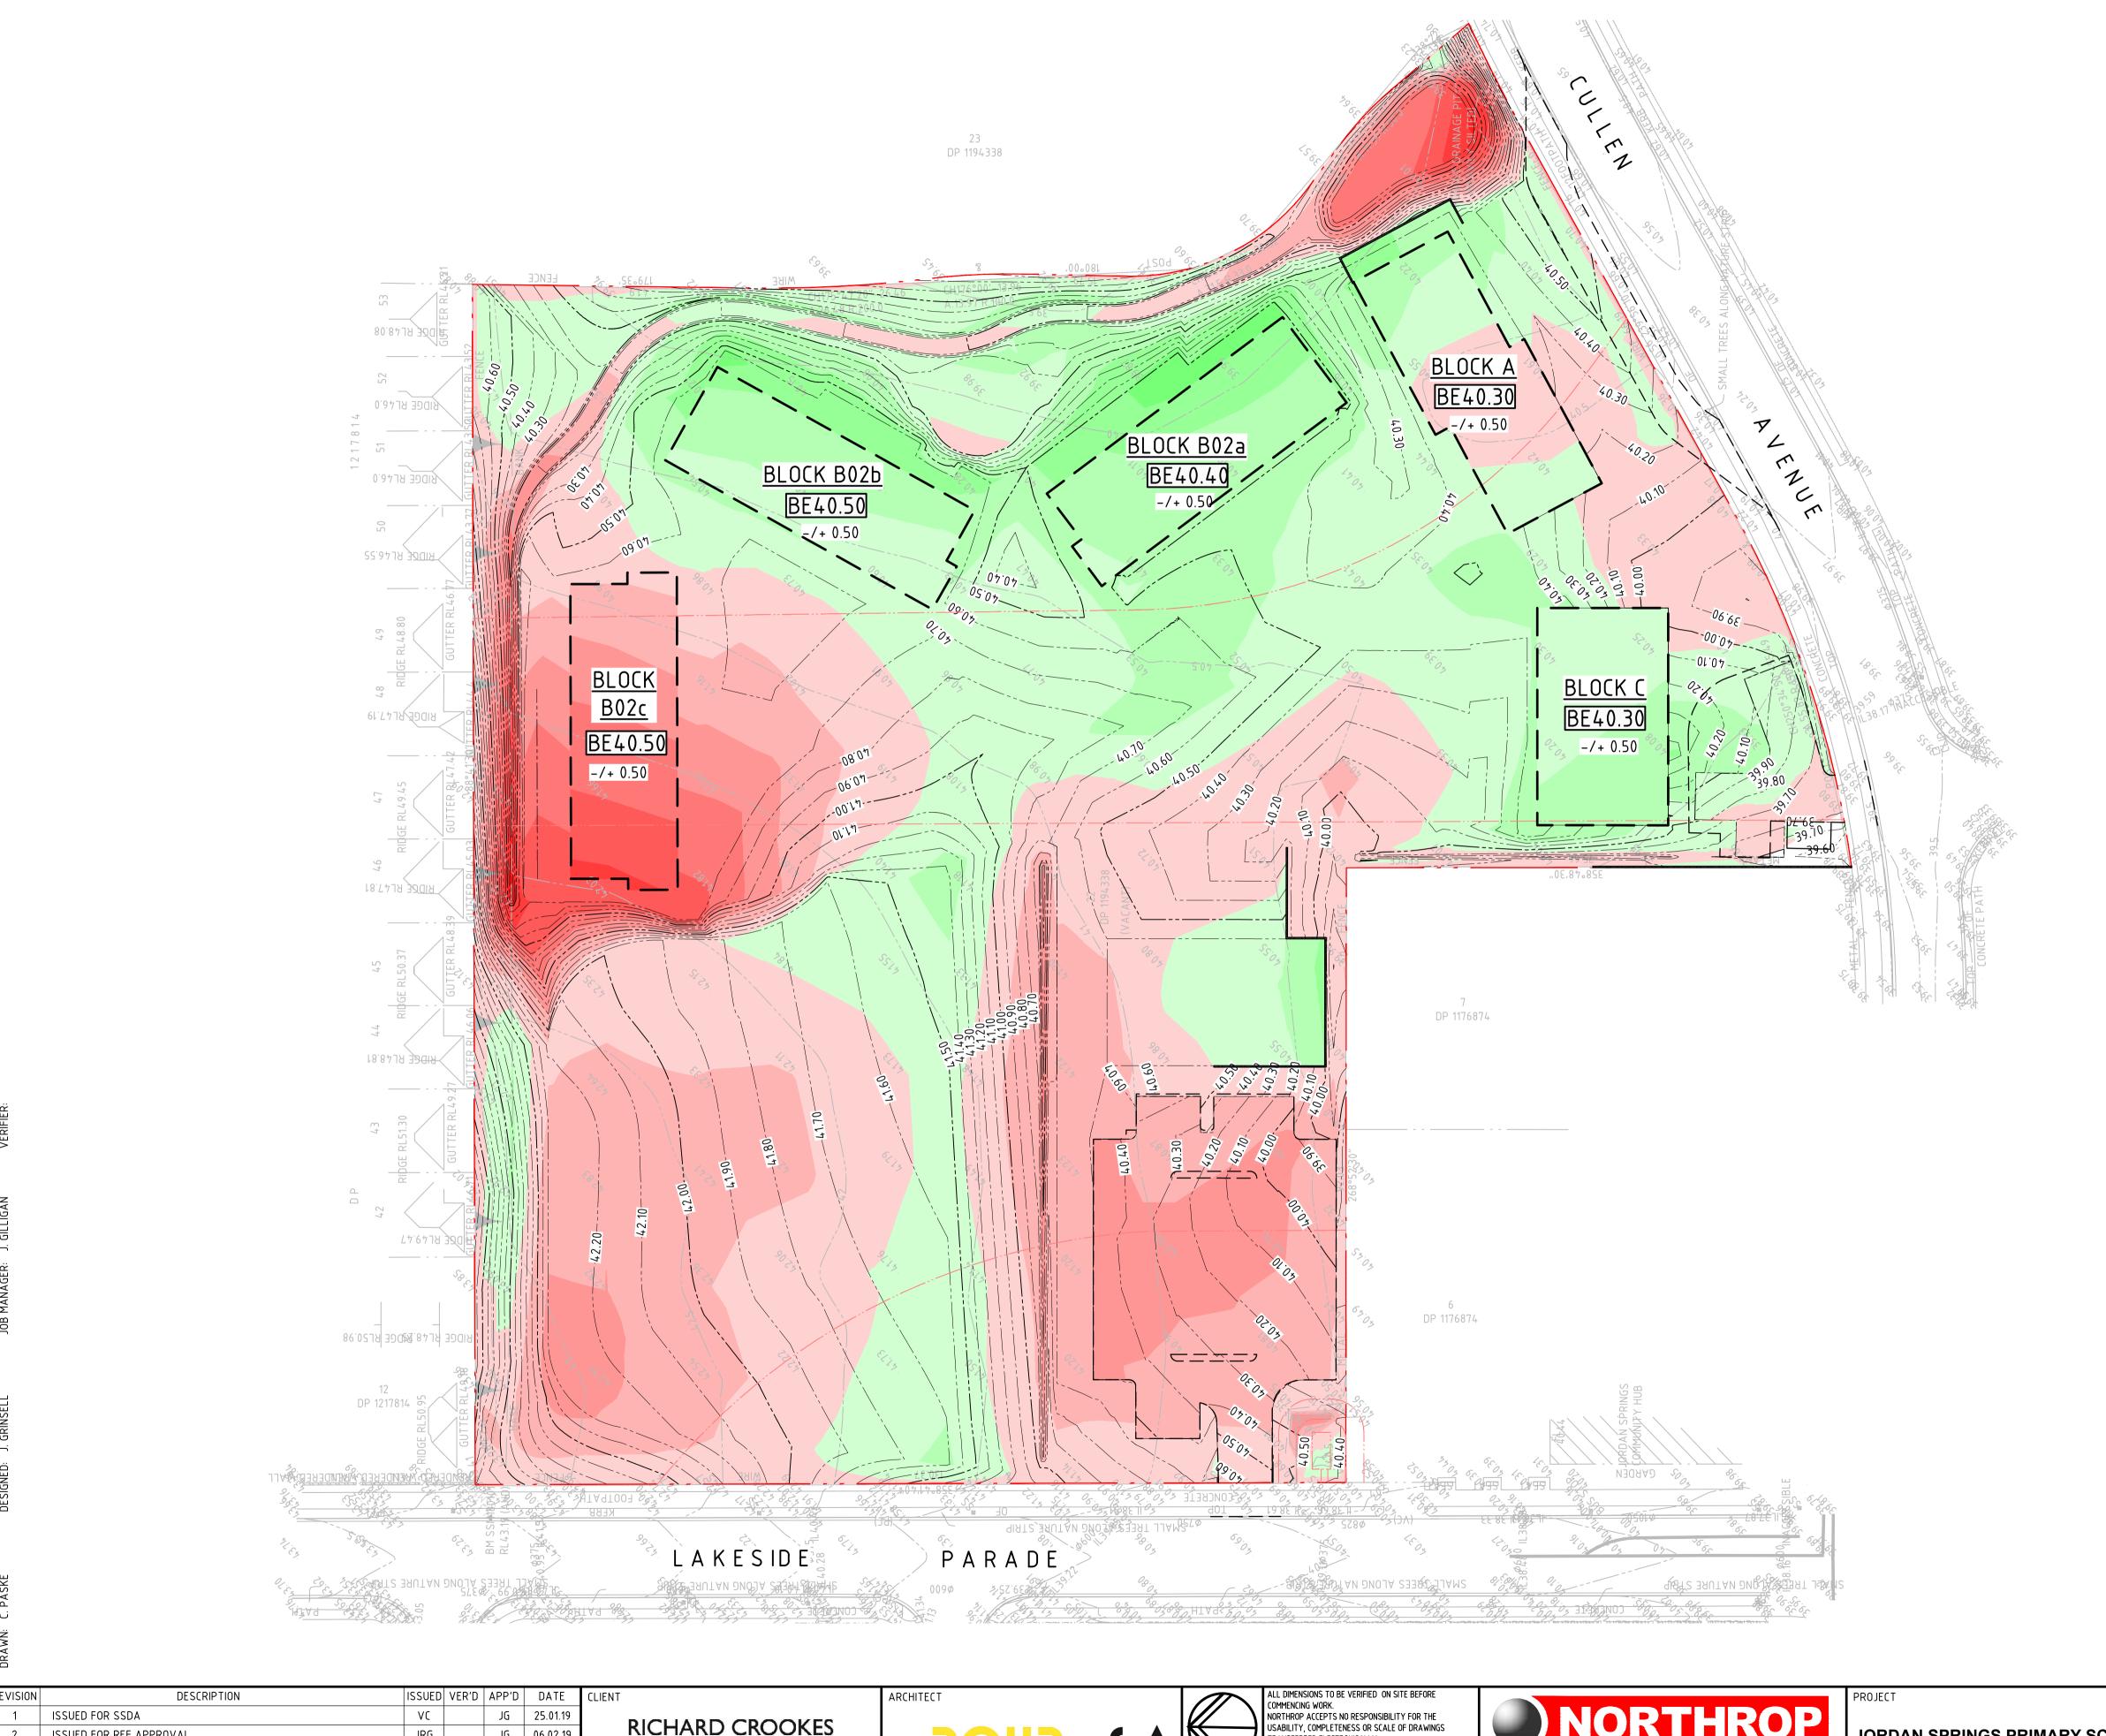

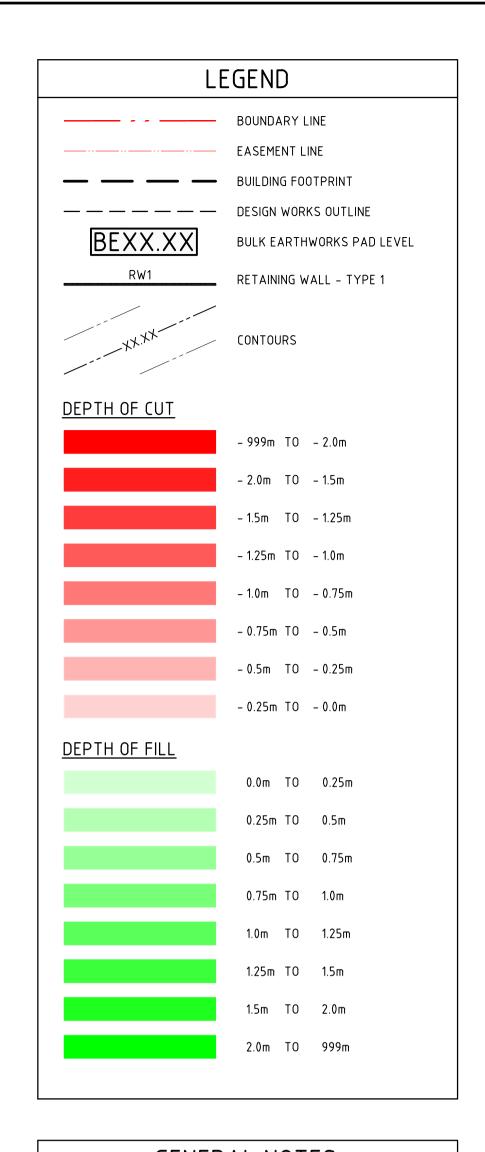

GENERAL NOTES:

- 1. ALL WORKS TO BE CARRIED OUT IN ACCORDANCE WITH COUNCIL / RELEVANT AUTHORITY SPECIFICATIONS AND
- 2. CAD FILES / DTM FILES TO BE SUPPLIED IN AUTOCAD
- FORMAT FOR SETOUT PURPOSES (UPON REQUEST). 3. STRIP EXISTING TOPSOIL IN CONSULTATION WITH THE GEOTECHNICAL ENGINEER / REPORT. FOR THE PURPOSES OF EARTHWORKS CALCULATIONS A TOPSOIL STRIPPING DEPTH
- OF 150mm HAS BEEN ASSUMED. GROUND SLAB DEPTH OF 400mm HAS BEEN ASSUMED WHERE REQUIRED.
- 4. NO ALLOWANCE HAS BEEN MADE FOR BULKING FACTORS. NOTE ALL VOLUMES DEPICTED ARE SOLID VOLUMES ONLY
- AND MAY NOT REFLECT DETAILED EARTHWORKS. 5. NO ALLOWANCE HAS BEEN MADE FOR DETAILED EARTHWORKS; ie SERVICE TRENCHING, DETAILED EXCAVATION, FOOTINGS, RETAINING WALLS AND THE LIKE.
- 6. THE CONTRACTOR SHALL USE FINAL SURFACE LEVELS AND TYPICAL PAVEMENT DETAILS FOR ACTUAL EARTHWORKS
- 7. BULK EARTHWORKS ARE BASED ON THE FOLLOWING DEPTHS FROM FINISHED SURFACE LEVELS;
- 7.1. ASPHALT PAVEMENT 200mm
- 7.2. CONCRETE PAVEMENT 200mm 7.3. BUILDING SLAB 400mm (REFER STRUCTURAL
- 7.4. FOOTPATH PAVEMENT 200mm
- 7.5. LANDSCAPE AREA 200mm
- 8. APPROXIMATE BULK EARTHWORK VALUES AS FOLLOWS;
- 8.1. CUT 5,148 cu.m 8.2. FILL 2,905 cu.m
- 8.3. BALANCE 2,243 cu.m CUT
- NOTE: SITE STRIPPING VOLUMES HAVE NOT BEEN INCLUDED IN ABOVE CALCULATIONS.

NOT FOR CONSTRUCTION


REVISION	DESCRIPTION	ISSUED	AFK,D	APP'U	DATE	CL
1	ISSUED FOR SSDA	VC		JG	25.01.19	
2	ISSUED FOR REF APPROVAL	JRG		JG	06.02.19	
3	ISSUED FOR DEVELOPMENT APPLICATION	JRG		JG	13.02.19	
4	ISSUED FOR SSDA	VC		JG	31.05.19	
						n

RICHARD CROOKES **CONSTRUCTIONS**

VERIFICATION SIGNATURE HAS BEEN ADDED



NORTHROP CONSULTING ENGINEERS PTY LTD

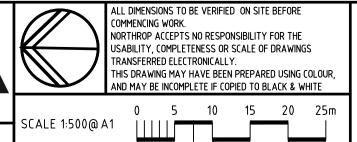



Level 11 345 George Street, Sydney NSW 2000 Ph (02) 9241 4188 Fax (02) 9241 4324 Email sydney@northrop.com.au ABN 81 094 433 100


JORDAN SPRINGS PRIMARY SCHOOL


14-28 CULLEN AVENUE, JORDAN SPRINGS

DRAWING TITLE CIVIL ENGINEERING PACKAGE **DEVELOPMENT APPLICATION**

> **BULK EARTHWORKS CUT AND FILL PLAN**

182535 DRAWING NUMBER REVISION

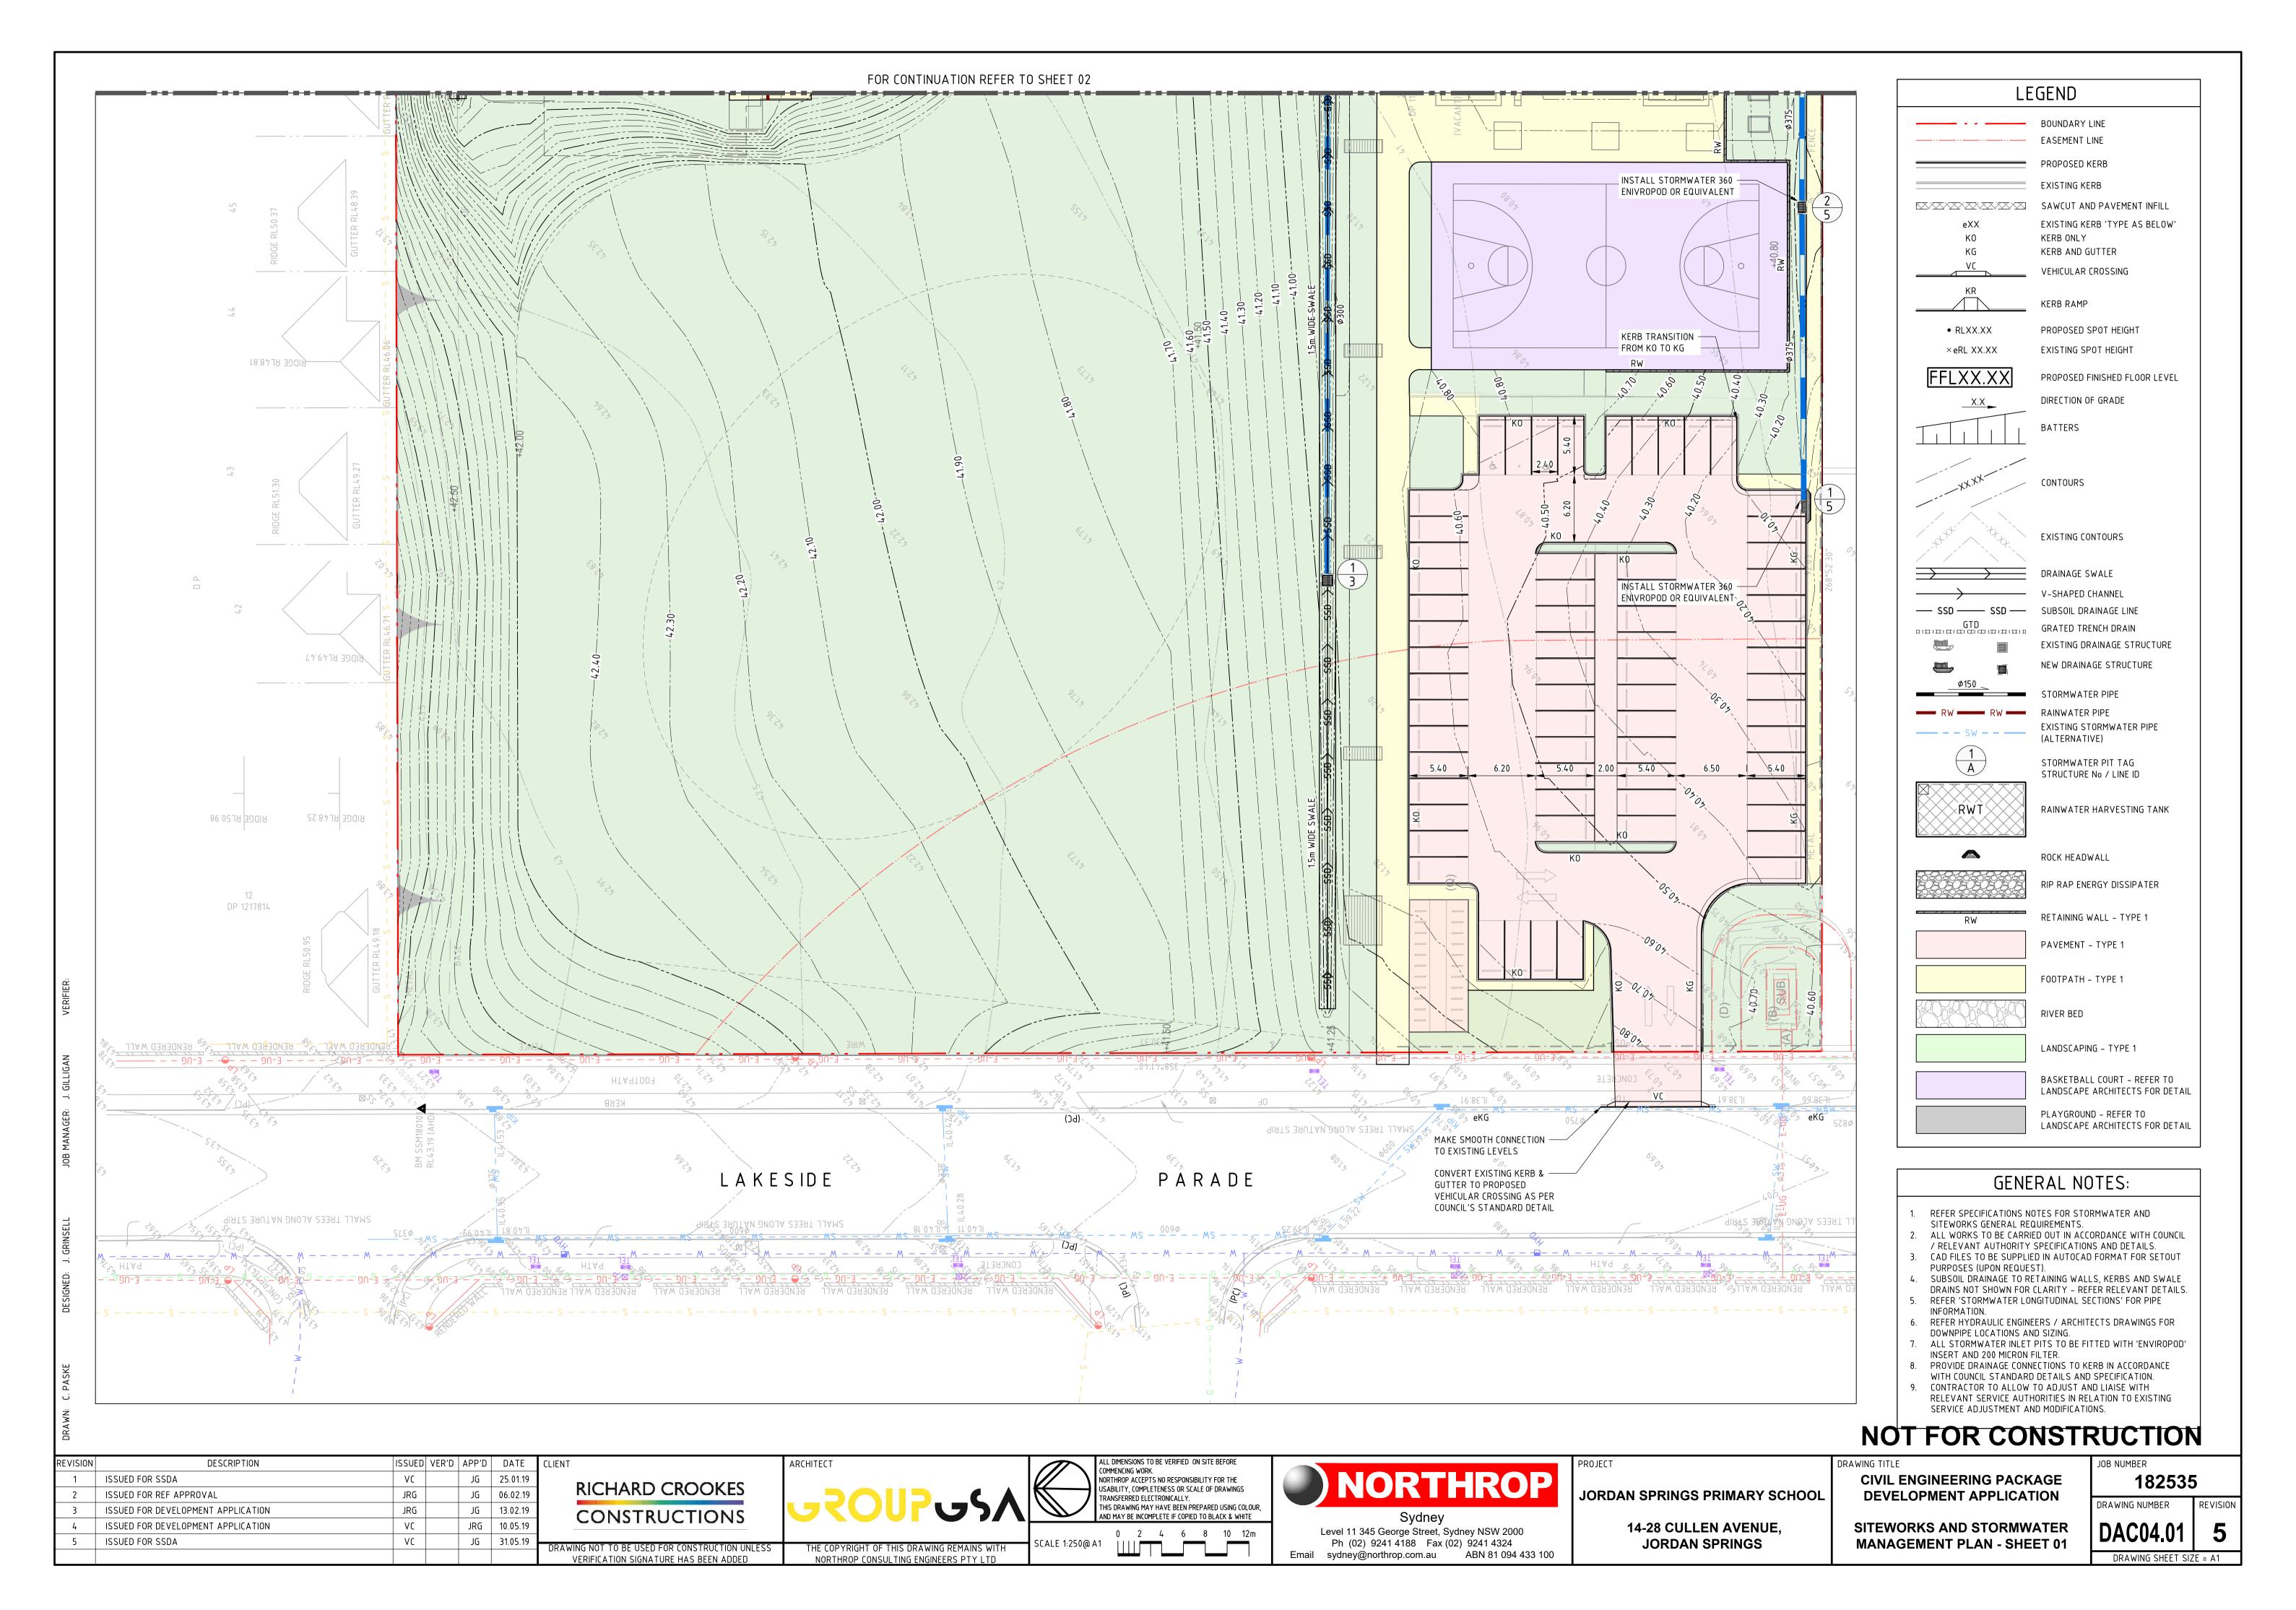

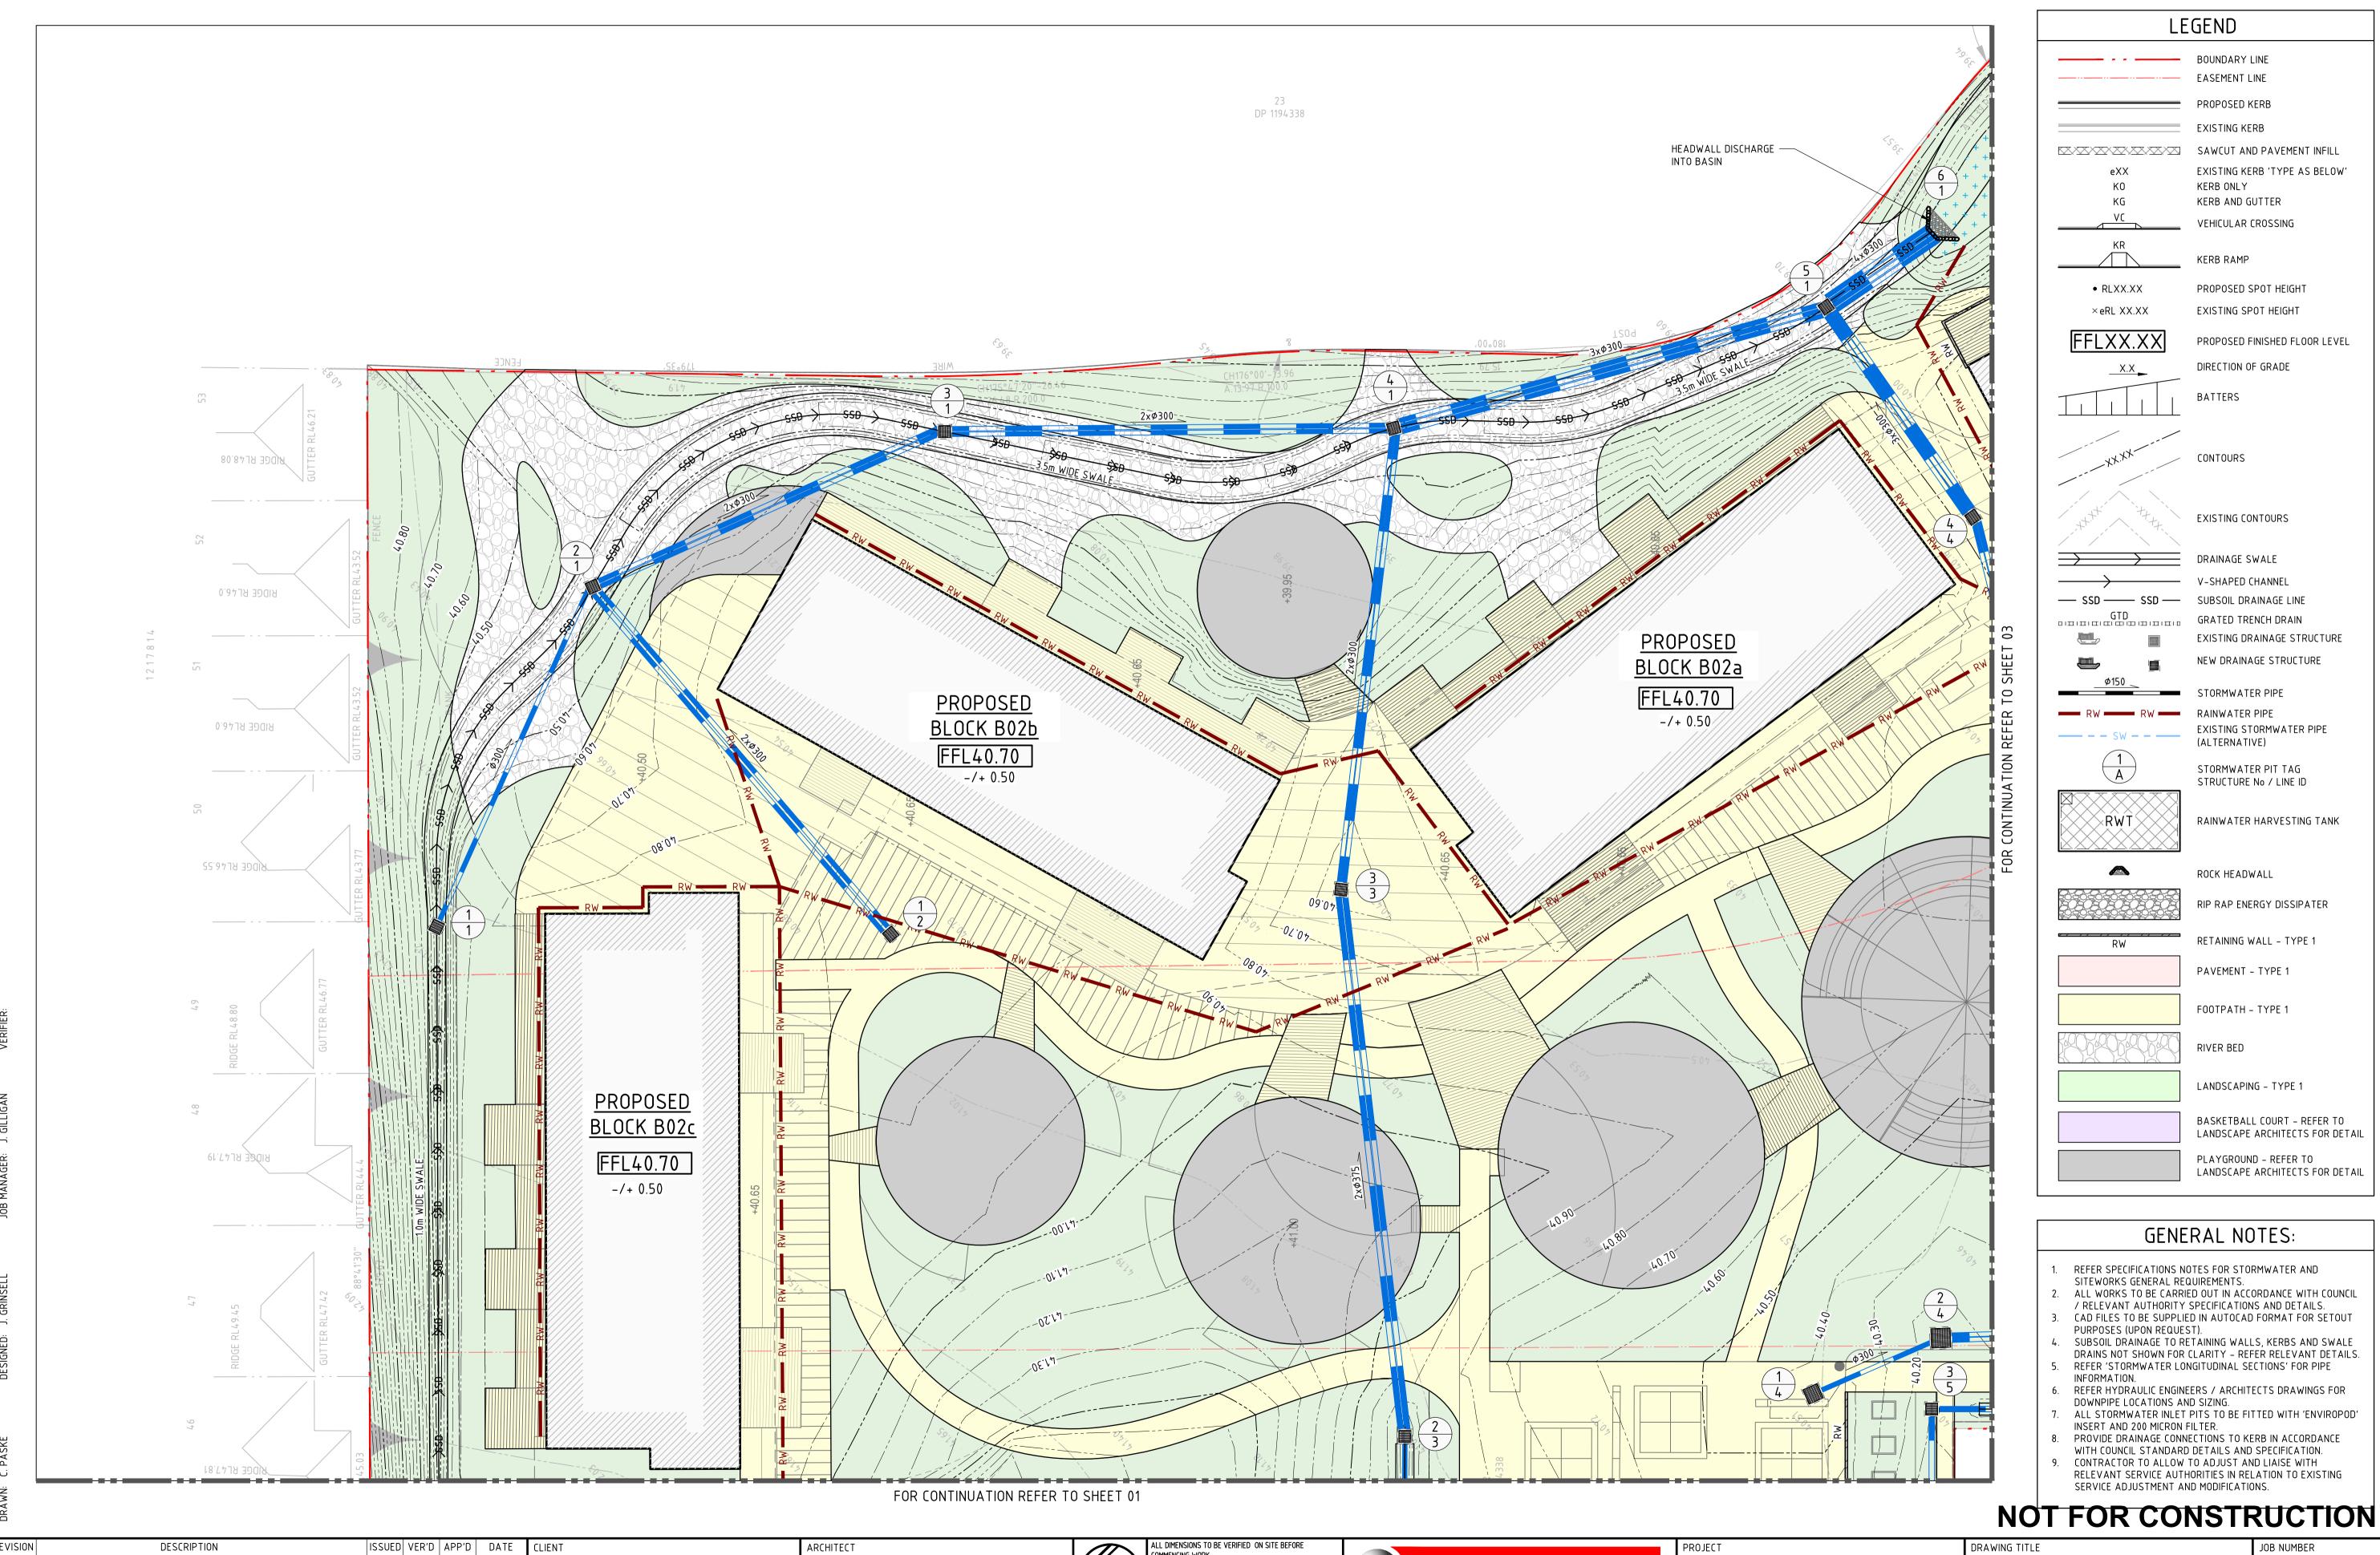

NORTHROP ACCEPTS NO RESPONSIBILITY FOR THE

TRANSFERRED ELECTRONICALLY.

SCALE 1:250@ A1

THE COPYRIGHT OF THIS DRAWING REMAINS WITH

NORTHROP CONSULTING ENGINEERS PTY LTD

JSABILITY, COMPLETENESS OR SCALE OF DRAWINGS

THIS DRAWING MAY HAVE BEEN PREPARED USING COLOUR,
AND MAY BE INCOMPLETE IF COPIED TO BLACK & WHITE

Sydney

Level 11 345 George Street, Sydney NSW 2000 Ph (02) 9241 4188 Fax (02) 9241 4324 Email sydney@northrop.com.au ABN 81 094 433 100

ISSUED FOR REF APPROVAL

3 ISSUED FOR DEVELOPMENT APPLICATION

ISSUED FOR DEVELOPMENT APPLICATION

ISSUED FOR DEVELOPMENT APPLICATION

ISSUED FOR DEVELOPMENT APPLICATION

JG 06.02.19

JG 13.02.19

JRG 10.05.19

JRG 15.05.19

JRG 16.05.19

JRG

VC

VC

RICHARD CROOKES

CONSTRUCTIONS

DRAWING NOT TO BE USED FOR CONSTRUCTION UNLESS

VERIFICATION SIGNATURE HAS BEEN ADDED

CIVIL ENGINEERING PACKAGE DEVELOPMENT APPLICATION

SITEWORKS AND STORMWATER MANAGEMENT PLAN - SHEET 02


DRAWING NUMBER REVISION


DRAWING SHEET SIZE = A1

JORDAN SPRINGS PRIMARY SCHOOL

14-28 CULLEN AVENUE,

JORDAN SPRINGS

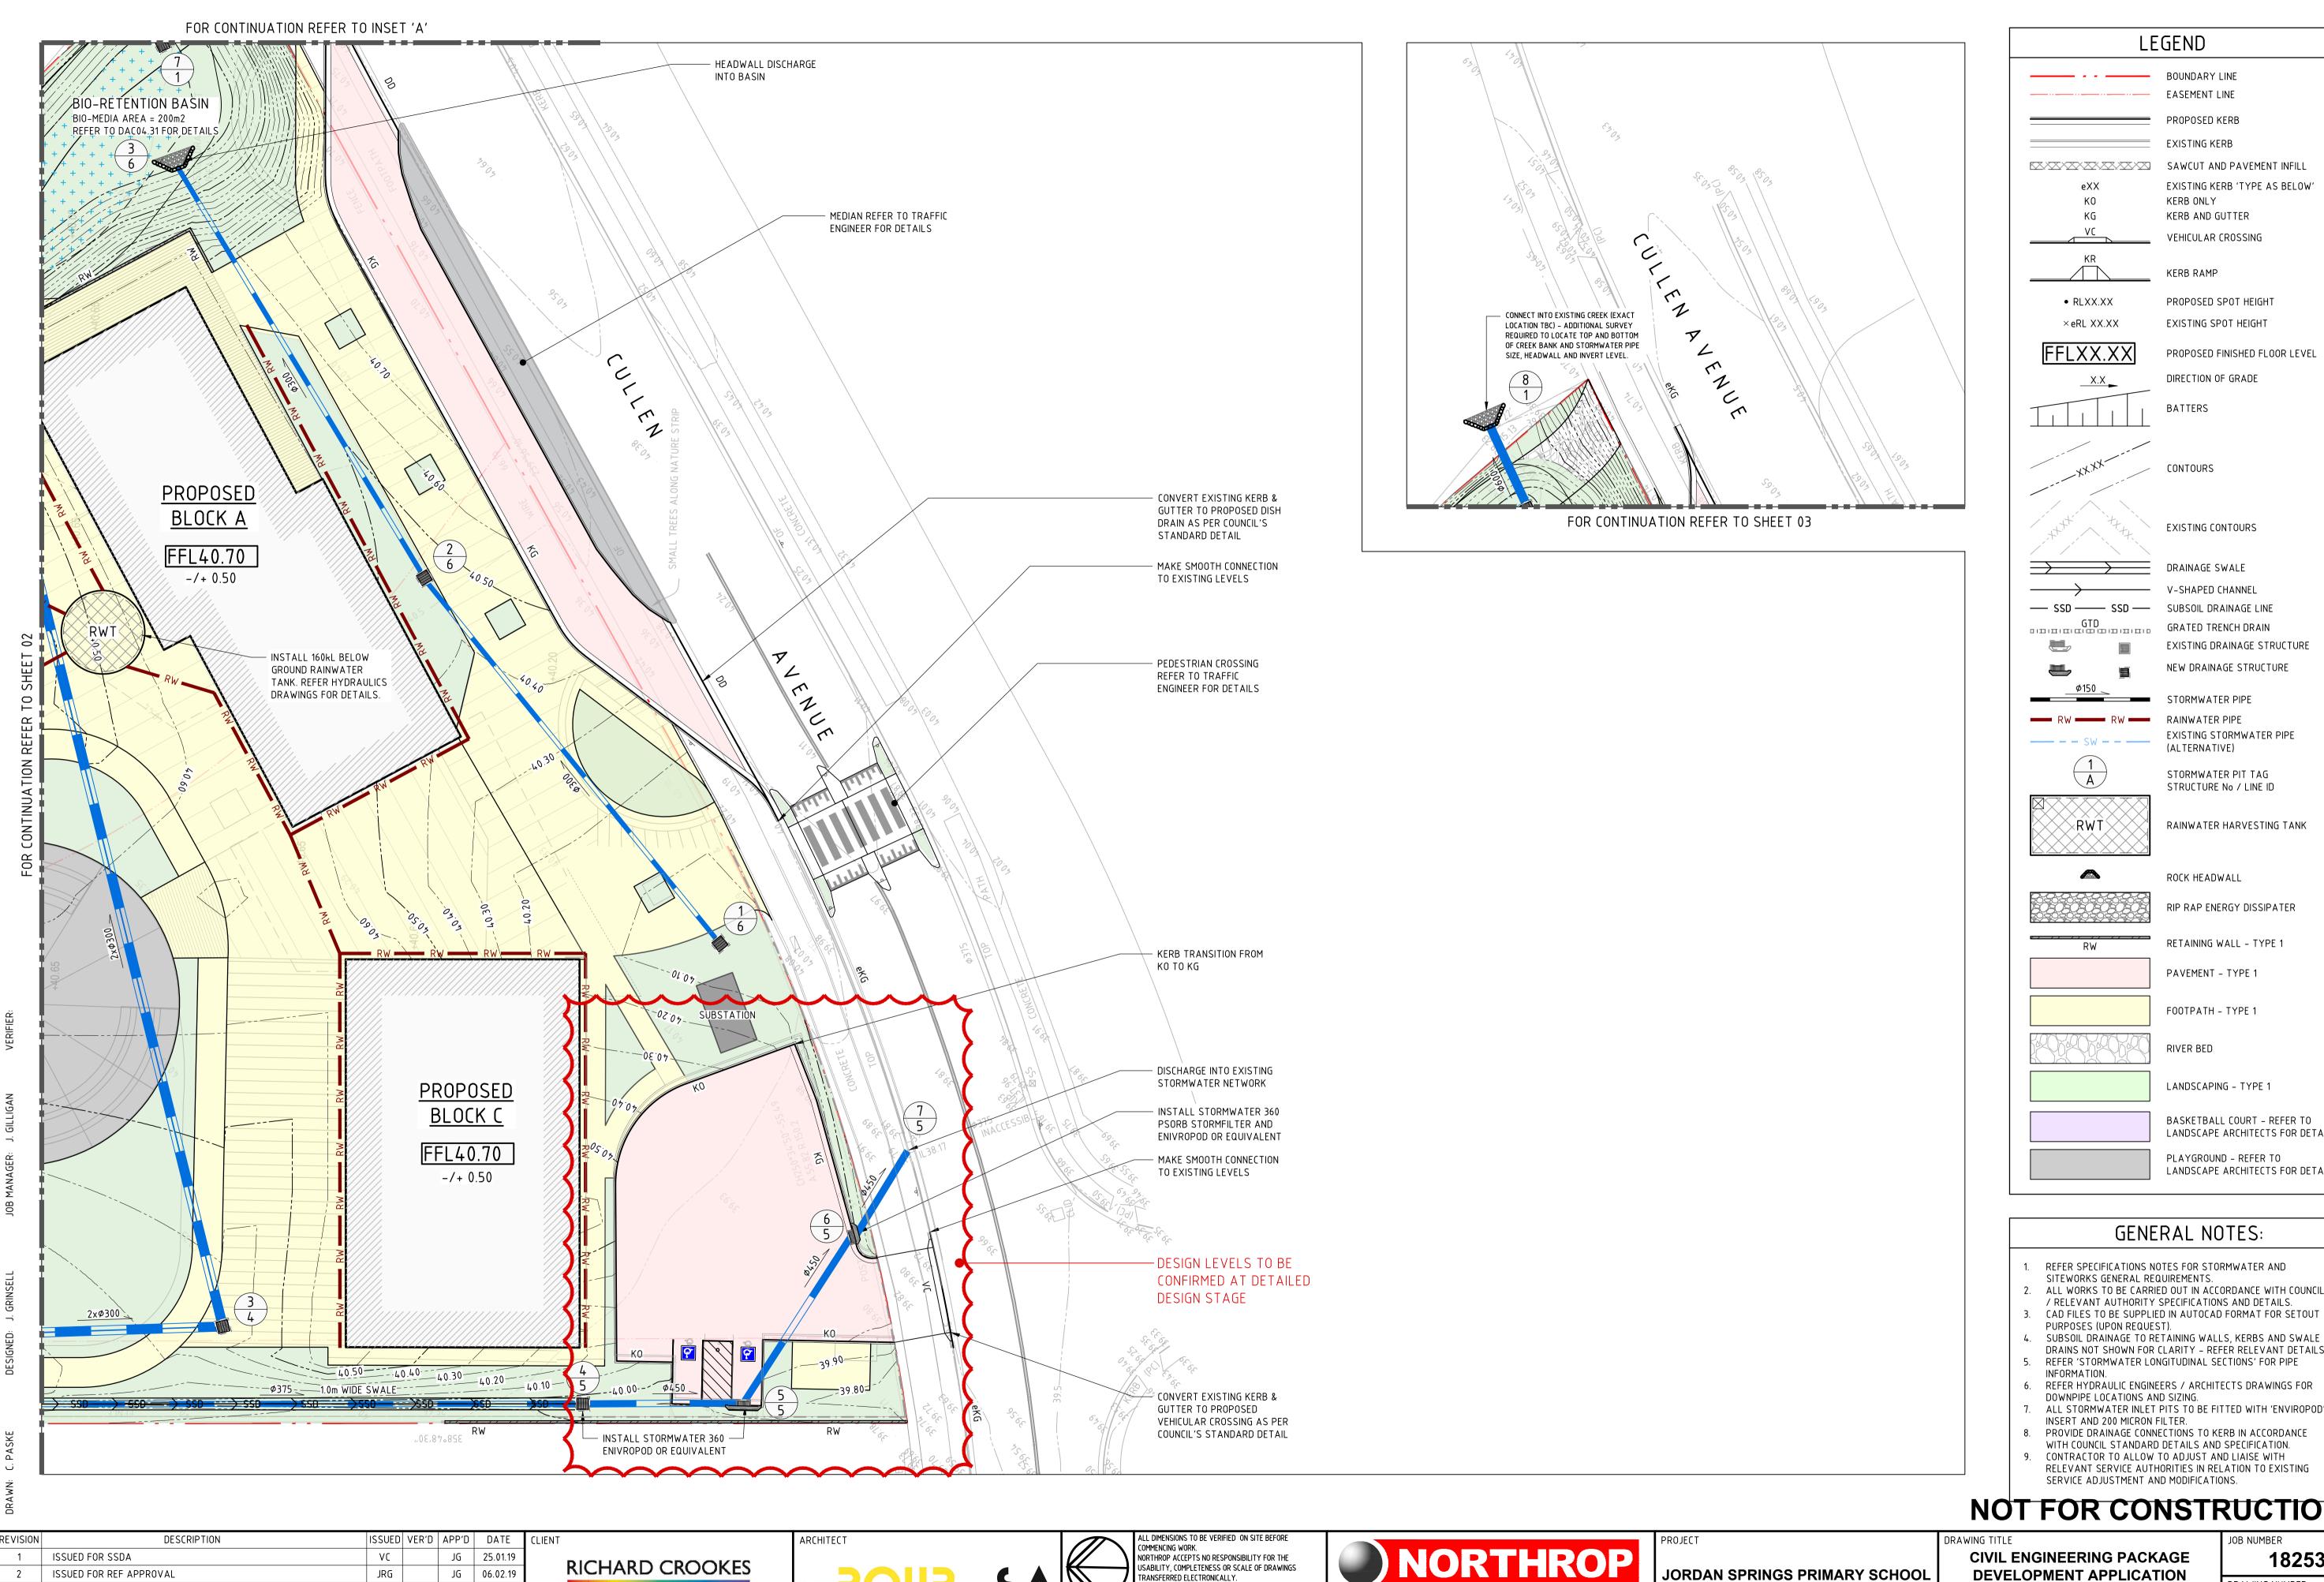

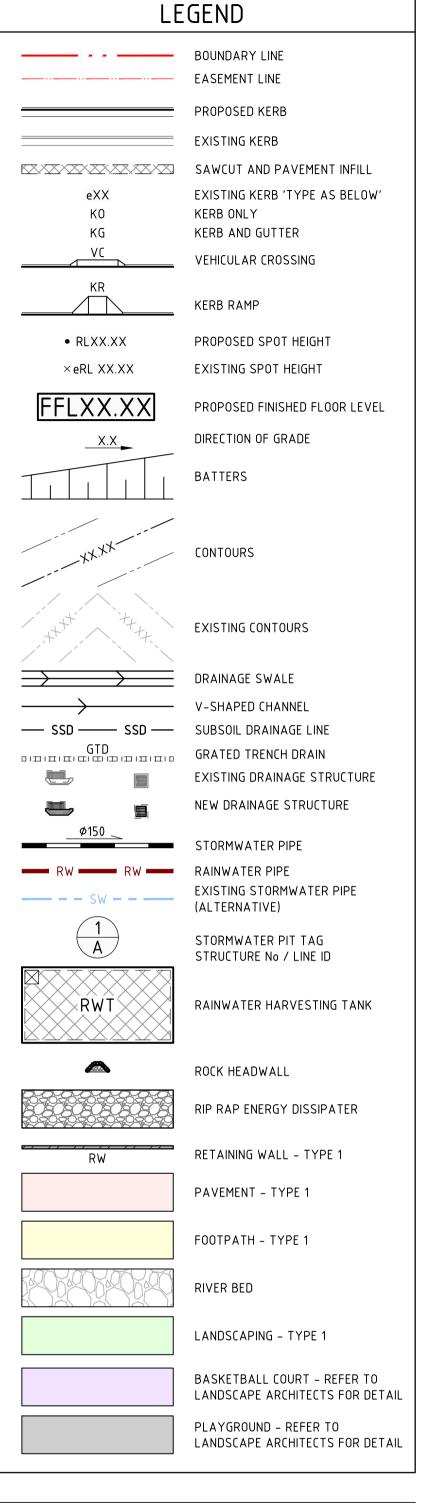

GENERAL NOTES:

- 1. REFER SPECIFICATIONS NOTES FOR STORMWATER AND
- SITEWORKS GENERAL REQUIREMENTS. 2. ALL WORKS TO BE CARRIED OUT IN ACCORDANCE WITH COUNCIL
- / RELEVANT AUTHORITY SPECIFICATIONS AND DETAILS. CAD FILES TO BE SUPPLIED IN AUTOCAD FORMAT FOR SETOUT PURPOSES (UPON REQUEST).
- DRAINS NOT SHOWN FOR CLARITY REFER RELEVANT DETAILS. REFER 'STORMWATER LONGITUDINAL SECTIONS' FOR PIPE
- INFORMATION.
- 6. REFER HYDRAULIC ENGINEERS / ARCHITECTS DRAWINGS FOR DOWNPIPE LOCATIONS AND SIZING.
- ALL STORMWATER INLET PITS TO BE FITTED WITH 'ENVIROPOD'
- INSERT AND 200 MICRON FILTER.
- 8. PROVIDE DRAINAGE CONNECTIONS TO KERB IN ACCORDANCE WITH COUNCIL STANDARD DETAILS AND SPECIFICATION. CONTRACTOR TO ALLOW TO ADJUST AND LIAISE WITH

SERVICE ADJUSTMENT AND MODIFICATIONS. NOT FOR CONSTRUCTION

1	ISSUED FOR SSDA	VC	JG	25.01.19
2	ISSUED FOR REF APPROVAL	JRG	JG	06.02.19
3	ISSUED FOR DEVELOPMENT APPLICATION	JRG	JG	13.02.19
4	ISSUED FOR DEVELOPMENT APPLICATION	VC	JRG	10.05.19
5	ISSUED FOR DEVELOPMENT APPLICATION	VC	JRG	15.05.19
6	ISSUED FOR SSDA	VC	JG	31.05.19

CONSTRUCTIONS


DRAWING NOT TO BE USED FOR CONSTRUCTION UNLESS


VERIFICATION SIGNATURE HAS BEEN ADDED



THE COPYRIGHT OF THIS DRAWING REMAINS WITH

NORTHROP CONSULTING ENGINEERS PTY LTD

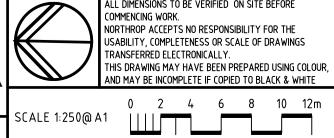

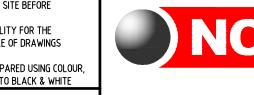

Level 11 345 George Street, Sydney NSW 2000 Ph (02) 9241 4188 Fax (02) 9241 4324 Email sydney@northrop.com.au ABN 81 094 433 100 **JORDAN SPRINGS PRIMARY SCHOOL**


14-28 CULLEN AVENUE, **JORDAN SPRINGS**


CIVIL ENGINEERING PACKAGE


SITEWORKS AND STORMWATER **MANAGEMENT PLAN - SHEET 03**

182535 DRAWING NUMBER

REVISION **DAC04.03** DRAWING SHEET SIZE = A1

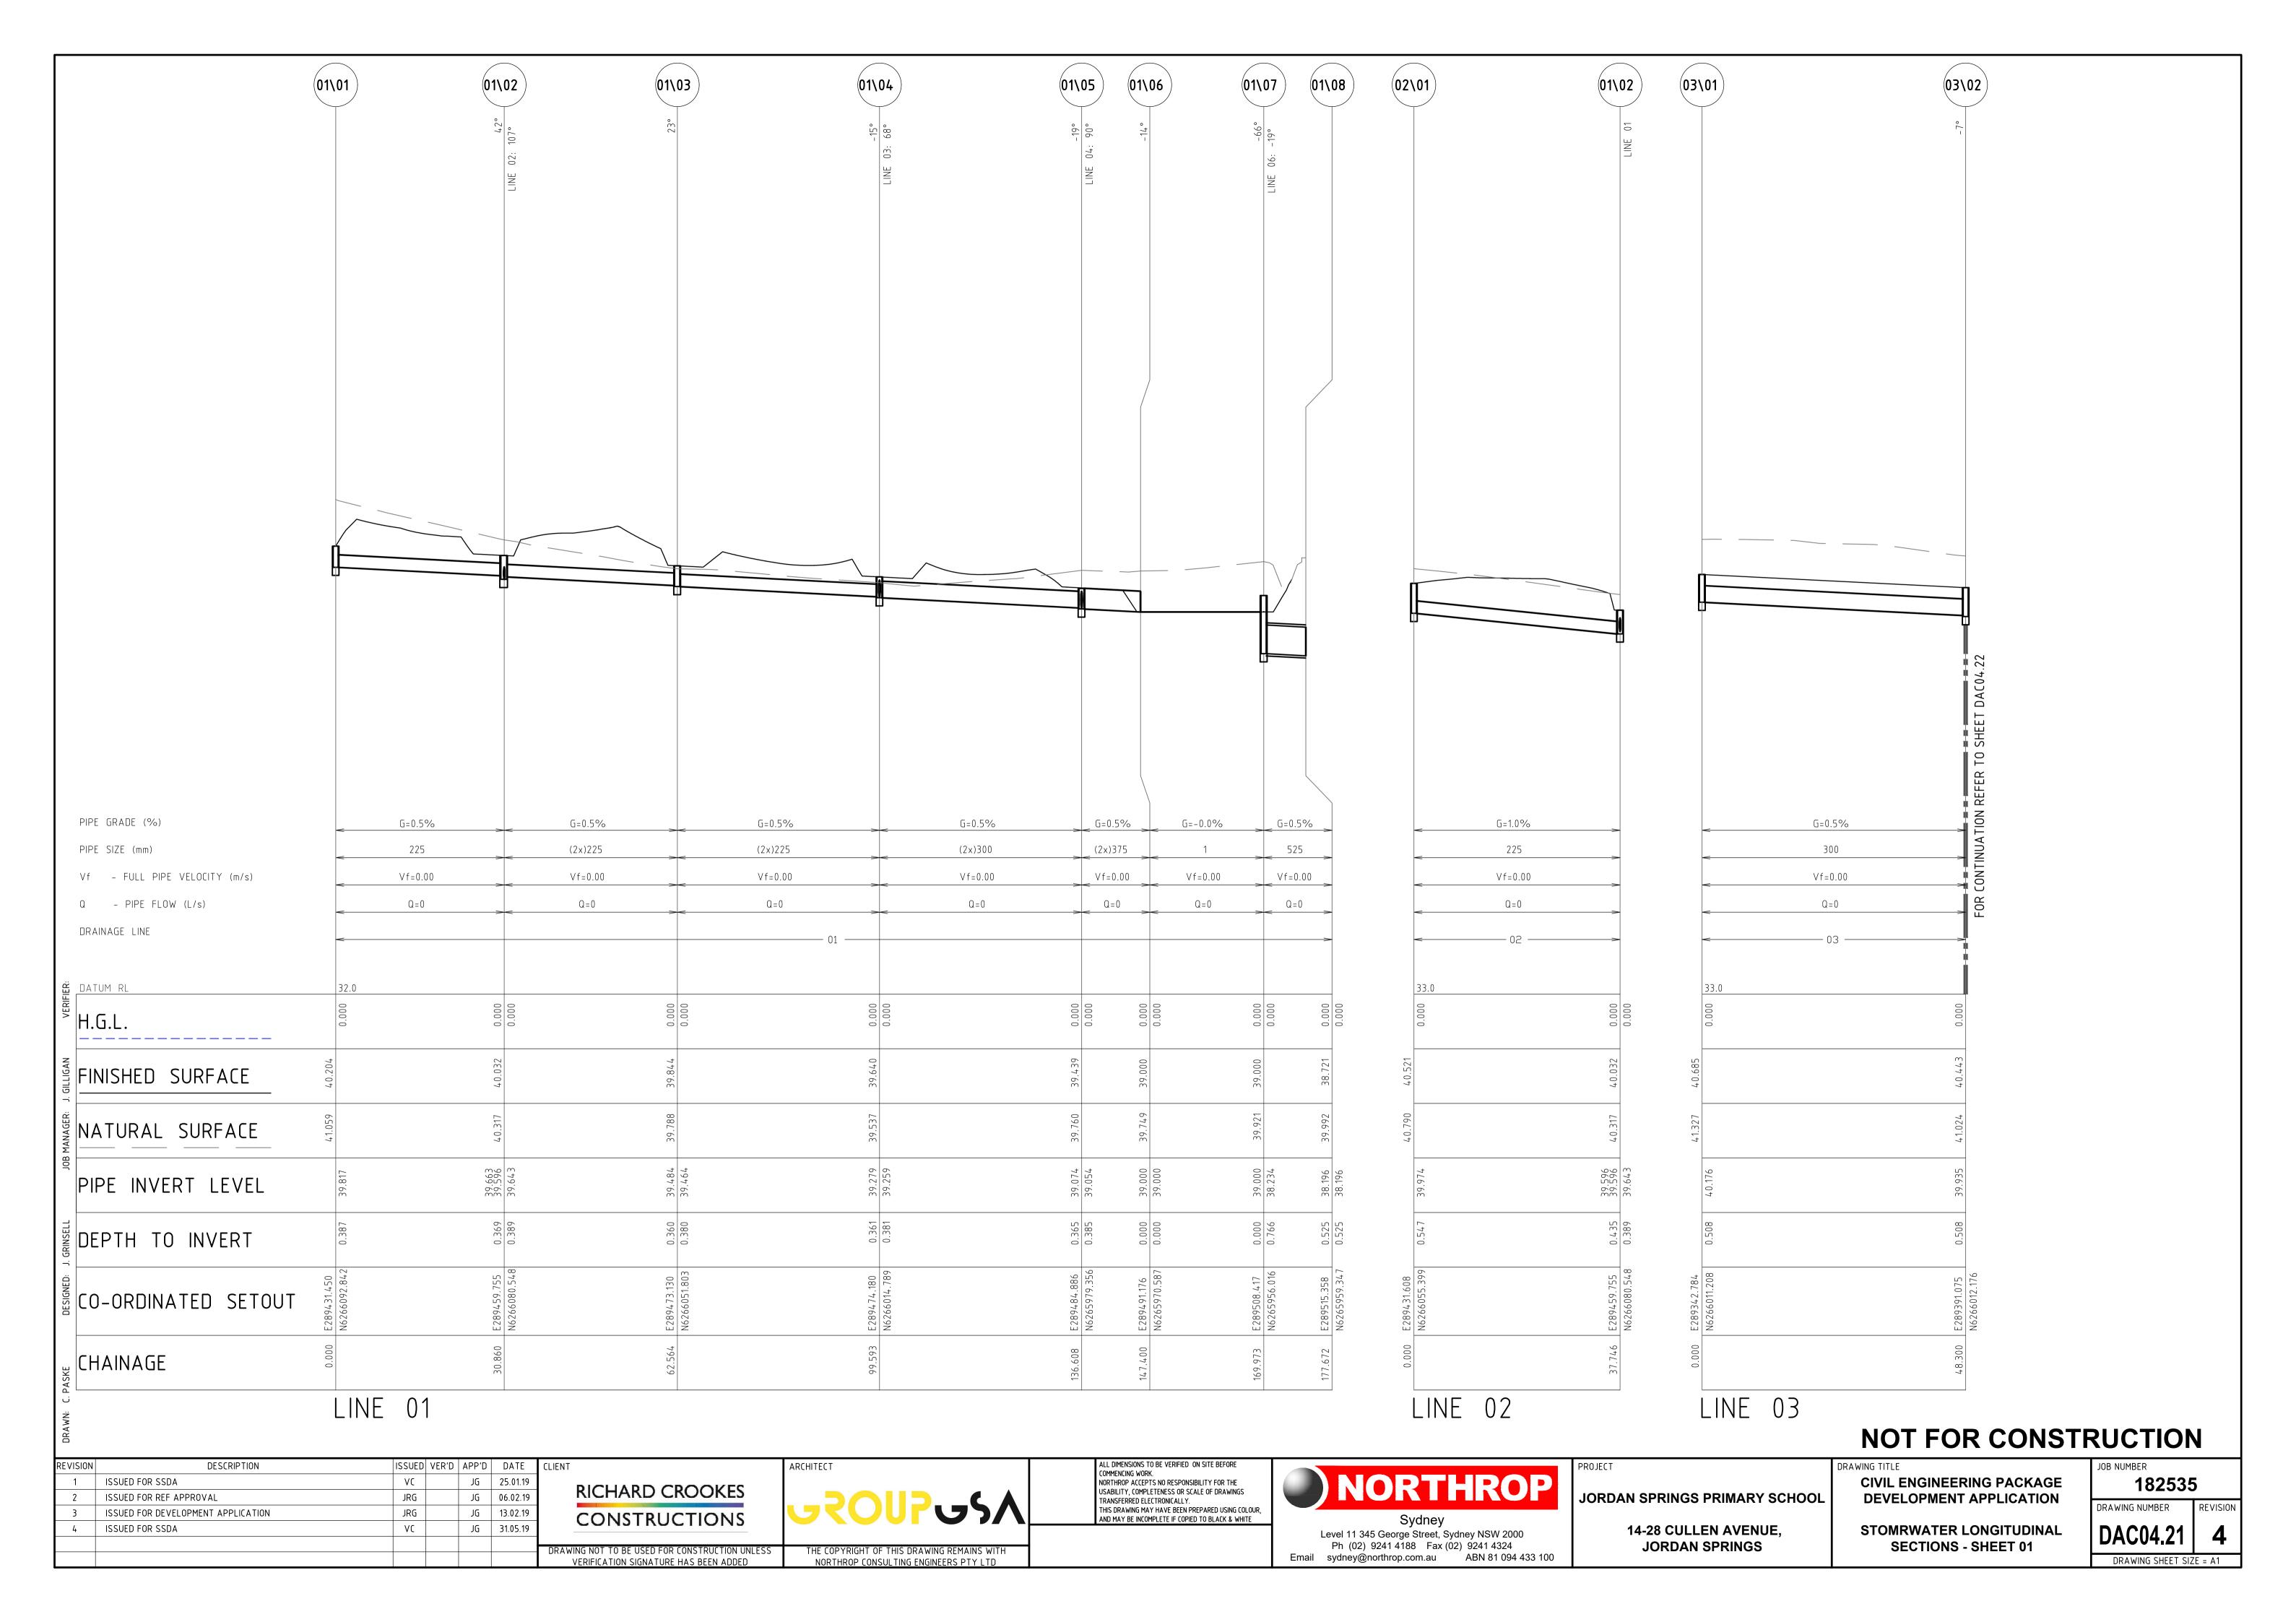

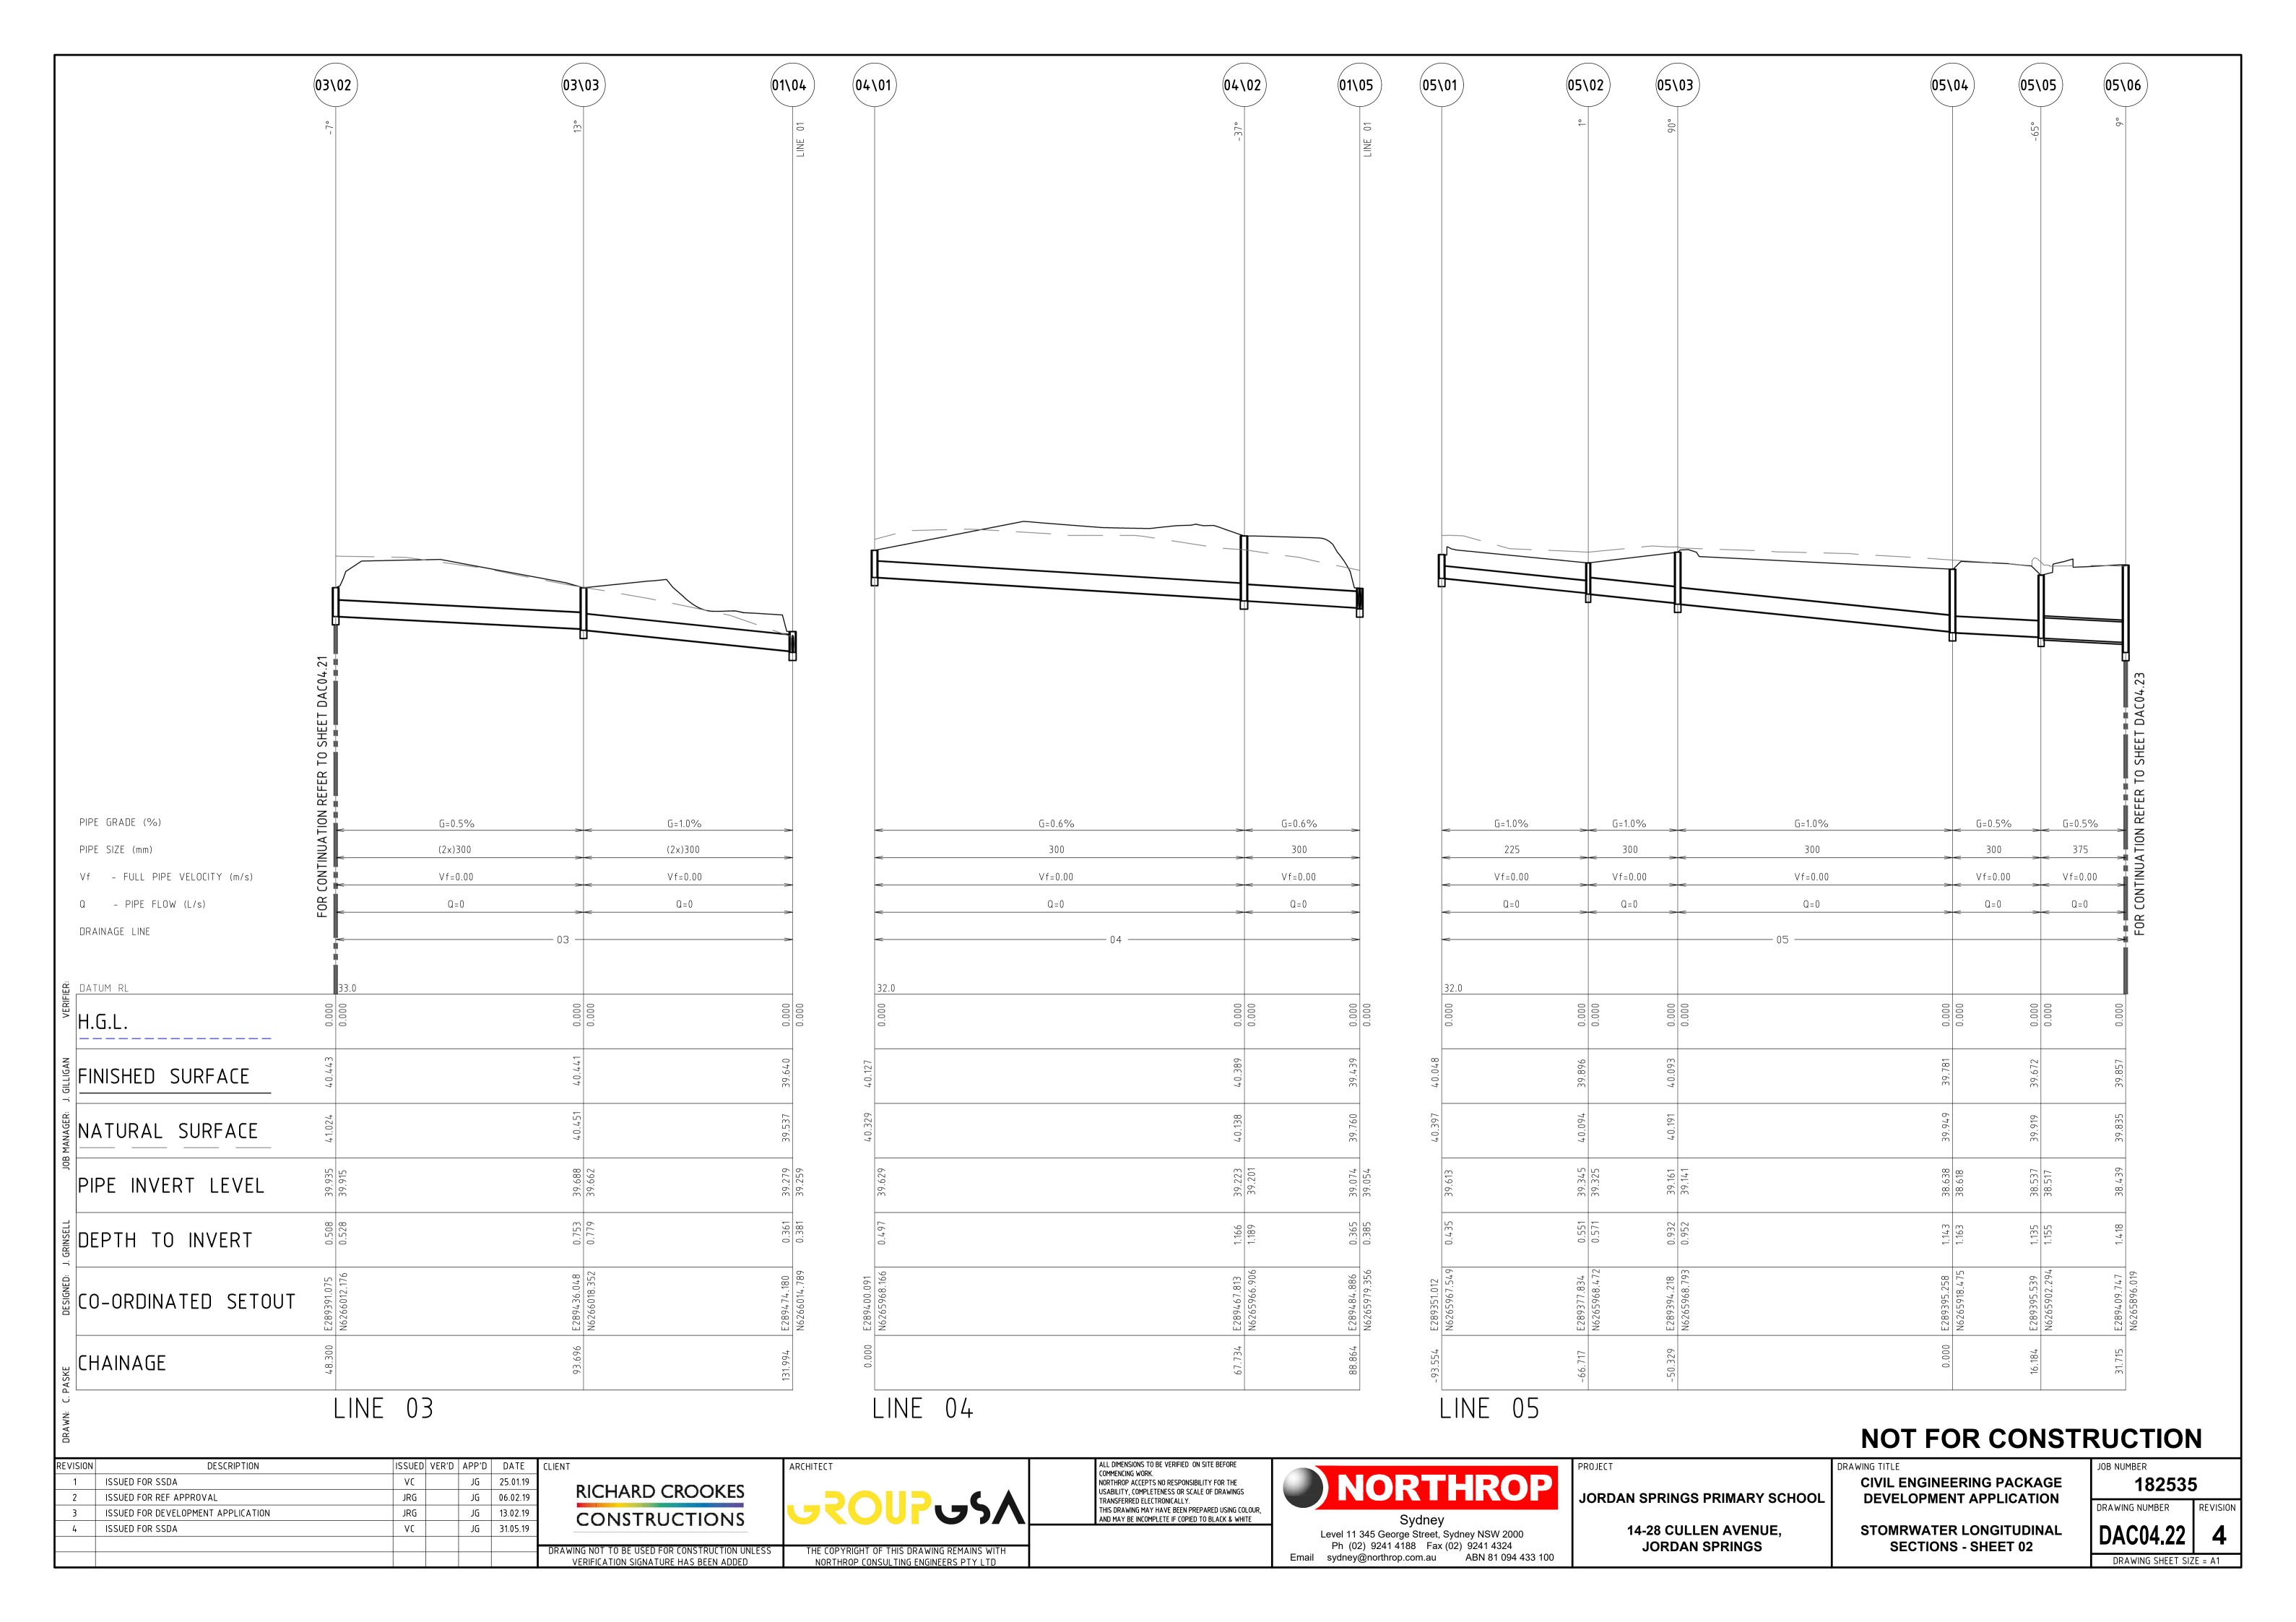

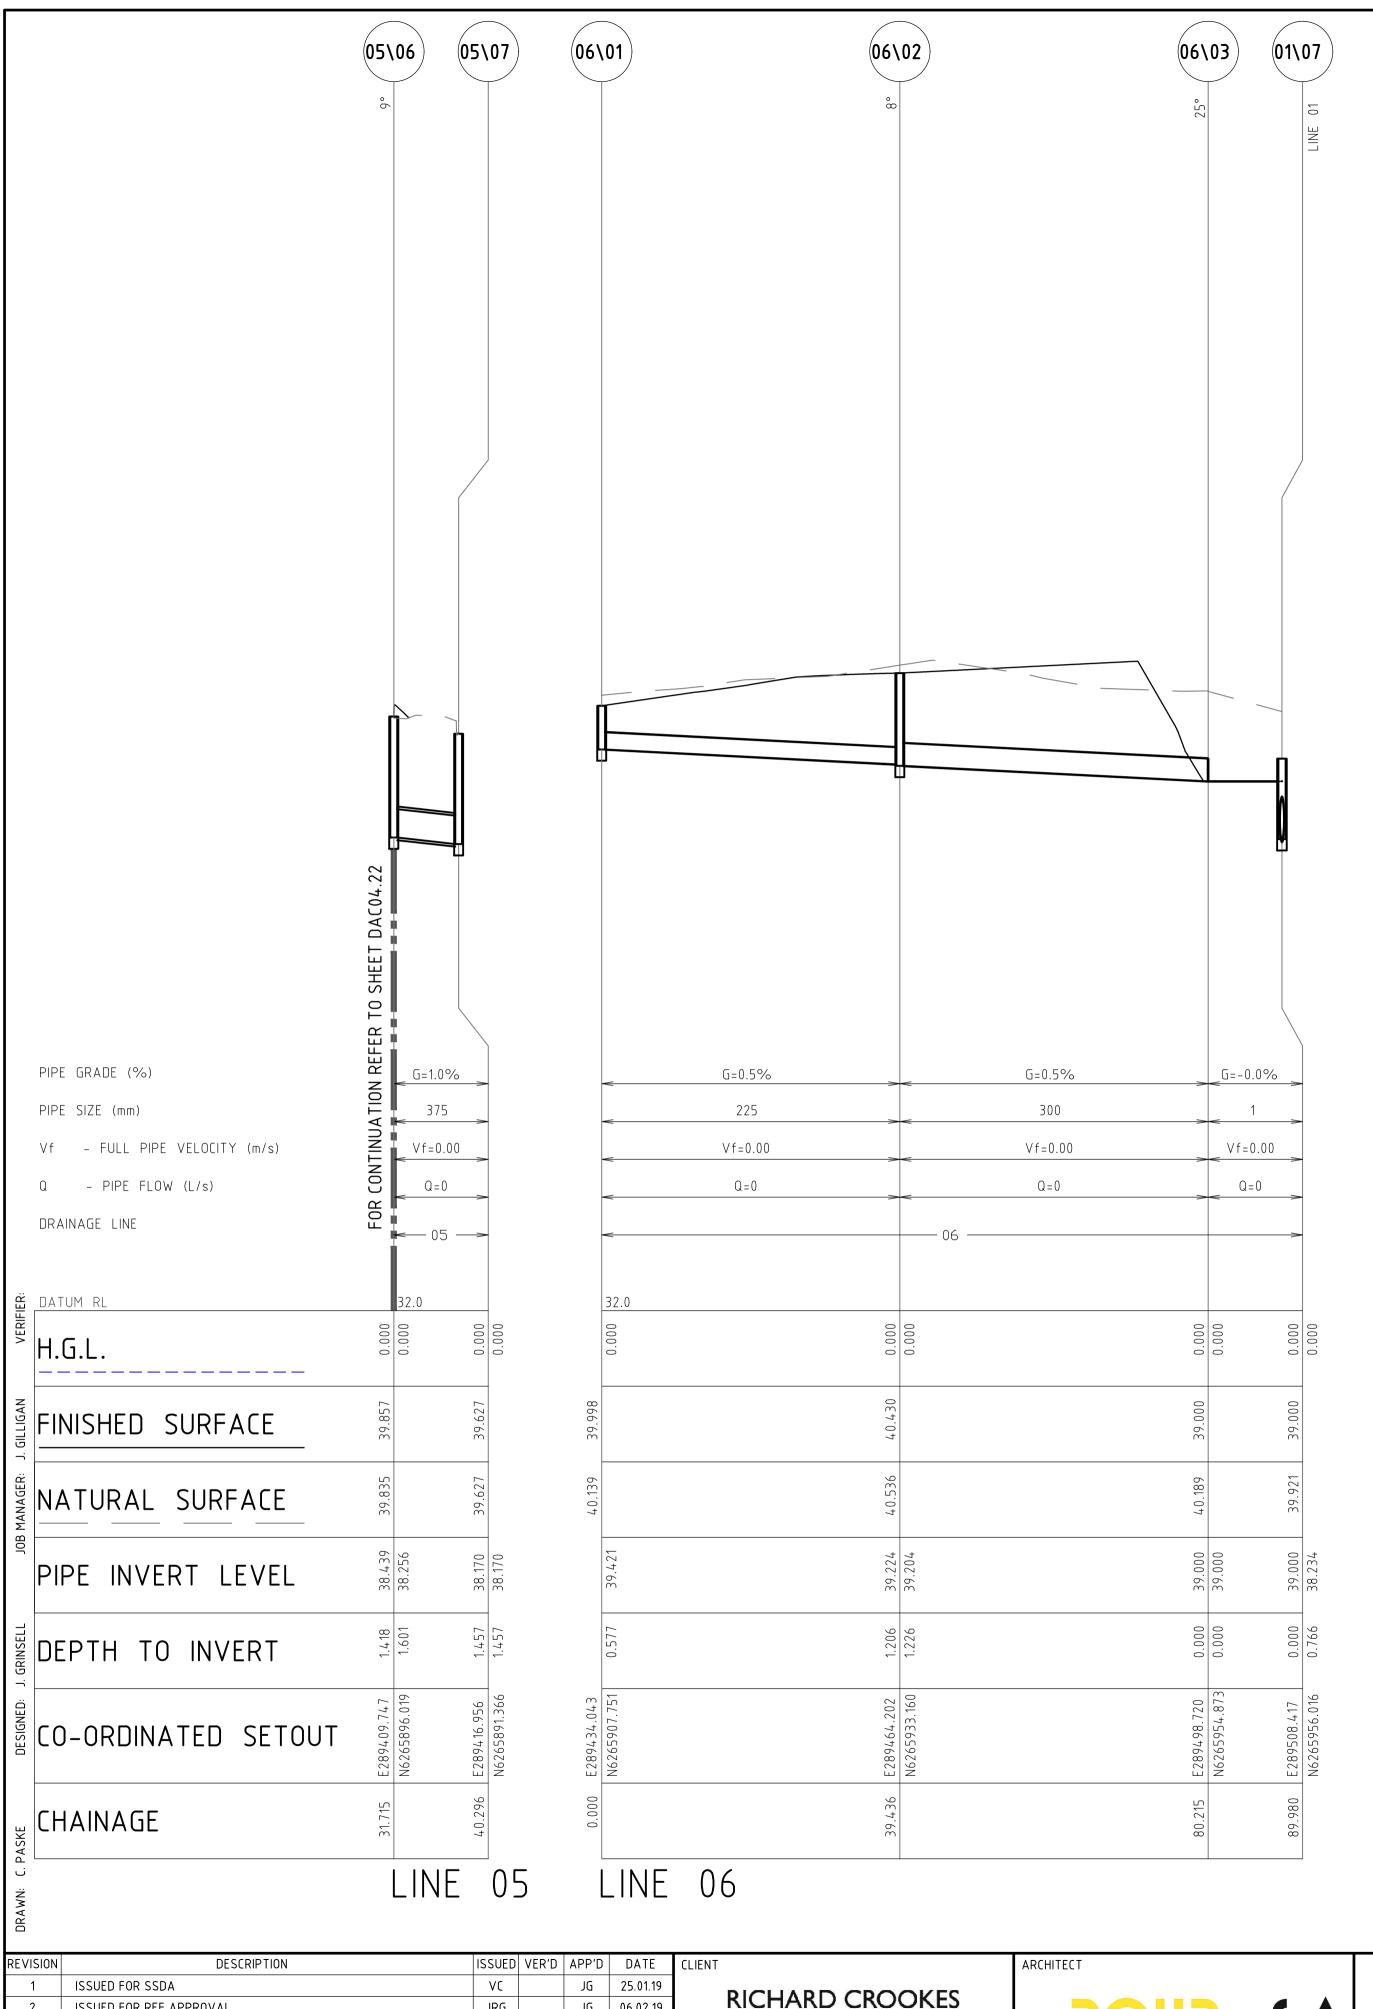

NOT FOR CONSTRUCTION

1	ISSUED FOR SSDA	VC	JG	25.01.19
2	ISSUED FOR REF APPROVAL	JRG	JG	06.02.19
3	ISSUED FOR DEVELOPMENT APPLICATION	JRG	JG	31.02.19
4	ISSUED FOR SSDA	VC	JG	31.05.19
DRAY				

RICHARD CROOKES
CONSTRUCTIONS

DRAWING NOT TO BE USED FOR CONSTRUCTION UNLESS
VERIFICATION SIGNATURE HAS BEEN ADDED

THE COPYRIGHT OF THIS DRAWING REMAINS WITH

NORTHROP CONSULTING ENGINEERS PTY LTD

ALL DIMENSIONS TO BE VERIFIED ON SITE BEFORE COMMENCING WORK.

NORTHROP ACCEPTS NO RESPONSIBILITY FOR THE USABILITY, COMPLETENESS OR SCALE OF DRAWINGS TRANSFERRED ELECTRONICALLY.

THIS DRAWING MAY HAVE BEEN PREPARED USING COLOUR, AND MAY BE INCOMPLETE IF COPIED TO BLACK & WHITE



Sydney

Level 11 345 George Street, Sydney NSW 2000

Ph (02) 9241 4188 Fax (02) 9241 4324

Email sydney@northrop.com.au ABN 81 094 433 100

JORDAN SPRINGS PRIMARY SCHOOL

14-28 CULLEN AVENUE, JORDAN SPRINGS CIVIL ENGINEERING PACKAGE DEVELOPMENT APPLICATION


STOMRWATER LONGITUDINAL


SECTIONS - SHEET 03

182535


DRAWING NUMBER REVISION

DAC04.23 4

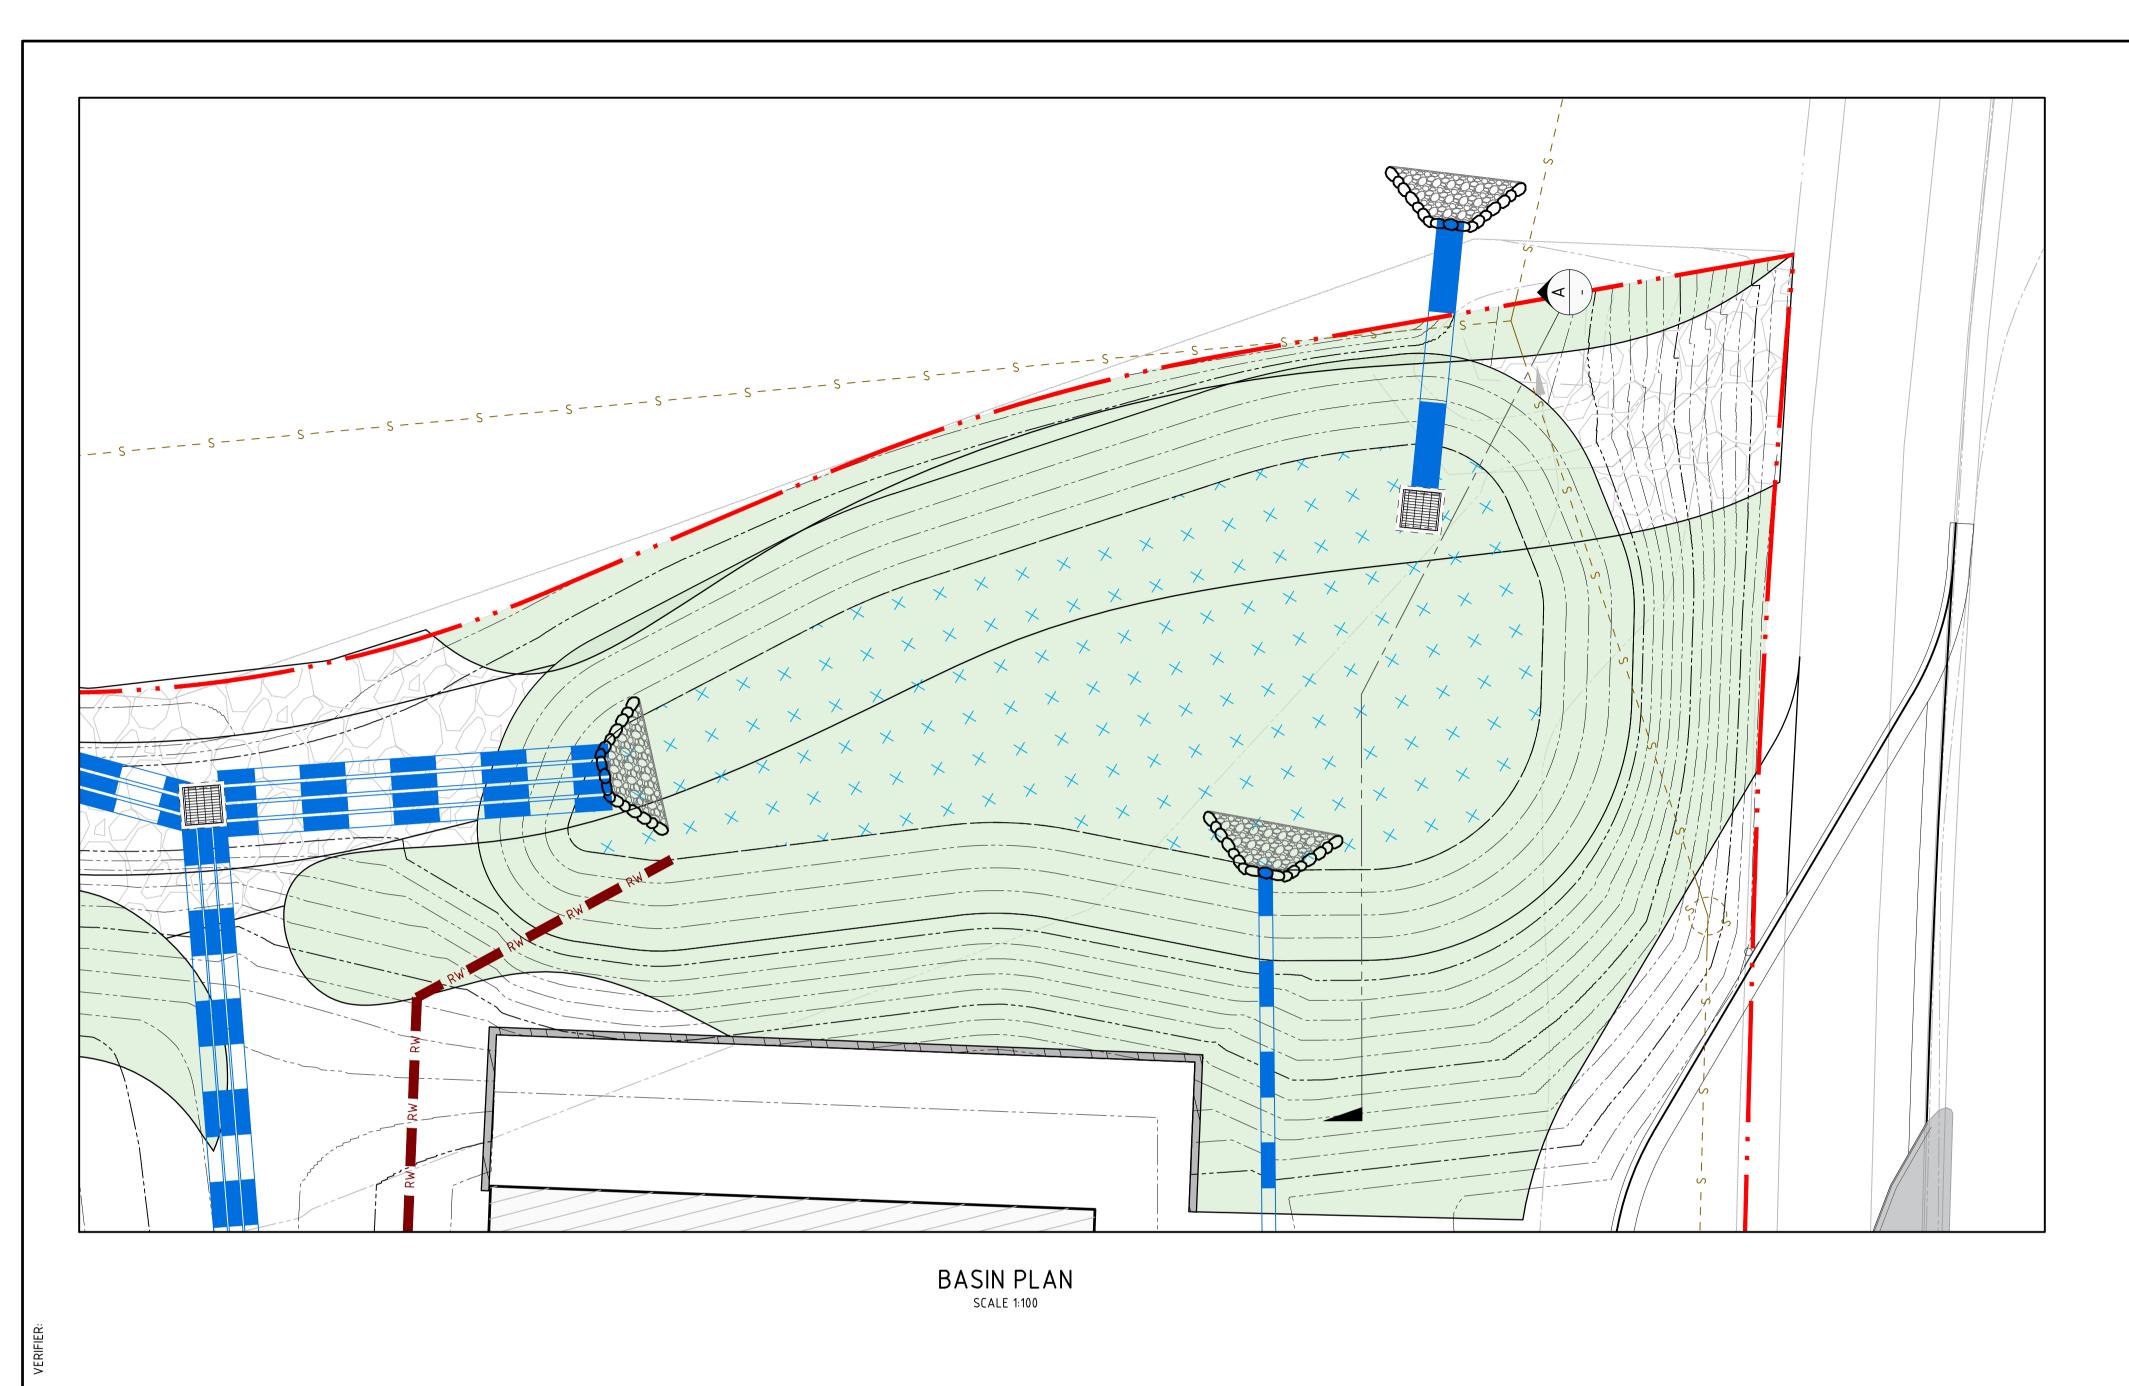

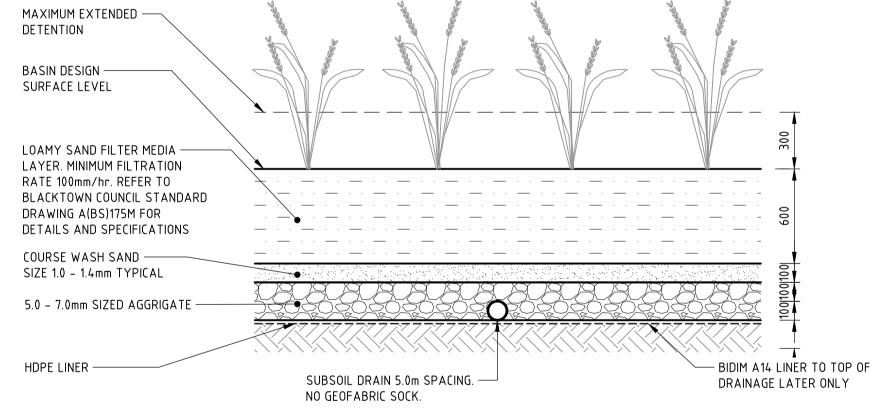

BIO-FILTRATION FILTER DETAIL

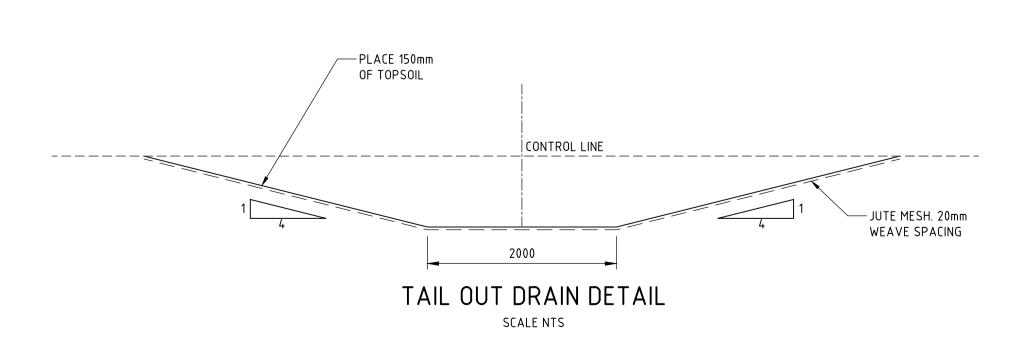

NOT FOR CONSTRUCTION

ISSUED VER'D APP'D DATE CLIENT REVISION DESCRIPTION 1 ISSUED FOR SSDA VC 2 ISSUED FOR REF APPROVAL JRG 3 ISSUED FOR DEVELOPMENT APPLICATION JRG 4 ISSUED FOR SSDA VC

TWL RL 39.30 ----

FILTRATION MEDIA.—

REFER DETAIL.

6 (MAX)

BIO-RETENTION -

BASE RL 39.00

SECTION (A)

SCALE 1:100



~ RIP RAP SCOUR PROTECTION.

> ALL DIMENSIONS TO BE VERIFIED ON SITE BEFORE COMMENCING WORK. NORTHROP ACCEPTS NO RESPONSIBILITY FOR THE USABILITY, COMPLETENESS OR SCALE OF DRAWINGS TRANSFERRED ELECTRONICALLY.
> THIS DRAWING MAY HAVE BEEN PREPARED USING COLOUR, AND MAY BE INCOMPLETE IF COPIED TO BLACK & WHITE

> > SCALE VARIES

– PRECINCT D RIPARIAN CORRIDOR

Sydney

JORDAN SPRINGS PRIMARY SCHOOL

DRAWING TITLE CIVIL ENGINEERING PACKAGE **DEVELOPMENT APPLICATION**

182535 DRAWING NUMBER REVISION

DRAWING SHEET SIZE = A1

J	APP	DATE	CLIENI	ARCHITECT
	JG	25.01.19	DICLIARD CROOKES	
	JG	06.02.19	RICHARD CROOKES	
	JG	13.02.19	CONSTRUCTIONS	G COUPGY/
	JG	31.05.19	CONSTRUCTIONS	
			DRAWING NOT TO BE USED FOR CONSTRUCTION UNLESS	THE COPYRIGHT OF THIS DRAWING REMAINS WITH
			VERIFICATION SIGNATURE HAS BEEN ADDED	NORTHROP CONSULTING ENGINEERS PTY LTD

- 1.52mm THICK REINFORCED FIRESTONE EPDM

THE BEDDING SURFACE IS ROUGH OR UNEVEN.

GEO-MAMBRANE APPLIED TO BASE AND SIDES OF FILTER AREA. GEO-MEMBRANE TO BE LAID ON TOP OF PREPARED

SURFACE COMPRISING OF A LAYER OF COURSE GRAVEL IF

TOP OF WEIR —

RL 39.40


Level 11 345 George Street, Sydney NSW 2000 Ph (02) 9241 4188 Fax (02) 9241 4324 Email sydney@northrop.com.au ABN 81 094 433 100

14-28 CULLEN AVENUE, **BIORETENTION BASIN JORDAN SPRINGS DETAILS - SHEET 01**

NOMINAL KERB FACE. NOTE PROPOSED -


LEVELS AT INVERT OF KERB U.N.O.


EXPANSION JOINTS @ MAX 12m CTRS / TOOL JOINTS @ MAX 3m CTRS ALL RADII TO BE 20mm U.N.O.

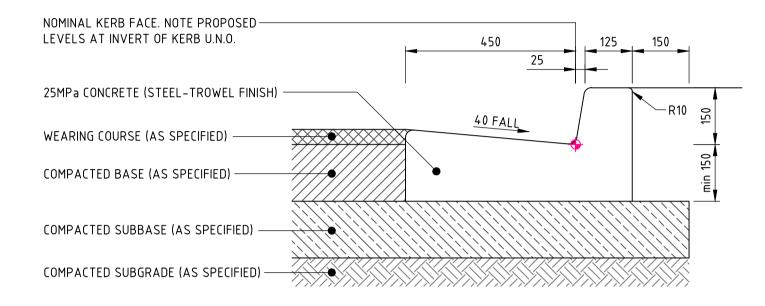


KERB & GUTTER 'KG' EXPANSION JOINTS @ MAX 12m CTRS / TOOL JOINTS @ MAX 3m CTRS ALL RADII TO BE 20mm U.N.O.

STANDARD DETAILS				
ANY DISCREPANCIES TO BE REPORTED IMMEDIATELY TO NORTHROP ENGINEERS FOR CLARIFICATION				
COUNCIL DETAILS	- BLACKTOWN CITY	' COUNCIL		
COMPONENT	DWG REFERENCE	DRAWING TITLE		
KERB AND GUTTER	A(BS) 101M	STD KERBS AND GUTTERS		
LAYBACK	A(BS) 102S	STANDARD RESIDENTIAL FOOTWAY AND LAYBACK CROSSING		
LAYBACK	A(BS) 103S	STD INDUSTRIAL & COMMERCIAL FOOTWAY CROSSINGS		
KERB RAMP	A(BS) 104M	PATH PAVING AT INTERSECTIONS AND KERB RAMP DETAILS		

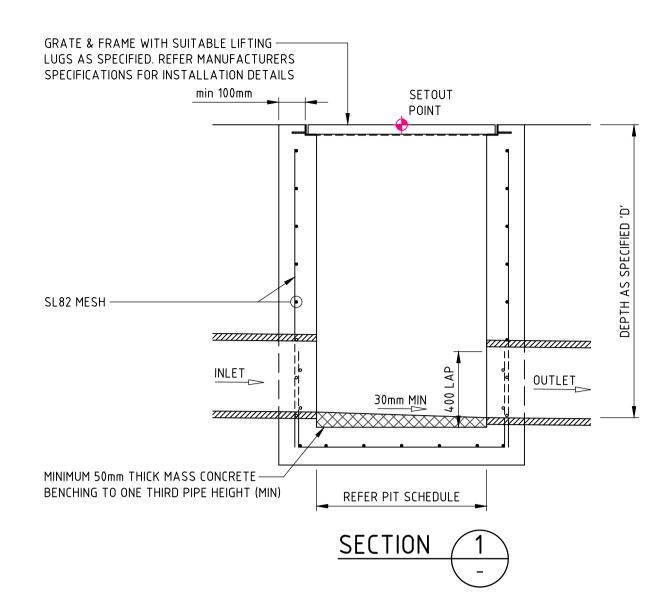

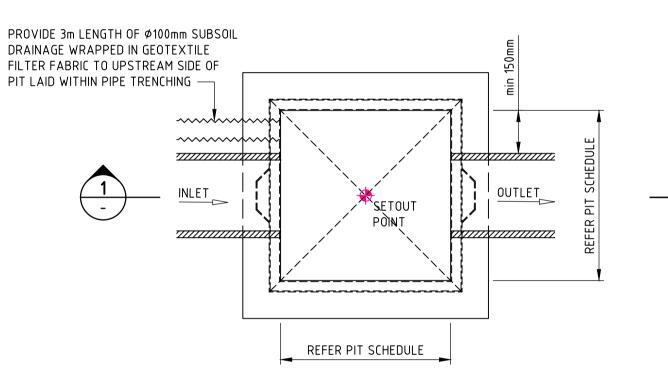

PLAN SURFACE INLET 'SIP' / JUNCTION PIT 'JP' PIT STRUCTURE TO BE 200mm THICK UNLESS SHOWN OTHERWISE. DRILL AND EPOXY PLASTIC PROPRIETARY STEP IRONS IN ACCORDANCE WITH AUSTRALIAN STANDARDS AND MANUFACTURERS SPECIFICATIONS (PITS > 1000mm DEPTH). REFER PIT INTERFACE DETAIL 'F' FOR CORNER REINFORCEMENT

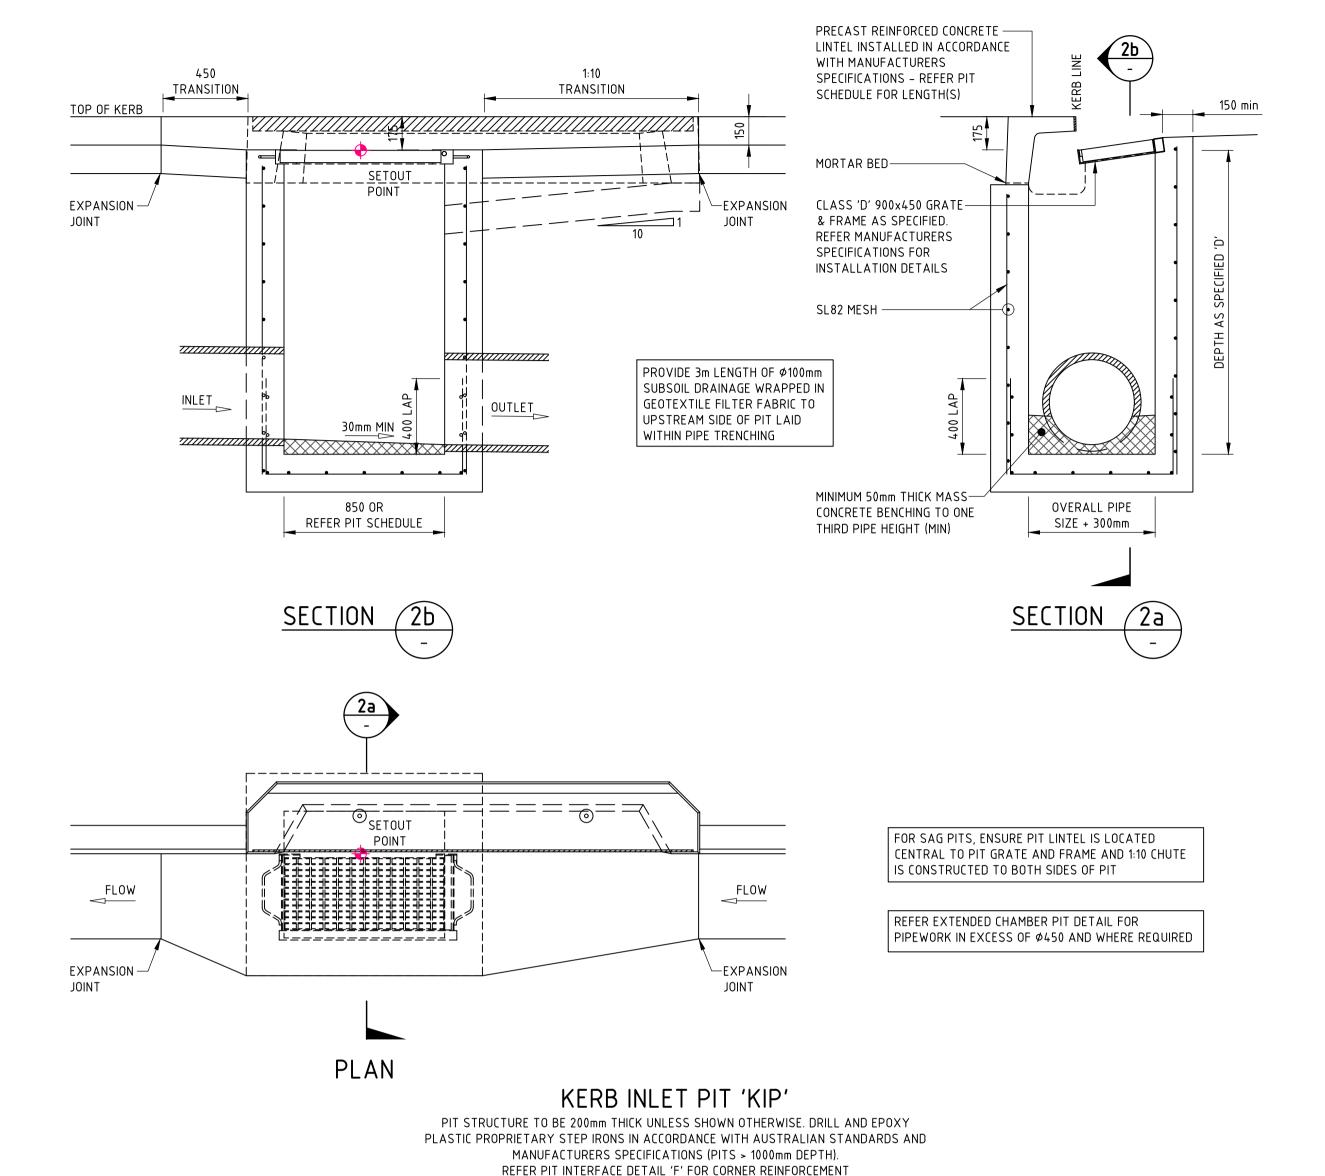

NOT FOR CONSTRUCTION

DESCRIPTION ISSUED VER'D APP'D DATE REVISION 1 ISSUED FOR SSDA JG 25.01.19 2 ISSUED FOR REF APPROVAL JRG JG 06.02.19 3 ISSUED FOR DEVELOPMENT APPLICATION JRG JG 13.02.19 4 ISSUED FOR SSDA JG 31.05.19

RICHARD CROOKES CONSTRUCTIONS DRAWING NOT TO BE USED FOR CONSTRUCTION UNLESS

VERIFICATION SIGNATURE HAS BEEN ADDED

ARCHITECT THE COPYRIGHT OF THIS DRAWING REMAINS WITH NORTHROP CONSULTING ENGINEERS PTY LTD

NORTHROP ACCEPTS NO RESPONSIBILITY FOR THE USABILITY, COMPLETENESS OR SCALE OF DRAWINGS TRANSFERRED ELECTRONICALLY. THIS DRAWING MAY HAVE BEEN PREPARED USING COLOUR,
AND MAY BE INCOMPLETE IF COPIED TO BLACK & WHITE

SCALE VARIES



JORDAN SPRINGS PRIMARY SCHOOL

DRAWING TITLE CIVIL ENGINEERING PACKAGE **DEVELOPMENT APPLICATION**

DETAILS - SHEET 01

182535 DRAWING NUMBER REVISION

DRAWING SHEET SIZE = A1

Level 11 345 George Street, Sydney NSW 2000 Ph (02) 9241 4188 Fax (02) 9241 4324 Email sydney@northrop.com.au ABN 81 094 433 100 14-28 CULLEN AVENUE, JORDAN SPRINGS



JORDAN SPRINGS PRIMARY SCHOOL SSDA LANDSCAPE SET

DRAWING SCHEDULE

L-0000	COVER SHEET
L-0001	SITE PLAN
L-1000	CENTRAL PLAY AREA
L-1001	UPPER PLAY AREA
L-1002	BUSH GARDEN - WESTERN BOUNDARY
L-5100	TREE PLANTING STRATEGY
L-5200	TREE SCHEDULE
L-5001	PLANTING SHCEDULES
L-5002	PLANTING SCHEDULES
L-6001	GENERAL SECTIONS PART 1
L-6002	GENERAL SECTIONS PART 2
L-6003	ELEVATION CULLEN AVE







SCALE

1:2000

DATE

31/05/2019



SSD

- School entry/drop off zone
- Accessible drop off & parking alongside garbage storage & service access.
- Pedestrian access & entry path.
- Gathering space with shade and seating.
- Outdoor seating/break out space.
- (6) Handball courts.
- Informal lawn.
- (8) Playground.
- (9)Nature play.
- (10) Food growing.
- Ramp to double slide.
- (12) Emergency access
- (13) Break out space adjacent to school hall/gym
- (14) Covered school entry.
- Outdoor learning areas.
- Bush garden/outdoor learning.
- Native planting to boundary.
- Defensible space (fire) which accomodates swale (stormwater runoff)
- Detention basin with vehicular access (19) (maintenance).









- Covered entry to school.
- Gathering place/plaza with shade and seating. Central deck at varying heights.
- Pergola slatted & vine-vine covered sections. Defined by trees in groundcovers.
- Feature trees.
- Turf area contrast to surrounding surfaces, contained internal play area.
- Break-out space seating & tables with shade trees in close proximity to canteen.
- Handball courts ball play areas.
- 8 Play area - multi play equipment
- Connection to other zones.
- Pedestrian connection (from staff carpark)







L-1000



© GROUP GSA

- Linking paths with seating and shade between activity zones.
- Internal turf area.
- Loop path defines upper playground space. Opportunity for educational markings along path e.g. measuring length.
- Play zone climbing and balance for gross motor skills. Ball toss or creative play - line markings.
- Mass planting areas with trees for shade & enclosure.
- Nature play zone focus on natural materials & elements.
- Sensory garden highlights textures, scent colour within garden.
- Food growing area Raised timber planters potting table, seating, small orchard & water tank.
- Double slide accessible play with rubber softfall. Play link to upper oval.
- Potential to store garden equipment under stairwell.







- Outdoor learning spaces decks.
- COLA Covered Outdoor Learning Area
- "Bush" meeting place/nature classroom. Utilise rocks or logs for seating in circle arrangement.
- Connect decks to pathways through space. Utilise installments in the environment: wind, solar, water gauge, temperature.
- 5 Dry creek bed.
- (6) Native vegetation highlight native indigenous plants.
- Mechanical plants to be screened using timber slats and vegetation. Allow for service access from landscaped area.
- Defensible Space (fire control tree canopy not to exceed 15% of total area.
- Additional fence to overland flow path.
- Area required overland flow. No obstacles or boulders to be placed with 5 meter setback from boundary.







Boundary Planting (Existing) Total: 38

Feature Trees- Native, evergreen (Large) Includes endemic trees (20m+) Total: 30 8 No. Euc. crebra 7 No. Euc. moluccana

7 No. Euc. punctata 8 No. Corymbia maculata

Feature Tree: Native, evergreen (Medium) Includes endemic trees (15m) Total: 25 No. Corymbia eximia

Feature tree: Lagerstroemia 'Natchez' Total: 19

Feature tree: Pyrus ussuriensis Total: 15

Feature tree: Fraxinus ' Urbanite' Total: 17

Feature tree - Ulmus parvifolia 7 to street, 10 in site

> Native garden Total: 26 Endemic trees with a mature size of 20m plus Includes: 3 No. Euc. crebra 4 No. Corymbia maculata









NUMBER REVISION В L-5100

DATE 31/05/2019

SCALE 1:1000@A3



SSD

FEATURE TREES - NATIVE EVERGREEN









FEATURE TREES - DECIDUOUS







BUSH GARDEN - CANOPY















BOUNDARY PLANTING BOTANIC NAME COMMON NAME MATURE SIZE (NATIVE (N) ENDEMIC (E) Dodonaea viscosa Hop Bush 4 x 3 N Eucalyptus species Various Varies N Bursaria spinosa Sweet Bursaria 3 x 2 E			
BOTANIC NAME	COMMON NAME		
Dodonaea viscosa	Hop Bush	4 x 3	N
Eucalyptus species	Various	Varies	N
Bursaria spinosa	Sweet Bursaria	3 x 2	Е
Callistemon "Endeavour"	Bottlebrush	3 x 3	N
Melaleuca decora	White Feather Honey Myrtle	6 x 4	Е
Melaleuca linariifolia	Swamp paperbark	9 x 5	N

FEATURE TREES Native, Evergreen

BOTANIC NAME	COMMON NAME	MATURE SIZE (H x W) m	NATIVE (N) ENDEMIC (E)
Corymbia eximia	Yellow Bloodwood	15 x 7	Е
Corymbia eximia "nana"	Dwarf Yellow Bloodwood	8 x 4	N
Corymbia maculata	Spotted gum	25 x 10	Е
Corymbia ficifolia grafted	Dwarf grafted Eucalypt	6 x 5	N
Callistemon salignus	White Bottlebrush	7 x 4	N
Eucalyptus crebra	Narrow leaved ironbark	25m +	E
Eucalyptus molucanna	Grey Box	25m +	Е
Eucalyptus parramattensis	Parramatta Red Gum	10 x 7	E
Eucalyptus punctata	Grey Gum	20 x 8	Е

FEATURE TREES Deciduous

BOTANIC NAME	COMMON NAME	MATURE SIZE (H x W) m	NATIVE (N) ENDEMIC (E)
Fraxinus "Urbanite"	Ash	15 x 8	
Lagerstroemia "Natchez"	Crepe Myrtle white flowering	6 x 6	
Pyrus ussuriensis	Manchurian Pear	14 x 12	
Ulmus parvifolia	Chinese Elm "Todd"	10 x 11	



DRAWING

NUMBER

L-5200



SSD

DECIDUOUS TREES











NATIVE TREES













NATIVE SHRUBS















NATIVE GRASSES & GROUNDCOVERS

















JORDAN SPRINGS

© GROUP GSA

BOTANIC NAME	COMMON NAME	INSTALLATION SIZE	MATURE SIZE (H x W) m	
CENTRAL PLAY SPACES				
DECIDUOUS TREES				
Jacaranda mimosifolia	Jacaranda	400 L†	15 x 15	
Lagerstroemia indica	Crepe Myrtle	200L	8 x 6	
Pyrus calleryana "Chanticleer"	Chanticleer Ornamental Pear	100 L	10 x 7	
Pyrus ussuriensis	Ornamental Pear	100 L	12 x 8	
NATIVE TREES				SPACING (mm)
Banksia Integrifolia	Coastal Banksia	45L	7 x 4	As shown
Callistemon viminalis	Weeping bottlebrush	45L	8 x 5	As shown
Melaleuca decora	White Feather Honey Myrtle	45L	6 x 4	As shown
Melaleuca ericifolia	Swamp paperbark	45L	9 x 5	As shown
Melaleuca linariifolia	Snow in Summer	45L	10 x 4	As shown
Tristaniopsis laurina "Luscious"	Water Gum	45L	12 x 5	As shown
NATIVE SHRUBS				SPACING (mm)
Banksia ericifolia	Heath Banksia	25 L	2 x 2	1200
Callistemon 'Captain Cook'	Dwarf Red Bottlebrush	25 L	1.5 x 1.5	800
Calothamnus quadrifus	Net Bush	200mm	1.5 x 2.0	1000
Hibbertia diffusa	Wedge Guinea Flower	140mm	0.4 x 0.6	400
Leptospermum "Little Bun"	Dwarf Tea tree	200mm	2 x 1.5	600
Melaleuca "Claret Tops"	Honey Myrtle	200mm	1.0 x 0.8	600
Plectranthus argentatus	Silver spur	200mm	1 x 1	700
Philotheca "Profusion"	Eriostemon	200mm	1.5 x 1.5	800
Pimelea nivea	Cotton bush	140mm	0.6 x 2	1000
Prostanthera sieberi	Native Mint Bush	140mm	1 x 1.5	1000
Westringia fruticosa	Native Rosemary	200mm	1.5 x 1.5	600
NATIVE GRASSES & GROUNDCOVERS				SPACING (mm)
Carex apressa	Tall sedge	150mm	0.8 x 0.6	300
Carpobrotus glaucescens	Pigface	150mm	0.3 x 1.5	800
Chrusocephalum apiculatum	Yellow Buttons	150mm	0.3 x 0.5	400
Cissus antarctica	Kangaroo vine	150mm	0.5 x 1.5	600
Dianella 'Little Jess'	Little Jess Dianella	150mm	0.4 x 0.4	300
Lomandra longafolia 'Tanika'	Lomandra Tanika	150mm	0.5 x 0.5	400
Pennisetum Nafray	Fountain Grass	150mm	0.6 x 0.6	400
Pennisetum "Penstripe"	Fountain Grass	150mm	0.45 x 0.45	400
Pennisetum "Rubrum"	Fountain Grass	150mm	1 x 1	600
Poa labillardieri "Eskdale"	Tussock grass	150mm	1 x 0.5	500
Isolepis nodosa	Knobby Club Rush	150mm	1 x 0.5	300

BOTANIC NAME	COMMON NAME	INSTALLATION SIZE	MATURE SIZE (H x W) m	
FOOD GROWING AREA				
TREES				
Aloysia triphylla	Lemon Verbena	45L	3.0 x 3.0	
Citrus hystrix	Kaffir Lime	45L	3.0 x 3.0	
Dwarf citrus	Dwarf Lemon	45L	1.5 x 1.0	
Olea species	Fruiting Olive	45L	8.0 x 3.0	
Syzygium species	Lilly Pilly	45L	2.0 x 1.0	
SHRUBS & GROUNDCOVERS				SPACING (mm)
Brassica species	Kale	150mm	0.45 x 0.45	300
Helichrysum italicum	Curry Plant	200mm	0.8 x 0.5	400
Melissa offinalis	Lemon Balm	200mm	0.5 x 0.75	500
Ocimum basilicum	Basil	150mm	0.4 x 0.4	300
Origanum vulgare	Oregano	150mm	0.3 x 0.3	300
Rosmarinus officinalis	Rosemary	200L	1.5 x 1.5	400
Salvia elegans	Pineapple Sage	200mm	1.2 x 0.9	600
Salvia officinalis	Sage	150mm	0.3 x 0.3	400
Thymus	Thyme	150mm	0.4 x 0.4	400
Tropaeolum species	Nasturtium	150mm	0.3 x 0.8	400
Tulbaghia violaceae	Society Garlic	150mm	0.3 x 0.3	300





| NUMBER | REVISION | DATE | SCALE

INSTALLATION MATURE SIZE

75 Lt

200L

100 Lt

75 Lt

45 L†

150mm

150mm

150mm

150mm

200mm

200mm

200mm

25 It

200mm

200mm

200mm

200mm

200mm

200L

150mm

200mm

150mm

150mm

150mm

(H x W) m

8 x 4

12 x 10

4 x 2.5

10 x 6

3.0 x 3.0

0.3 x 0.6

0.3 x 1.0

0.5 x 1.5

0.8 x 0.5

1.0 x 1.0

1.5 x 0.8

0.8 x 1.0

1.0 x 1.0

4 x 2.5

0.8 x 0.6

0.5 x 0.5

0.5 x 0.75

0.8 x 1.0

1.5 x 1.5

 0.3×0.3

0.6 x 0.6

0.3 x 0.5

0.4 x 0.4

0.3 x 0.3

(mm) 300

400

500

300

600 700

400

600

1000

400

400 500

600

400

400

300

300

400

300

COMMON NAME

She-oak

Magnolia

Paperbark

Crepe Myrtle

Lilac cultivar

Bugle weed

Cosmos

Kangaroo vine

African daisy

Liquorice plant

Gardenia

Lavander

Statice

Paperbark

Rosemary

Stonecrop

Lambs Ears

Society Garlic

Sage

Thyme

Lemon Balm

Everlasting paper daisy

Lemon scented Tea tree

Lemon scented geranium

\mathcal{I}

	SSD
	JORDAN SPRINGS
)	© GROUP GSA

BOTANIC NAME

TREES

SENSORY GARDEN

Allocasuarina species

Lagerstroemia indica

Magnolia Little Gem

SHRUBS & GROUNDCOVERS

Chrysocephalum apiculatum

Dimorphotheca pluvialis

Leptospermum petersonii

Melaleuca incana "Velvet Cushions"

Melaleuca species

Syringa vulgaris

Ajuga reptans

Cissus antarctica

Gardenia species

Helichrysum species

Lavandula species

Limonium perezii

Melissa offinalis

Salvia species

Thymus

Sedum spectabilis

Stachys byzantina

Tulbaghia violaceae

Pelargonium citrosum

Rosmarinus officinalis

Cosmos species



01 SECTION 1 - A



01 SECTION 1 - B





DRAWING **GENERAL SECTIONS 1** NUMBER REVISION L-6001

DATE

SCALE 1:200

SSD JORDAN SPRINGS © GROUP GSA









DRAWING GENERAL SECTIONS 2

NUMBER REVISION L-6002

DATE 31/05/2019 SCALE 1:200



