



SCHOOL INFRASTRUCTURE
NSW




HUNTER RIVER HIGH
SCHOOL

36 ELKIN AVENUE,
HEATHERBRAE NSW
2324

ISSUE FOR SCHEMATIC DESIGN - REF01
2024.05.02





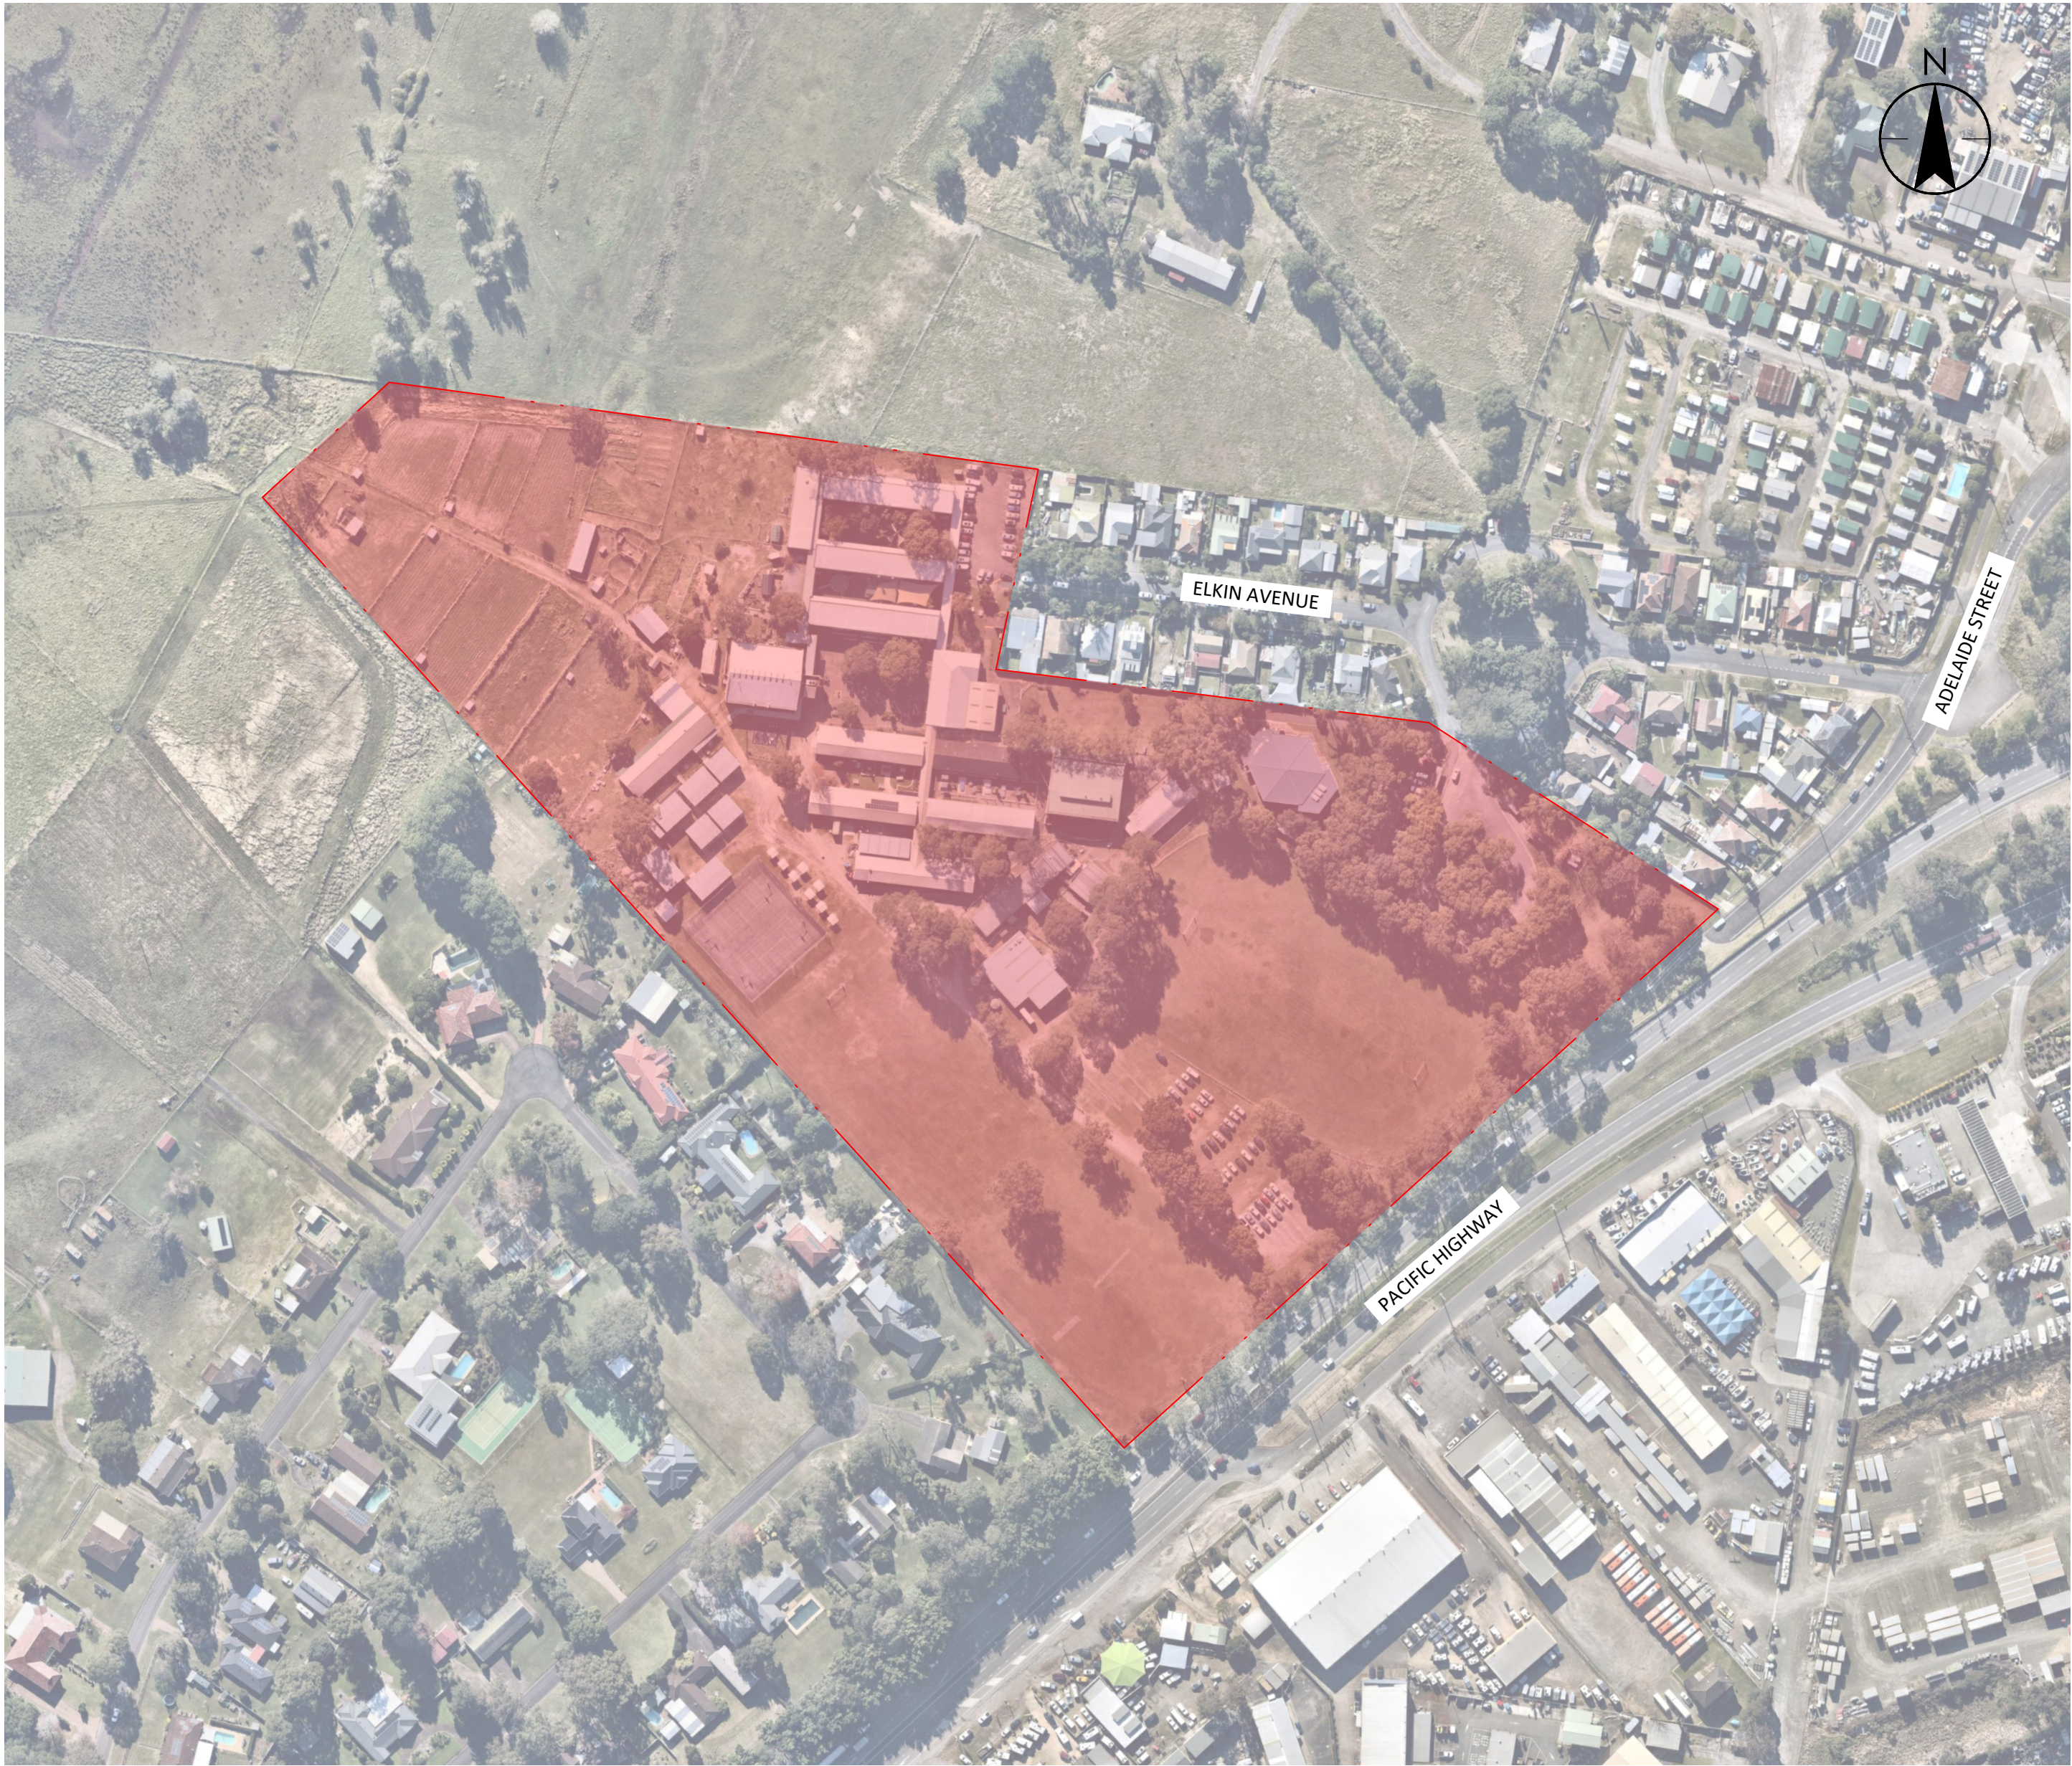




Stantec Project Number: 301350909



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HRHS-STNC-XX-XX-DR-C-007001	GENERAL NOTES	C	2024.05.02
HRHS-STNC-XX-XX-DR-C-050001	EXISTING CONDITIONS PLAN	C	2024.05.02
HRHS-STNC-XX-XX-DR-C-055001	DEMOLITION PLAN	C	2024.05.02
HRHS-STNC-XX-XX-DR-C-060001	GENERAL ARRANGEMENT PLAN - SITE WIDE	C	2024.05.02
HRHS-STNC-XX-XX-DR-C-060101	SITEWORKS PLAN - SHEET 1	C	2024.05.02
HRHS-STNC-XX-XX-DR-C-060102	SITEWORKS PLAN - SHEET 2	C	2024.05.02
HRHS-STNC-XX-XX-DR-C-060103	SITEWORKS PLAN- SHEET 3	C	2024.05.02
HRHS-STNC-XX-XX-DR-C-070001	EROSION AND SEDIMENT CONTROL - PLAN	C	2024.05.02
HRHS-STNC-XX-XX-DR-C-076001	EROSION AND SEDIMENT CONTROL - DETAILS	C	2024.05.02
HRHS-STNC-XX-XX-DR-C-100001	BULK EARTHWORKS PLAN	C	2024.05.02
HRHS-STNC-XX-XX-DR-C-403001	ROADS TYPICAL SECTIONS	C	2024.05.02
HRHS-STNC-XX-XX-DR-C-406001	ROADS DETAILS - SHEET 1	C	2024.05.02
HRHS-STNC-XX-XX-DR-C-406002	ROADS DETAILS - SHEET 2	C	2024.05.02
HRHS-STNC-XX-XX-DR-C-406003	ROADS DETAILS - SHEET 3	C	2024.05.02
HRHS-STNC-XX-XX-DR-C-440101	PAVEMENT PLAN - SHEET 1	C	2024.05.02
HRHS-STNC-XX-XX-DR-C-440102	PAVEMENT PLAN - SHEET 2	C	2024.05.02
HRHS-STNC-XX-XX-DR-C-440103	PAVEMENT PLAN - SHEET 3	C	2024.05.02
HRHS-STNC-XX-XX-DR-C-500001	STORMWATER DRAINAGE CATCHMENT PLAN	C	2024.05.02
HRHS-STNC-XX-XX-DR-C-520001	STORMWATER DRAINAGE PLAN - SITE WIDE	C	2024.05.02
HRHS-STNC-XX-XX-DR-C-520101	STORMWATER DRAINAGE PLAN - SHEET 1	C	2024.05.02
HRHS-STNC-XX-XX-DR-C-520102	STORMWATER DRAINAGE PLAN - SHEET 2	C	2024.05.02
HRHS-STNC-XX-XX-DR-C-520103	STORMWATER DRAINAGE PLAN - SHEET 3	C	2024.05.02
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HRHS-STNC-XX-XX-DR-C-526003	STORMWATER DRAINAGE DETAILS - SHEET 3	C	2024.05.02
HRHS-STNC-XX-XX-DR-C-526004	STORMWATER DRAINAGE DETAILS - SHEET 4	C	2024.05.02
HRHS-STNC-XX-XX-DR-C-527001	STORMWATER DRAINAGE PIT SCHEDULE	C	2024.05.02





LEGEND

	SITE BOUNDARY
	EXISTING BUILDINGS
	PROPOSED AREA APPROVED UNDER APPLICATION NUMBER 16-2023-239-1.
	PROPOSED BUILDINGS
	EXISTING TELSTRA
	EXISTING ELECTRICAL
	EXISTING WATER
	EXISTING GAS
	EXISTING SEWER

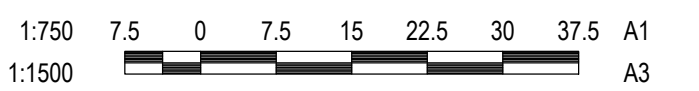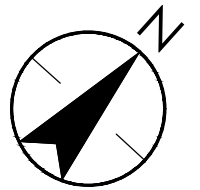

Notes

Issue Status

PRELIMINARY
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SINSW

HUNTER RIVER HIGH SCHOOL

HEATHERBRAE NSW 2324

File Name: HRHS-STNC-XX-XX-DR-C-050001.DWG

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JMB

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2024

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drawing

No.

Title



EXISTING CONDITIONS PLAN

Project No.
301350957


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Revision
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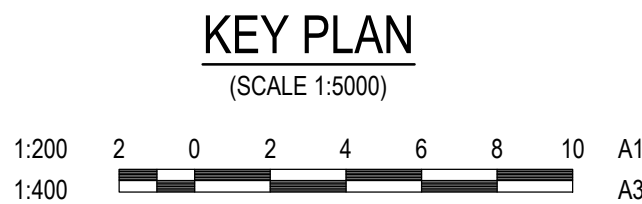
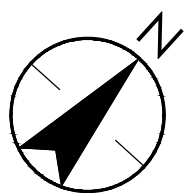
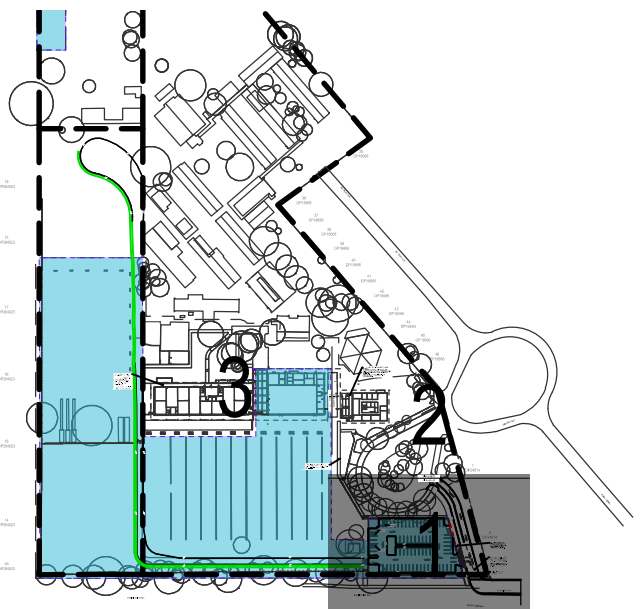
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HRHS-STNC-XX-XX-DR-C-050001



Title	
DEMOLITION PLAN	
Project No.	Scale
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Revision	Drawing No.
c	HRHS-STNC-XX-XX-DR-C-055001

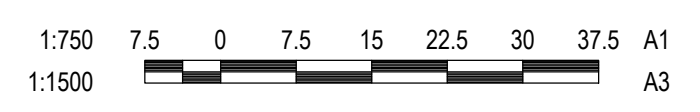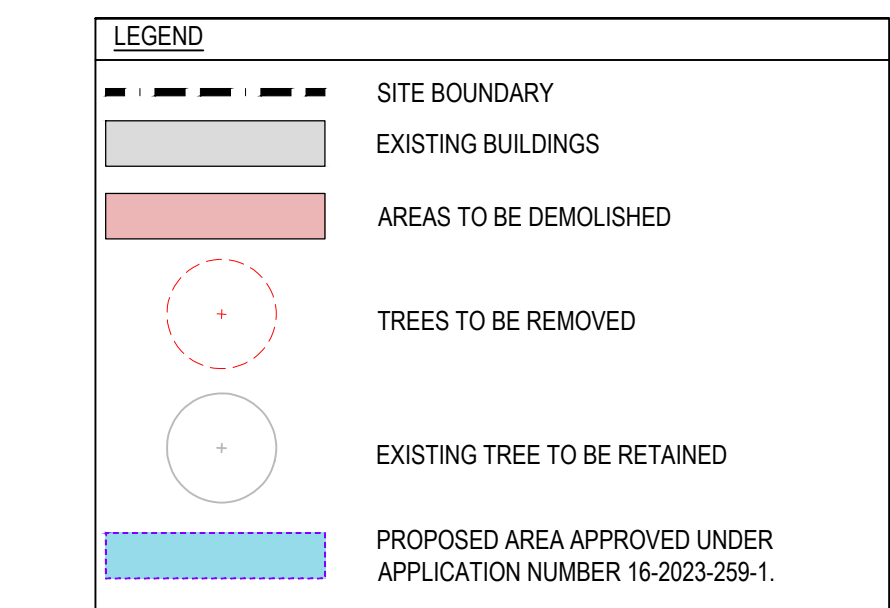

LEGEND	
	SITE BOUNDARY
	EXISTING BUILDING
	PROPOSED BUILDING
	DA PLANNING EXTENTS
	LANDSCAPE
	SPORTS FIELD
	PROPOSED PAVEMENT. REFER PAVEMENT PLAN
	PROPOSED SURFACE LEVELS
	EXISTING CONTOURS
	ROLLED KERB
	KERB ONLY
	FLUSH KERB
	DISH DRAIN
	PROPOSED GRATED DRAIN
	RAINWATER TANK
	STORM CHAMBER
	SPEL HYDROSYSTEM
	GRASSED TABLE DRAIN
	PROPOSED JUNCTION PIT
	EXISTING JUNCTION PIT
	PROPOSED GRATED PIT
	EXISTING GRATED PIT
	PROPOSED KERB INLET PIT
	EXISTING KERB INLET PIT
	PROPOSED TREE. REFER LANDSCAPE ARCHITECT.
	EXISTING TREE TO REMAIN
	EXISTING TREE TO BE REMOVED
	PROPOSED SWALE

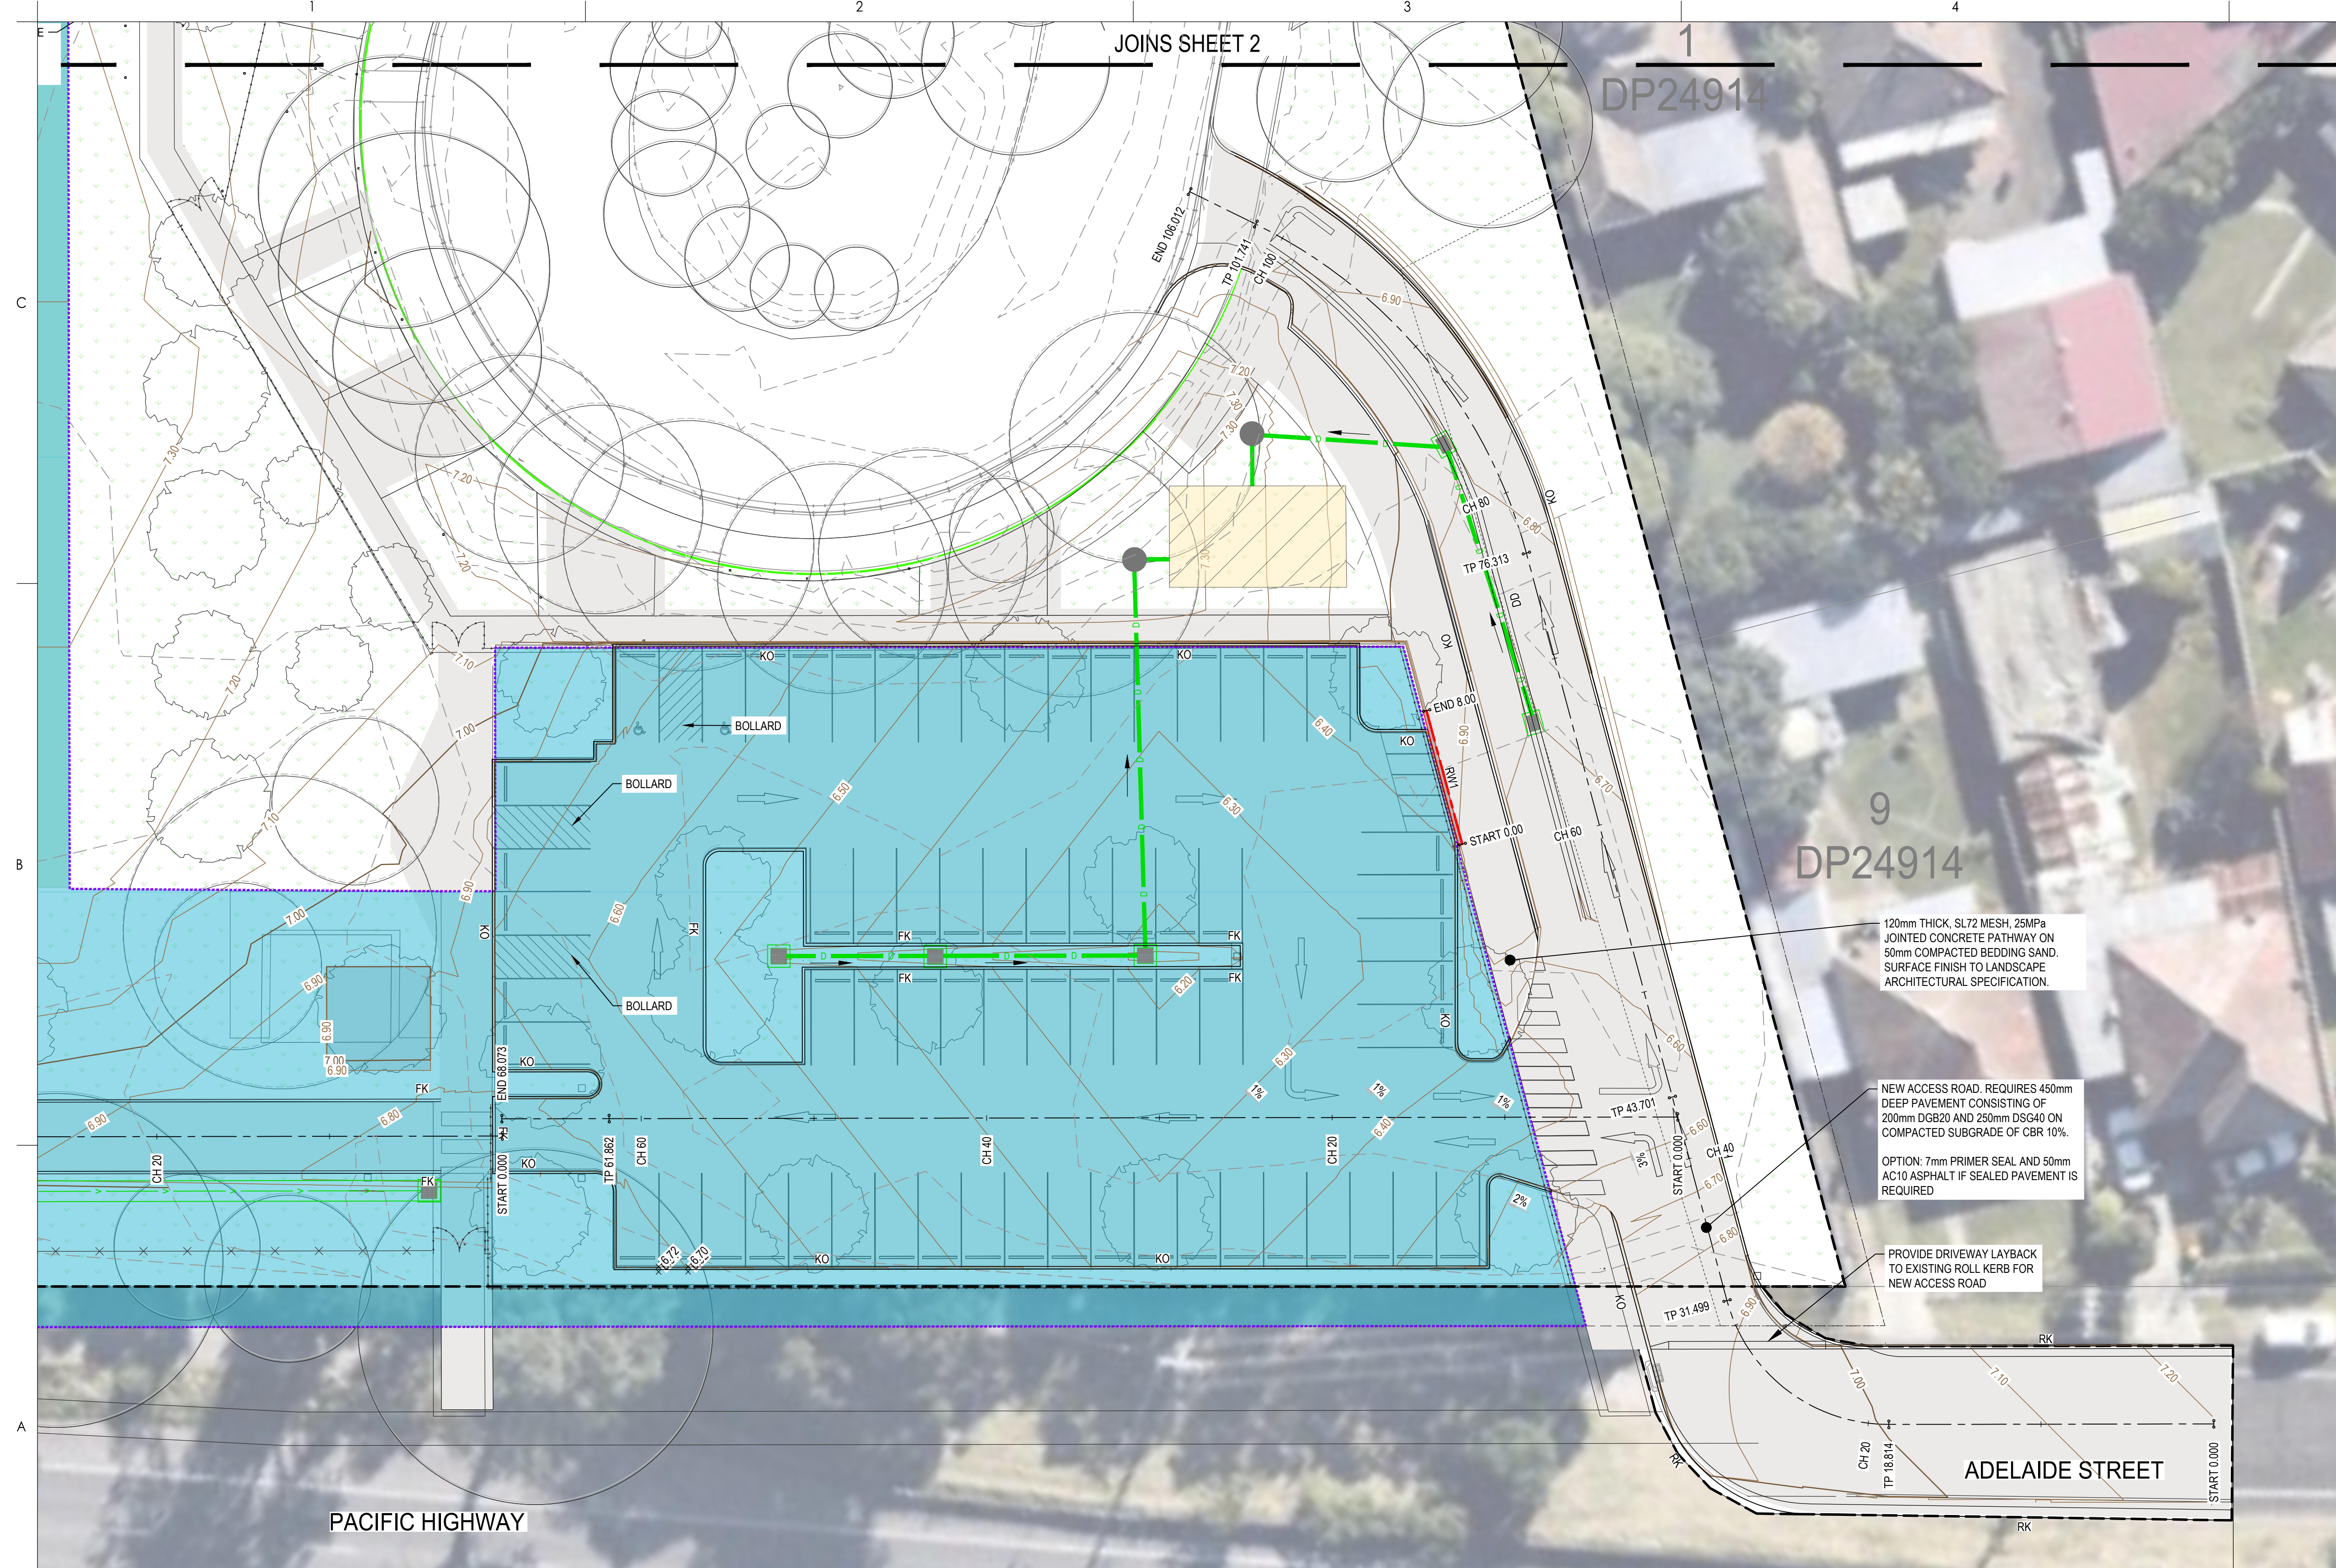

Notes

C	ISSUE FOR SCHEMATIC DESIGN - REF 01	HAL	JMB	2024.05.02
B	ISSUE FOR SCHEMATIC DESIGN - REF 01	HAL	JMB	2024.04.17
A	ISSUE FOR SCHEMATIC DESIGN - REF 01	MK	JMB	2024.04.04

Issued/Revision

By

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Notes

Client/Project Logo

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Level 6, Building B
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St Leonards, NSW 2045
Tel: +61 2 8484 7000

The APP Group

Client/Project

SINSW

HUNTER RIVER HIGH SCHOOL

HEATHERBRAE NSW 2324

File Name: HRHS-STNC-XX-XX-DR-C-060101.DWG

CPO

JMB

JMB

2024.04.04

Dwn.

Dign.

Chkd.

YYYY.MM.DD

Title

SITWORKS PLAN - SHEET 1



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Revision c






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1:200 2 0 2 4 6 8 10 A1
1:400 A3

Revision: C Drawing No. HRHS-STNC-XX-XX-DR-C-060103



NOTES

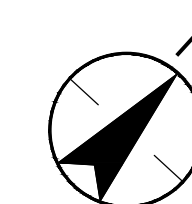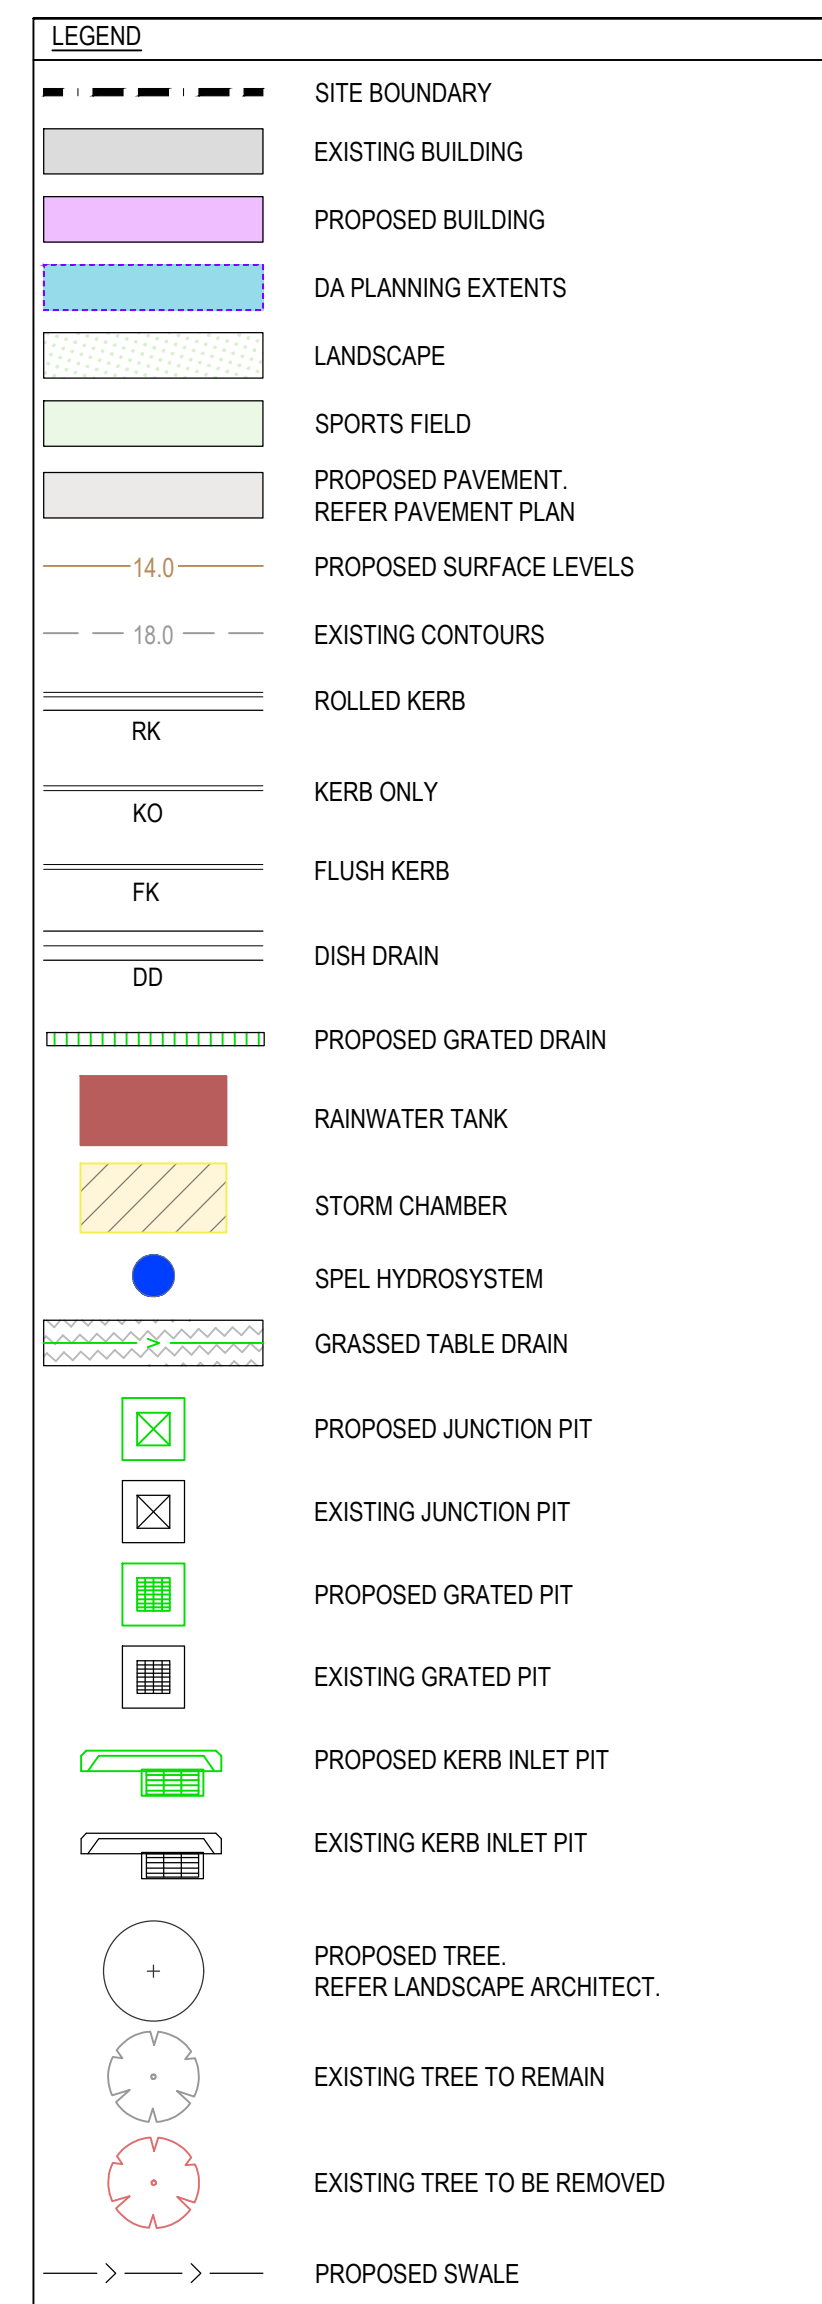1. THIS PLAN IS TO BE READ IN CONJUNCTION WITH OTHER ENGINEERING PLANS AND ANY WRITTEN INSTRUCTIONS THAT MAY BE ISSUED.
2. THE CONTRACTOR SHALL IMPLEMENT ALL SOIL EROSION AND SEDIMENT CONTROL MEASURES PRIOR TO DISTURBANCE OF THE RELATED CATCHMENT AREA AND TO THE STANDARD OF MANAGING URBAN STORMWATER, SOIL & CONSTRUCTION & COUNCIL SPECIFICATIONS.
3. ALL SUBCONTRACTORS SHALL BE INFORMED OF THEIR RESPONSIBILITIES IN MINIMISING THE POTENTIAL FOR SOIL EROSION AND POLLUTION TO DOWN SLOPE AREAS.
4. LAND DISTURBANCE SHALL BE LIMITED TO THAT NECESSARY FOR IMPLEMENTATION OF THE PLANS OF WORKS. BUFFER ZONES AND LAND NOT TO BE DISTURBED SHALL BE CLEARLY MARKED WITH BARRIER FENCE. 'SILT' FENCE FOR STRAW BALE SEDIMENT TRAPS SHALL BE PLACED AT REGULAR INTERVALS IMMEDIATELY DOWNSLOPE OF ALL UNPROTECTED DISTURBED LANDS.
5. THE LOCATION OF 'SILT' FENCES, BARRIER FENCES, SEDIMENT TRAPS AND OTHER DEVICES ARE INDICATIVE ONLY AND FINAL LOCATIONS ARE TO BE DECIDED ON SITE. VARIATIONS WILL BE PERMITTED TO BEST SUIT THE CIRCUMSTANCES. CONTRACTOR TO PREPARE DETAILED CONSTRUCTION SEDIMENT AND EROSION CONTROL PLAN.
6. ALL SOIL EROSION AND SEDIMENT CONTROL STRUCTURES SHALL BE INSPECTED FOLLOWING EACH STORM EVENT AND ANY NECESSARY MAINTENANCE WORK SHALL BE UNDERTAKEN TO ENSURE THEIR CONTINUED PROPER OPERATION. SEDIMENT SHALL BE REMOVED FROM THE SOIL EROSION & SEDIMENT CONTROL STRUCTURES WHEN
7. NO MORE THAN 40% CAPACITY HAS BEEN REACHED. THESE STRUCTURES SHALL CONTINUE IN PROPER OPERATION UNTIL ALL DEVELOPMENT ACTIVITIES HAVE BEEN COMPLETED AND THE SITE FULLY ESTABLISHED.
8. WHERE THE AREA IS TO BE DISTURB CONTAINS TREES TO REMAIN, AN ARBORIST CONSULTANT SHOULD PROVIDE ADVICE ON PROCEDURES AND MEASURES TO BE PLACED.
9. TEMPORARY REHABILITATION SHALL BE UNDERTAKEN WITHIN 14 WORKING DAYS BEFORE EITHER WORKS CONTINUE OR PERMANENT REHABILITATION IS UNDERTAKEN.
10. ALL OF THE SOIL STORAGE, REVEGETATION AND SEDIMENT AND EROSION CONTROL MANAGEMENT DEVICES/MEASURES SHALL BE IMPLEMENTED TO NSW ENVIRONMENT PROTECTION AUTHORITY (EPA) AND DEPARTMENT OF LAND AND WATER REQUIREMENTS.
11. ALL SEDIMENT AND EROSION CONTROL MANAGEMENT MEASURES/DEVICES SHOWN ON THE PLANS SHALL BE IMPLEMENTED PRIOR TO CONSTRUCTION, AND MAINTAINED DURING AND AFTER.

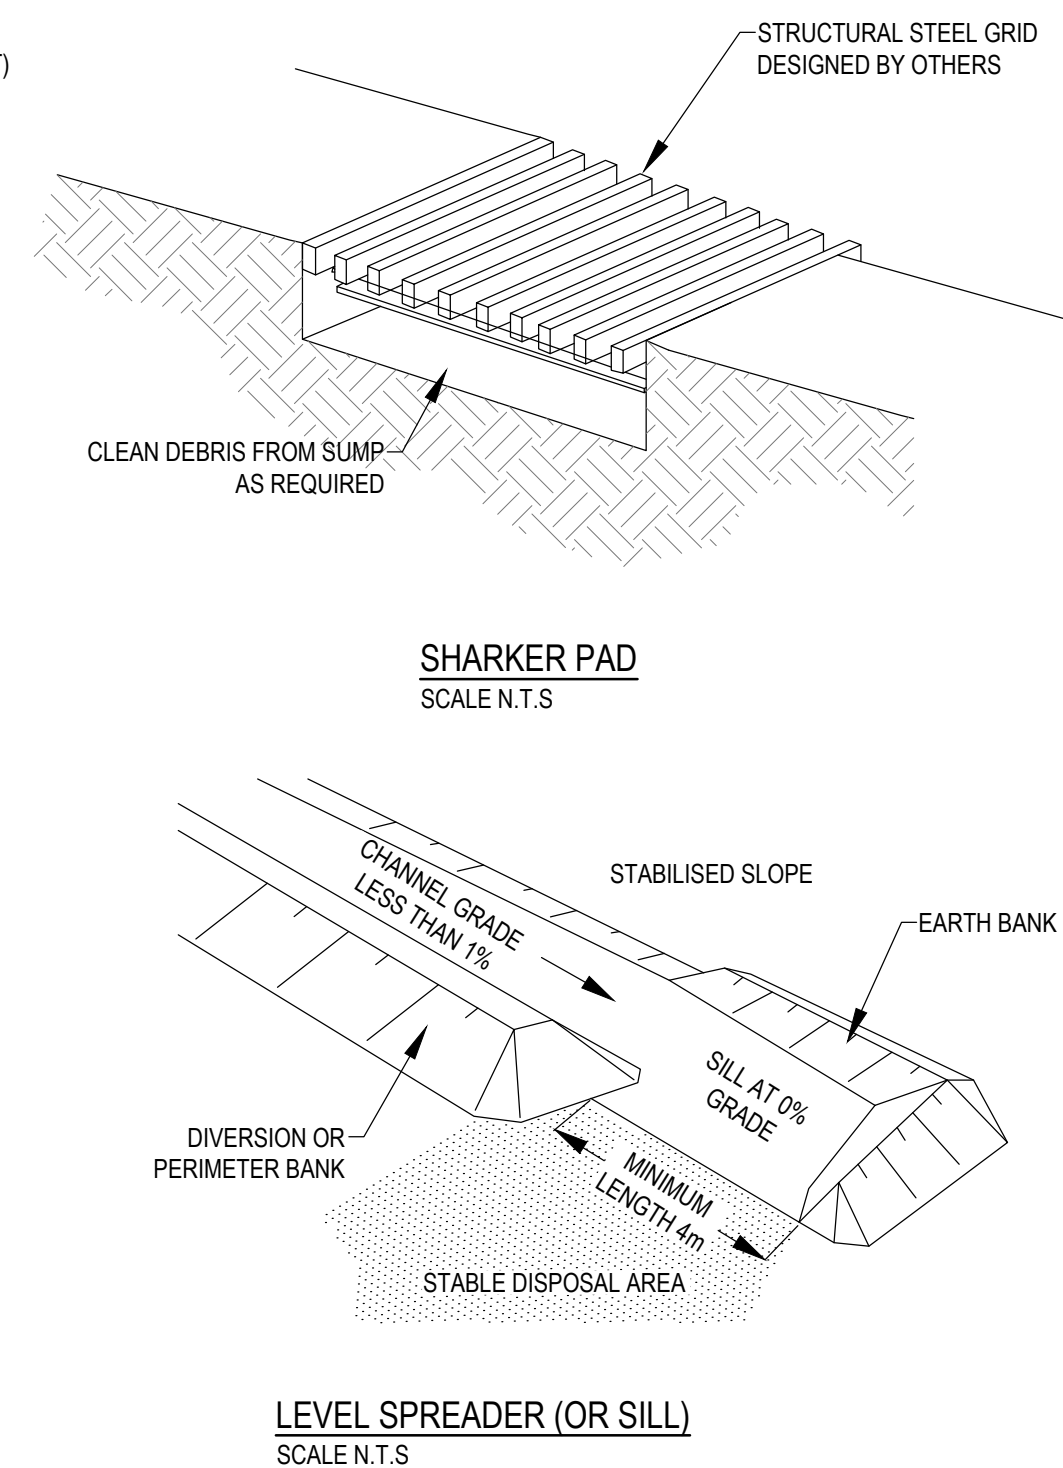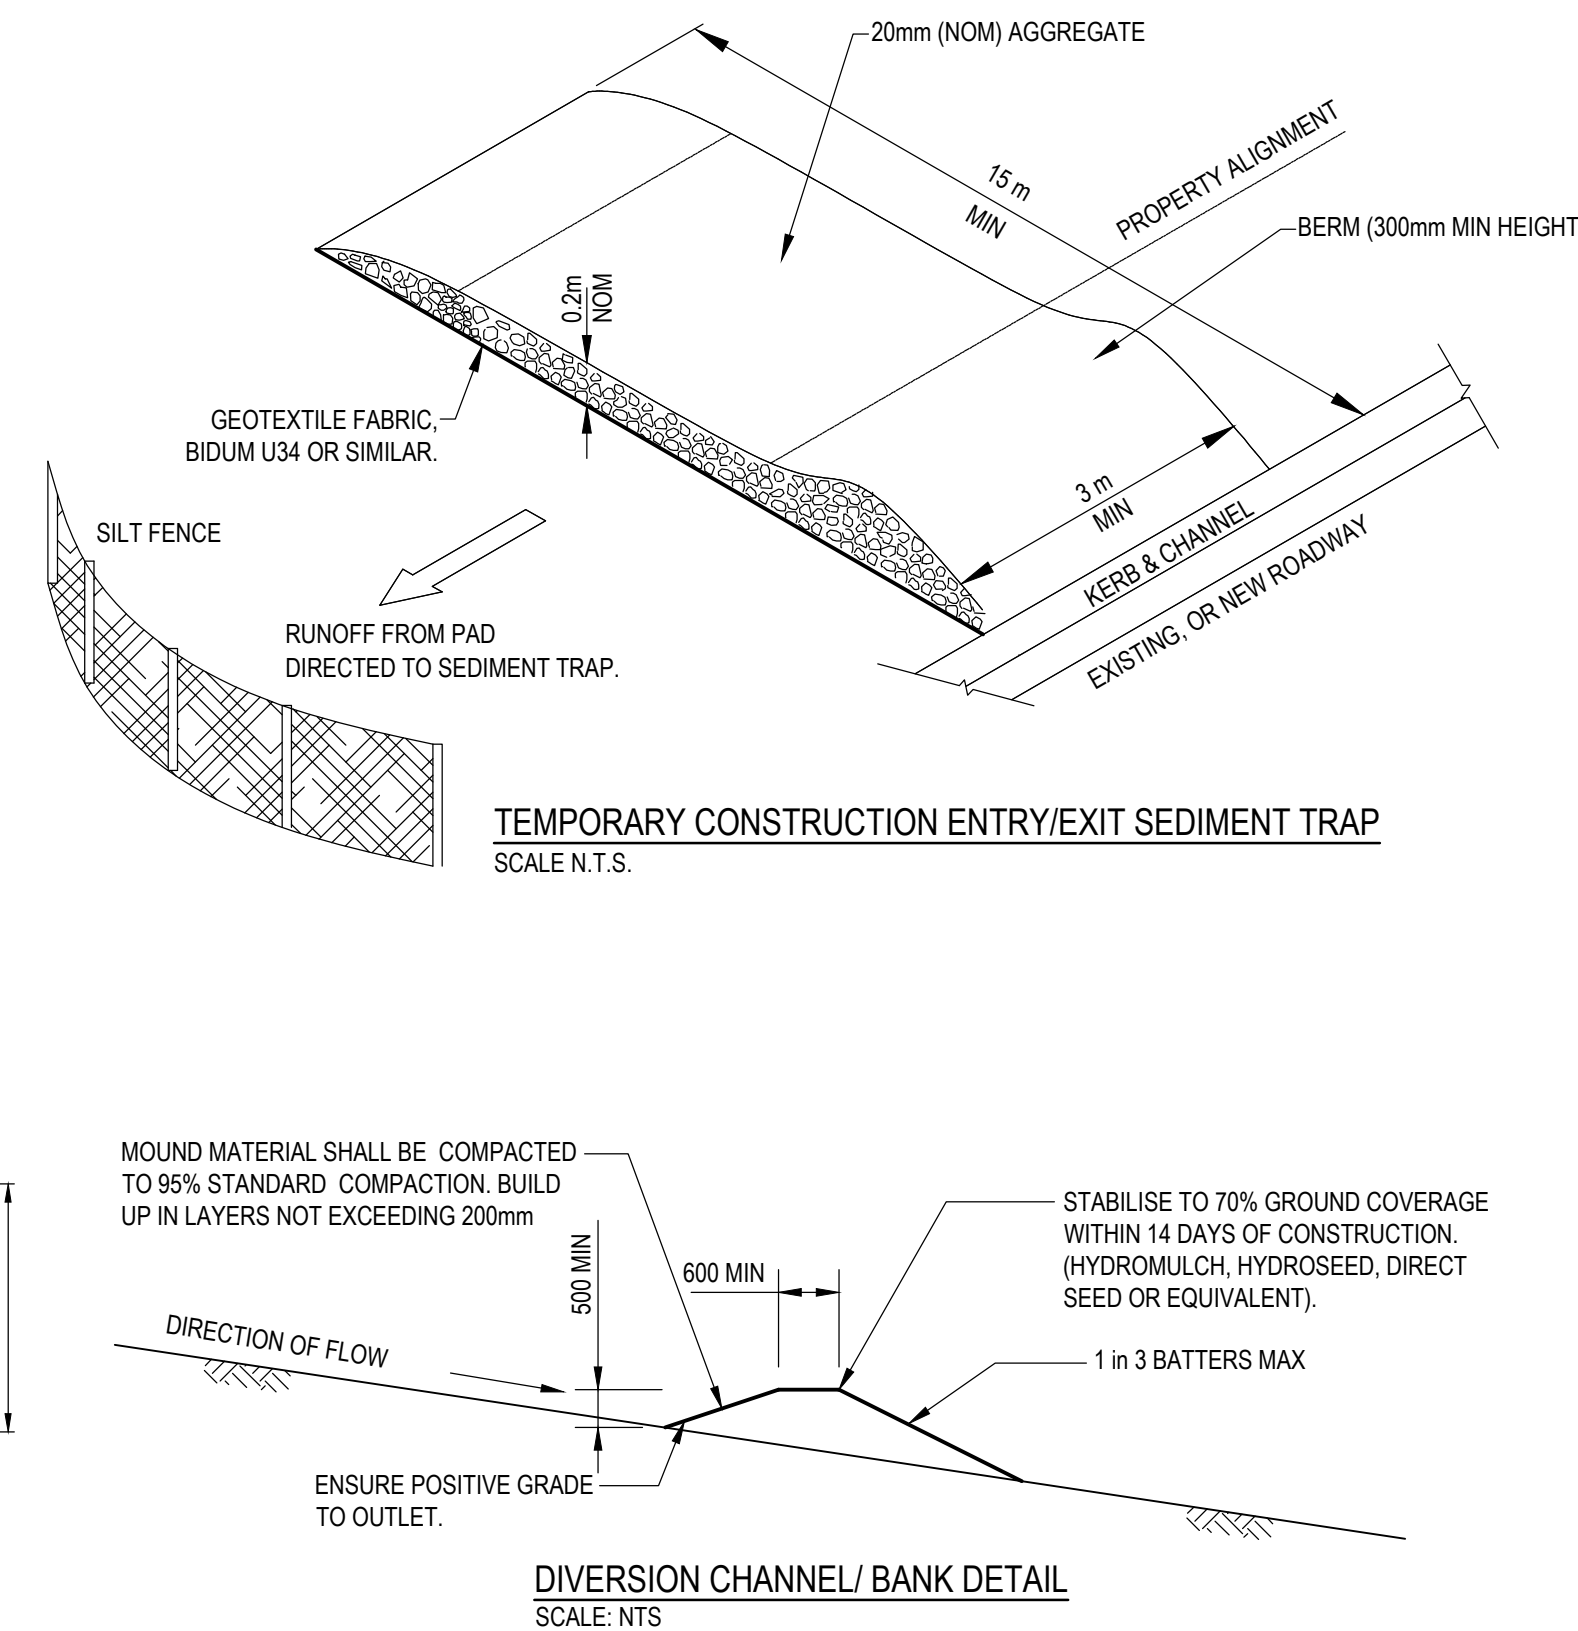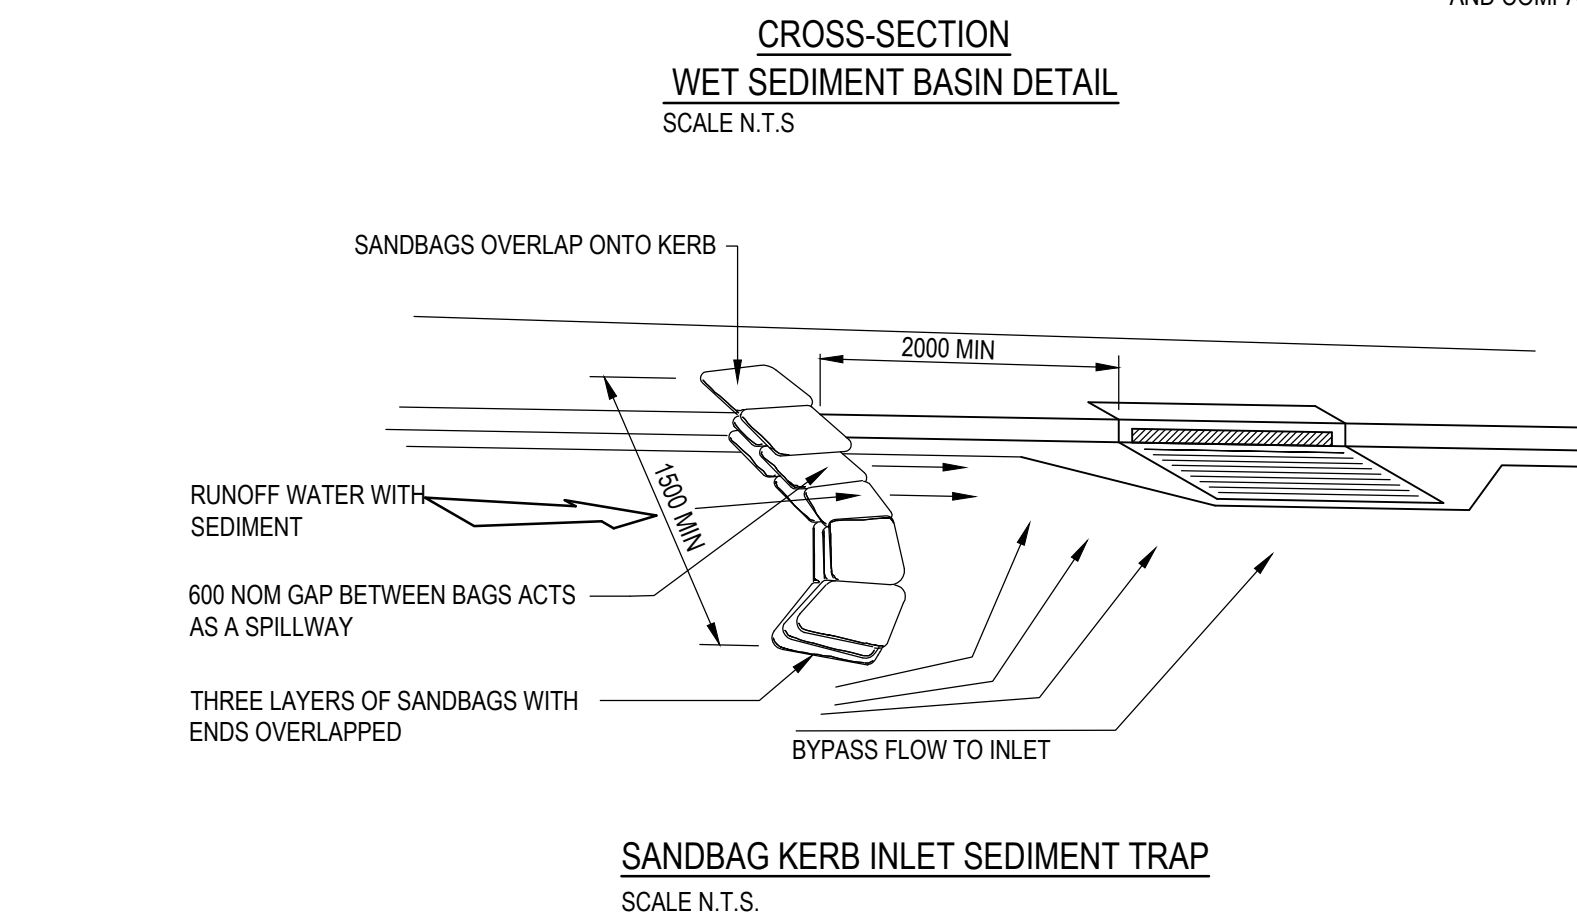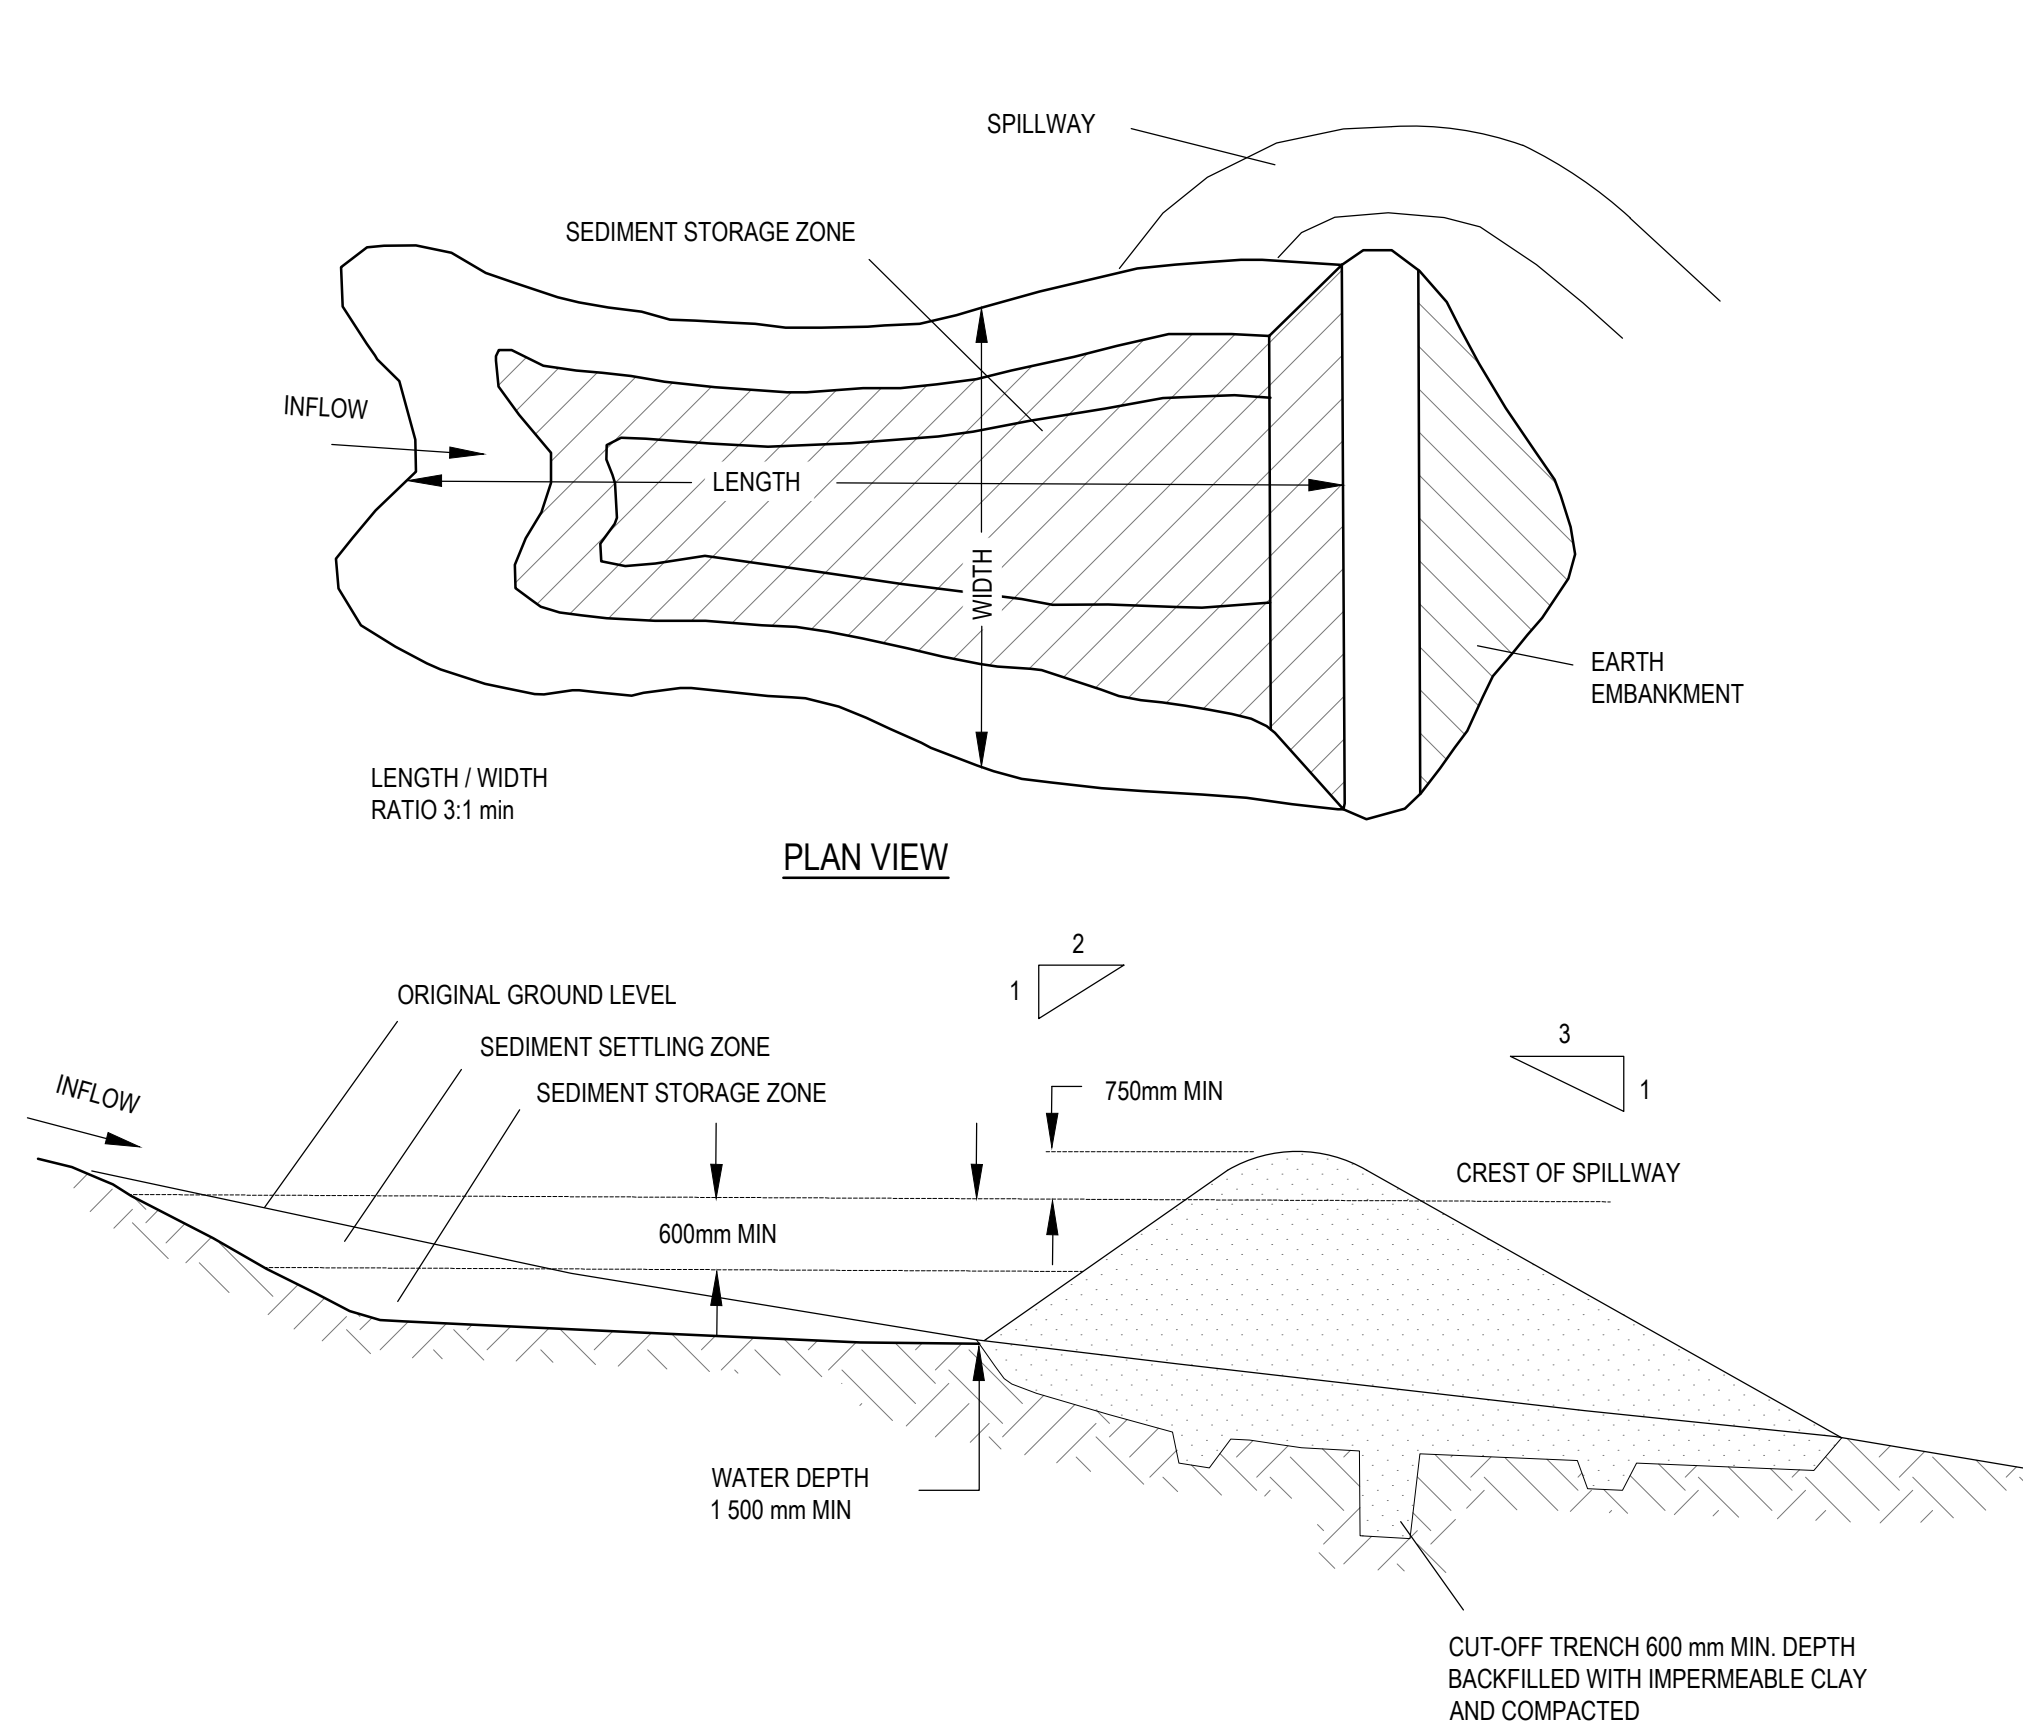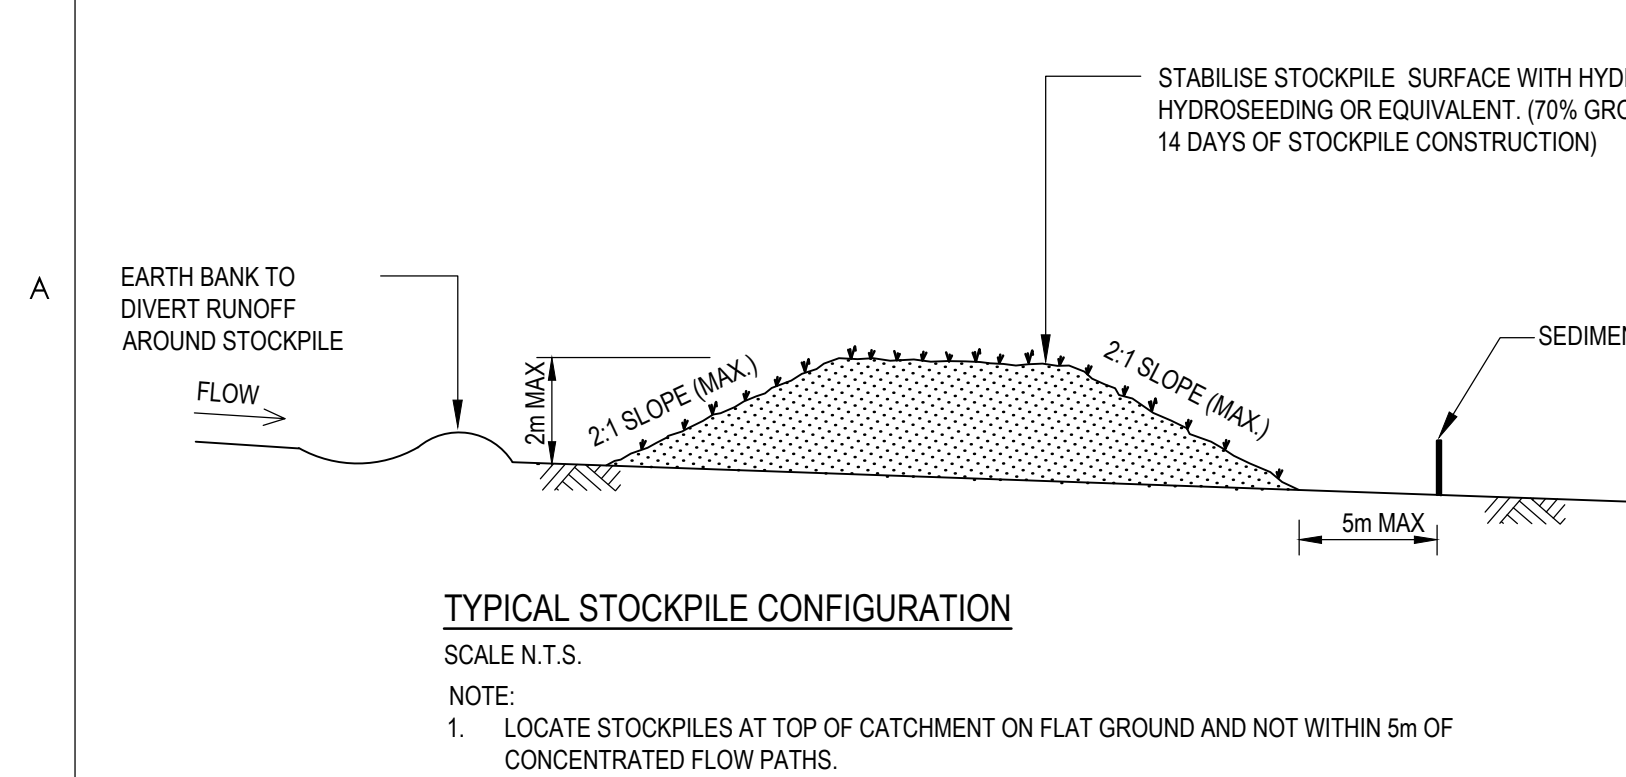Notes

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Client/Project
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HUNTER RIVER HIGH SCHOOL

HEATHERBRAE NSW 2324



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	Dwn.	Dsgn.	Chkd.	YYYY.MM.DD

Title

EROSION AND SEDIMENT CONTROL - DETAILS

Project No.
301350957

Revision **C** Drawing No. **HRHS-STNC-XX-XX-DR-C-076001**

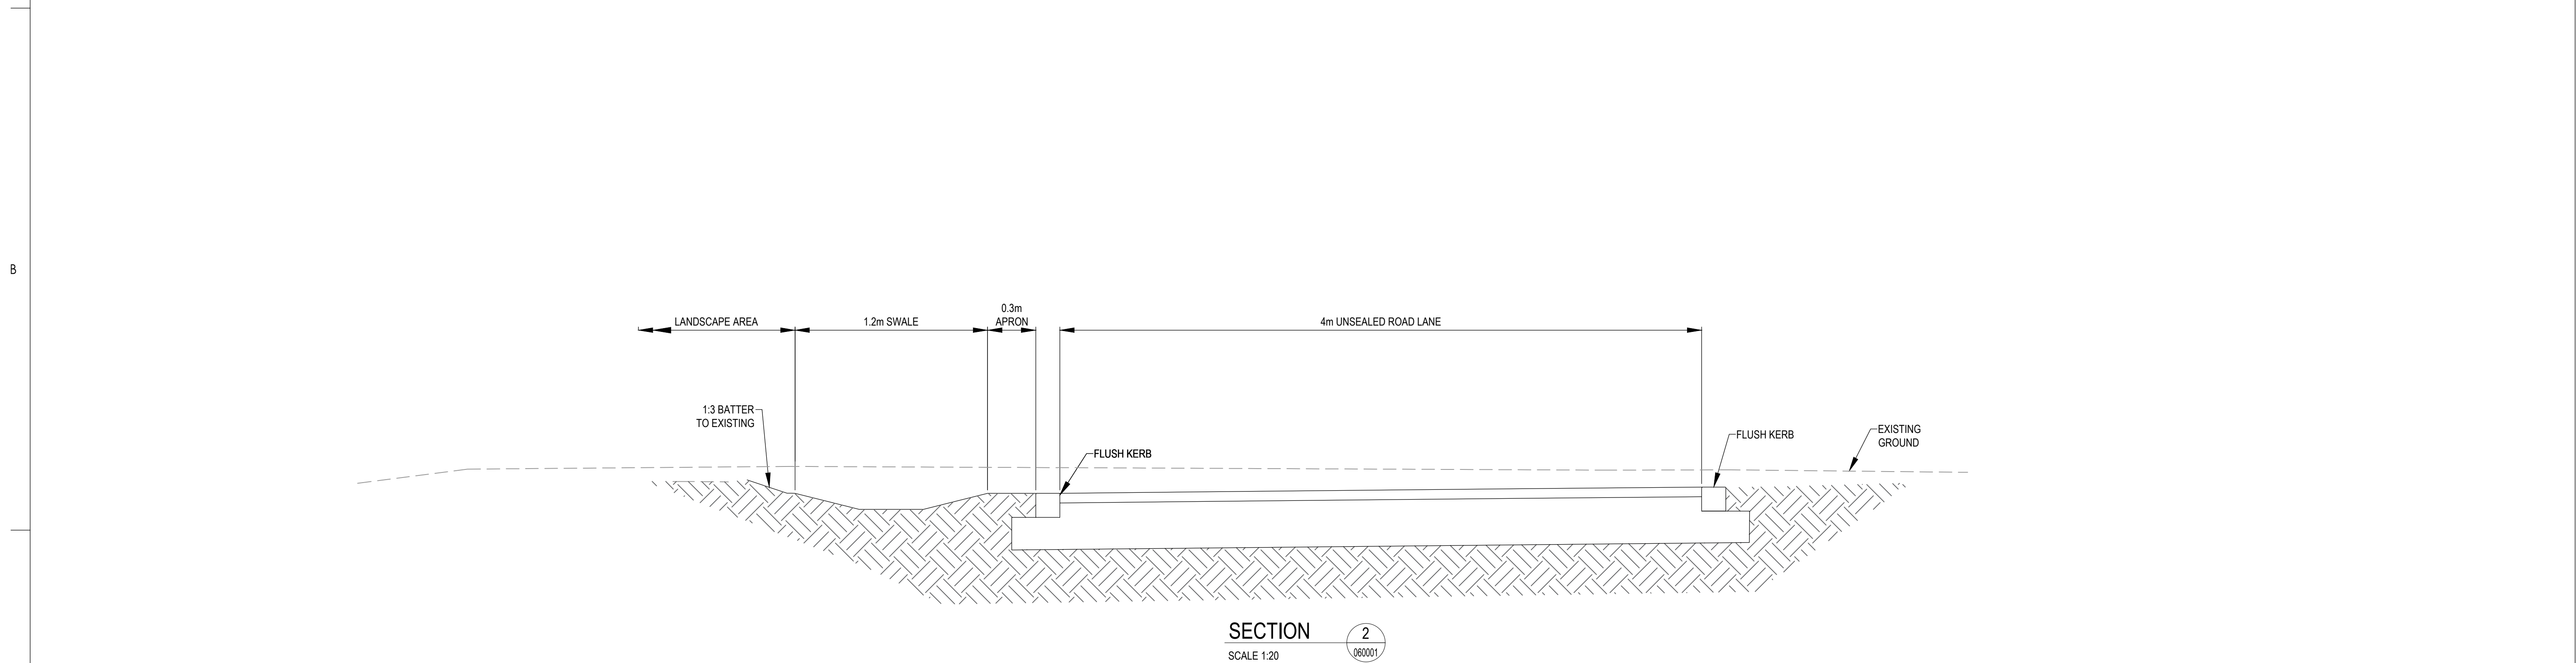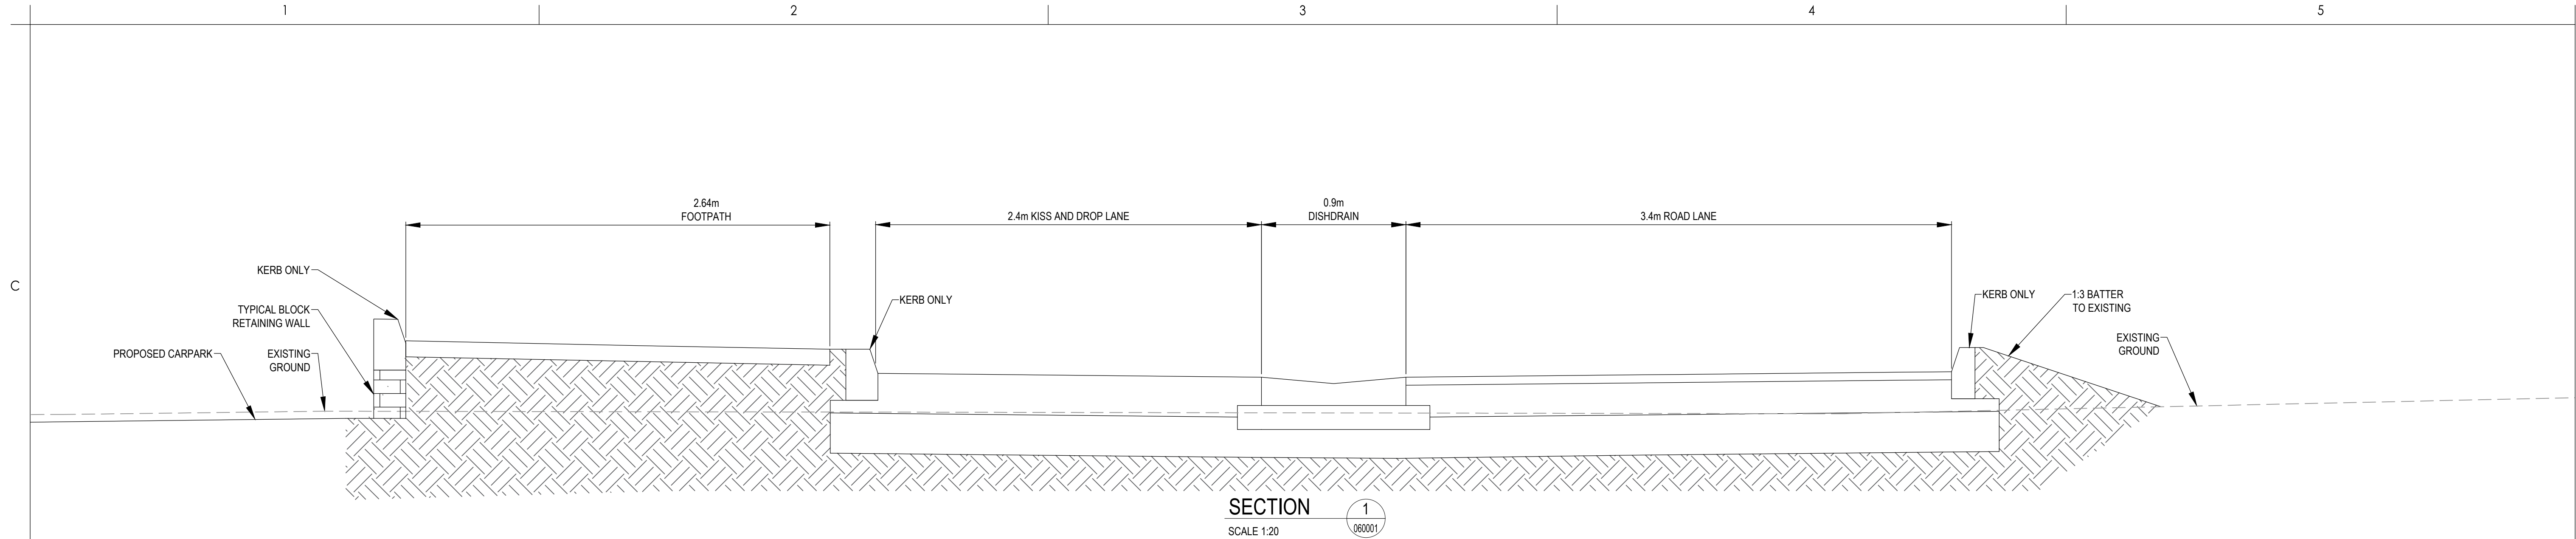

Notes

B	ISSUE FOR SCHEMATIC DESIGN - REF 01	HAL	JMB	2024.04.17
A	ISSUE FOR SCHEMATIC DESIGN - REF 01	MK	JMB	2024.04.04

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CONSTRUCTION ISSUE

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HEATHERBRAE NSW 2324

File Name: HRHS-STNC-XX-XX-DR-C-403001.DWG

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JMB

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2024.04.04

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Dign.

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YYYY.MM.DD

Title

ROADS TYPICAL SECTIONS







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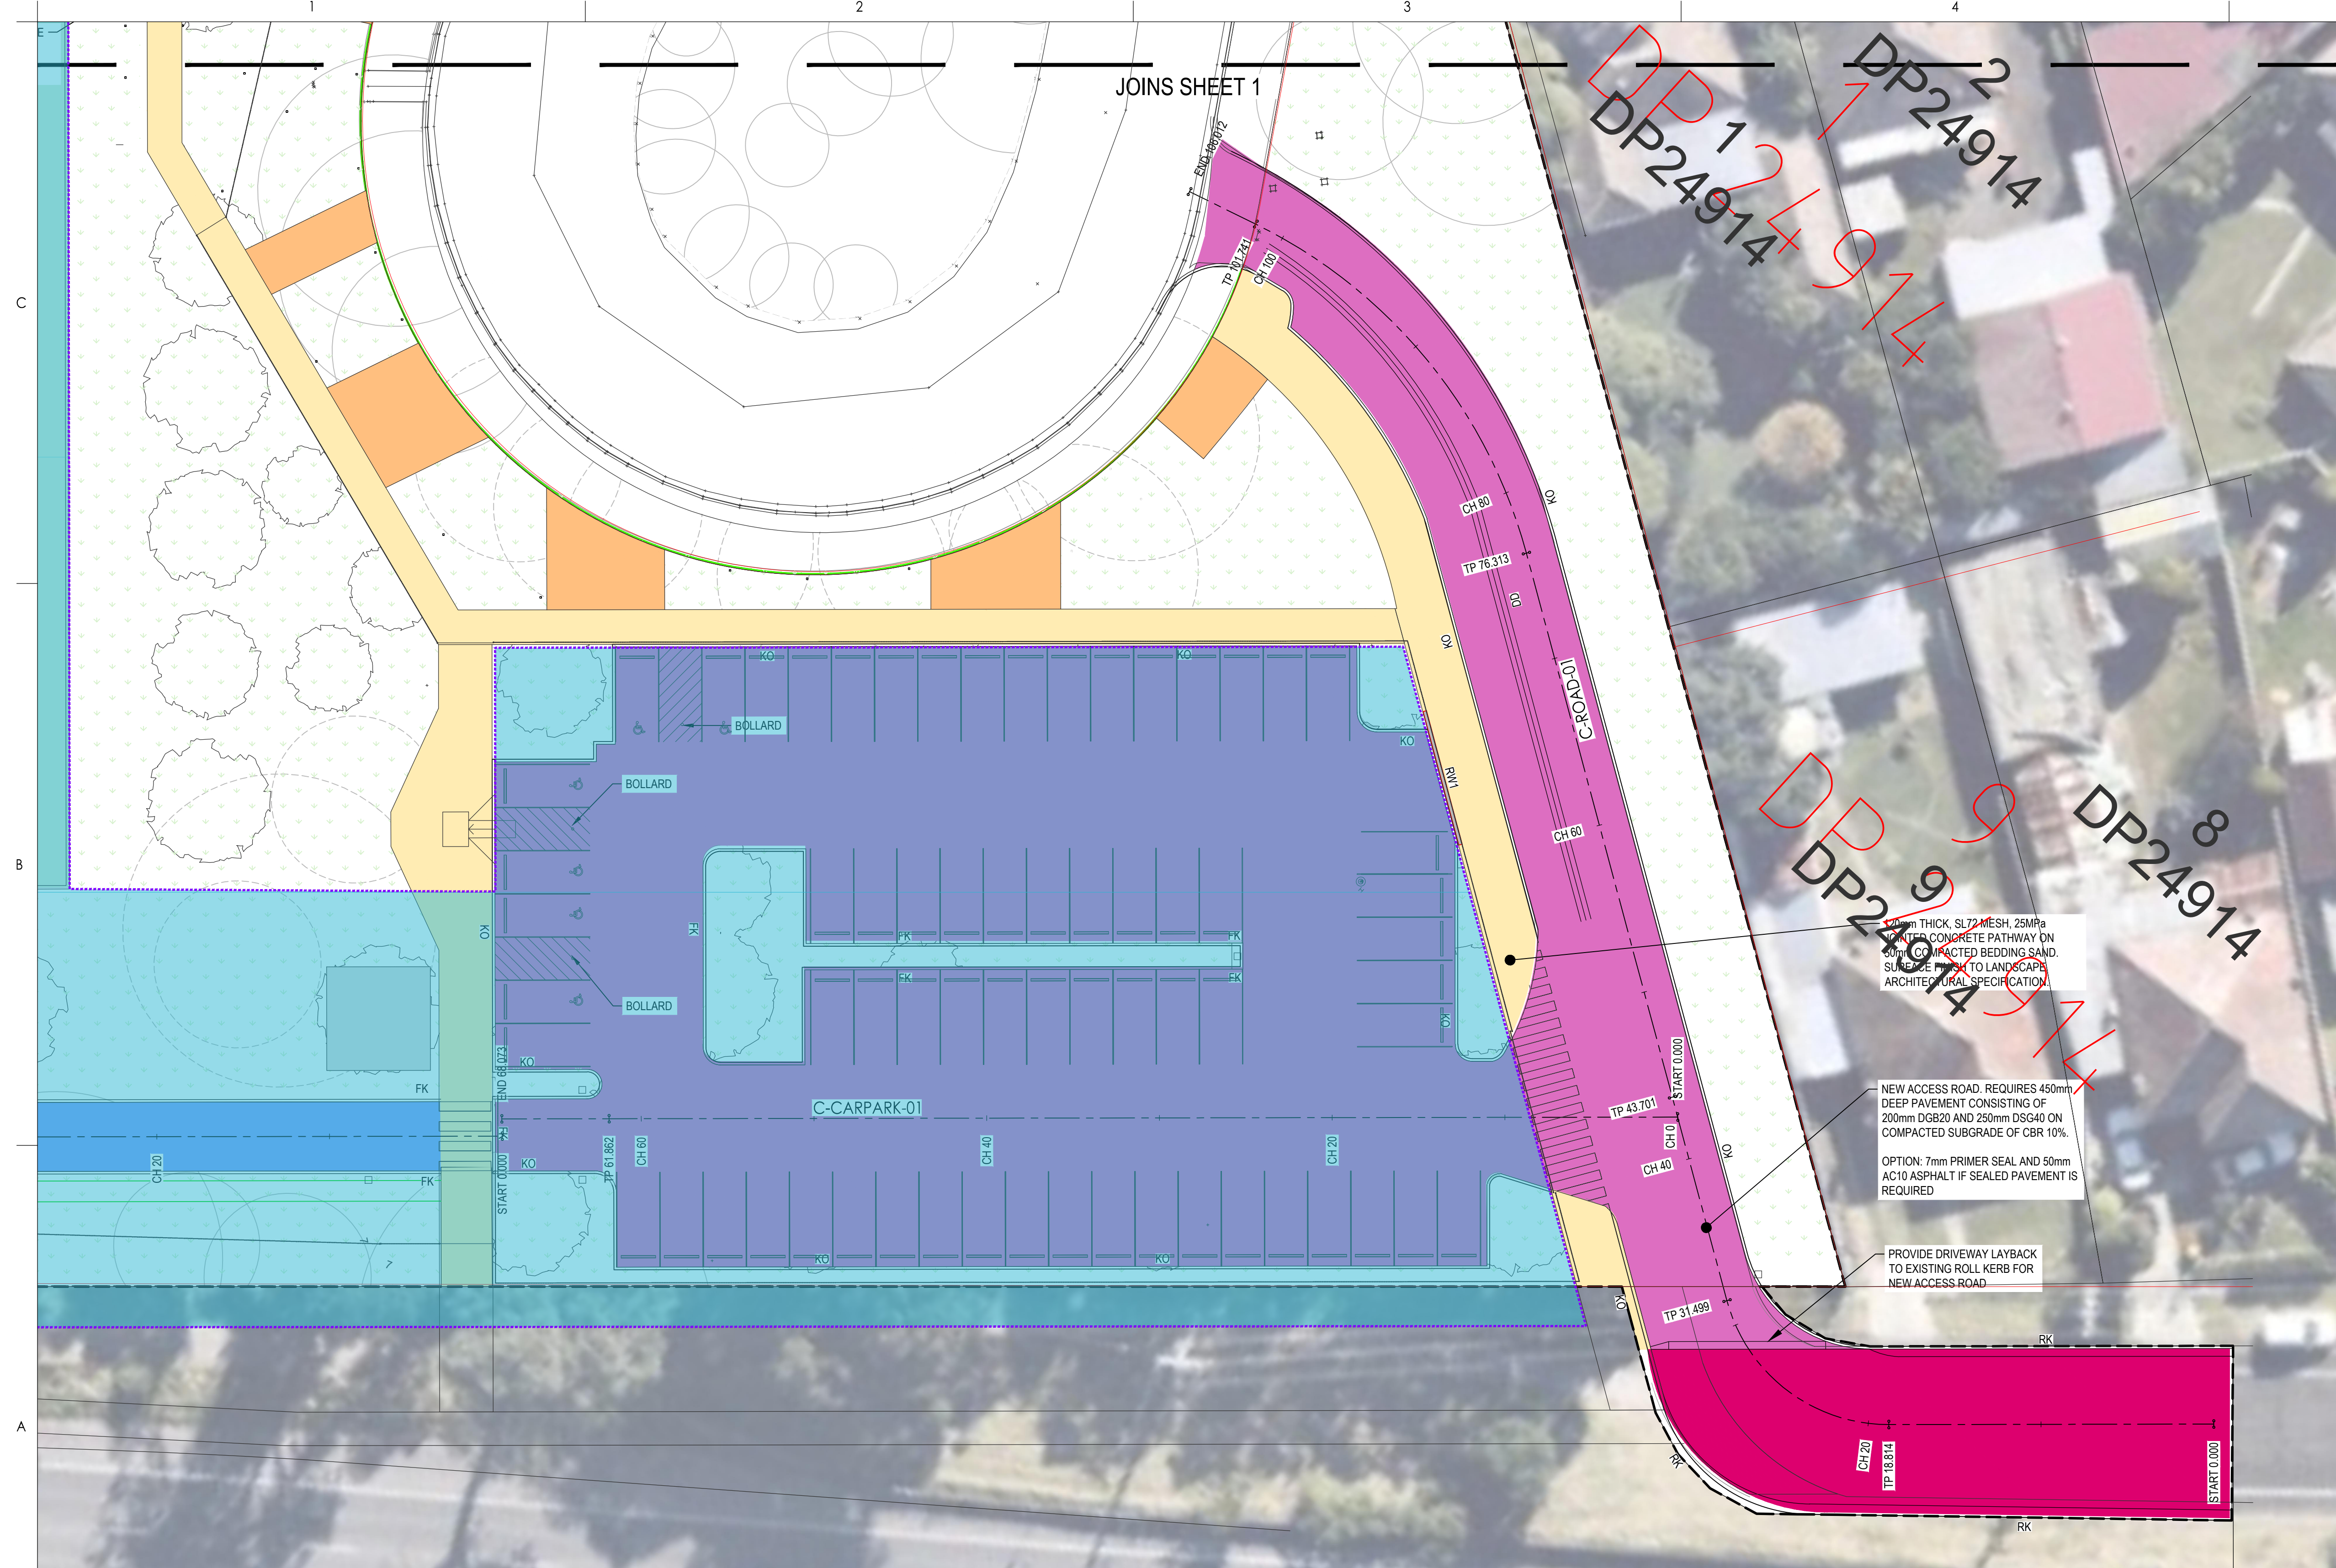
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Revision
B

Drawing No.
HRHS-STNC-XX-XX-DR-C-403001

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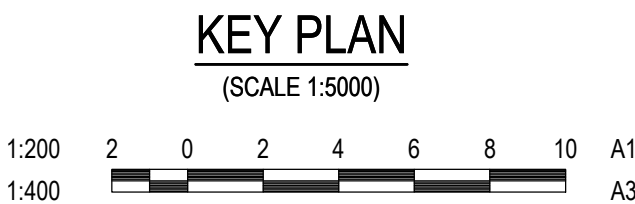
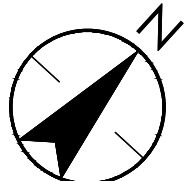
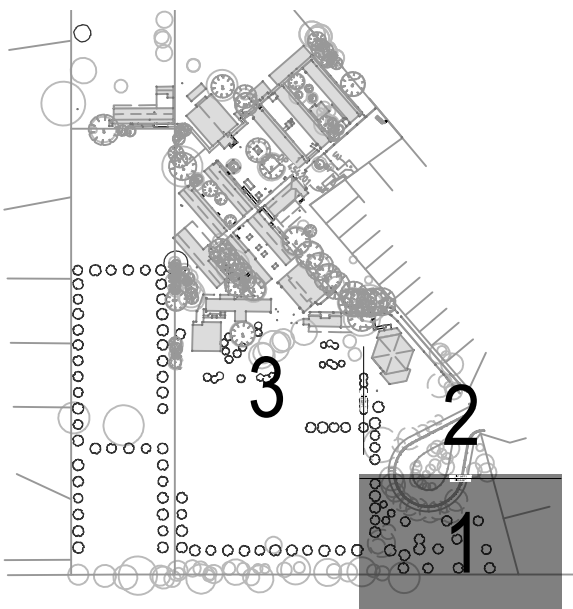





LEGEND	
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	LANDSCAPE
	SPORTS FIELD
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	UNSEALED PAVEMENT
	EXISTING UNSEALED PAVEMENT TO BE MAINTAINED
	EXISTING PAVEMENT RE-SHEETED
	CONCRETE FOOTPATH
	EXISTING CONCRETE FOOTPATH
	CRUSHED GRANITE
	BRICK PAVING
	INTERFACE OF EXISTING PAVEMENT & PROPOSED PAVEMENT ⁽¹⁾

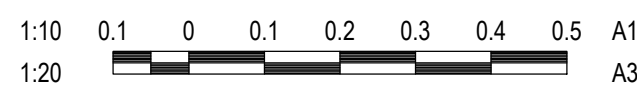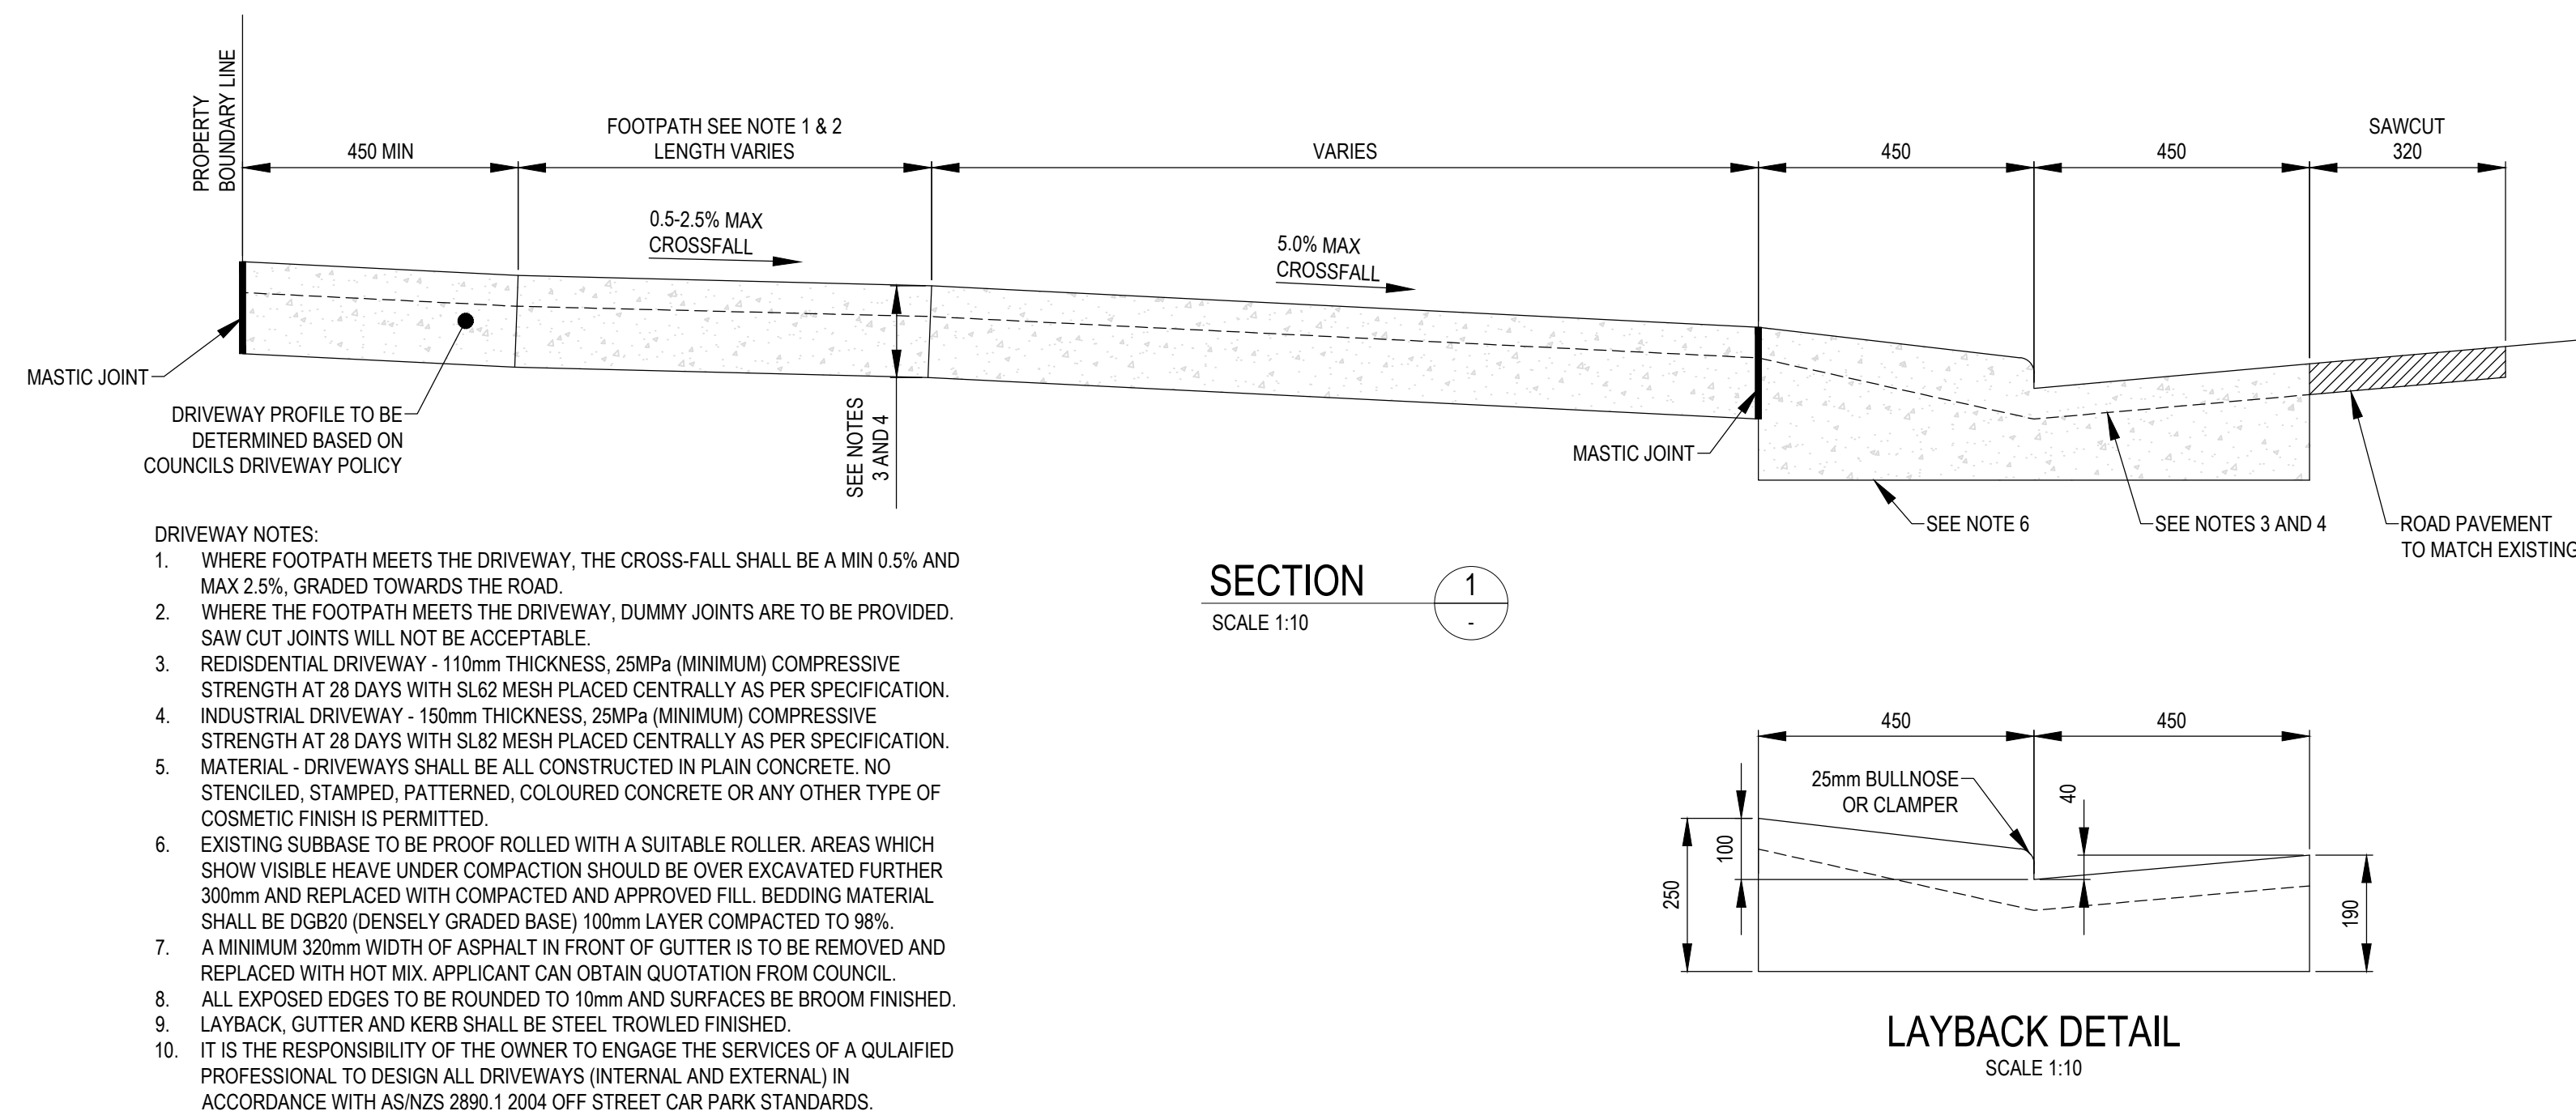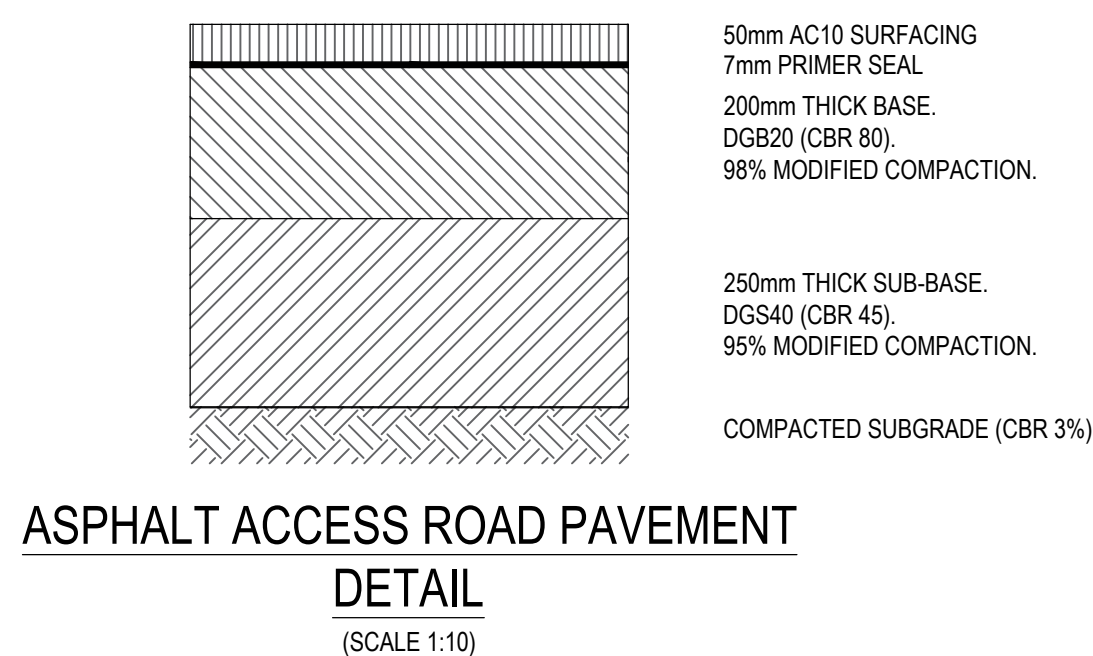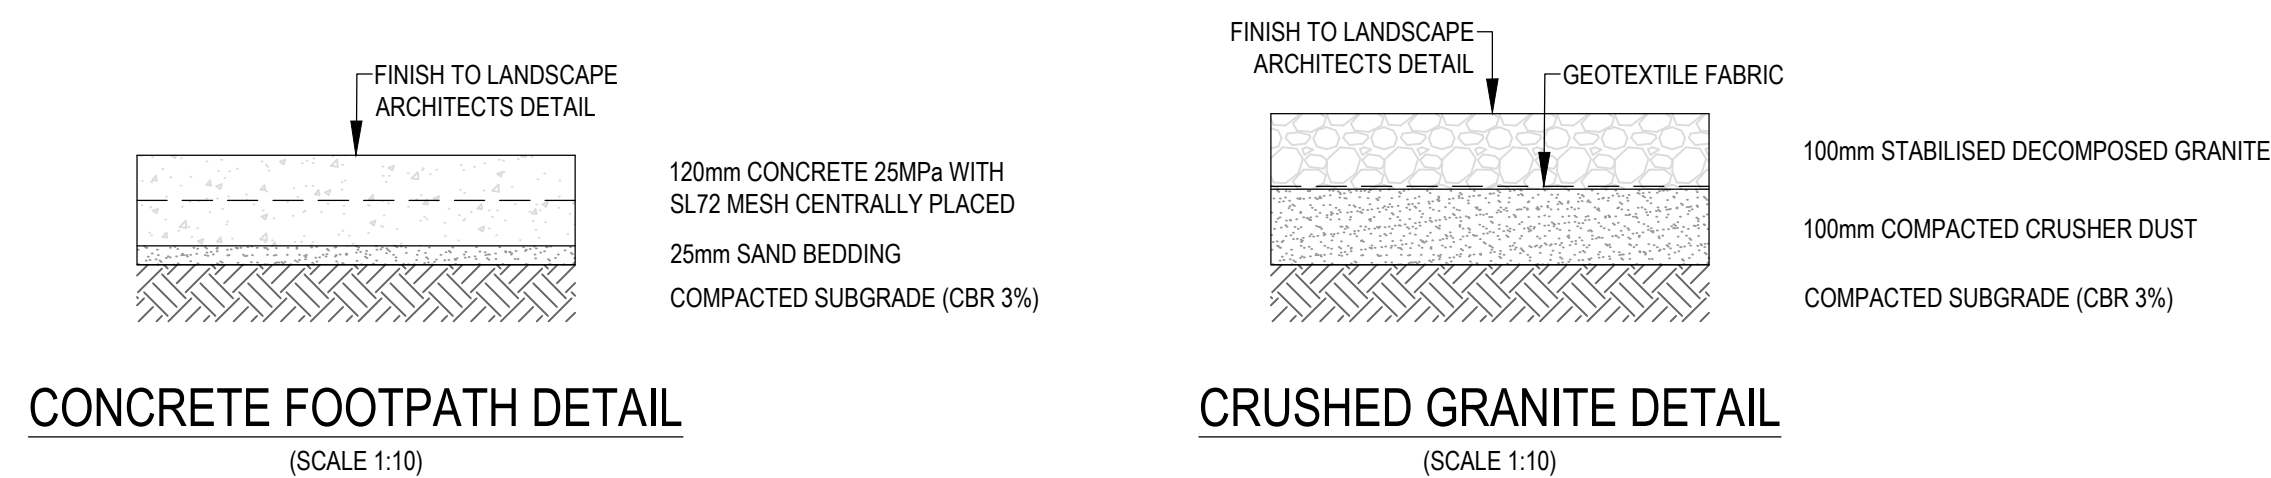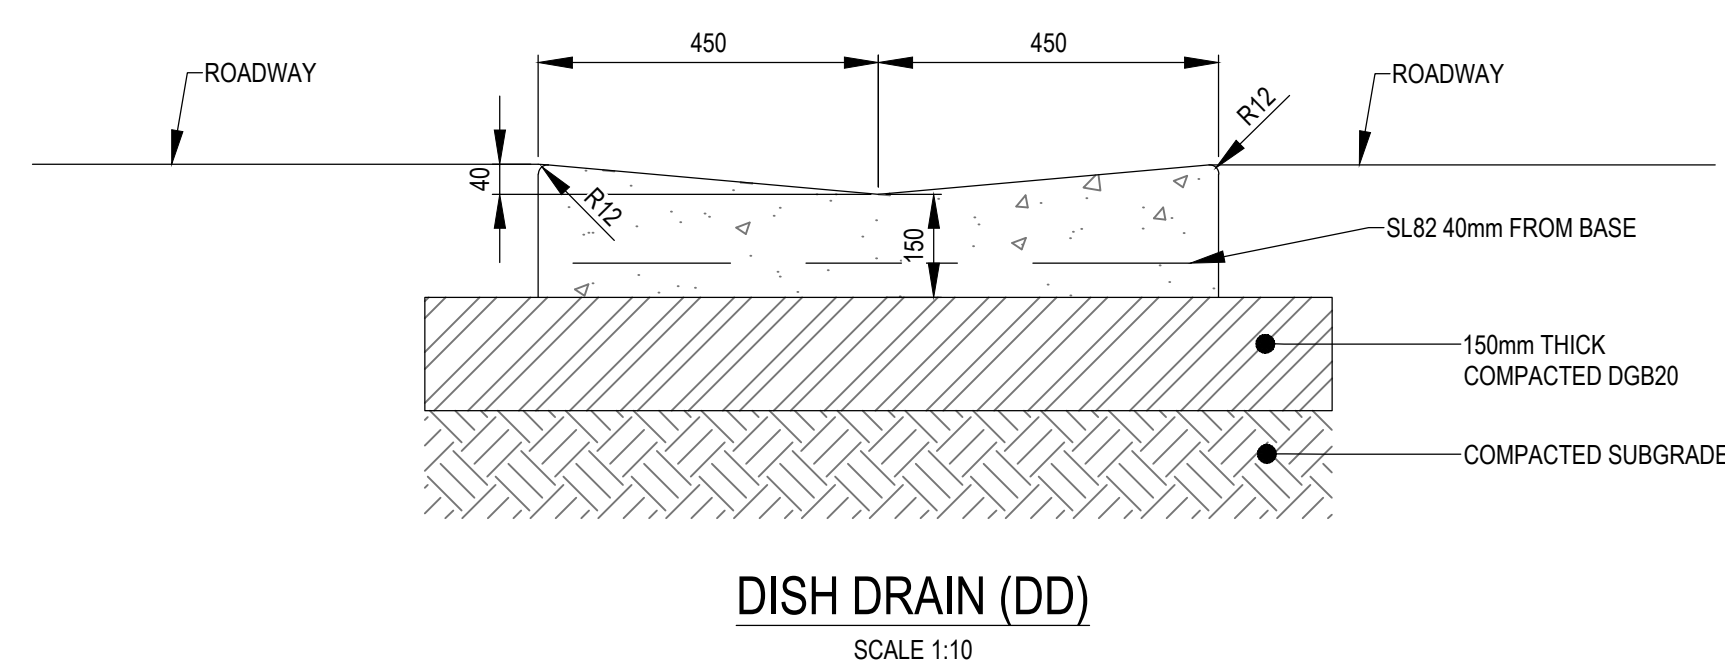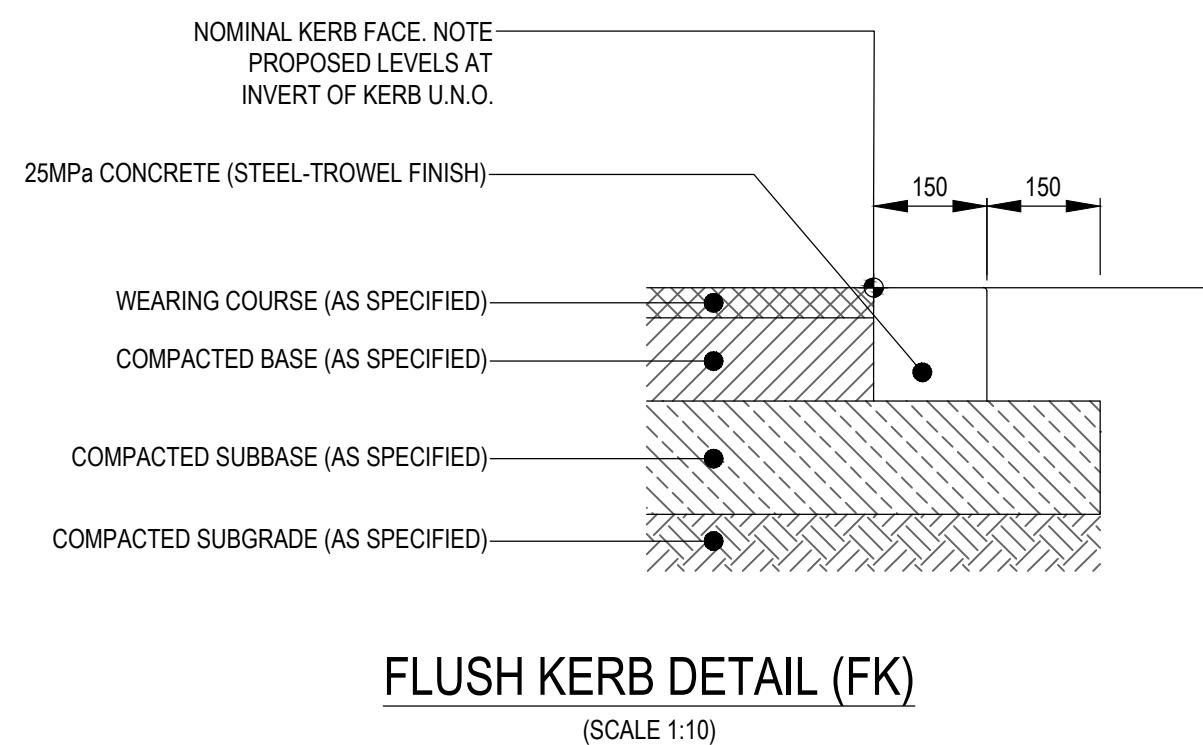NOTES:

1. CUT NEATLY INTO EXISTING PAVEMENT & APPLY EXPANSION JOINT (E.J) DETAIL PER SHEET HRHS-STNC-XX-XX-DR-C-406002






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		This document is suitable only for the purpose noted above. Use of this document for any other purpose is not permitted.		Notes		 The APP Group		HUNTER RIVER HIGH SCHOOL		Project No. 301350957	
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								JMB Chkd.		2024.04.04 YYYY.MM.DD	
										Drawing No. HRHS-STNC-XX-XX-DR-C-440101	

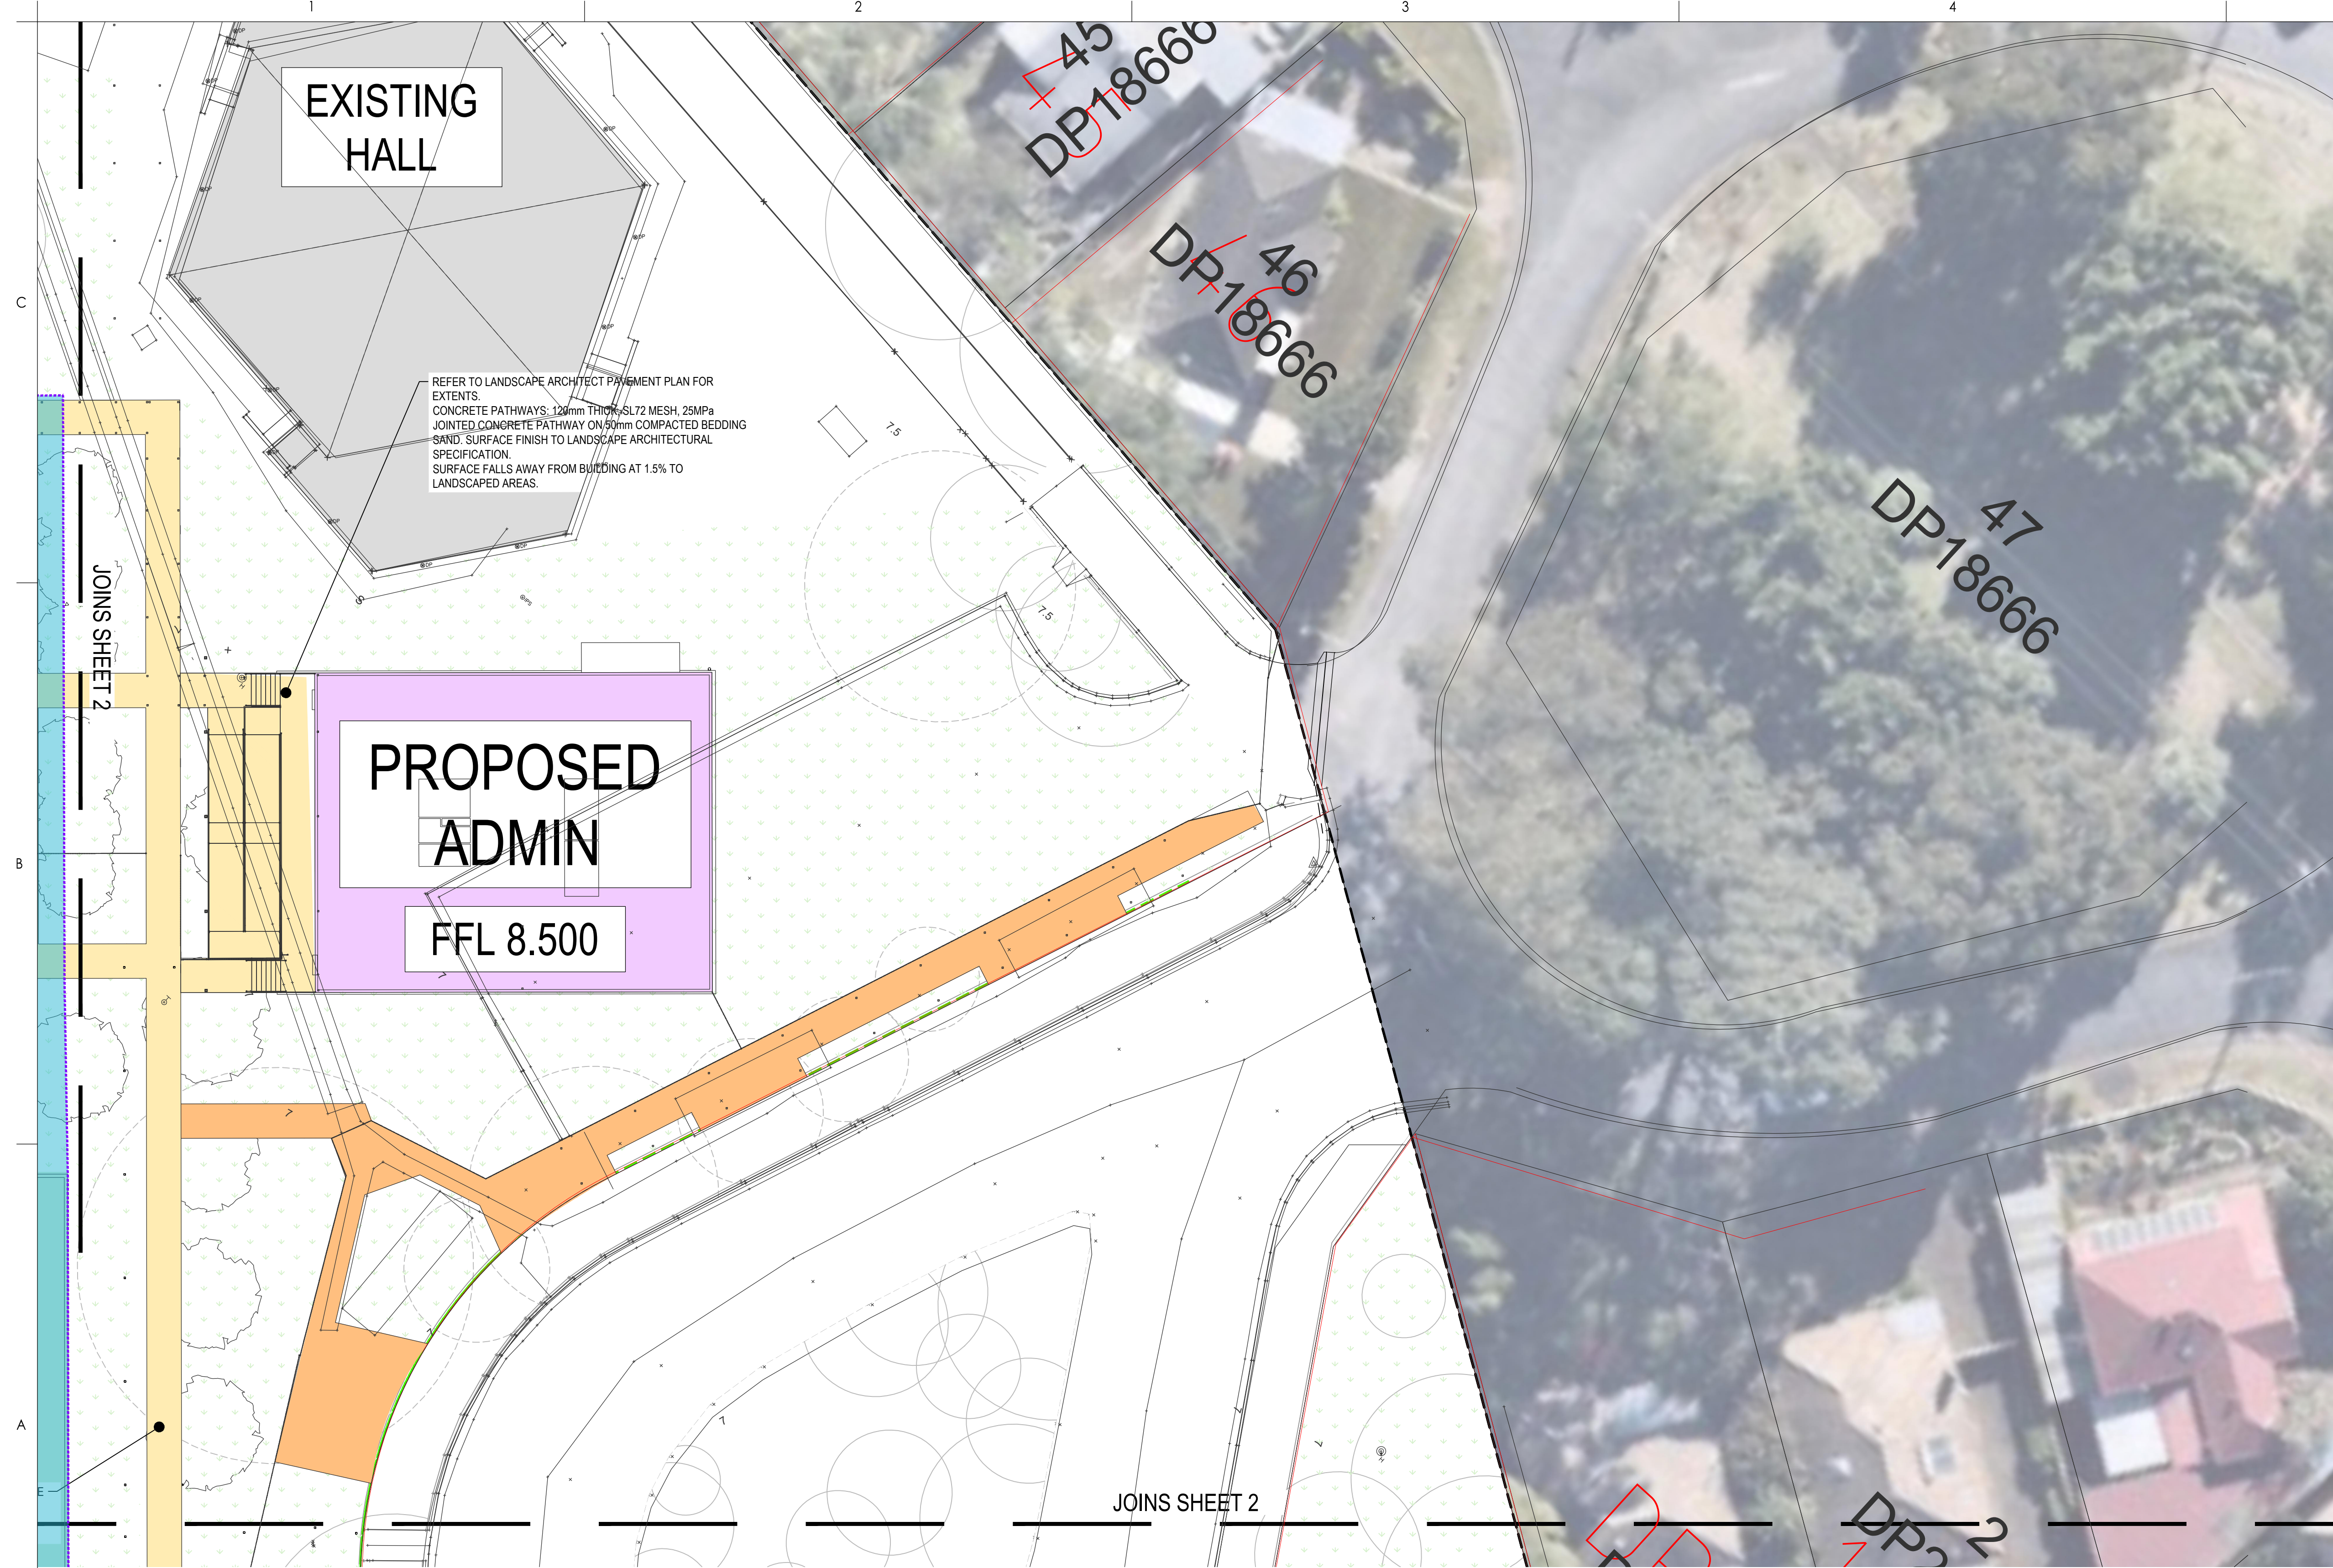

LEGEND


- SITE BOUNDARY
- PROPOSED BUILDING
- DA PLANNING EXTENTS
- LANDSCAPE
- SPORTS FIELD
- ROAD PAVEMENT - ASPHALT SURFACING
- UNSEALED PAVEMENT
- EXISTING UNSEALED PAVEMENT TO BE MAINTAINED
- EXISTING PAVEMENT RE-SHEETED
- CONCRETE FOOTPATH
- EXISTING CONCRETE FOOTPATH
- CRUSHED GRANITE
- BRICK PAVING
- INTERFACE OF EXISTING PAVEMENT & PROPOSED PAVEMENT ⁽¹⁾

- NOTES:**
- CUT NEATLY INTO EXISTING PAVEMENT & APPLY EXPANSION JOINT (E.J) DETAIL PER SHEET HRHS-STNC-XX-XX-DR-C-406002

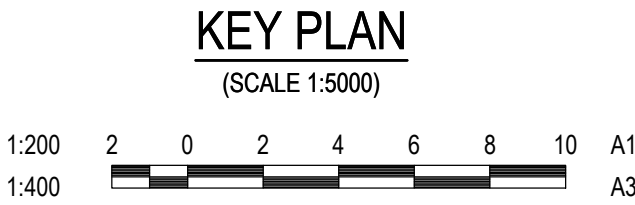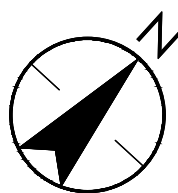
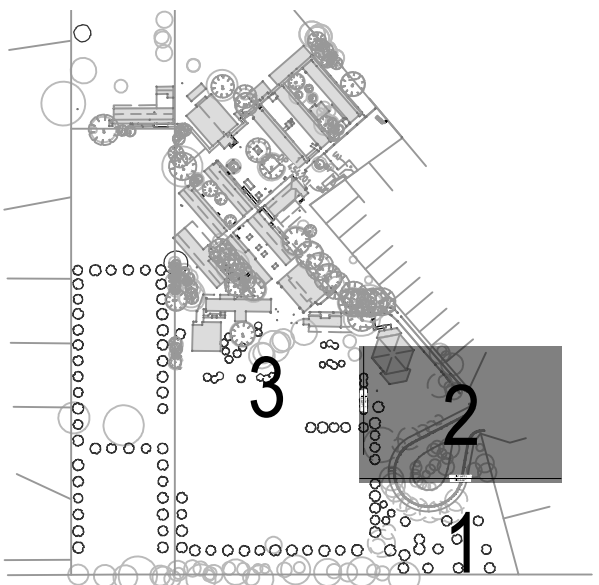


<p>Notes</p> <p>Issued/Revision</p> <table><tr><td>C</td><td>ISSUE FOR SCHEMATIC DESIGN - REF 01</td><td>HAL</td><td>JMB</td><td>2024.05.02</td></tr><tr><td>B</td><td>ISSUE FOR SCHEMATIC DESIGN - REF 01</td><td>HAL</td><td>JMB</td><td>2024.04.17</td></tr><tr><td>A</td><td>ISSUE FOR SCHEMATIC DESIGN - REF 01</td><td>MK</td><td>JMB</td><td>2024.04.04</td></tr></table>	C	ISSUE FOR SCHEMATIC DESIGN - REF 01	HAL	JMB	2024.05.02	B	ISSUE FOR SCHEMATIC DESIGN - REF 01	HAL	JMB	2024.04.17	A	ISSUE FOR SCHEMATIC DESIGN - REF 01	MK	JMB	2024.04.04	<p>Issue Status</p> <p>PRELIMINARY</p> <p>NOT FOR CONSTRUCTION</p> <p>This document is suitable only for the purpose noted above. Use of this document for any other purpose is not permitted.</p>	<p>Colour Disclaimer</p> <p>This drawing has been documented in colour. This drawing is required to be printed in colour. Failure to do so may result in loss of information. Black and white printing may be used if specific black and white documents have been obtained from Stantec.</p> <p>Notes</p>	<p>Stantec</p> <p>Stantec Australia Pty. Ltd. Level 6, Building B 207 Pacific Highway St Leonards, NSW 2045 Tel: +61 2 8484 7000</p> <p>Copyright Reserved</p> <p>The Copyright to all designs and drawings are the property of Stantec. Reproduction or use for any purpose other than that authorised by Stantec is forbidden. The Contractor shall verify and be responsible for all dimensions. DO NOT scale the drawing - any errors or omissions shall be reported to Stantec without delay.</p>	<p>Client/Project Logo</p> <p>NSW GOVERNMENT</p> <p>The APP Group</p>	<p>Client/Project</p> <p>SINSW</p> <p>HUNTER RIVER HIGH SCHOOL</p> <p>HEATHERBRAE NSW 2324</p> <table><tr><td>File Name:</td><td>HRHS-STNC-XX-XX-DR-C-440101.DWG</td><td>CPO</td><td>JMB</td><td>JMB</td><td>2024.04.04</td></tr><tr><td></td><td></td><td>Dwn.</td><td>Dign.</td><td>Chkd.</td><td>YYYY.MM.DD</td></tr></table>	File Name:	HRHS-STNC-XX-XX-DR-C-440101.DWG	CPO	JMB	JMB	2024.04.04			Dwn.	Dign.	Chkd.	YYYY.MM.DD	<p>Title</p> <p>PAVEMENT PLAN - SHEET 2</p> <p>Project No. 301350957 Scale 1:200</p> <p>Revision c Drawing No. HRHS-STNC-XX-XX-DR-C-440102</p>
C	ISSUE FOR SCHEMATIC DESIGN - REF 01	HAL	JMB	2024.05.02																													
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		Dwn.	Dign.	Chkd.	YYYY.MM.DD																												

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1. CUT NEATLY INTO EXISTING PAVEMENT & APPLY EXPANSION JOINT (EJ) DETAIL PER SHEET HRHS-STNC-XX-XX-DR-C-406002

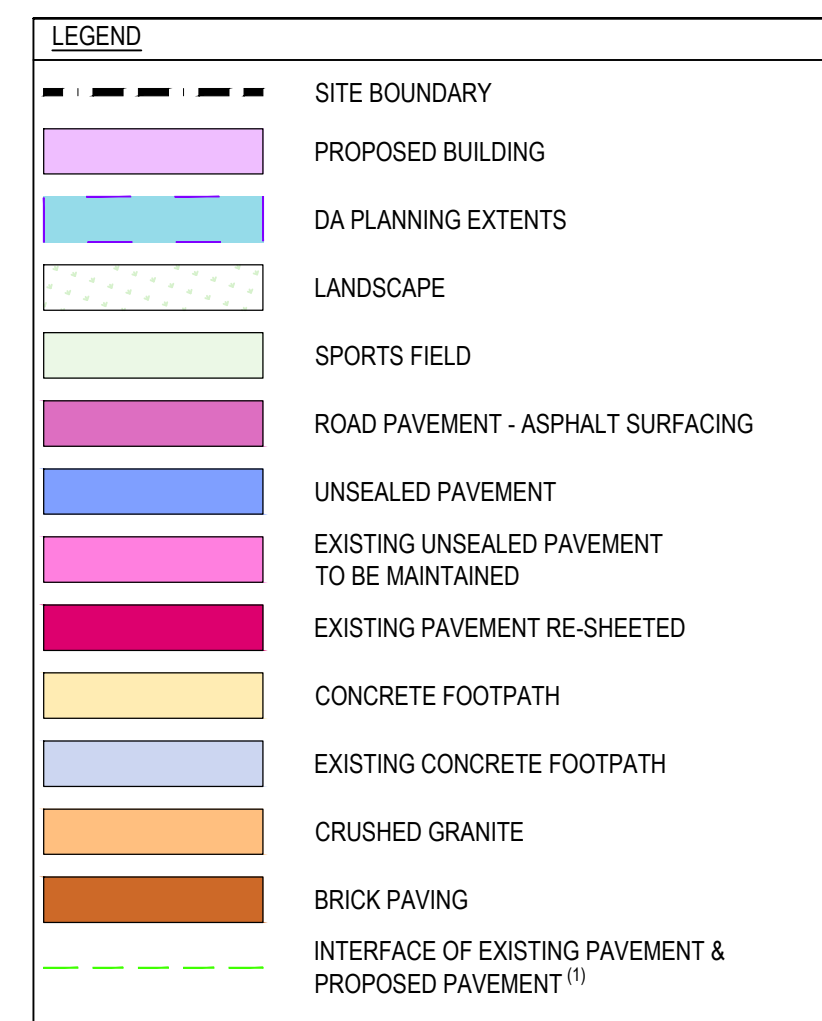

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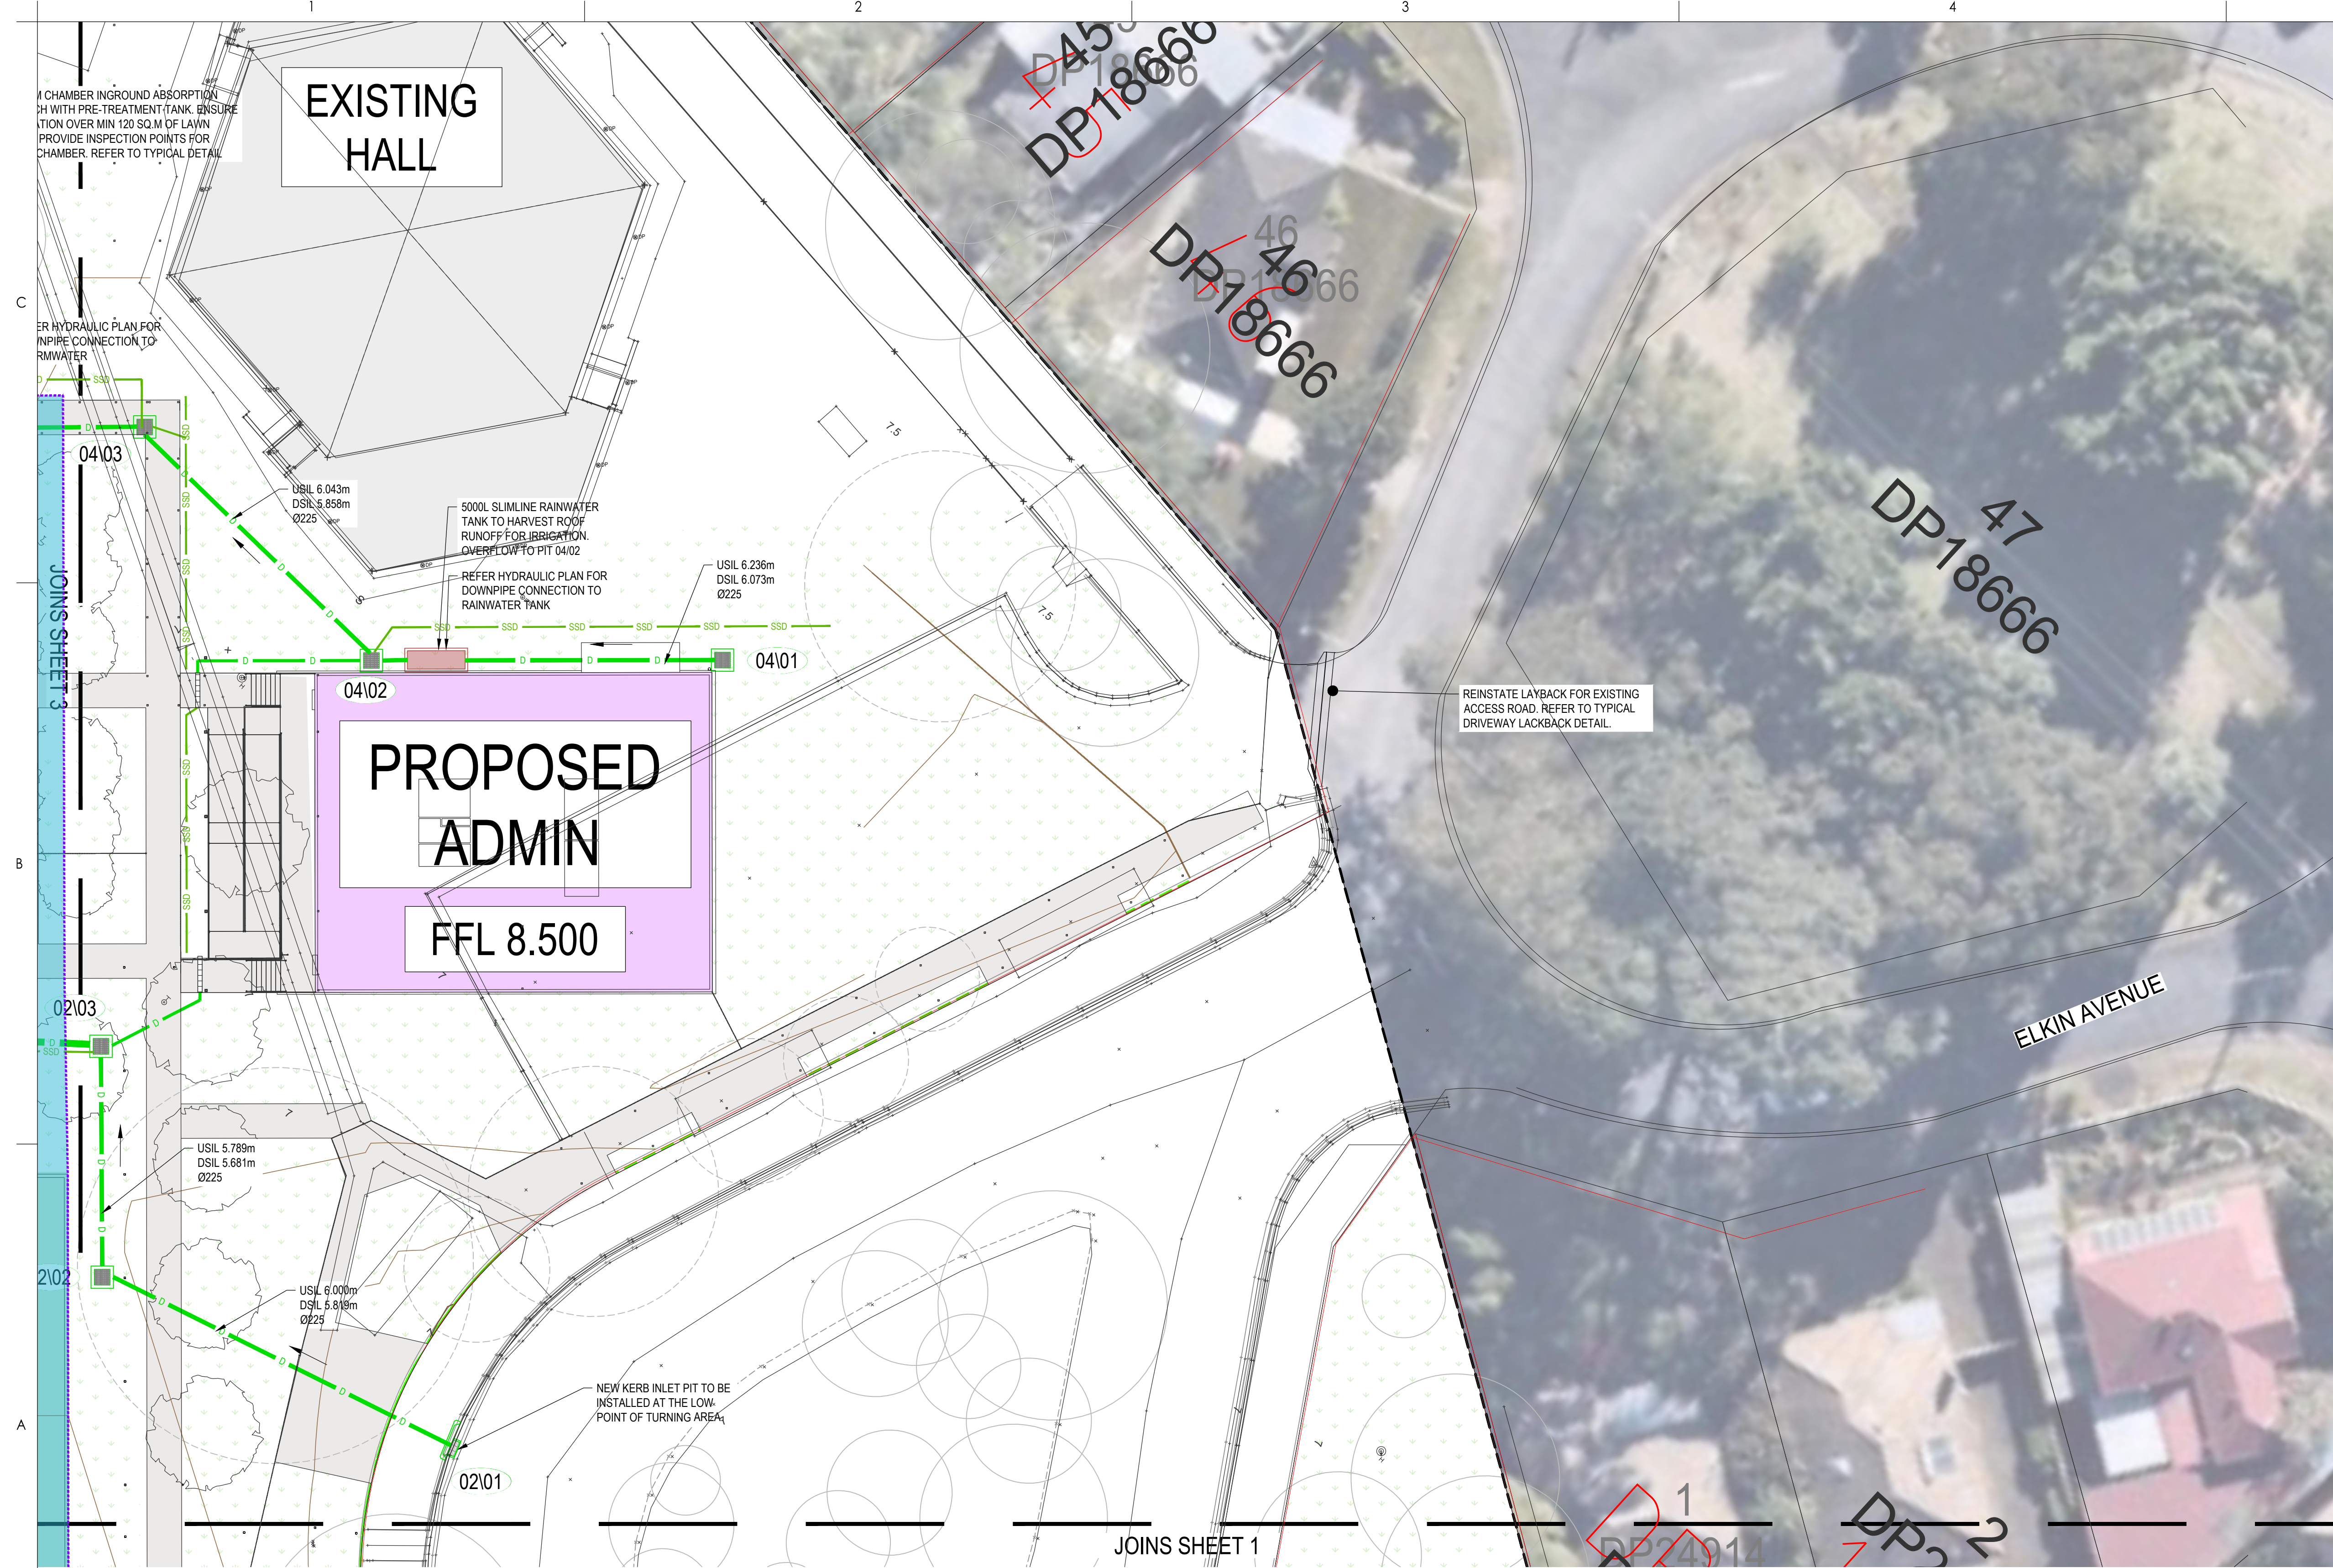
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HEATHERBRAE NSW 2324

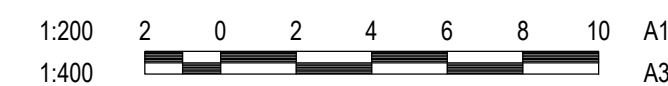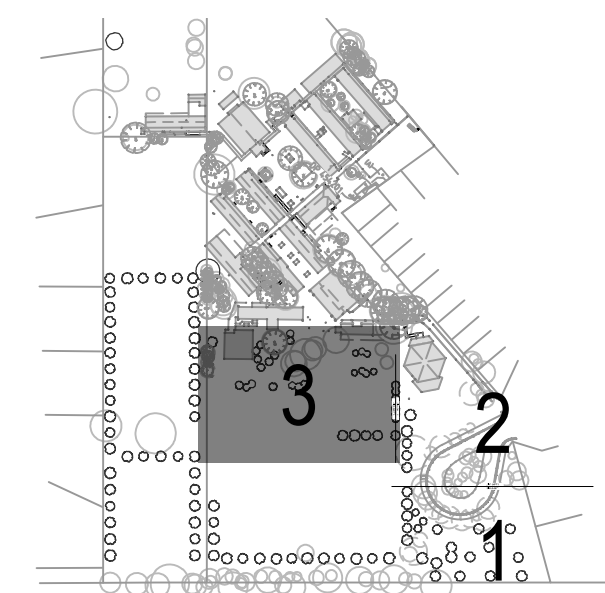File Name: HRHS-STNC-XX-XX-DR-C-440101.DWG	CPO	JMB	JMB	2024.04.04
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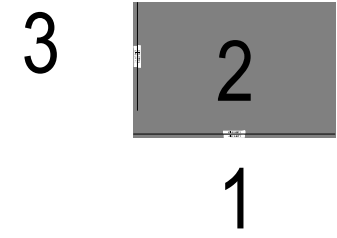
PAVEMENT PLAN -
SHEET 3Project No.
301350957

Revision **C** Drawing No. **HRHS-STNC-XX-XX-DR-C-440103**




LEGEND

- SITE BOUNDARY
- PROPOSED BUILDING
- PROPOSED STORMWATER PIPE
- PROPOSED GRATED DRAIN
- SSD--- PROPOSED SUBSOIL DRAIN
- ON SITE DETENTION (OSD) TANK
- RAINWATER TANK
- STORM CHAMBER
- SPEL HYDROSYSTEM
- GRASSED TABLE DRAIN
- PROPOSED JUNCTION PIT
- EXISTING JUNCTION PIT
- PROPOSED GRATED PIT
- EXISTING GRATED PIT
- PROPOSED KERB INLET PIT
- EXISTING KERB INLET PIT
- PIT TAG
- PROPOSED TREE. REFER LANDSCAPE ARCHITECT.
- EXISTING TREE TO REMAIN



KEY PLAN
(SCALE 1:5000)

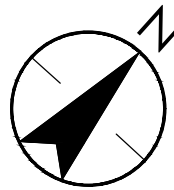

Notes

C	ISSUE FOR SCHEMATIC DESIGN - REF 01	HAL	JMB	2024.05.02
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A	ISSUE FOR SCHEMATIC DESIGN - REF 01	MK	JMB	2024.04.04

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YYYY.MM.DD

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Title

STORMWATER DRAINAGE PLAN - SHEET 2


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Scale 1:200

Revision c


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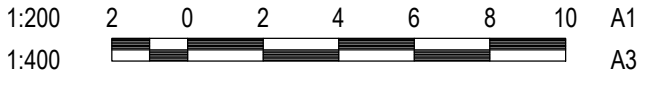
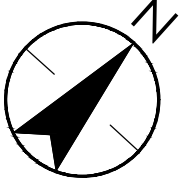


LEGEND

- SITE BOUNDARY
- PROPOSED BUILDING
- PROPOSED STORMWATER PIPE
- PROPOSED GRATED DRAIN
- PROPOSED SUBSOIL DRAIN
- ON SITE DETENTION (OSD) TANK
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- EXISTING KERB INLET PIT
- PIT TAG
- PROPOSED TREE
- REFER LANDSCAPE ARCHITECT.
- EXISTING TREE TO REMAIN

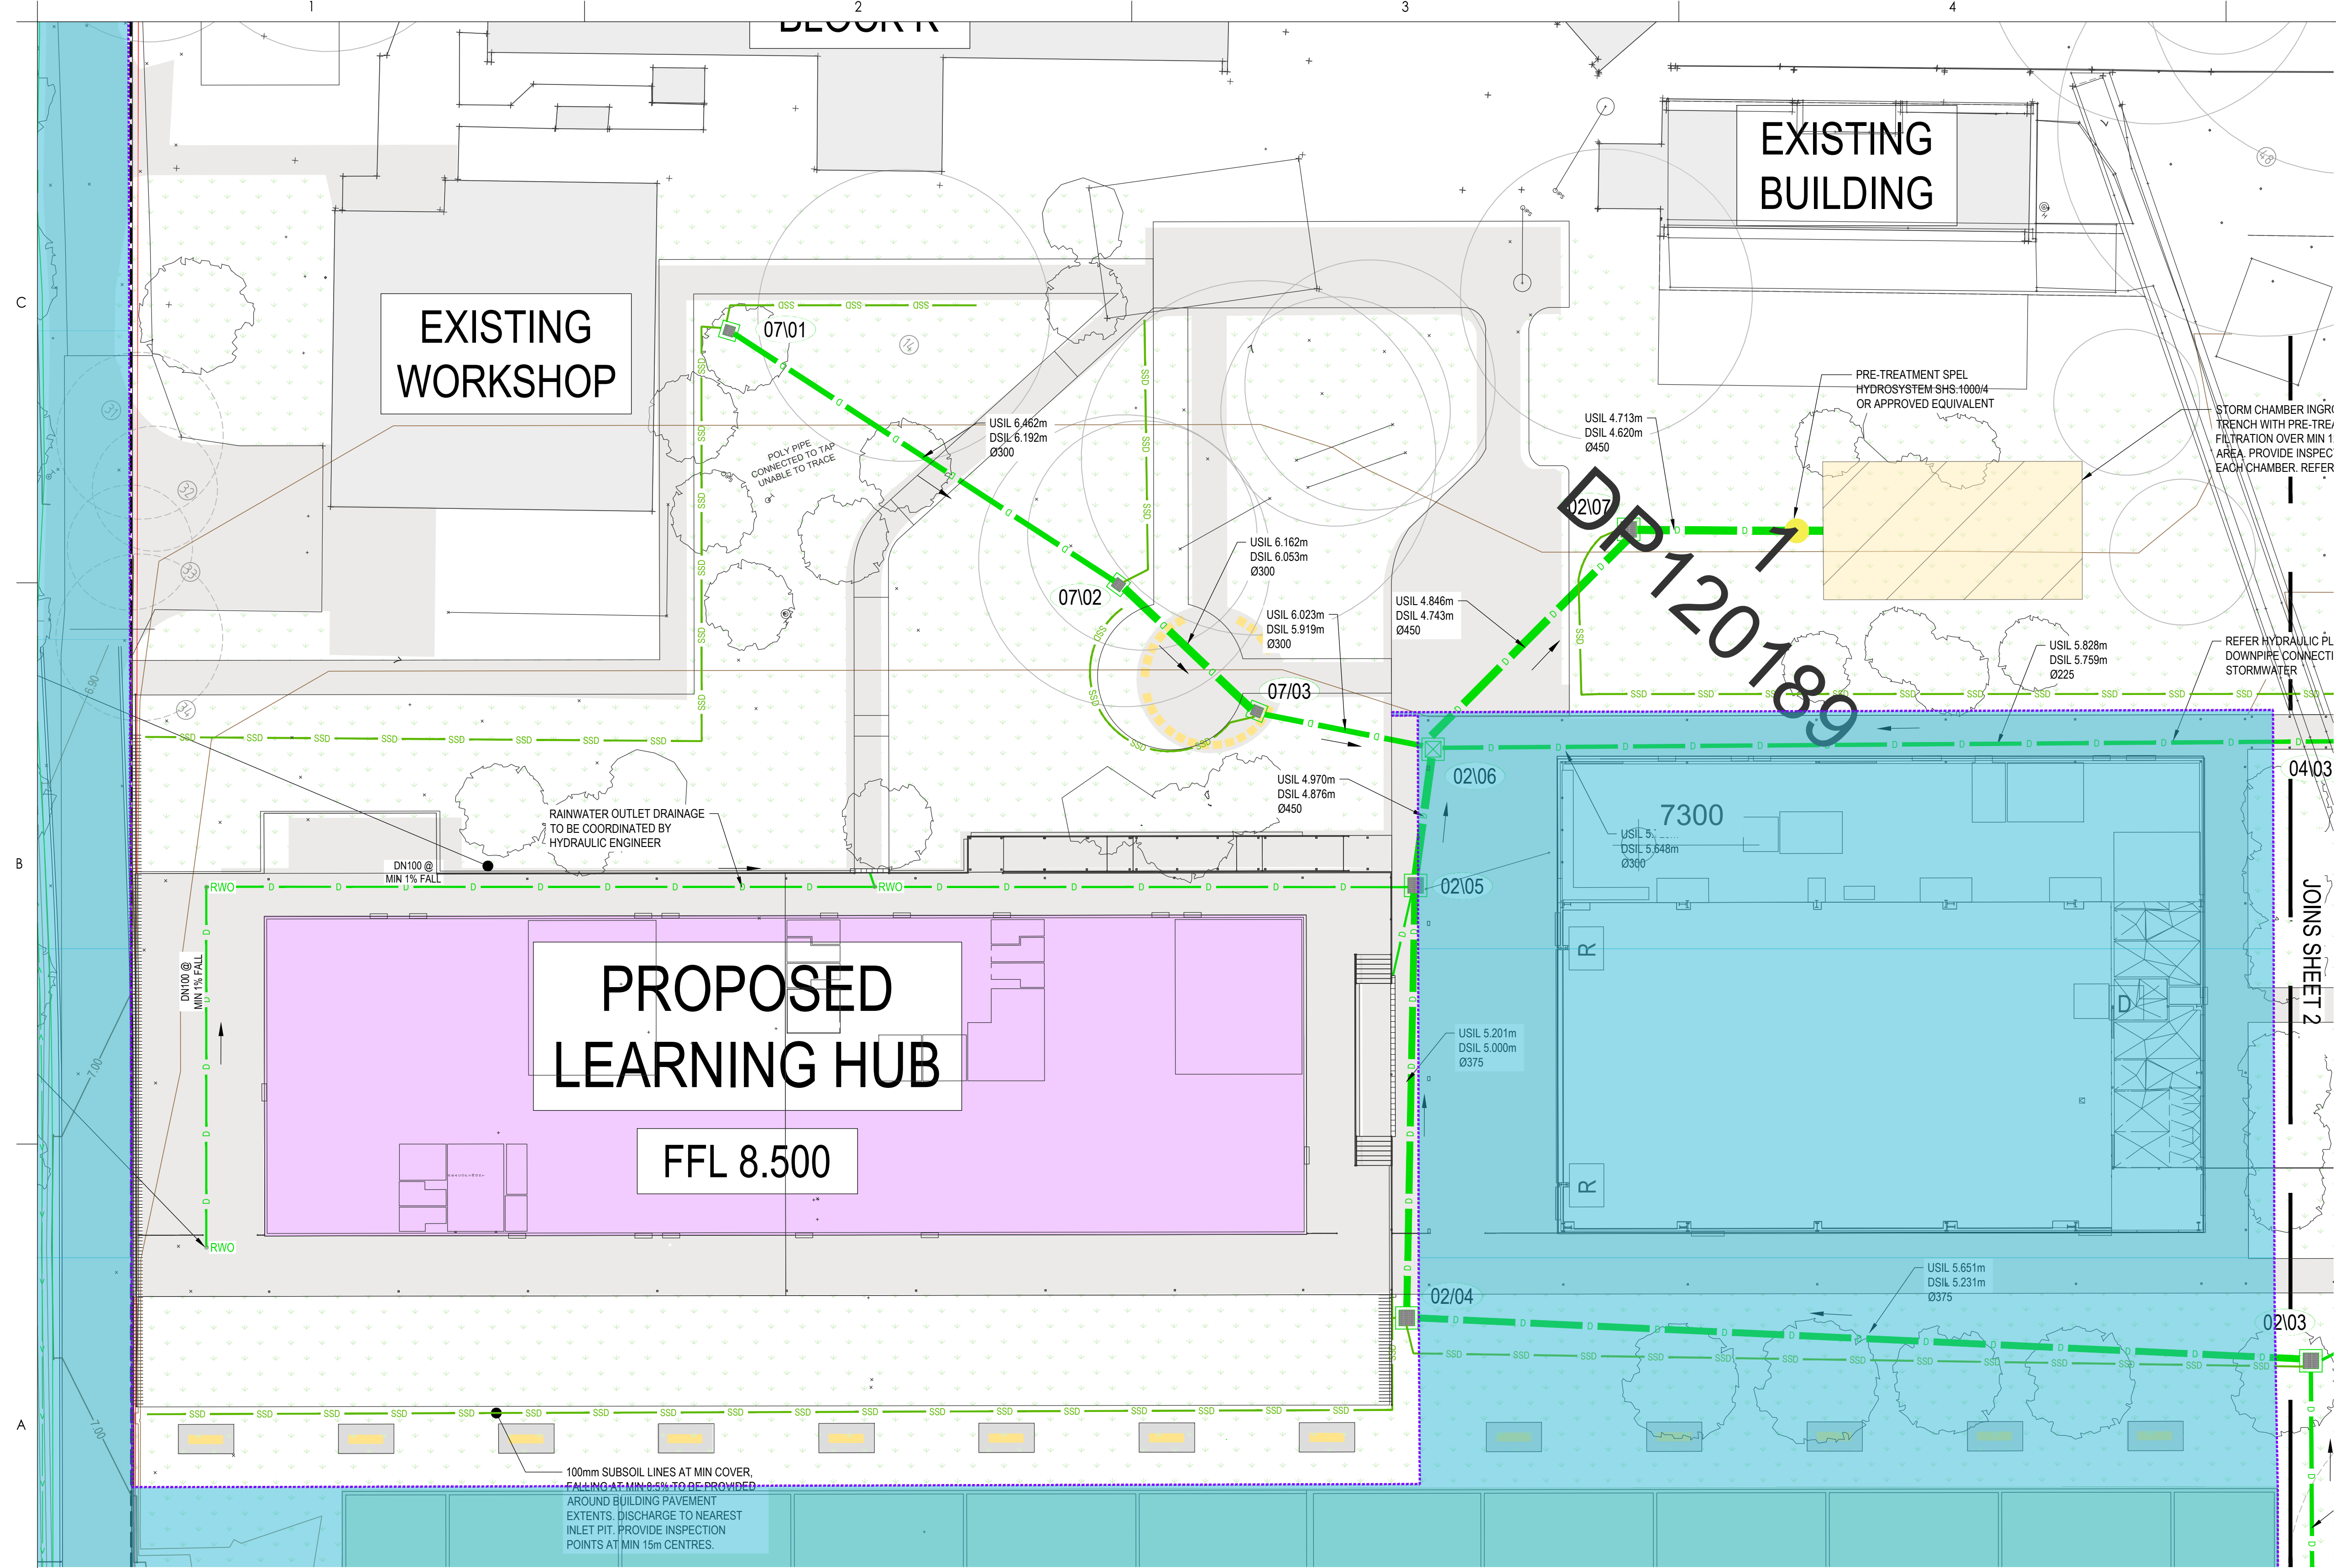

KEY PLAN
(SCALE 1:5000)

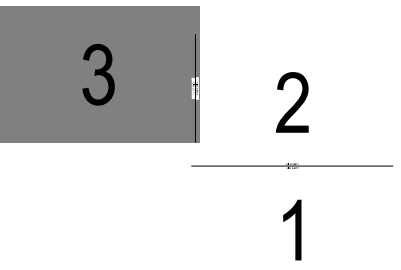

Notes

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Title

STORMWATER DRAINAGE PLAN - SHEET 3

Project No. 301350957

Scale 1:200

Revision c

Drawing No. **HRHS-STNC-XX-XX-DR-C-520103**

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