

Hunter River High School Upgrade

REF1 ISSUE

BUILDING AND SITE INFORMATION

ADDRESS	36 Elkin Ave, Heatherbrae NSW 2324
CLIENT	School Infrastructure NSW
LOT/ DP	1/- DP120189, 1/- DP540114, 1/- DP579025
SITE AREA	91456.5 m²
LOCAL COUNCIL	Port Stephens Council
LEP BULDING HEIGHT	9m
LEP ZONING	R2 - Low Density Residential
WIND CLASSIFICATION	-
MINES SUBSIDENCE ZONE	-
FLOOD ZONE	'Minimal Risk Flood Prone Land' & 'High Hazard Floodway Area' Zones
BUSHFIRE ZONE	Vegetation Category 3, Vegetation Buffer
HERITAGE SITE	-
LOCAL ABORIGINAL LAND COUNCIL	Worimi
WETLANDS	Wetlands
FSR RATIO	ALLOWED: - ACTUAL: -



EXTERIOR FINISHES SCHEDULE


AREA	CODE	DESCRIPTION	IMAGE	AREA	CODE	DESCRIPTION	IMAGE
BRICKWORK	BRK.01	AUSTRAL 'MINERAL CONTOURS MICA GREY' PRESSED MORTAR: OFF WHITE CEMENT/ YELLOW SAND ROLLED MORTAR JOINT FINISH ANTI-GRAFFITI COATING, DULUX: SURFACESHIELD HD GRAFFITI RESISTANT TREATMENT		ROOFING	MRS.01	LYSAGHT ROOF SHEETING, CUSTOM ORB PROFILE, FINISH: COLORBOND TBC (MINIMUM ROOF SLOPE 5 DEGREES)	
WALL CLADDING - GENERALLY	FC.01	CARAT 'CORAL 7031', FORMAT: LARGO 12mm 3050mm x 1250mm, CONCEAL FIX		SOFFIT LINING - GENERALLY	SL.01	SOFFIT SHEET METAL - PROFILE AND COLOUR TBC	
WALL CLADDING - GENERALLY	FC.02	TECTIVA 'TE30', SIZE: 8mm x 2500mm x 1220mm, THICKNESS: 12mm, CONCEAL FIX		WINDOW AND DOOR FRAMES - POWDER COATED ALUMINIUM	PC.01	DURATEC ZEUS 'MONUMENT' MATT 90Z8189M	
STEEL COLUMNS	SC	NATURAL GALVANISED		SOLID CORE DOOR PAINT - GENERALLY	PT.03	'MAVORA' NZ10H9 SEMI GLOSS FINISH	
ROOFING ELEMENTS (FASCIAS, GUTTERS, FLASHINGS ETC.)	-	COLORBOND TBC		HANDRAILS AND BALUSTRADES - EFSG STANDARD	BAL.01 & HR.01	GALVANISED STEEL - NATURAL	

REF 1 ARCHITECTURAL SHEET LIST	
SHEET NO.	SHEET NAME
A-REF-001	Coversheet
A-REF-010	Site Plan
A-REF-020	Site Detail Plan
A-REF-050	Typical Covered Walkway
A-REF-X-100	Admin - Block X - Ground Floor Plan
A-REF-X-110	Admin - Block X - Roof Plan
A-REF-X-140	Admin - Block X - Reflected Ceiling Plan
A-REF-X-200	Admin - Block X - Elevations
A-REF-X-300	Admin - Block X - Sections
A-REF-Z-100	New Support Learning Hub - Block Z - Ground Floor Plan
A-REF-Z-110	New Support Learning Hub - Block Z - Reflected Ceiling Plan
A-REF-Z-140	New Support Learning Hub - Block Z - Roof Plan
A-REF-Z-200	New Support Learning Hub - Block Z - Elevations - Sheet 1
A-REF-Z-201	New Support Learning Hub - Block Z - Elevations Sheet 2
A-REF-Z-300	New Support Learning Hub - Block Z - Sections
No. of Sheets in Set: 15	

EJE ARCHITECTURE
ACN 002 912 843 | ABN 82 644 649 849
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A 412 KING STREET, NEWCASTLE, NSW 2300

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REV	DATE	COMMENTS
A	29/06/2023	ISSUE FOR REF 1
B	11/07/2023	ISSUE FOR REF 1
C	25/08/2023	REF 1 ISSUE
D	27/03/2024	REVISED REF1 SD FOR COORDINATION
E	08/04/2024	REVISED REF1 ISSUE
F	17/04/2024	REF1 ISSUE

DRN	CHKD
MJD	HN
MJD	HN
MJD	HN
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MJD	HN
MJD	HN
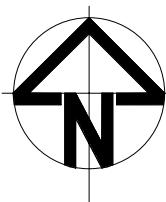
| VRFD |

PROJECT : Hunter River High School Upgrade

CLIENT : School Infrastructure NSW

SITE : 36 Elkin Ave,
Heatherbrae
NSW 2324

DRAWING : Coversheet

WORK IN FIGURED DIMENSIONS IN PREFERENCE TO SCALE. CHECK DIMENSIONS AND LEVELS ON SITE PRIOR TO THE ORDERING OF MATERIALS OR THE COMPLETION OF WORKSHOP DRAWINGS. IF IN DOUBT ASK. REPORT ALL ERRORS AND OMISSIONS.


Autodesk Docs:Hunter River High School\HRHS-EJE-ZZ-ZZ-M3-A-0001.rvt

PROJECT No : 14276
DRAWN : MJD
DATE : 17/04/2024
SCALES : As indicated @ A1 @ A3

PHASE : SD
BUILDING ID: 000
Level No: 000
DRAWING No : A-REF-001
REV : F

REF 1



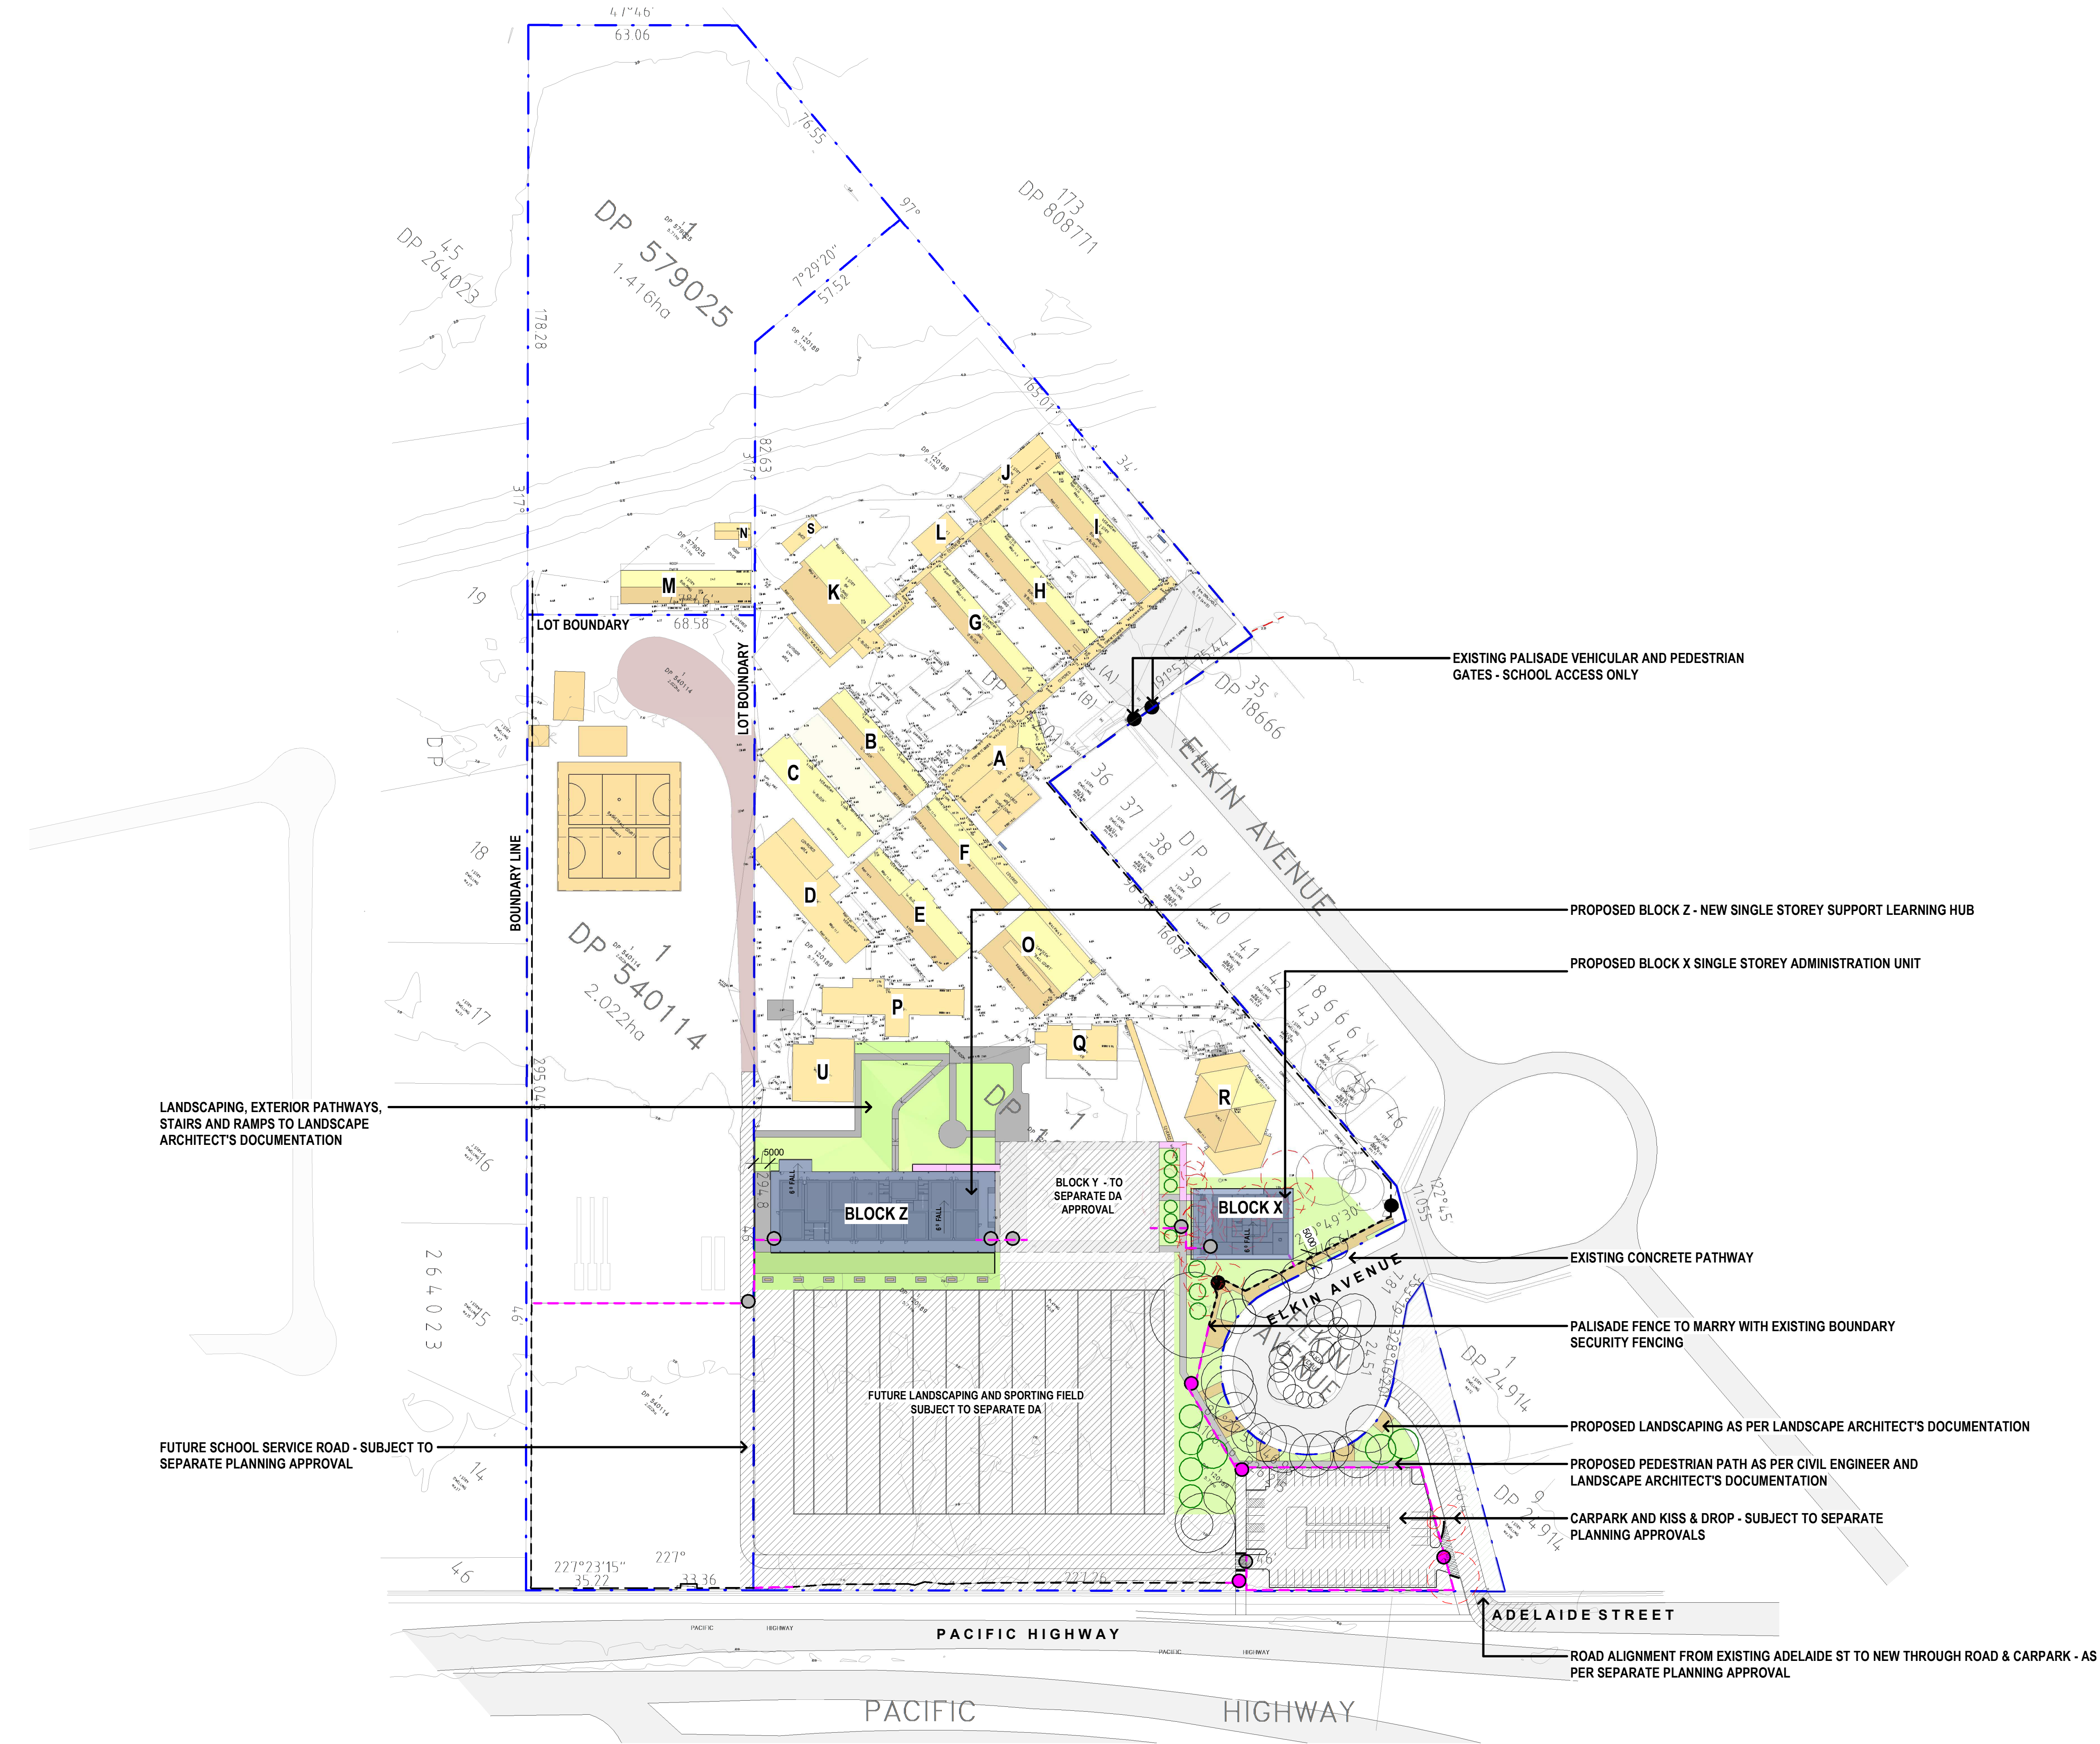

LEGEND


- CONSTRUCTION LEGEND:
- PROPOSED NEW BUILDINGS/ COVERED PATHWAYS
 - EXISTING BUILDINGS
 - FUTURE SITE DEVELOPMENT WORKS
SUBJECT TO SEPARATE PLANNING APPROVAL
 - PROPOSED COVERED WALKWAYS
 - PROPOSED UNCOVERED PEDESTRIAN PATH
 - PROPOSED LANDSCAPED AREA AS PER LANDSCAPE
ARCHITECT'S DOCUMENTATION
 - PROPERTY BOUNDARY LINE
 - EXISTING PALISADE FENCING
 - FUTURE FENCING AS PER SEPARATE PLANNING APPROVAL.
 - EXISTING PALISADE GATE TO BE RETAINED
 - FUTURE SECURITY ACCESS GATES TO BOUNDARY
FENCING (EXTERIOR SECURITY) SUBJECT TO
SEPARATE PLANNING APPROVAL
 - FUTURE CONTROLLED ACCESS GATES TO INTERNAL
SCHOOL ACCESS FENCING SUBJECT TO SEPARATE
PLANNING APPROVAL
 - PROPOSED TREES TO LANDSCAPE ARCHITECT'S
DOCUMENTATION
 - EXISTING TREES TO REMAIN TO LANDSCAPE
ARCHITECT'S DOCUMENTATION
 - EXISTING TREES TO BE REMOVED TO LANDSCAPE
ARCHITECT'S DOCUMENTATION

NOTE:
REFER SSU DRAFT SECURITY DESIGN FOR SITE & BUILDING SECURITY & ACCESS
REQUIREMENTS, AS WELL AS GATE TYPES, AUTOMATION & ELECTRONIC ACCESS &
MONITORING REQUIREMENTS.

REFER TO A-REF-050 TYPICAL COVERED WALKWAY - FOR GENERAL CONSTRUCTION
DETAILS

REFER TO LANDSCAPE ARCHITECT DOCUMENTATION AND ARBORIST REPORT FOR
EXISTING TREES TO BE RETAINED, REMOVED AND NEW PLANTING DETAILS

REFER TO ELECTRICAL ENGINEER'S DOCUMENTATION FOR LOCATION OF NEW MSB/
MDB. EFFECTED AND DISTURBED AREA TO BE MADE GOOD WHERE WORKS PASS
THROUGH EXISTING SCHOOL SITE.

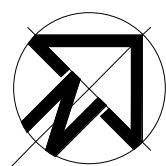

REV	DATE	COMMENTS
A	29/06/2023	ISSUE FOR REF 1
B	11/07/2023	ISSUE FOR REF 1
C	25/08/2023	REF 1 ISSUE
D	11/01/2024	REVISED REF 1 SITE PLAN
E	15/01/2024	REVISED REF 1 ISSUE
F	27/03/2024	REVISED REF 1 SD FOR COORDINATION
G	08/04/2024	REVISED REF 1 ISSUE
H	17/04/2024	REF 1 ISSUE

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PROJECT: Hunter River High School Upgrade
36 Elkin Ave,
Heatherbrae
NSW 2324

DRAWING: Site Plan

CLIENT: School Infrastructure NSW




DRAWN: MJD
DATE: 08/04/2024 As indicated @ A1
SCALES: 1: 2000 @ A3


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PHASE: SD
DRAWING No: A-REF-010
REV: H

REF 1




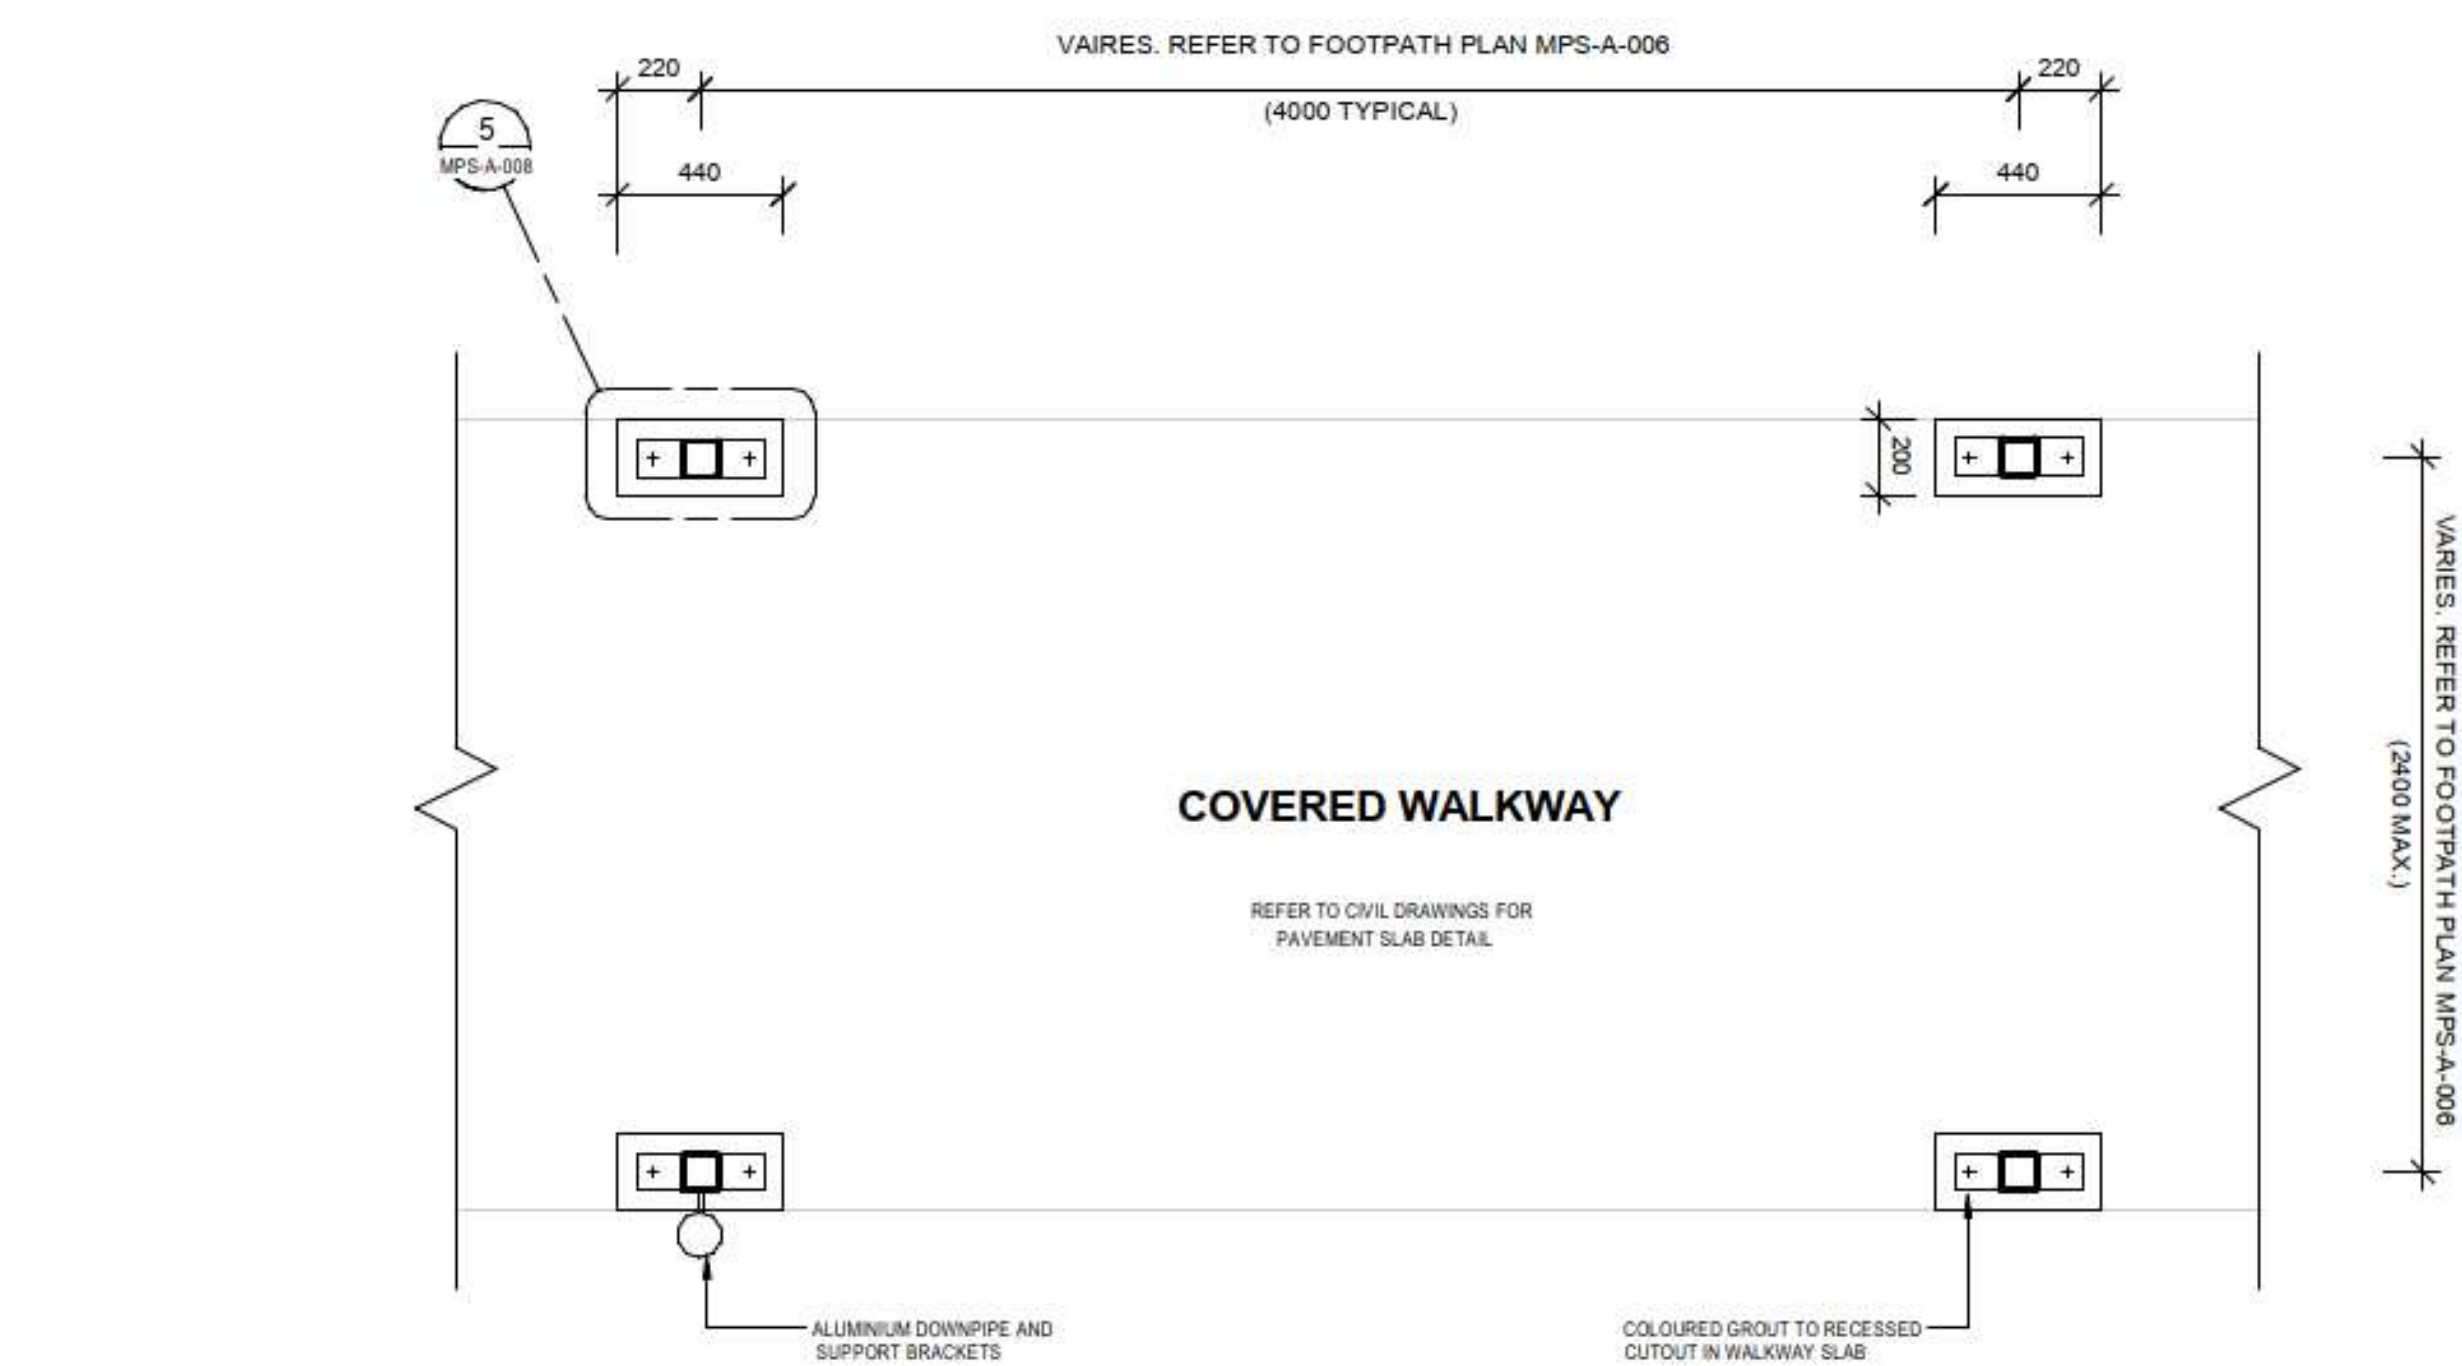


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TYPICAL AWNING PLAN

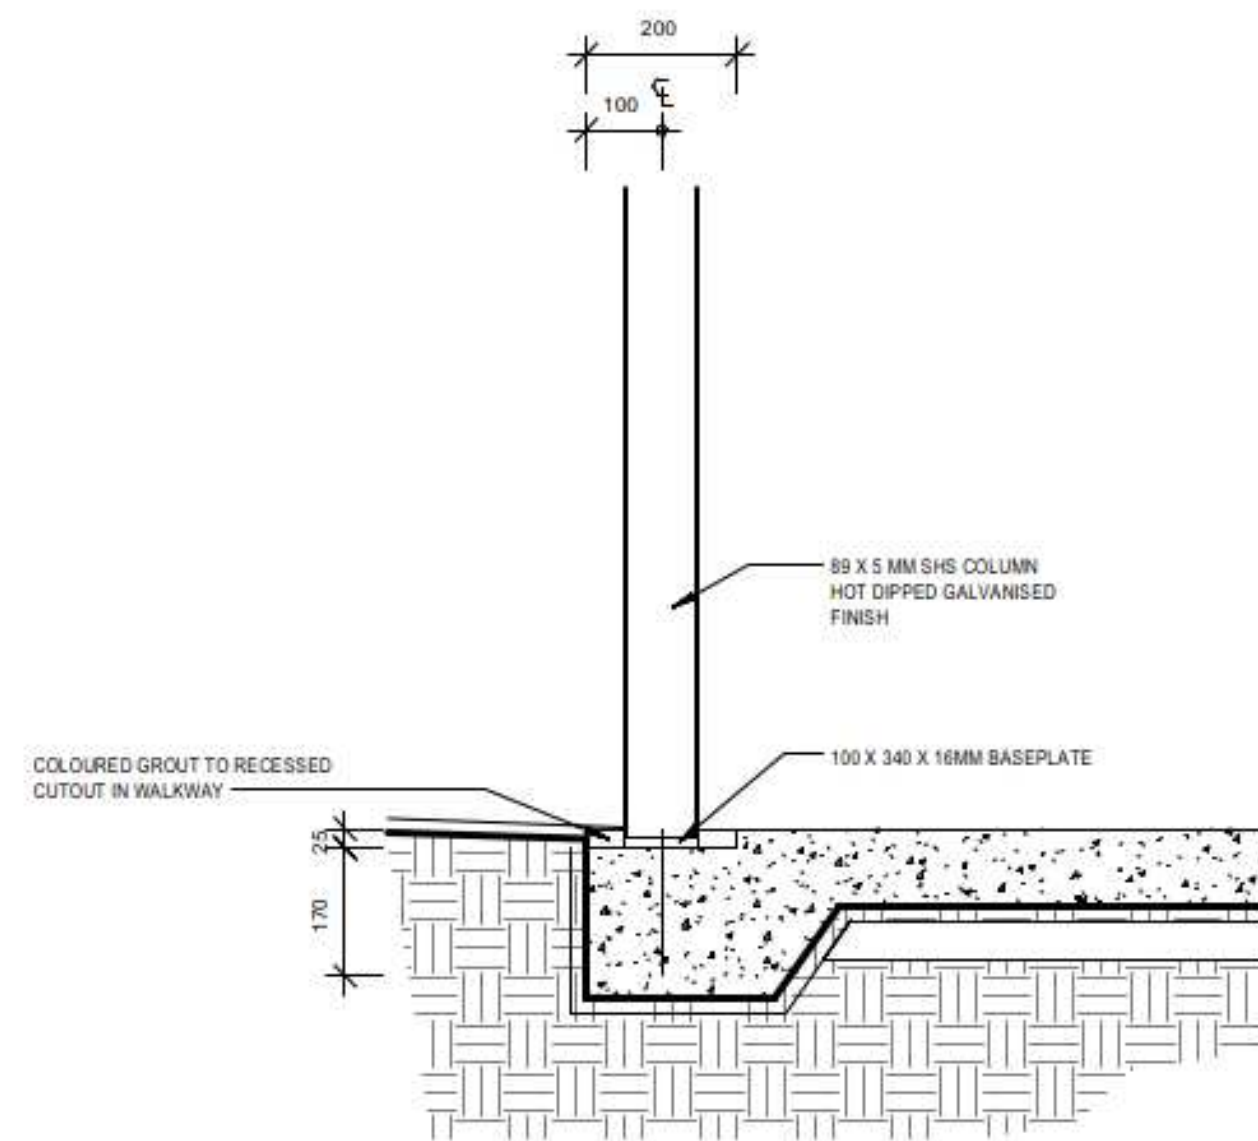


2
1 : 10
TYPICAL AWNING SECTION - COLUMN TO FLOOR JUNCTION

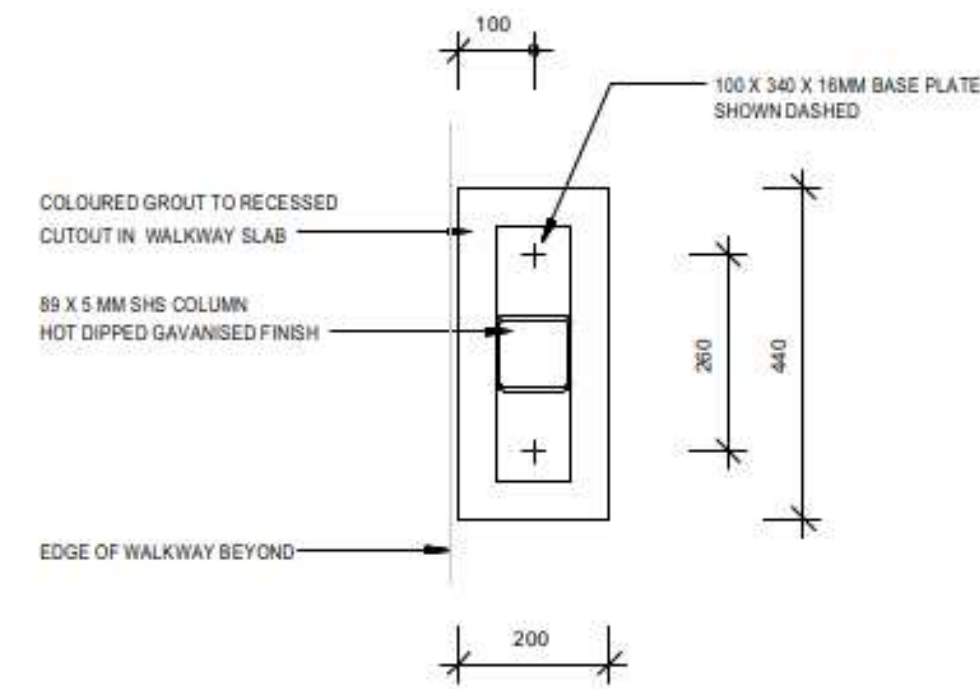

3
1 : 10
TYPICAL AWNING PLAN - FOOTING

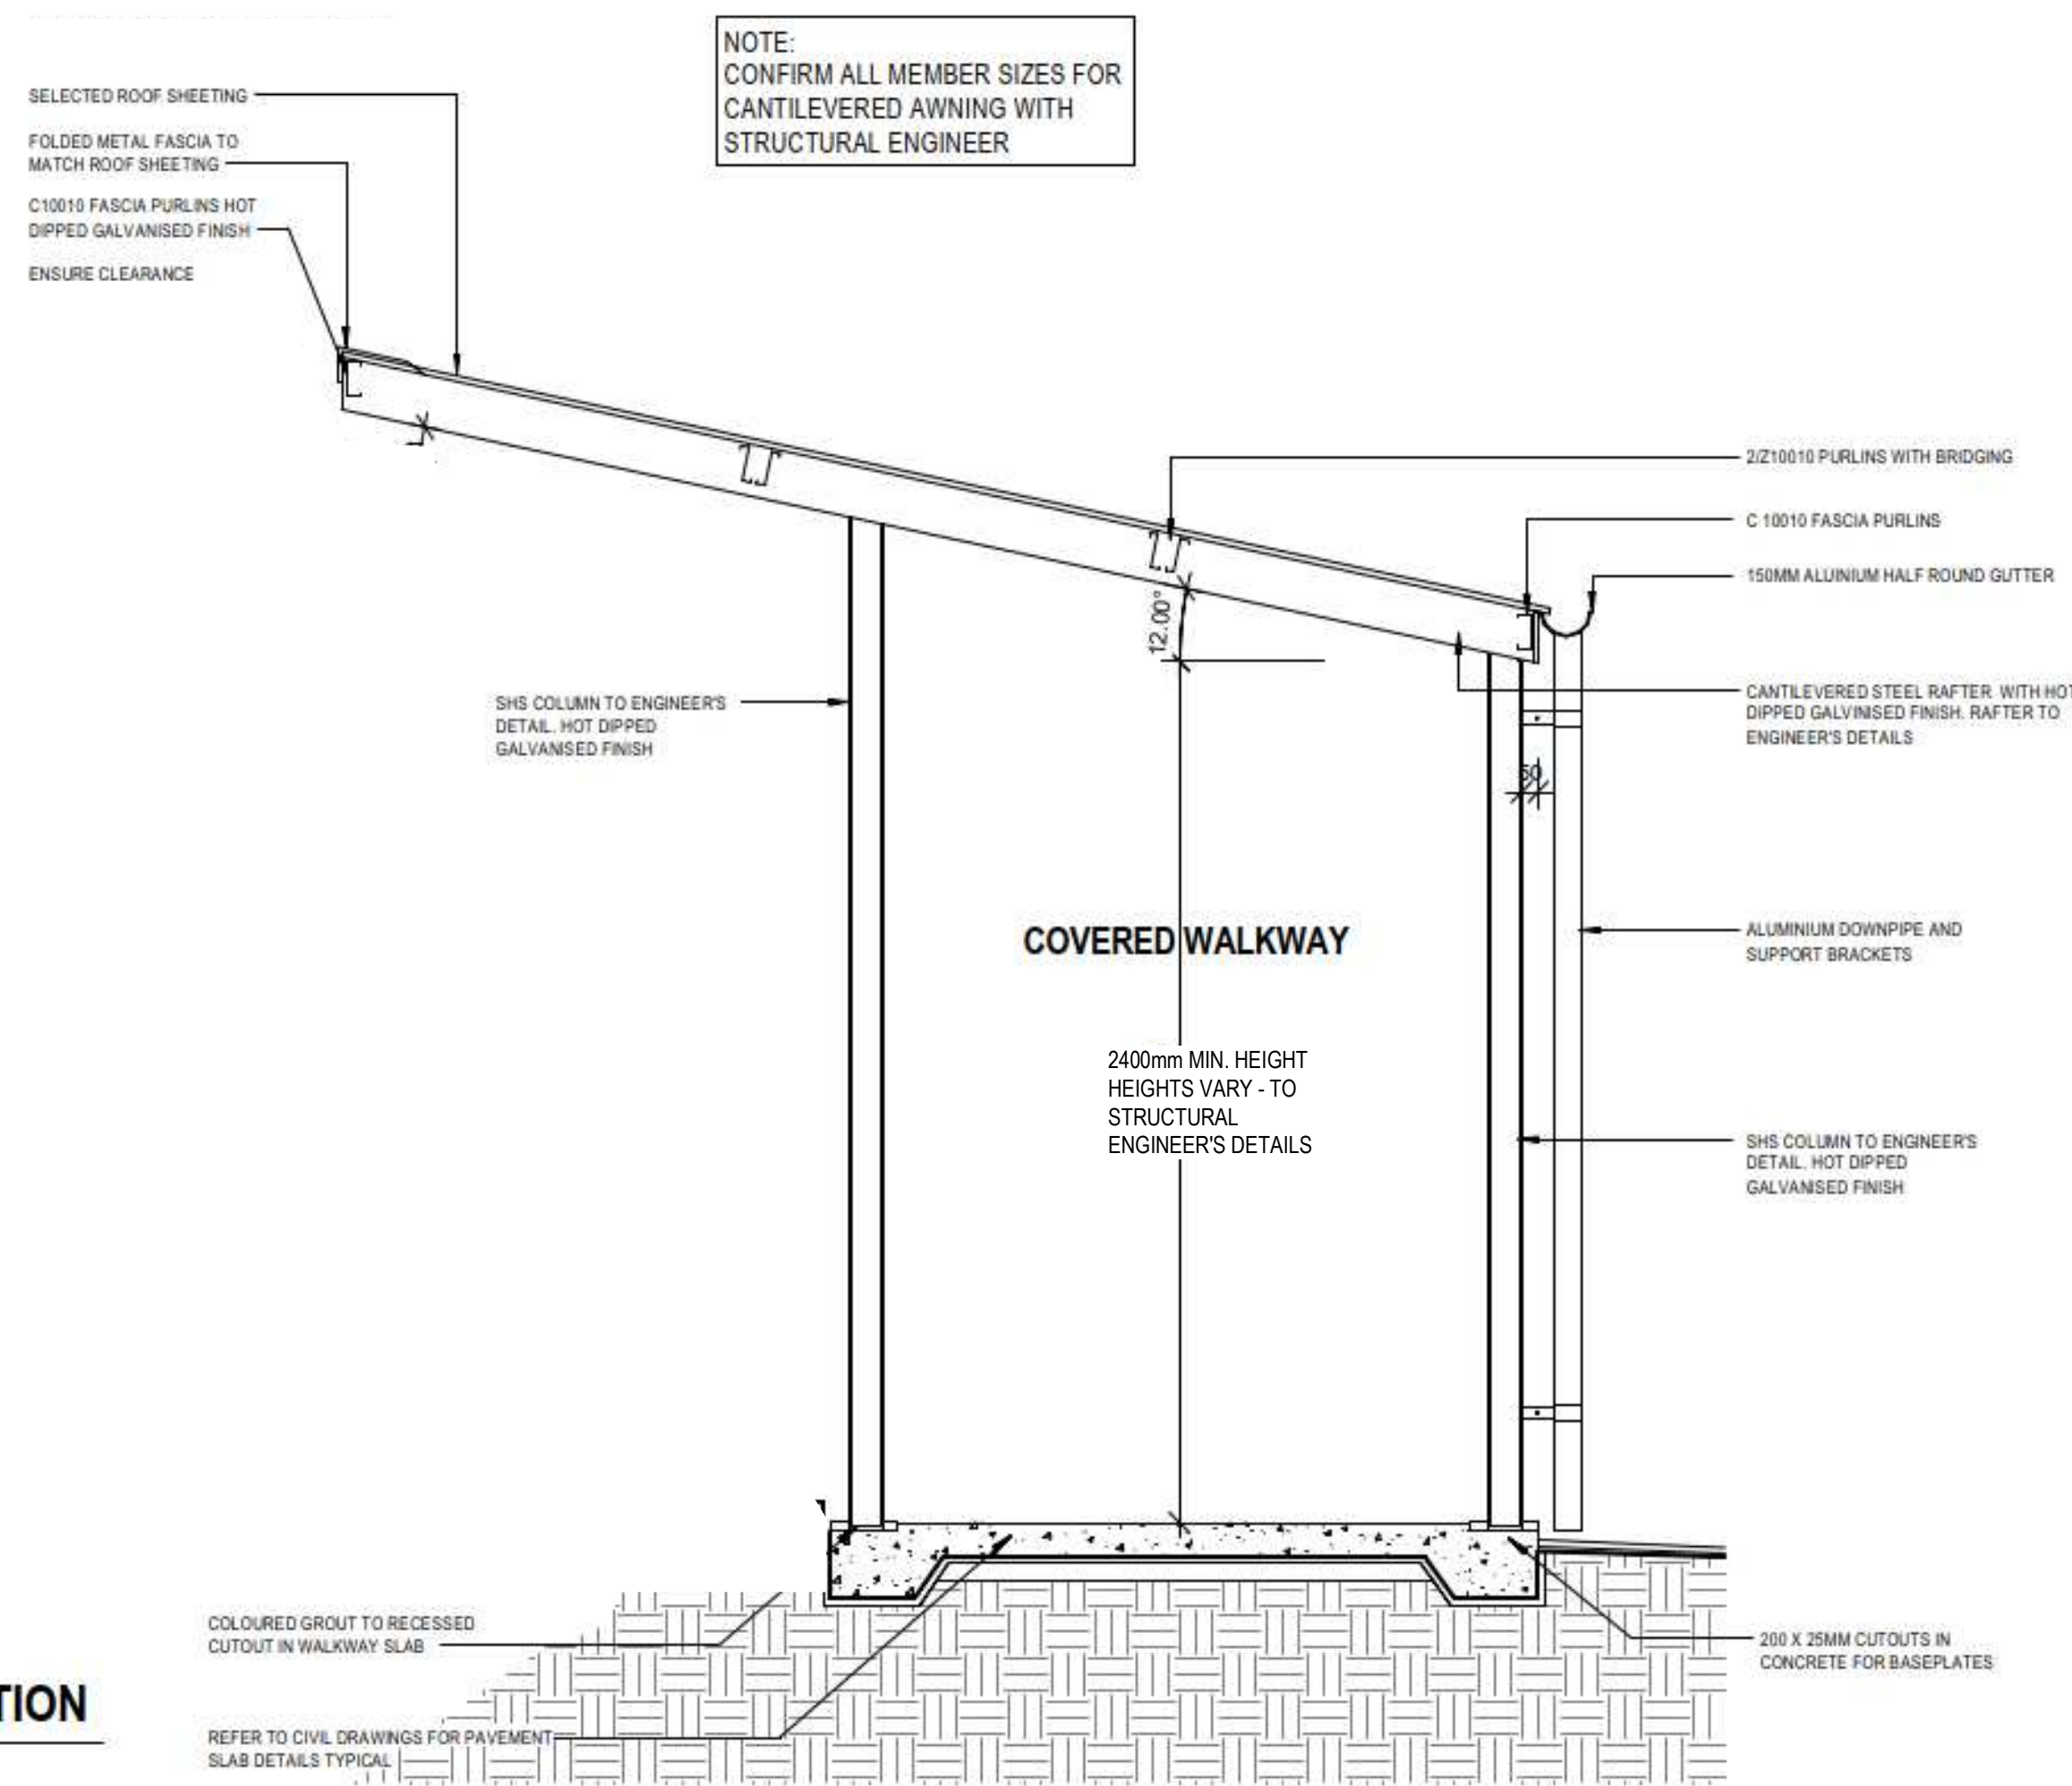

4
1 : 20
TYPICAL UPPER AWNING SECTION

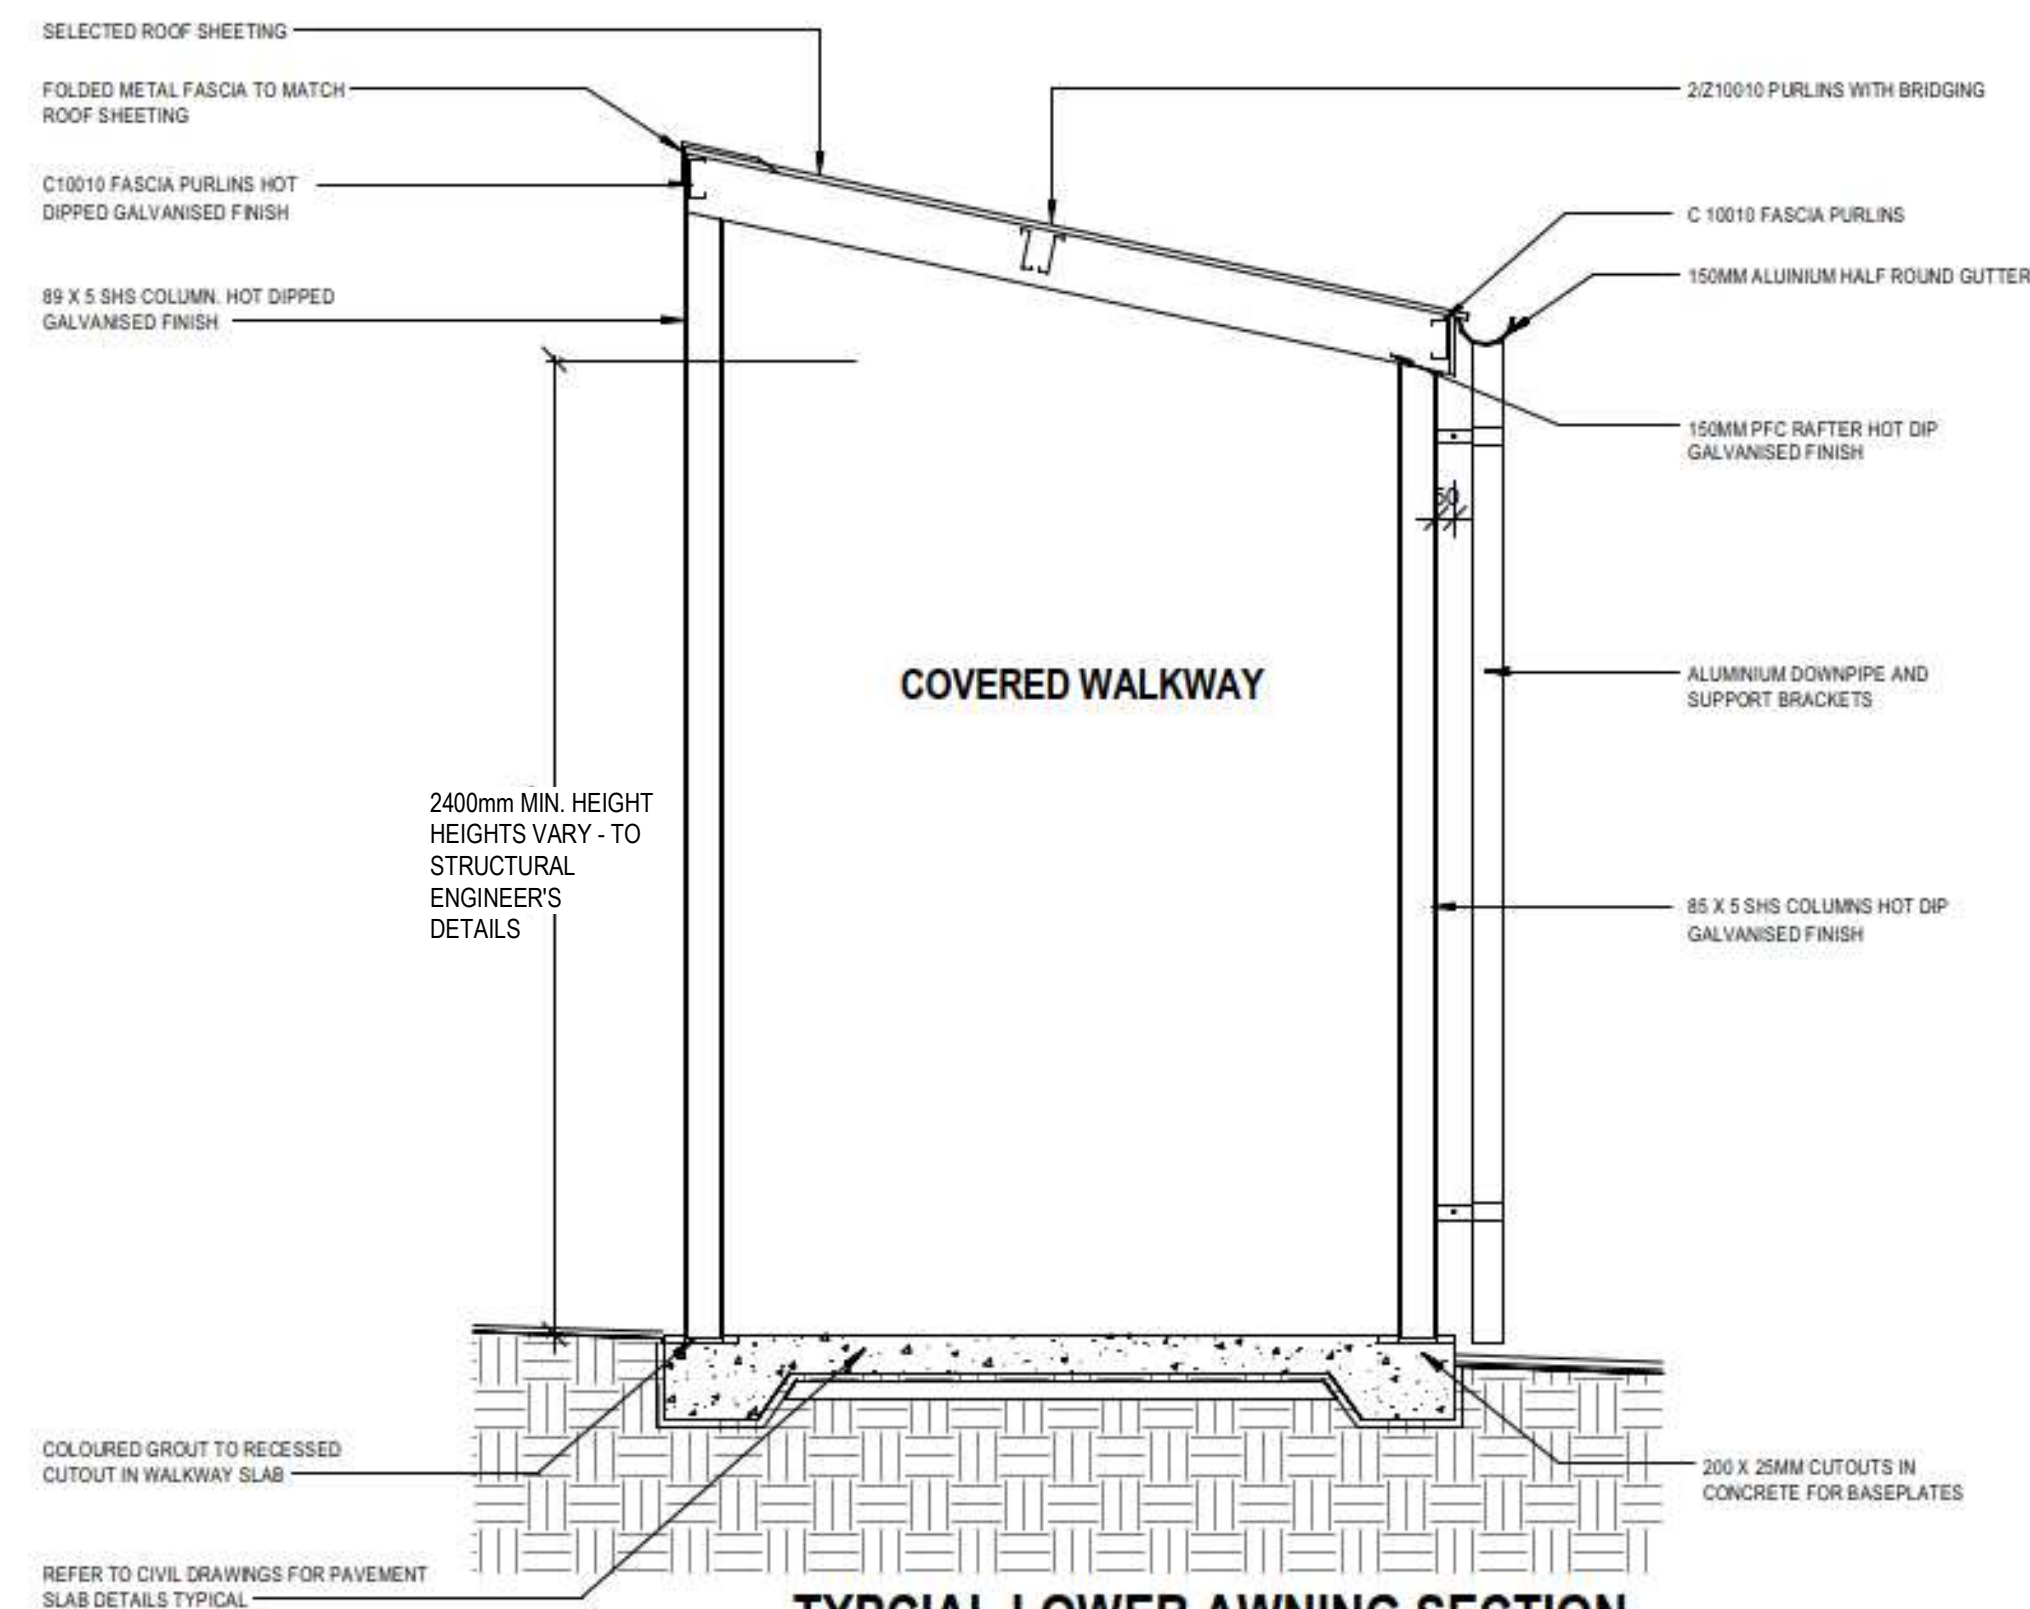

5
1 : 20
TYPICAL LOWER AWNING SECTION

ADMIN
GROUND FLOOR



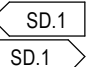

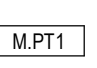
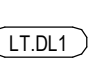


LEGEND

ABBREVIATIONS	
CC1 -	CONCRETE COLUMN AS SCHEDULED BY ENG.
SC -	STEEL COLUMN AS SCHEDULED BY ENG.
SC-FR -	FIRE RATED STEEL COLUMN
CC2 -	CONCRETE CIRCULAR COLUMN AS SCHEDULED BY ENG.
FFL -	FLOOR FINISH LEVEL
BAL -	BALUSTRADE
TGSI -	TACTILE GROUND SURFACE INDICATORS

FLOOR FINISHES	
CPT.01 -	CARPET TYPE 1 AS SCHEDULED
CPT.02 -	CARPET TYPE 2 AS SCHEDULED
VF.01 -	VINYL TYPE 1 AS SCHEDULED
VF.02 -	VINYL TYPE 2 AS SCHEDULED
VF.03 -	VINYL TYPE 3 AS SCHEDULED
CONC.01 -	CONCRETE FLOOR AS SCHEDULED
TL.01 -	TILE TYPE 1 AS SCHEDULED
TSF.01 -	TIMBER SPRUNG FLOORING AS SCHEDULED

SECURITY LEVEL CATEGORY	
(A)	LEVEL A
(B)	LEVEL B
(C)	LEVEL C
(D)	LEVEL D
(E)	LEVEL E

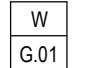NOTE: SECURITY CATEGORY TO BE READ IN CONJUNCTION WITH NSW EFSG SCHOOLS SECURITY GUIDELINES

STANDARD TAGS	
	WINDOW TAG TOP LINE IS THE "WINDOW IDENTIFIER" BOTTOM LINE IS THE "LEVEL WINDOW NUMBER" ie. (G) GROUND LEVEL, (01) WINDOW 1 ON THAT LEVEL
	DOOR TAG TOP LINE IS THE "DOOR IDENTIFIER" BOTTOM LINE IS THE "LEVEL DOOR NUMBER" ie. (G) GROUND LEVEL, (01) DOOR 1 ON THAT LEVEL
	WALL TAG "WALL MAKEUP/TYPE IDENTIFIER WALL TYPE NUMBER" ie. (S) STEEL STUD (D) 92mm, (1) TYPE 1
	JOINERY TAG "JOINERY IDENTIFIER JOINERY NUMBER" ie. (JR) JOINERY, (1) JOINERY ITEM 1
	MATERIAL TAG "MATERIAL IDENTIFIER MATERIAL FINISH NUMBER" ie. (M) MATERIALS, (PT) PAINT FINISH (1) TYPE 1
	GENERAL TAG "CATEGORY/SCHEDULE IDENTIFIER ITEM IDENTIFIER ITEM TYPE" ie. (LT) LIGHTING, (DL) DOWNLIGHT (1) TYPE 1
	REVISION TAG IN TRIANGLE IS REVISION NUMBER OUTSIDE TRIANGLE IS CHANGE COMMENT ie. COMMENT MIGHT BE "DOOR ADDED"
	GATE TAG TOP LINE IS THE "GATE IDENTIFIER" BOTTOM LINE IS THE "LEVEL GATE NUMBER" ie. (G) GROUND LEVEL, (01) DOOR 1 ON THAT LEVEL


Joinery - Admin/ Block X

CODE	DESCRIPTION
J.04	RECEPTION COUNTER
J.05	CLINIC BENCH
J.06	KITCHEN BACK BENCH
J.07	KITCHEN ISLAND JOINERY
J.08	UTILITY BENCH
J.11	ADMIN/CLERICAL STORAGE BENCH UNIT

NOTE:


CONTRACTOR TO ALLOW PROVISIONS FOR WALL MOUNTED MONITOR TO PUBLIC ENTRY, INTERVIEW ROOM 1, INTERVIEW ROOM 2 AND PRINCIPAL'S OFFICE.

REF 1

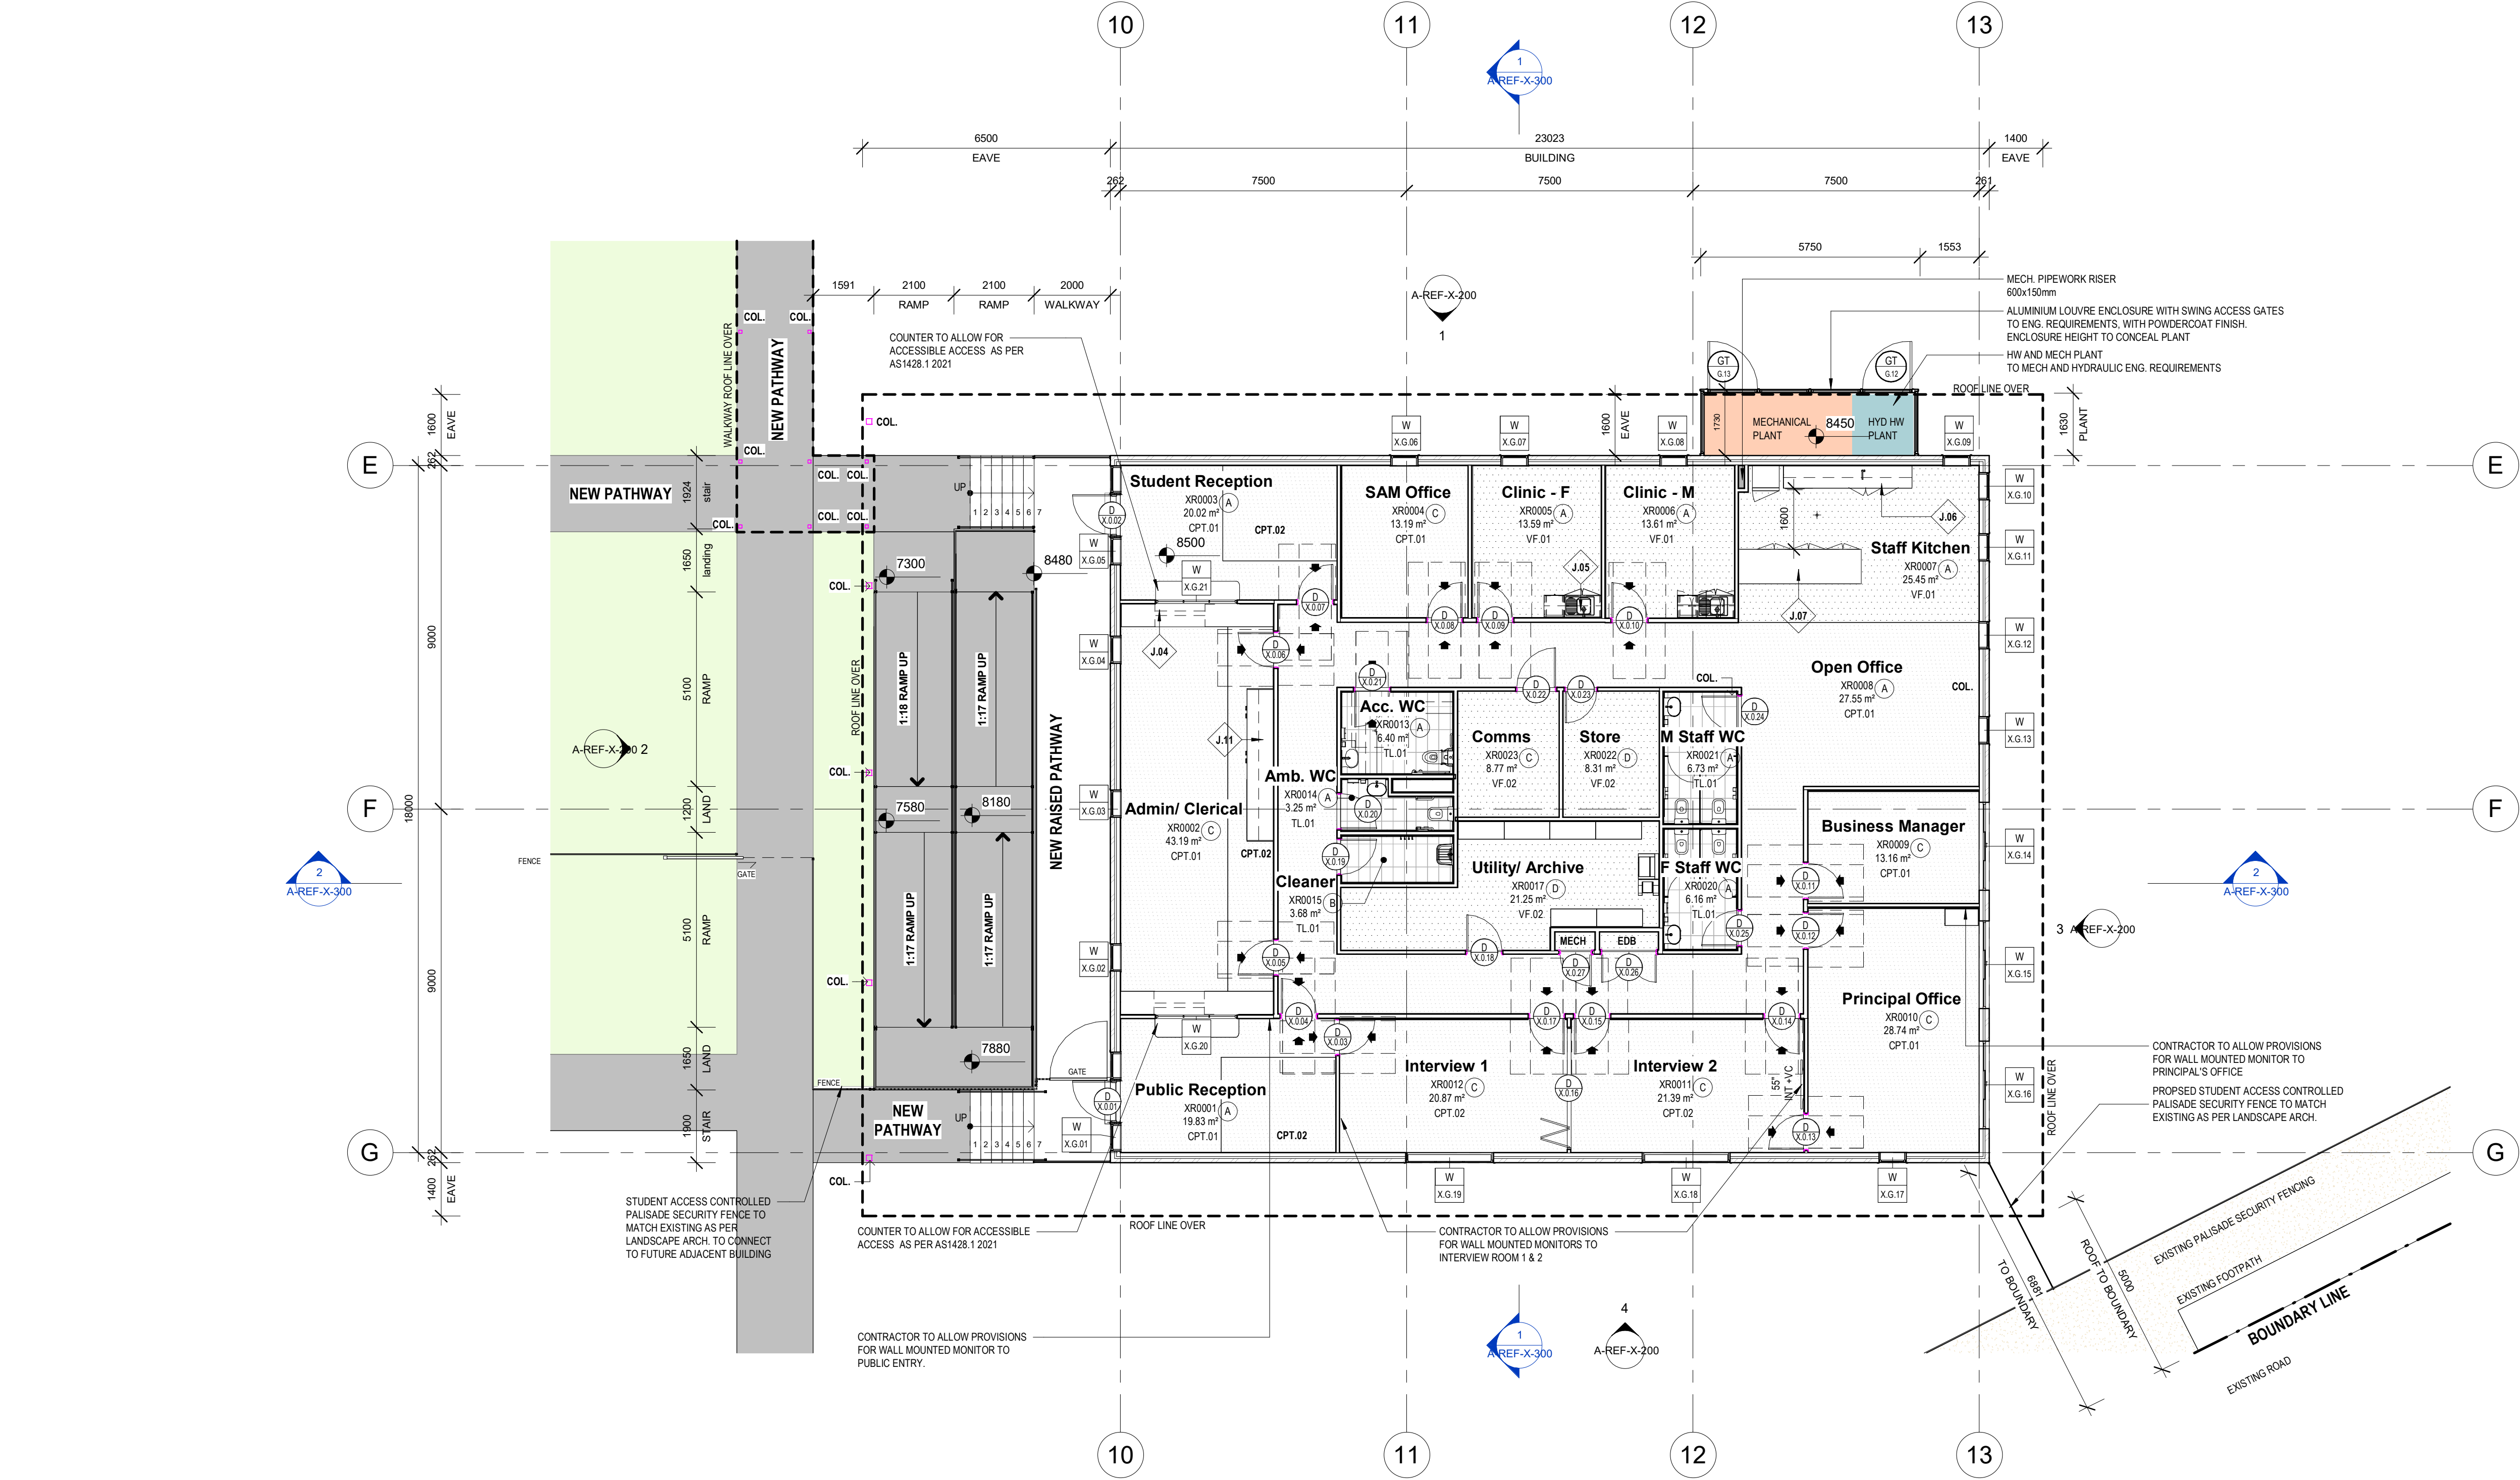

1m 5m 2m 10m
SCALE = 1:100 A1 / 1:200 A3

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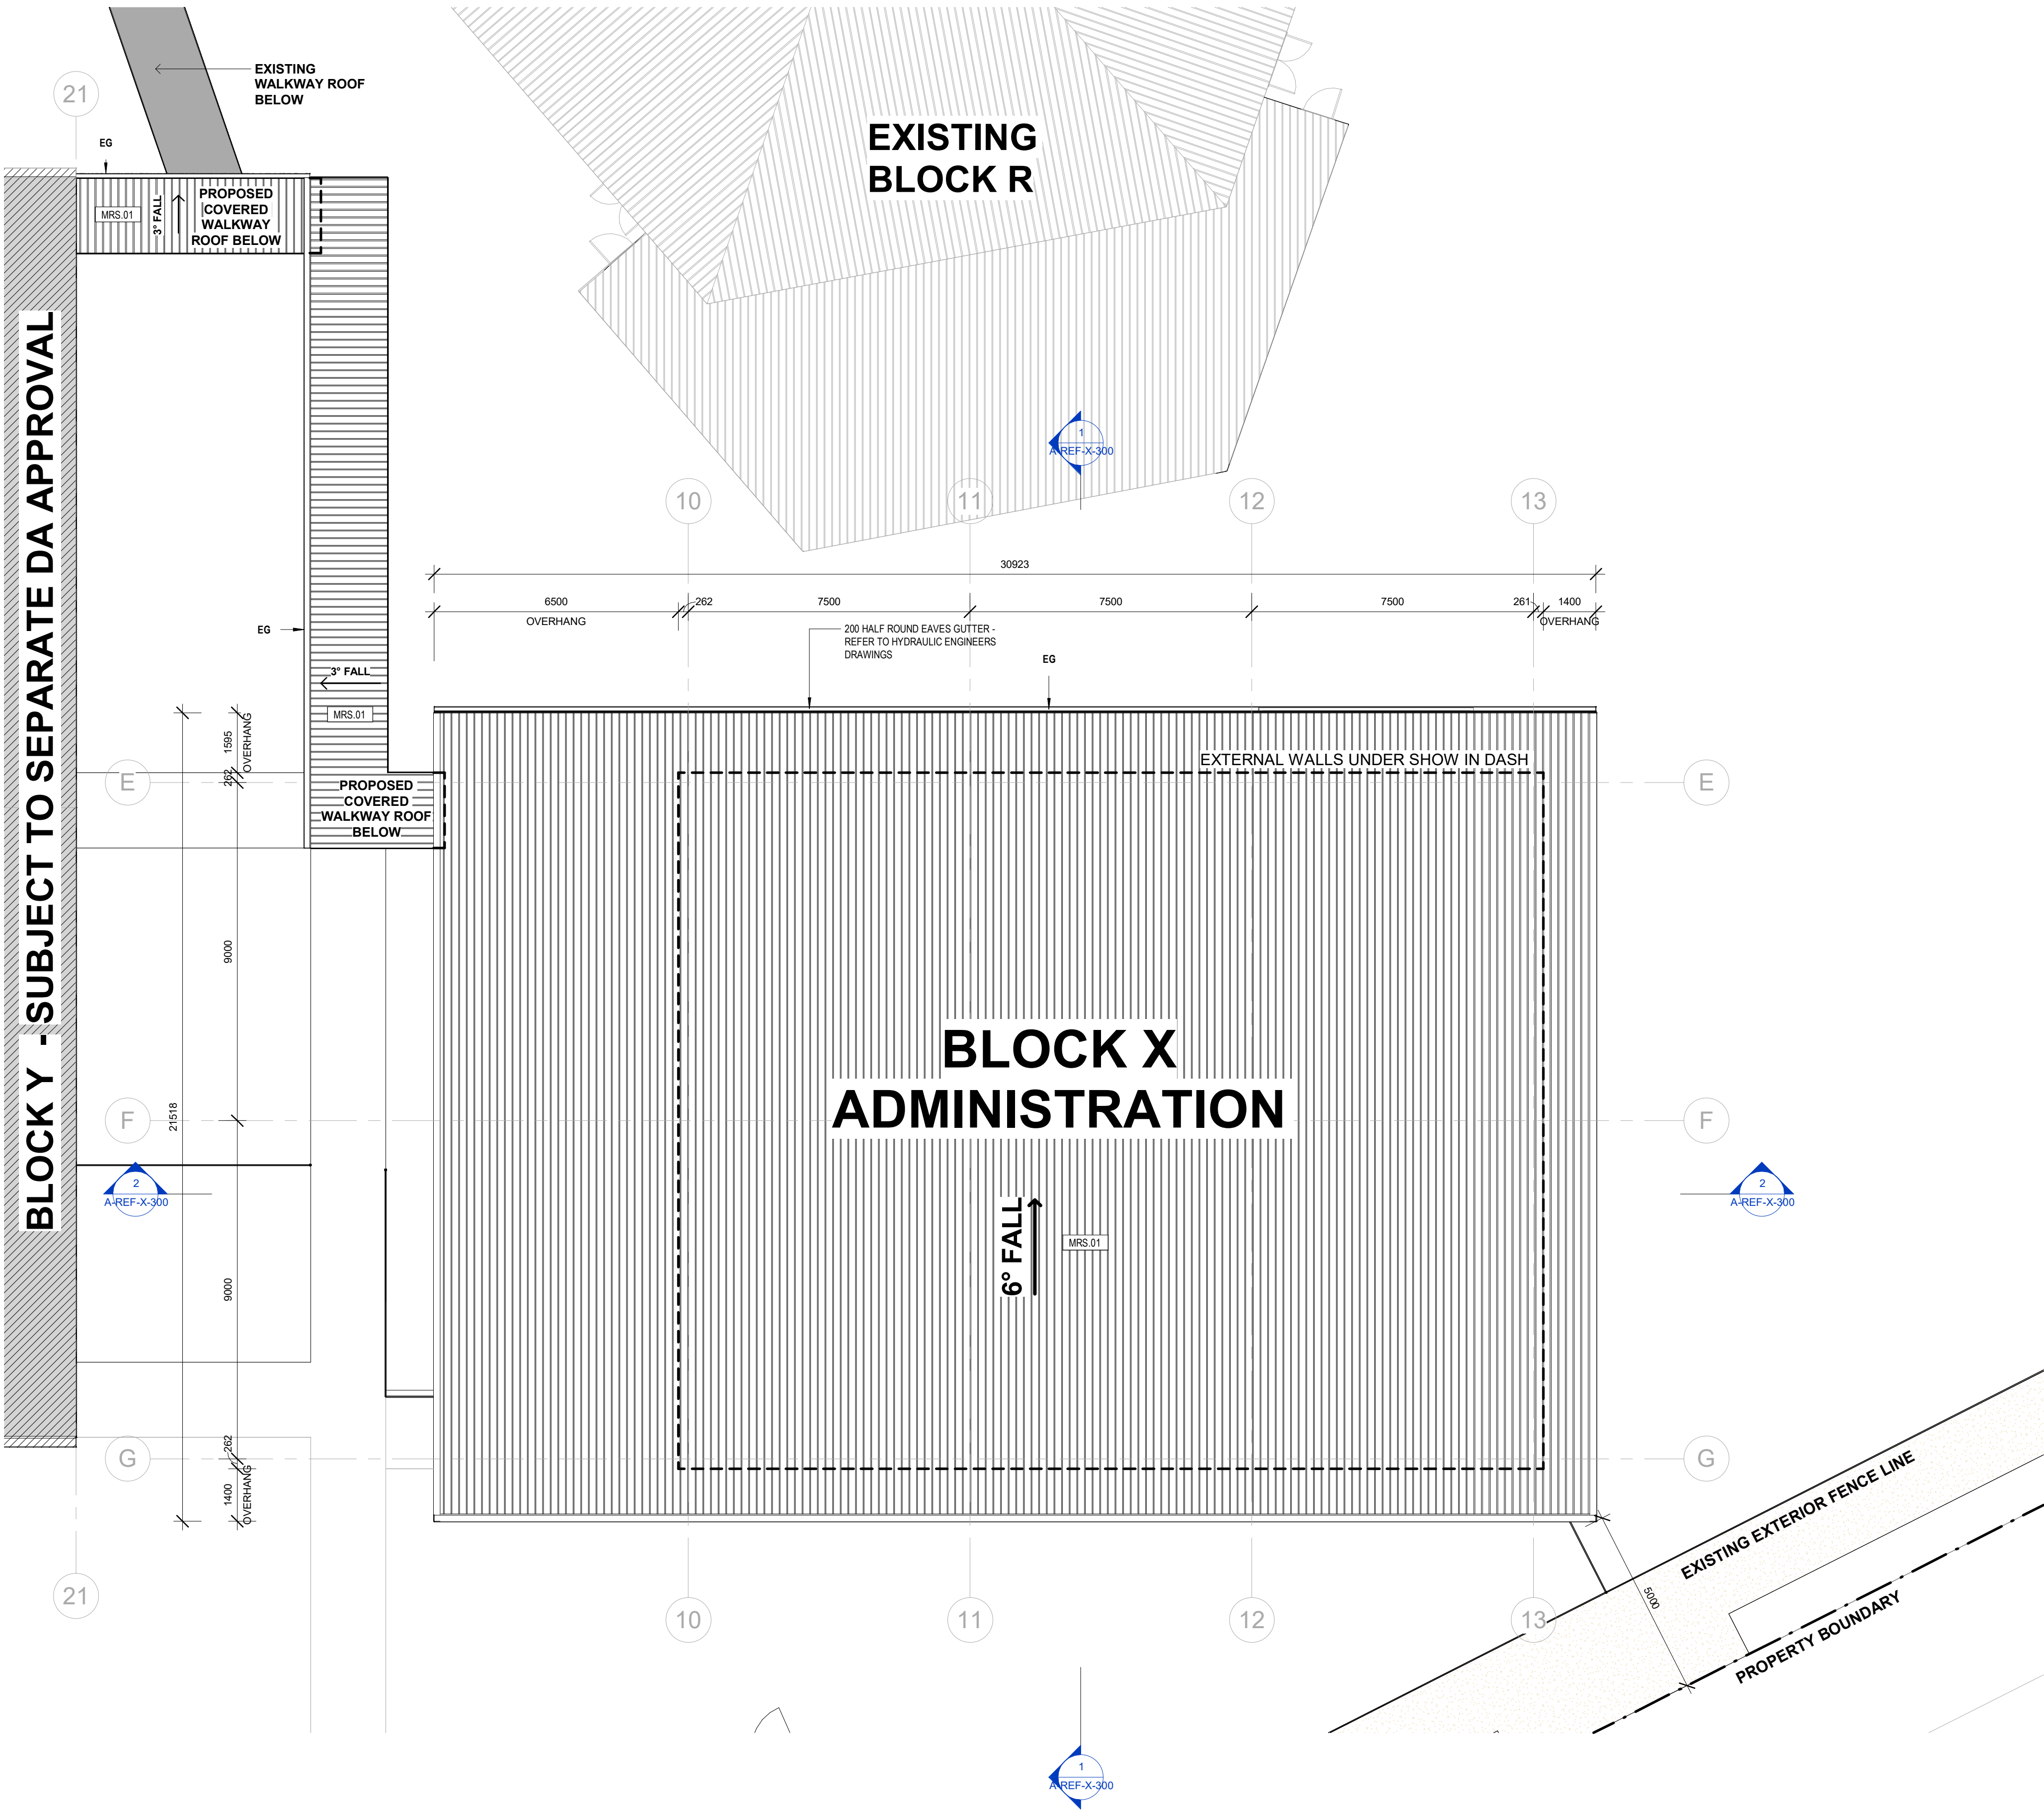
CLIENT: School Infrastructure NSW

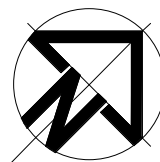DRAWING: Admin - Block X - Ground Floor Plan



DRAWN: MJD
DATE: 08/04/2024 As indicated@ A1
SCALE: 1:200 @ A3
PROJECT No: 14276
PHASE: SD A-REF-X-100
DRAWING No: F


ADMIN
ROOF PLAN




LEGEND

ABBREVIATIONS
EG- EAVES GUTTER AS HYDRAULIC ENG.
DP- DOWN PIPES AS HYDRAULIC ENG.
MRS- METAL ROOF SHEETING - AS SCHEDULED

NOTE:
1. ROOF CEILING ENVELOPE R3.7 (DOWNWARDS) SOLAR ABSORBANCE NO MORE THAN 0.45
2. ALL DOORS, OR ONE LEAF OF A DOUBLE DOOR, ARE TO HAVE A CLEAR UNOBSTRUCTED OPENING WIDTH OF MIN. 850MM

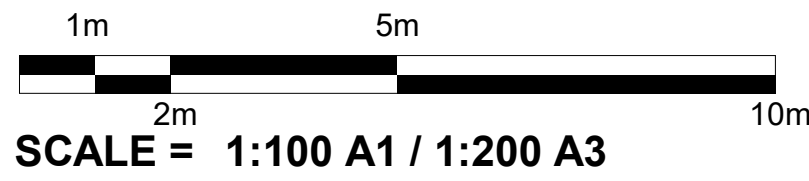

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36 Elkin Ave,
Heatherbrae
NSW 2324
DRAWING: Admin - Block X - Roof Plan

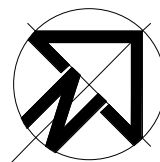CLIENT: School Infrastructure NSW



DRAWN: MJD
DATE: 08/04/2024
As indicated@ A1
1 : 200 @ A3
PROJECT No: 14276
PHASE: SD
DRAWING No: A-REF-X-110
REV: F









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ADMIN


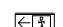







GROUND FLOOR RCP

CEILING FINISHES LEGEND - ADMINISTRATION BLOCK X

- | | | | | | |
|---|--|---|--|---|--------------------------------------|
|  | CLG-101
FLUSH PLASTERBOARD
PAINT FINISH |  | CLG-105
NRC >0.85 HIGHLY ABSORPTIVE CEILING |  | SL.01
SOFFIT LINING - SHEET METAL |
|  | CLG-102
MOISTURE RESISTANT PLASTERBOARD
PAINT FINISH |  | CLG-106
FIRE RATED PLASTERBOARD
PAINT FINISH | | |
| | |  | CLG-107, CLG-108 & CLG-109
PRE-FINISHED FC | | |
|  | CLG-104
NRC: 0.6 - 0.8 ABSORPTIVE CEILING |  | FC.01
PRE-FINISHED AS SCHEDULE | | |


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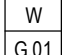

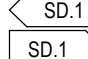

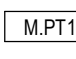
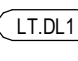


- | | |
|----|---|
| A1 | RECESSED/ SURFACED LED LIGHT TYPE 1 - REFER TO ELECTRICAL ENG. DRAWINGS |
| B1 | LED BATTEN LIGHT TYPE 1 - REFER TO ELECTRICAL ENG. DRAWINGS |
| D1 | RECESSED LED DOWNLIGHT TYPE 1 - REFER TO ELECTRICAL ENG. DRAWINGS |
| D2 | RECESSED LED DOWNLIGHT TYPE 2 - REFER TO ELECTRICAL ENG. DRAWINGS |
| S1 | SURFACE MOUNTED LED OYSTER LIGHT - REFER TO ELECTRICAL ENG. DRAWINGS |
| W1 | SURFACE MOUNTED LED WALL LIGHT - REFER TO ELECTRICAL ENG. DRAWINGS |

- | | |
|---|---|
|  | ILLUMINATED EXIT SIGN - REFER TO ELECTRICAL ENG. DRAWINGS |
|  | DIRECTIONAL ILLUMINATED EXIT SIGN - REFER TO ELECTRICAL ENG. DRAWINGS |
|  | LED EMERGENCY LIGHT - REFER TO ELECTRICAL ENG. DRAWINGS |
|  | MOVEMENT SENSOR - REFER TO ELECTRICAL ENG. DRAWINGS |
|  | WALL FAN - REFER TO ELECTRICAL ENG. DRAWINGS (FINAL COLOUR AND LOCATIONS TO BE ADVISED BY ARCHITECT) |
|  | CEILING FAN - REFER TO ELECTRICAL ENG. DRAWINGS (FINAL COLOUR AND LOCATIONS TO BE ADVISED BY ARCHITECT) |
|  | RETURN EXHAUST AIR EGG CRATE GRILLE - REFER TO MECHANICAL ENG. DRAWINGS |
|  | ACCESS PANEL - REFER TO MECHANICAL ENG. DRAWINGS |
|  | CASSETTE STYLE AIR SUPPLY - REFER TO MECHANICAL ENG. DRAWINGS |

NOTE:


- 1. ROOF/ CEILING ENVELOPE R3.7 (DOWNWARDS) SOLAR ABSORBANCE NO MORE THAN 0.45**
- 2. CONTRACTOR TO REFER TO ACOUSTIC ENGINEERS REPORT FOR CEILING NRC REQUIREMENTS**
- 3. CONTRACTOR TO REFER TO AUDIO VISUAL CONSULTANT DRAWINGS AND REPORT FOR DETAILS ON BUILDING'S AV REQUIREMENTS**
- 4. REFER TO FIRE ENGINEER DOCUMENTATION FOR FIRE SAFETY CEILING ACCESSORIES/ SERVICES**

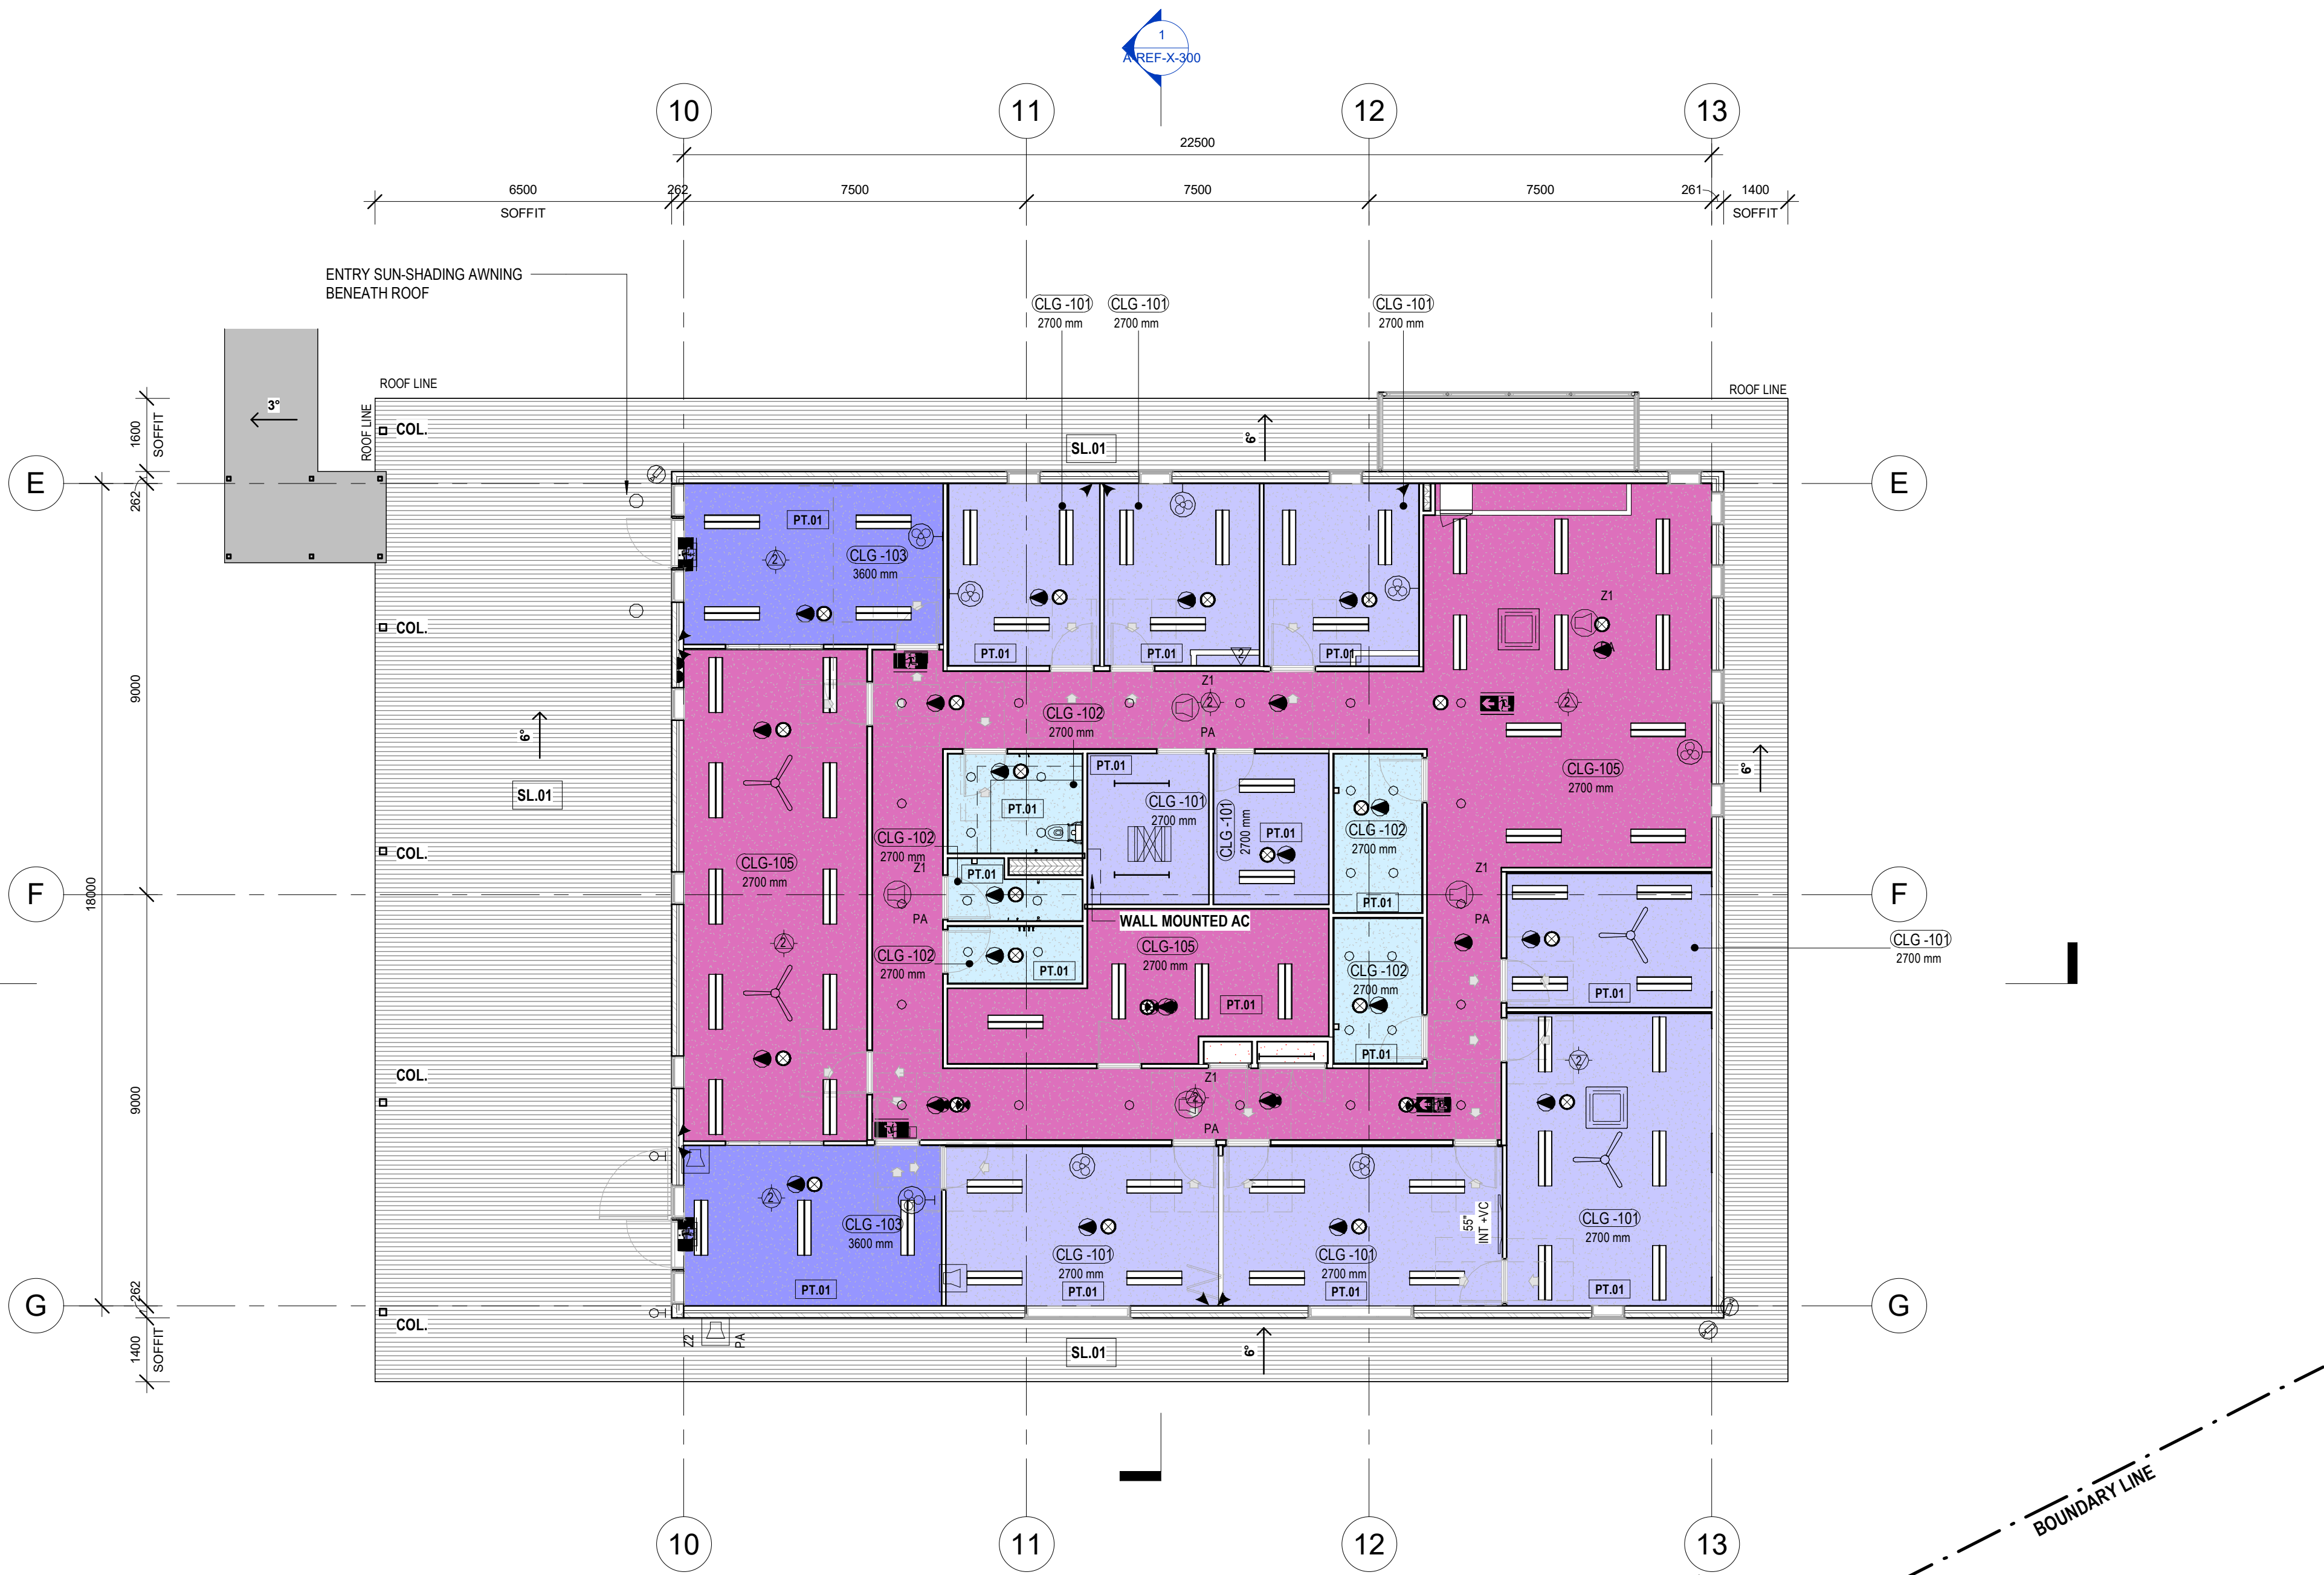

STANDARD TAGS	
	WINDOW TAG TOP LINE IS THE "WINDOW IDENTIFIER" BOTTOM LINE IS THE "LEVEL, WINDOW NUMBER" ie. (G) GROUND LEVEL, (01) WINDOW 1 ON THAT LEVEL
	DOOR TAG TOP LINE IS THE "DOOR IDENTIFIER" BOTTOM LINE IS THE "LEVEL, DOOR NUMBER" ie. (G) GROUND LEVEL, (01) DOOR 1 ON THAT LEVEL
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	MATERIAL TAG "MATERIAL IDENTIFIER, MATERIAL FINISH NUMBER" ie. (M) MATERIALS, (PT) PAINT FINISH (1) TYPE 1
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MATERIALS LEGEND

CODE	DESCRIPTION
ACP.02	ACOUSTIC PANEL AS SCHEDULED
ACP.03	ACOUSTIC PANEL AS SCHEDULED
CPT.01	CARPET TILE AS SCHEDULED
CPT.02	CARPET TILE AS SCHEDULED
CPT.03	CARPET TILE AS SCHEDULED
CST.01	COVERED SKIRTING TILE
CVS.02	COVERED VINYL SKIRTING AS SCHEDULED
FC.03	CEMENT WALL SHEETING FEATURE
FC.05	FIBRE CEMENT COLUMN CLADDING SHEETING
FLM.01	PRIVACY WINDOW FILM
LAM.01	LAMINATE TYPE 01 AS SCHEDULED
LAM.02	LAMINATE TYPE 02 AS SCHEDULED
LAM.03	LAMINATE TYPE 03 AS SCHEDULED
LAM.04	LAMINATE TYPE 04 AS SCHEDULED
PIN.01	PINBOARD FINISH TYPE 01 AS SCHEDULED
PIN.02	PINBOARD FINISH TYPE 02 AS SCHEDULED
PIN.03	PINBOARD FINISH TYPE 03 AS SCHEDULED
PT.01	PAINT FINISH AS SCHEDULED
PT.02	PAINT FINISH AS SCHEDULED
PT.03	PAINT FINISH AS SCHEDULED
RCS.01	RECONSTITUTED STONE BENCHTOP AS SCHEDULED
TL.01	SLIP RESISTANT TILE AS SCHEDULED
TL.02	WALL TILE AS SCHEDULED
TL.03	FEATURE WALL TILE AS SCHEDULED
TL.04	SLIP RESISTANT TILE AS SCHEDULED
VF.01	VINYL FLOORING TYPE 1 AS SCHEDULED
VF.02	VINYL FLOORING TYPE 2 AS SCHEDULED
VF.03	VINYL FLOORING TYPE 3 AS SCHEDULED

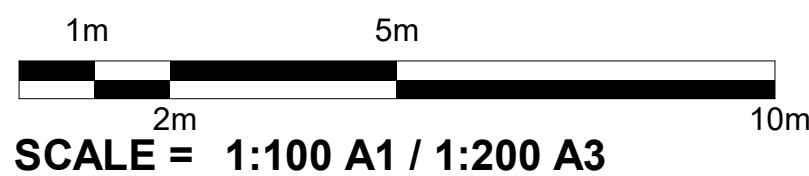


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E.J.E. 800-769-8443 • 264-6451 • 840 Nominatim Archibell - Benard County NSW Architects Registration No A438

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REV	DATE	COMMENTS
A	29/06/2023	ISSUE FOR REF 1
B	11/07/2023	ISSUE FOR REF 1
C	25/08/2023	REF 1 ISSUE
D	27/03/2024	REVISED REF1 SD FOR COORDINATION
E	08/04/2024	REVISED REF1 ISSUE
F	19/04/2024	REF1 ISSUE

[illegible]

PROJECT: Hunter River High School Upgrade
36 Elkin Ave,
Heatherbrae
NSW 2324

CLIENT: School Infrastructure NSW

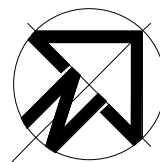

DRAWN : MJD DATE : 08/04/2024 As indicated@ A1
1 : 200 @ A3
Autodesk Docs/Hunter River High School/HRHS-EJE-JZ-ZZ-M3-A-0001.rvt
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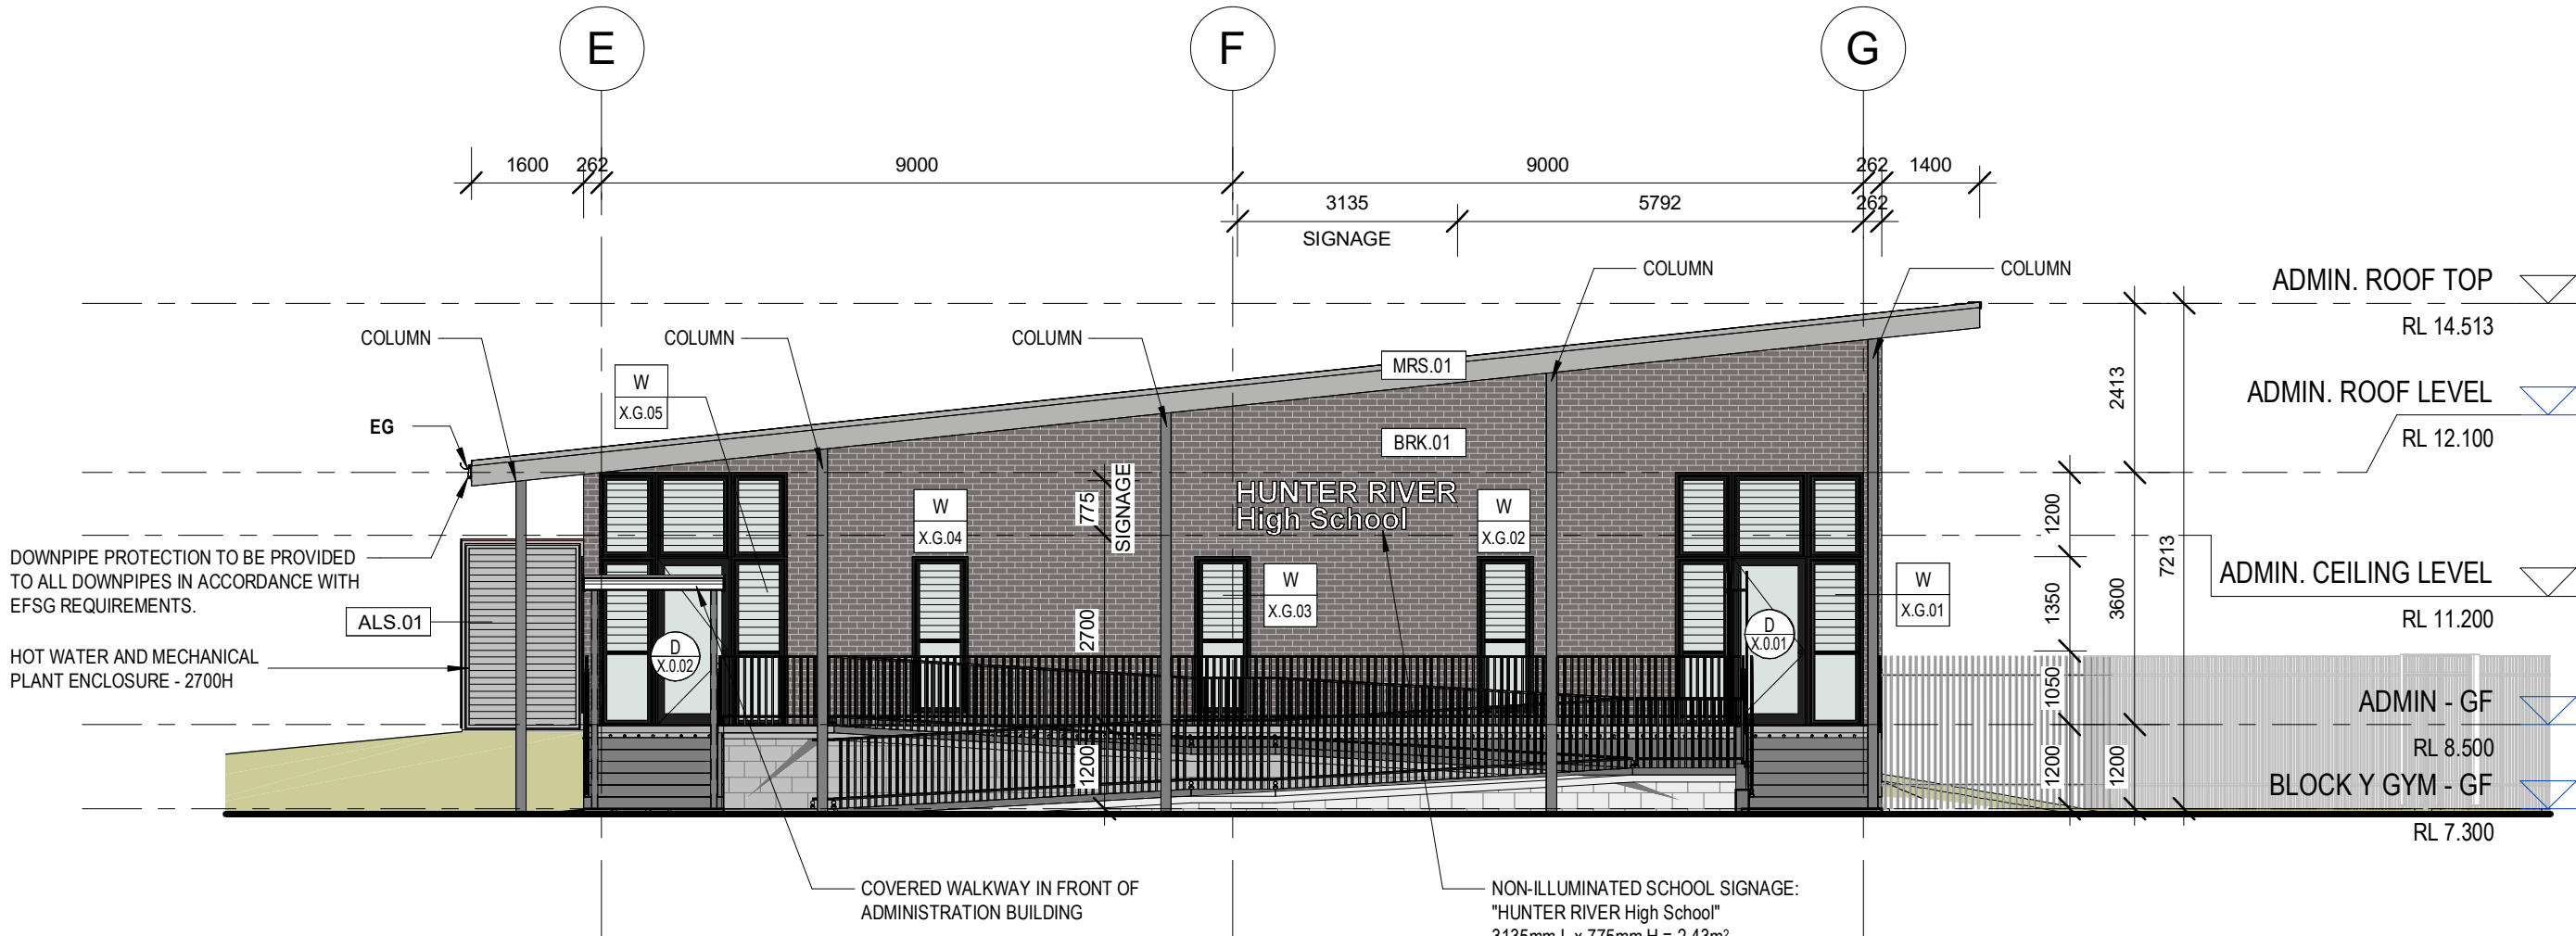
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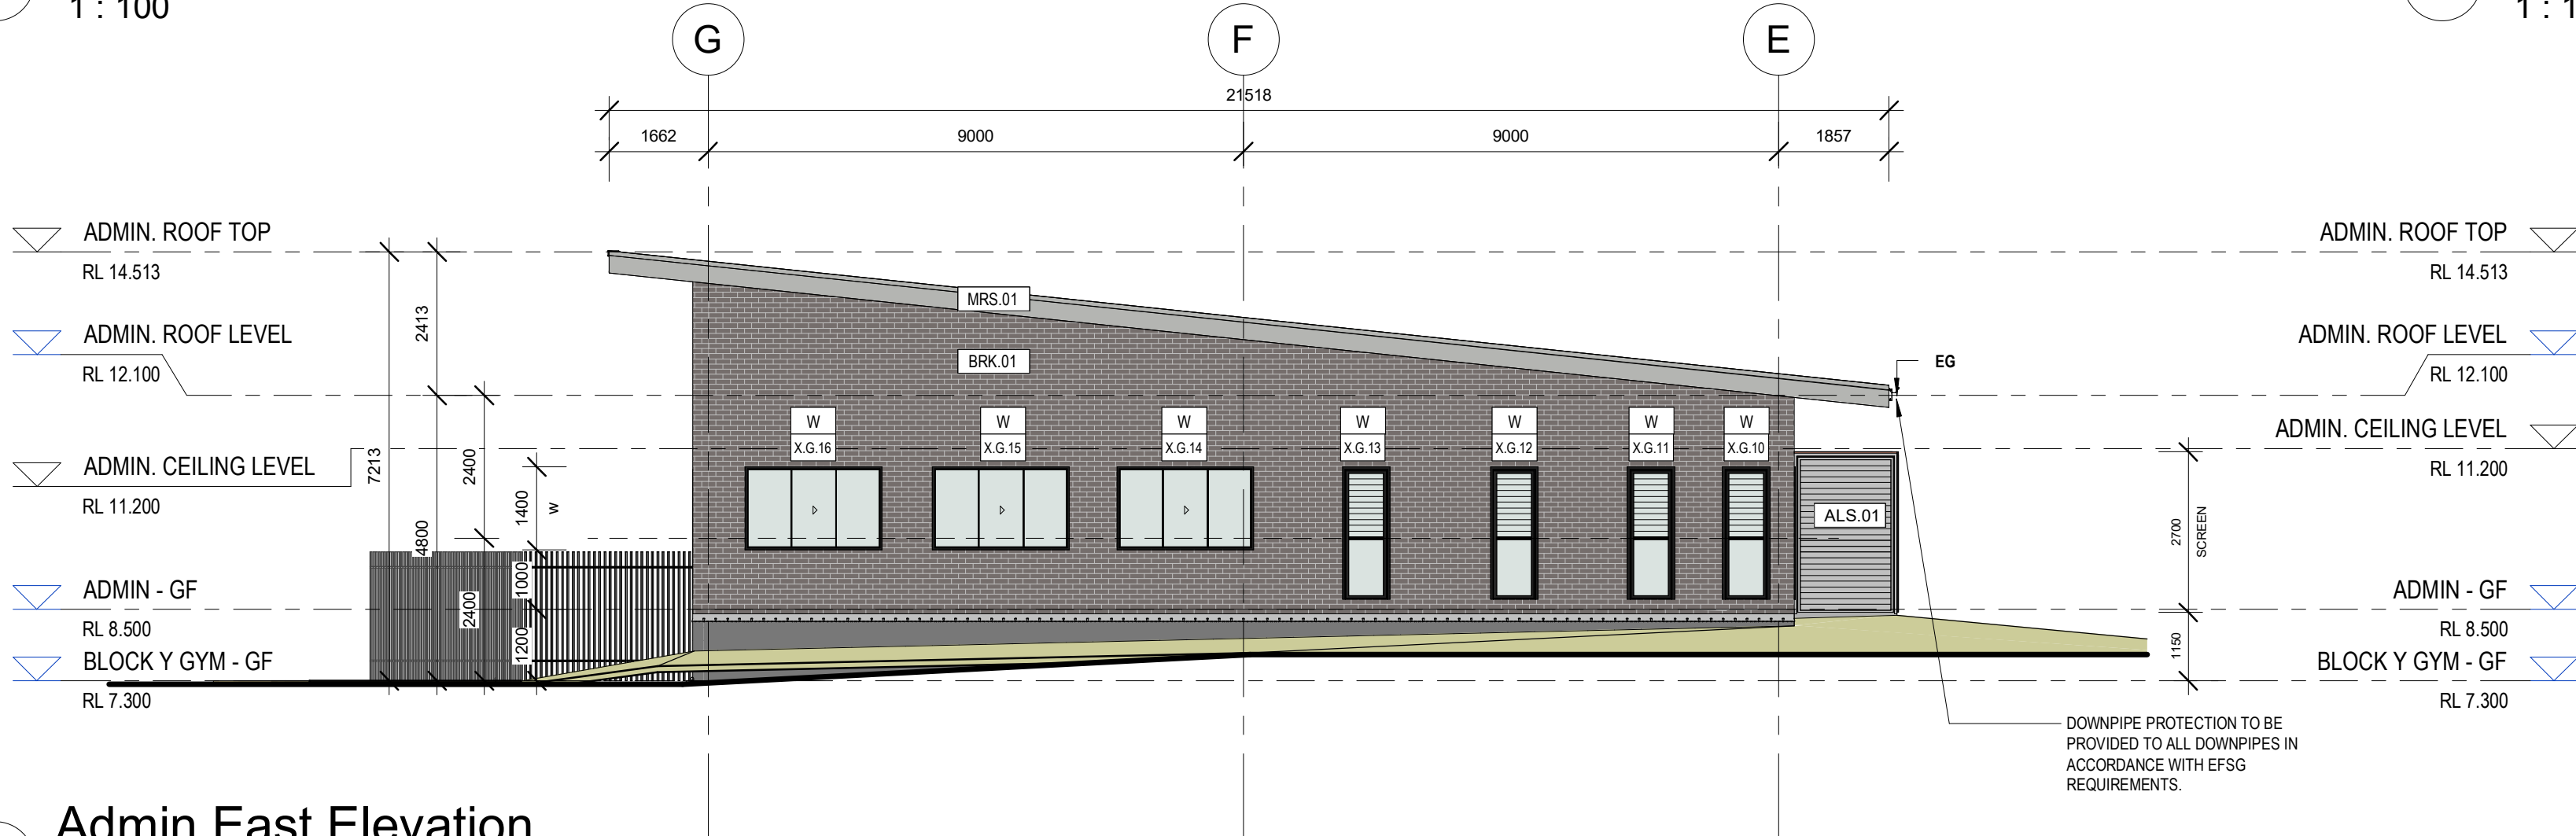
ADMIN
ELEVATIONS




1 Admin North Elevation
1 : 100



2 Admin West Elevation
1 : 100



3 Admin East Elevation
1 : 100

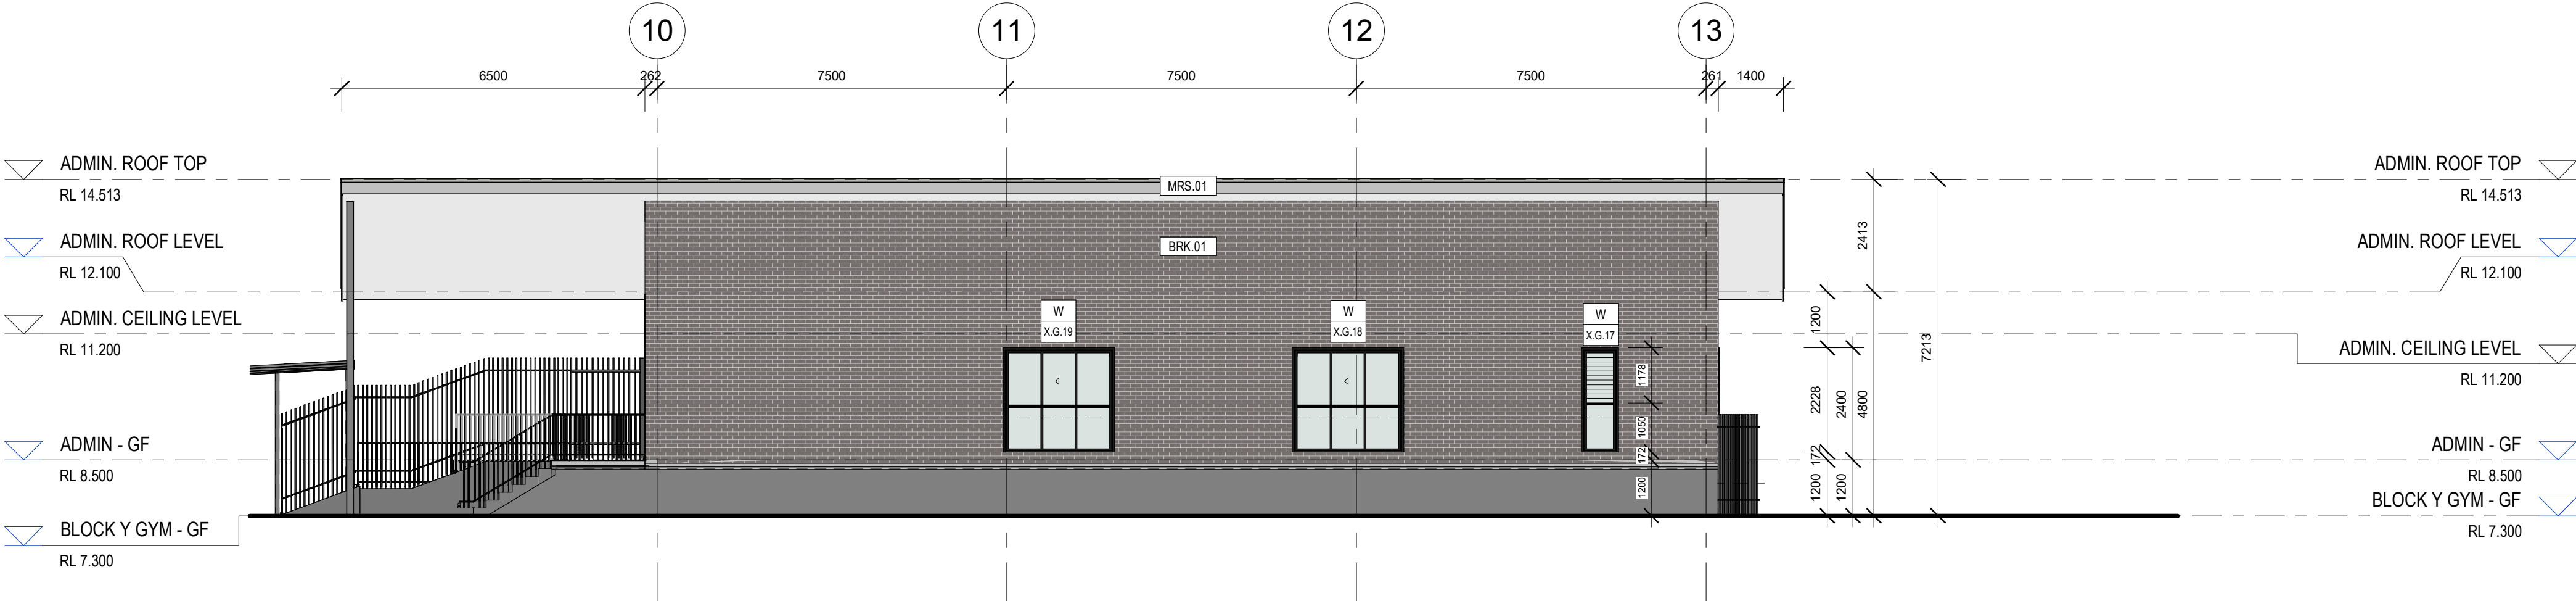

4 Admin South Elevation
1 : 100

LEGEND

FINISHES CODES

- BAL.# - ALUMINIUM BALUSTRADE WITH PC FINISH
- PC.# - ALUMINIUM DOOR & WINDOW FRAMES, SASHES, MULLIONS
- BRK.# - FACE BRICK AS SCHEDULED & TO COMPLY WITH AS 3700
- ALS.# - ALUMINIUM LOUVRE SCREEN AS SCHEDULED
- SN.# - STAIR NOSING AS SCHEDULED
- TGSI.# - TACTILE GROUND SURFACE INDICATORS
- MS.# - PREFINISHED METAL SHEETING AS SCHEDULED
- MRS.# - PREFINISHED METAL ROOF SHEETING AS SCHEDULED
- DP.# - RAINWATER DOWNPIPE
- EG.# - RAINWATER GUTTERING
- CONC.# - CONCRETE SLAB / BEAMS / STAIRS/ PATHWAY AS SCHEDULED
- COL.# - CONCRETE COLUMNS AS SCHEDULE
- FC.# - PREFINISHED FC SHEETING AS SCHEDULED
- BLK.# - BLOCK WORK
- PT.# - PAINT FINISH AS SCHEDULED
- SL.# - EAVES SOFFIT LININGS


NOTE:
DOWNPIPE PROTECTION TO BE PROVIDED TO ALL DOWNPIPES IN ACCORDANCE WITH EFSG REQUIREMENTS.
ALL LOUVRE WINDOWS TO BEGIN ABOVE 1000MM FFL
FC = PREFINISHED FIBRE CEMENT SHEETING - AS SCHEDULED

STANDARD TAGS	
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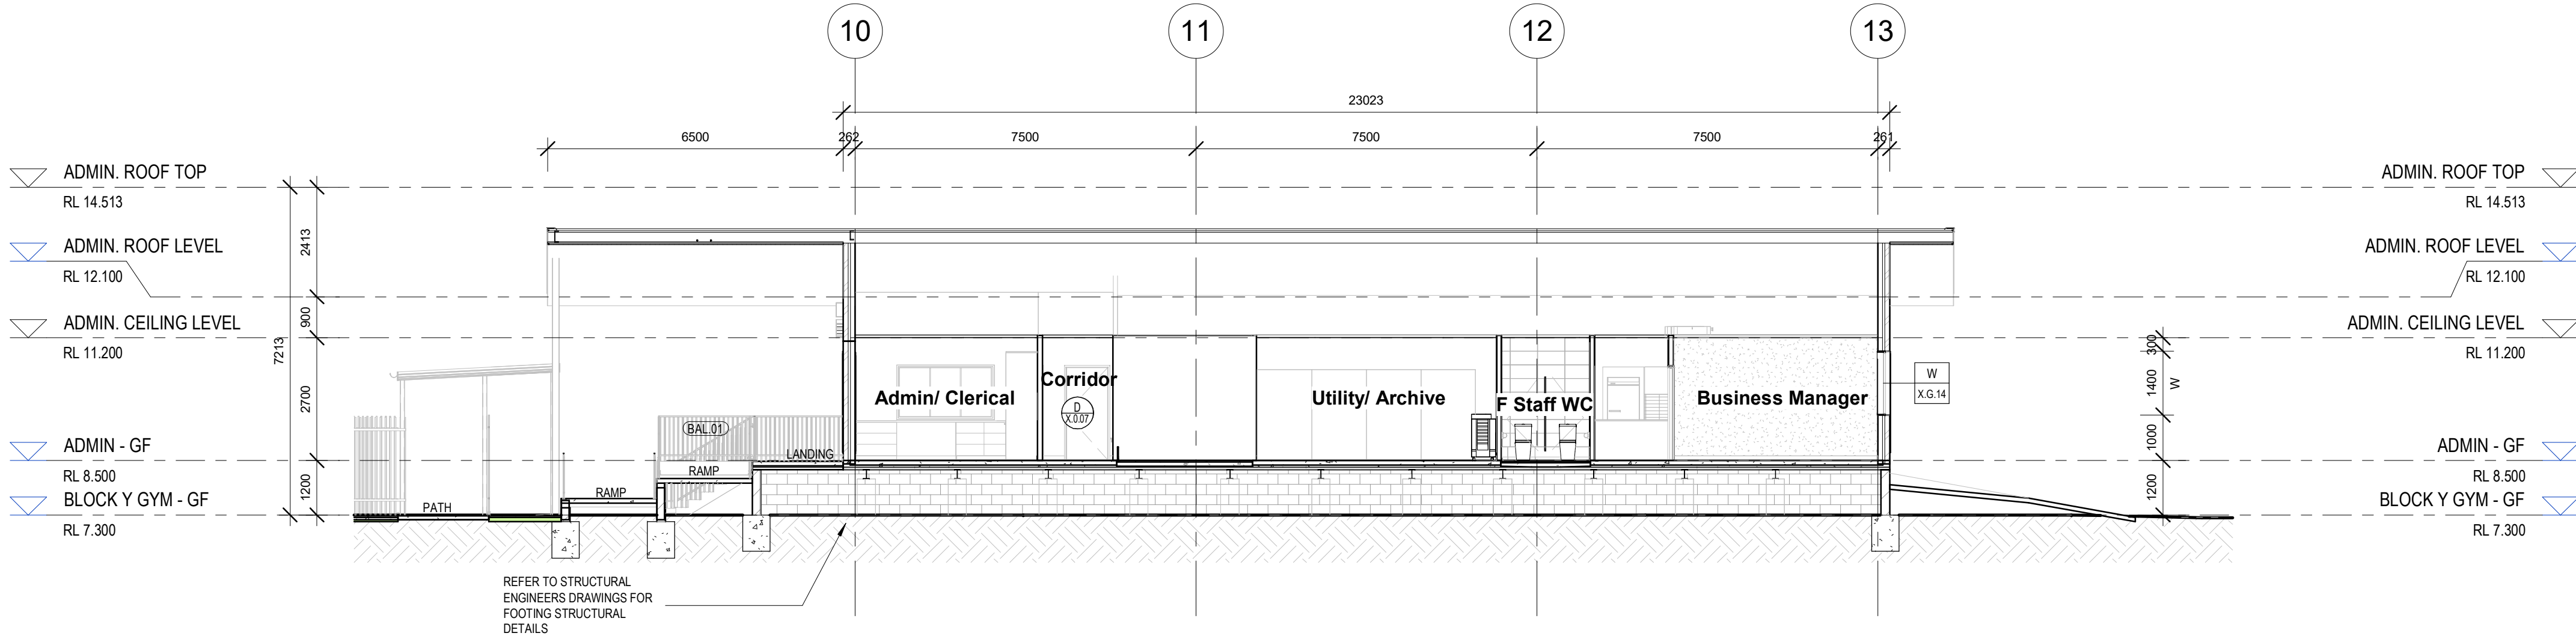
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ADMIN
SECTIONS



1 Admin - Section 1
1 : 100

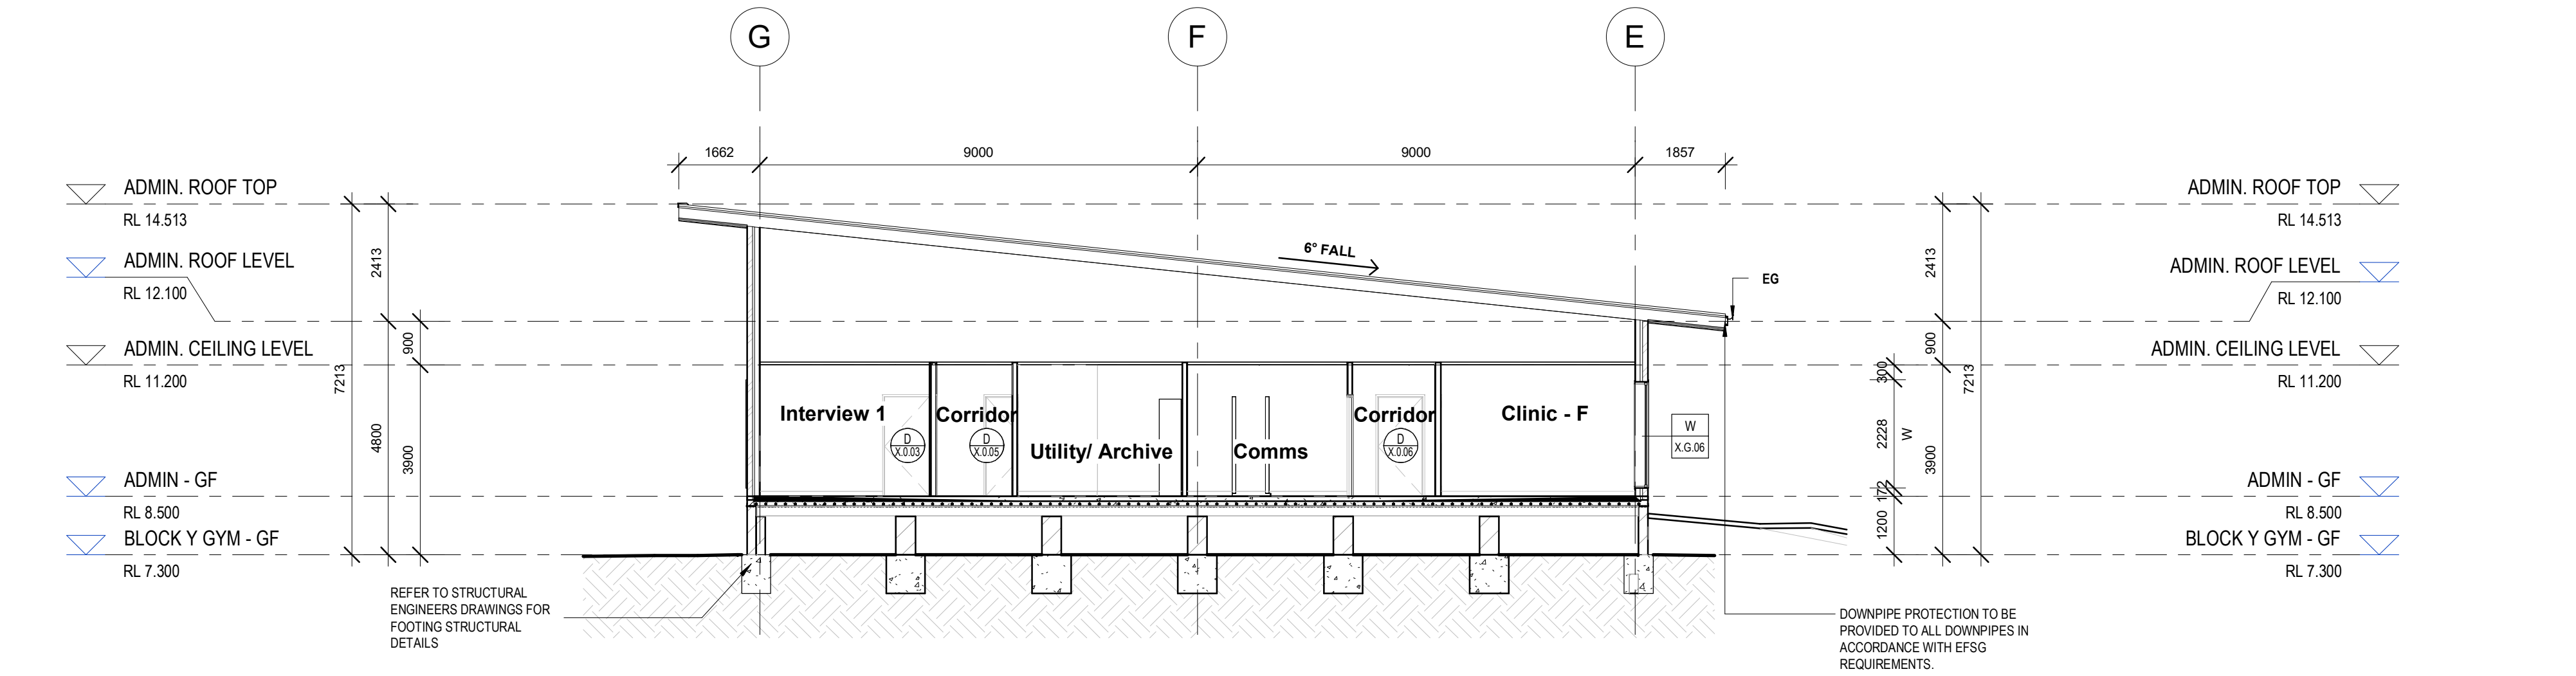

2 Admin Section 2
1 : 100

LEGEND

ABBREVIATIONS


CC-1	CONCRETE COLUMN AS SCHEDULED BY ENG.
SC	STEEL COLUMN AS SCHEDULED BY ENG.
SC-FR	FIRE RATED STEEL COLUMN
CC-2	CONCRETE CIRCULAR COLUMN AS SCHEDULED BY ENG.
FFL	FLOOR FINISH LEVEL
BAL	BALUSTRADE
TGSI	TACTILE GROUND SURFACE INDICATORS
DP	DOWN PIPE AS SCHEDULED BY ENG.

FLOOR FINISHES

CPT-01	CARPET TYPE 1 AS SCHEDULE
CPT-02	CARPET TYPE 2 AS SCHEDULE
VF-01	VINYL TYPE 1 AS SCHEDULED
VF-02	VINYL TYPE 2 AS SCHEDULED
CONC-01	CONCRETE FLOOR AS SCHEDULED
TL-01	TILE TYPE 1 AS SCHEDULE

	NEW WORKS
	REPRESENTS DEMOLITION WORKS

NOTE: EXISTING ROOM DIMENSIONS TO BE CONFIRMED ON SITE

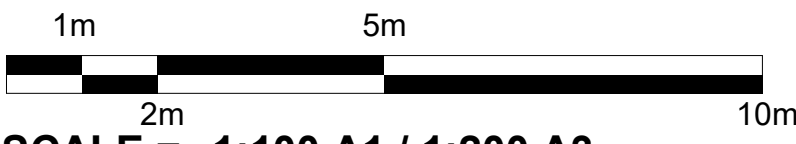

SCALE = 1:100 A1 / 1:200 A3

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ADMINISTRATION BUILDING FABRIC REQUIREMENTS

- ALL ROOF TO HAVE TOTAL CONSTRUCTION R-VALUE OF R13.7 (SA<0.45) (DOWNWARD)
- ENVELOPE WALLS TO HAVE TOTAL CONSTRUCTION R-VALUE OF R1.4
- ENVELOPE FLOORS (INCLUDING SLAB ON GROUND) TO HAVE TOTAL CONSTRUCTION R-VALUE OF R12.0 (DOWNWARD)

NB:

- IT IS A TOTAL SYSTEM PERFORMANCE VALUE AND NOT THE INSULATION
- THE IMPACT OF THERMAL BRIDGING MUST BE INCLUDED IN THE BUILDING ENVELOPE TOTAL SYSTEM R-VALUE CALCULATIONS
- ROOF SOLAR ABSORBANCE MUST BE NO MORE THAN 0.45 (LIGHTER COLOUR)

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ACN 002 912 843 | ABN 82 644 649 849 Nominated Architect - Bernard Collins NSW Architects Registration No.4438

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REV	DATE	COMMENTS
A	29/06/2023	ISSUE FOR REF 1
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C	25/08/2023	REF 1 ISSUE
D	27/03/2024	REVISED REF1 SD FOR COORDINATION
E	08/04/2024	REVISED REF1 ISSUE
F	17/04/2024	REF1 ISSUE

DRN	CHKD	VRFD
MJD	HN	
MJD	HN	
MJD	HN	
MJD	HN	
MJD	HN	

PROJECT: Hunter River High School Upgrade
36 Elkin Ave,
Heatherbrae
NSW 2324

DRAWING: Admin - Block X - Sections

CLIENT: School Infrastructure NSW



DRAWN: MJD
DATE: 08/04/2024
As indicated @ A1
1 : 200 @ A3

Autodesk Docs/Hunter River High School/HRS-EJE-ZZ-ZZ-AG-A-0001.rvt


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PHASE: SD A-REF-X-300
DRAWING No: F
REV: F




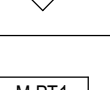
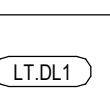



REF 1



NEW SUPPORT LEARNING HUB

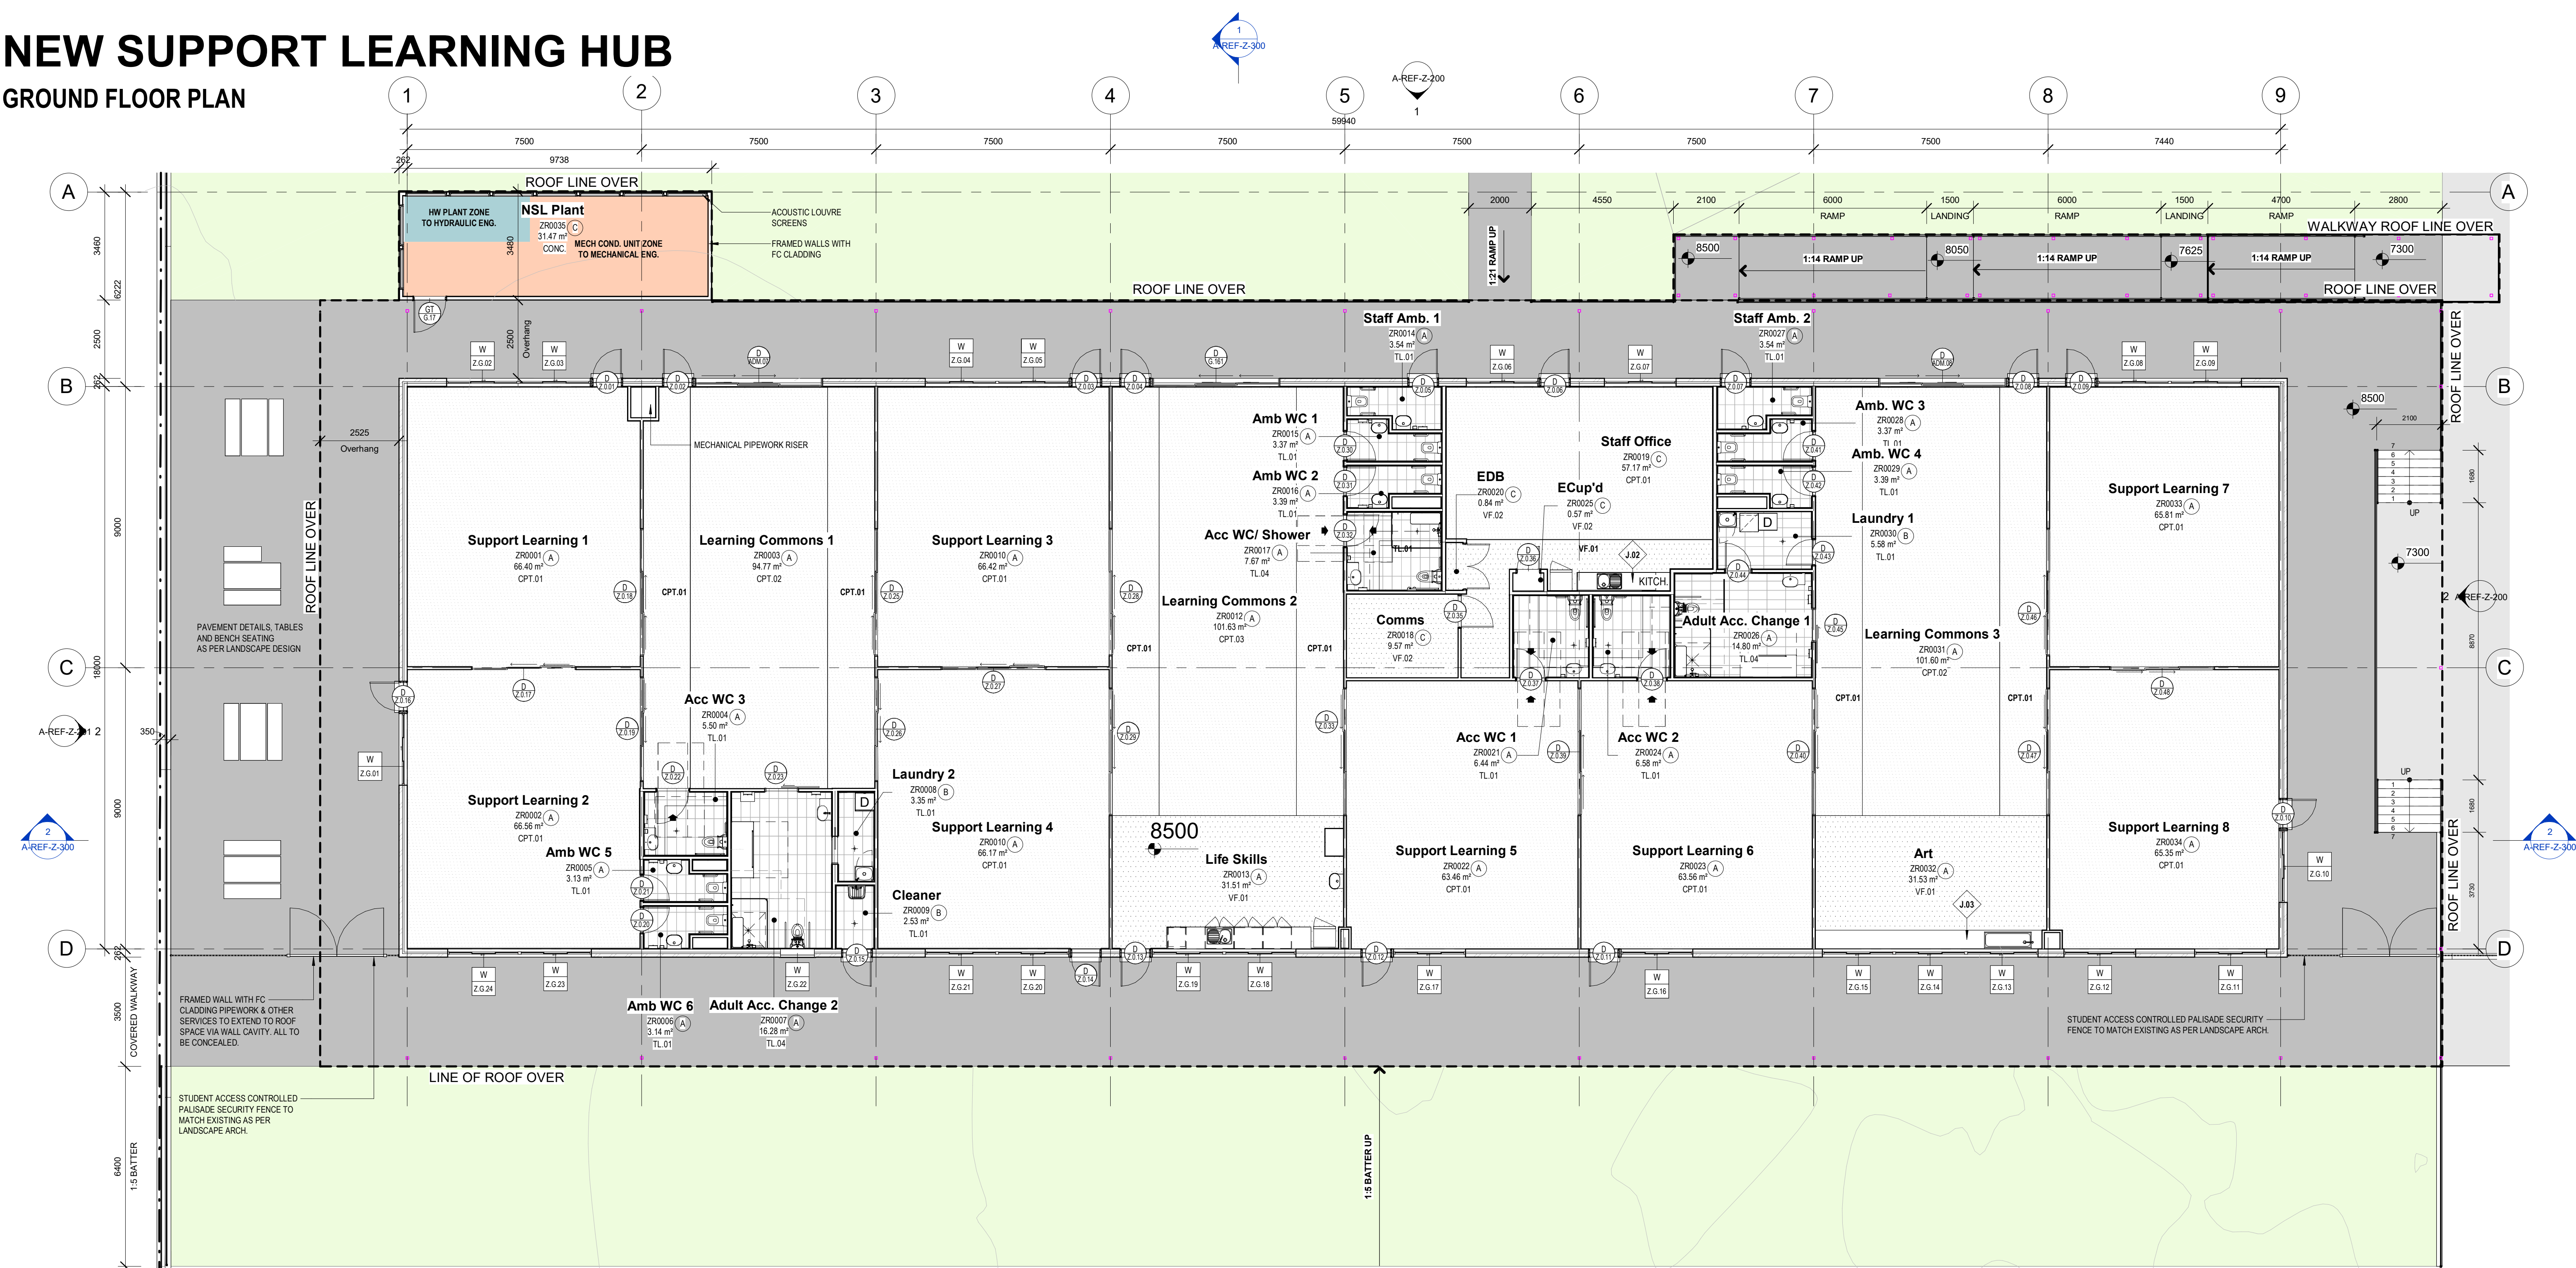GROUND FLOOR PLAN

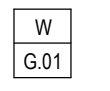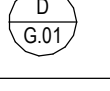
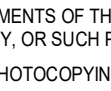
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LEGEND

ABBREVIATIONS

CC1 -	CONCRETE COLUMN AS SCHEDULED BY ENG.
SC -	STEEL COLUMN AS SCHEDULED BY ENG.
SC FR -	FIRE RATED STEEL COLUMN
CC2 -	CONCRETE CIRCULAR COLUMN AS SCHEDULED BY ENG.
FFL -	FLOOR FINISH LEVEL
BAL -	BALUSTRADE
TGSI -	TACTILE GROUND SURFACE INDICATORS

FLOOR FINISHES

CPT.01 -	CARPET TYPE 1 AS SCHEDULED
CPT.02 -	CARPET TYPE 2 AS SCHEDULED
VF.01 -	VINYL TYPE 1 AS SCHEDULED
VF.02 -	VINYL TYPE 2 AS SCHEDULED
VF.03 -	VINYL TYPE 3 AS SCHEDULED
CONC.01 -	CONCRETE FLOOR AS SCHEDULED
TL.01 -	TILE TYPE 1 AS SCHEDULED
TSF.01 -	TIMBER SPRUNG FLOORING AS SCHEDULED

SECURITY LEVEL CATEGORY

(A)	LEVEL A	(C)	LEVEL C	(E)	LEVEL E
(B)	LEVEL B	(D)	LEVEL D		

NOTE: SECURITY CATEGORY TO BE READ IN CONJUNCTION WITH NSW EFGS SCHOOLS SECURITY GUIDELINES

REV	DATE	COMMENTS
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DRN	CHKD	VRFD
MJD	HN	
MJD	HN	
MJD	HN	
MJD	HN	
MJD	HN	

PROJECT: Hunter River High School Upgrade
36 Elkin Ave,
Heatherbrae
NSW 2324

CLIENT: School Infrastructure NSW

DRAWING: New Support Learning Hub - Block Z -
Ground Floor Plan

DRAWN: MJD

DATE: 08/04/2024

SCALES:

As indicated @ A1
1: 200 @ A3

Autodesk Docs/Hunter River High School/HHS-EJE-ZZ-ZZ-AG-A-0001.rvt

PROJECT No: 14276
PHASE: SD A-REF-Z-100
DRAWING No: F


REF 1



Joinery - NSL / Block Z

CODE DESCRIPTION

J.01	WORKING BENCH
J.02	KITCHENETTE
J.03	WORKING BENCH

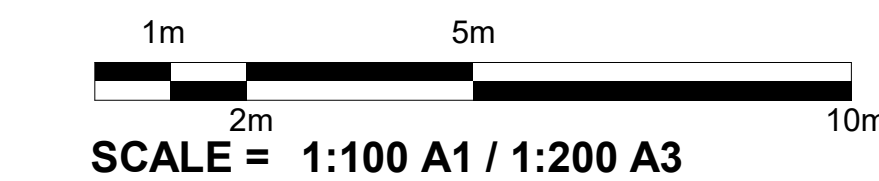

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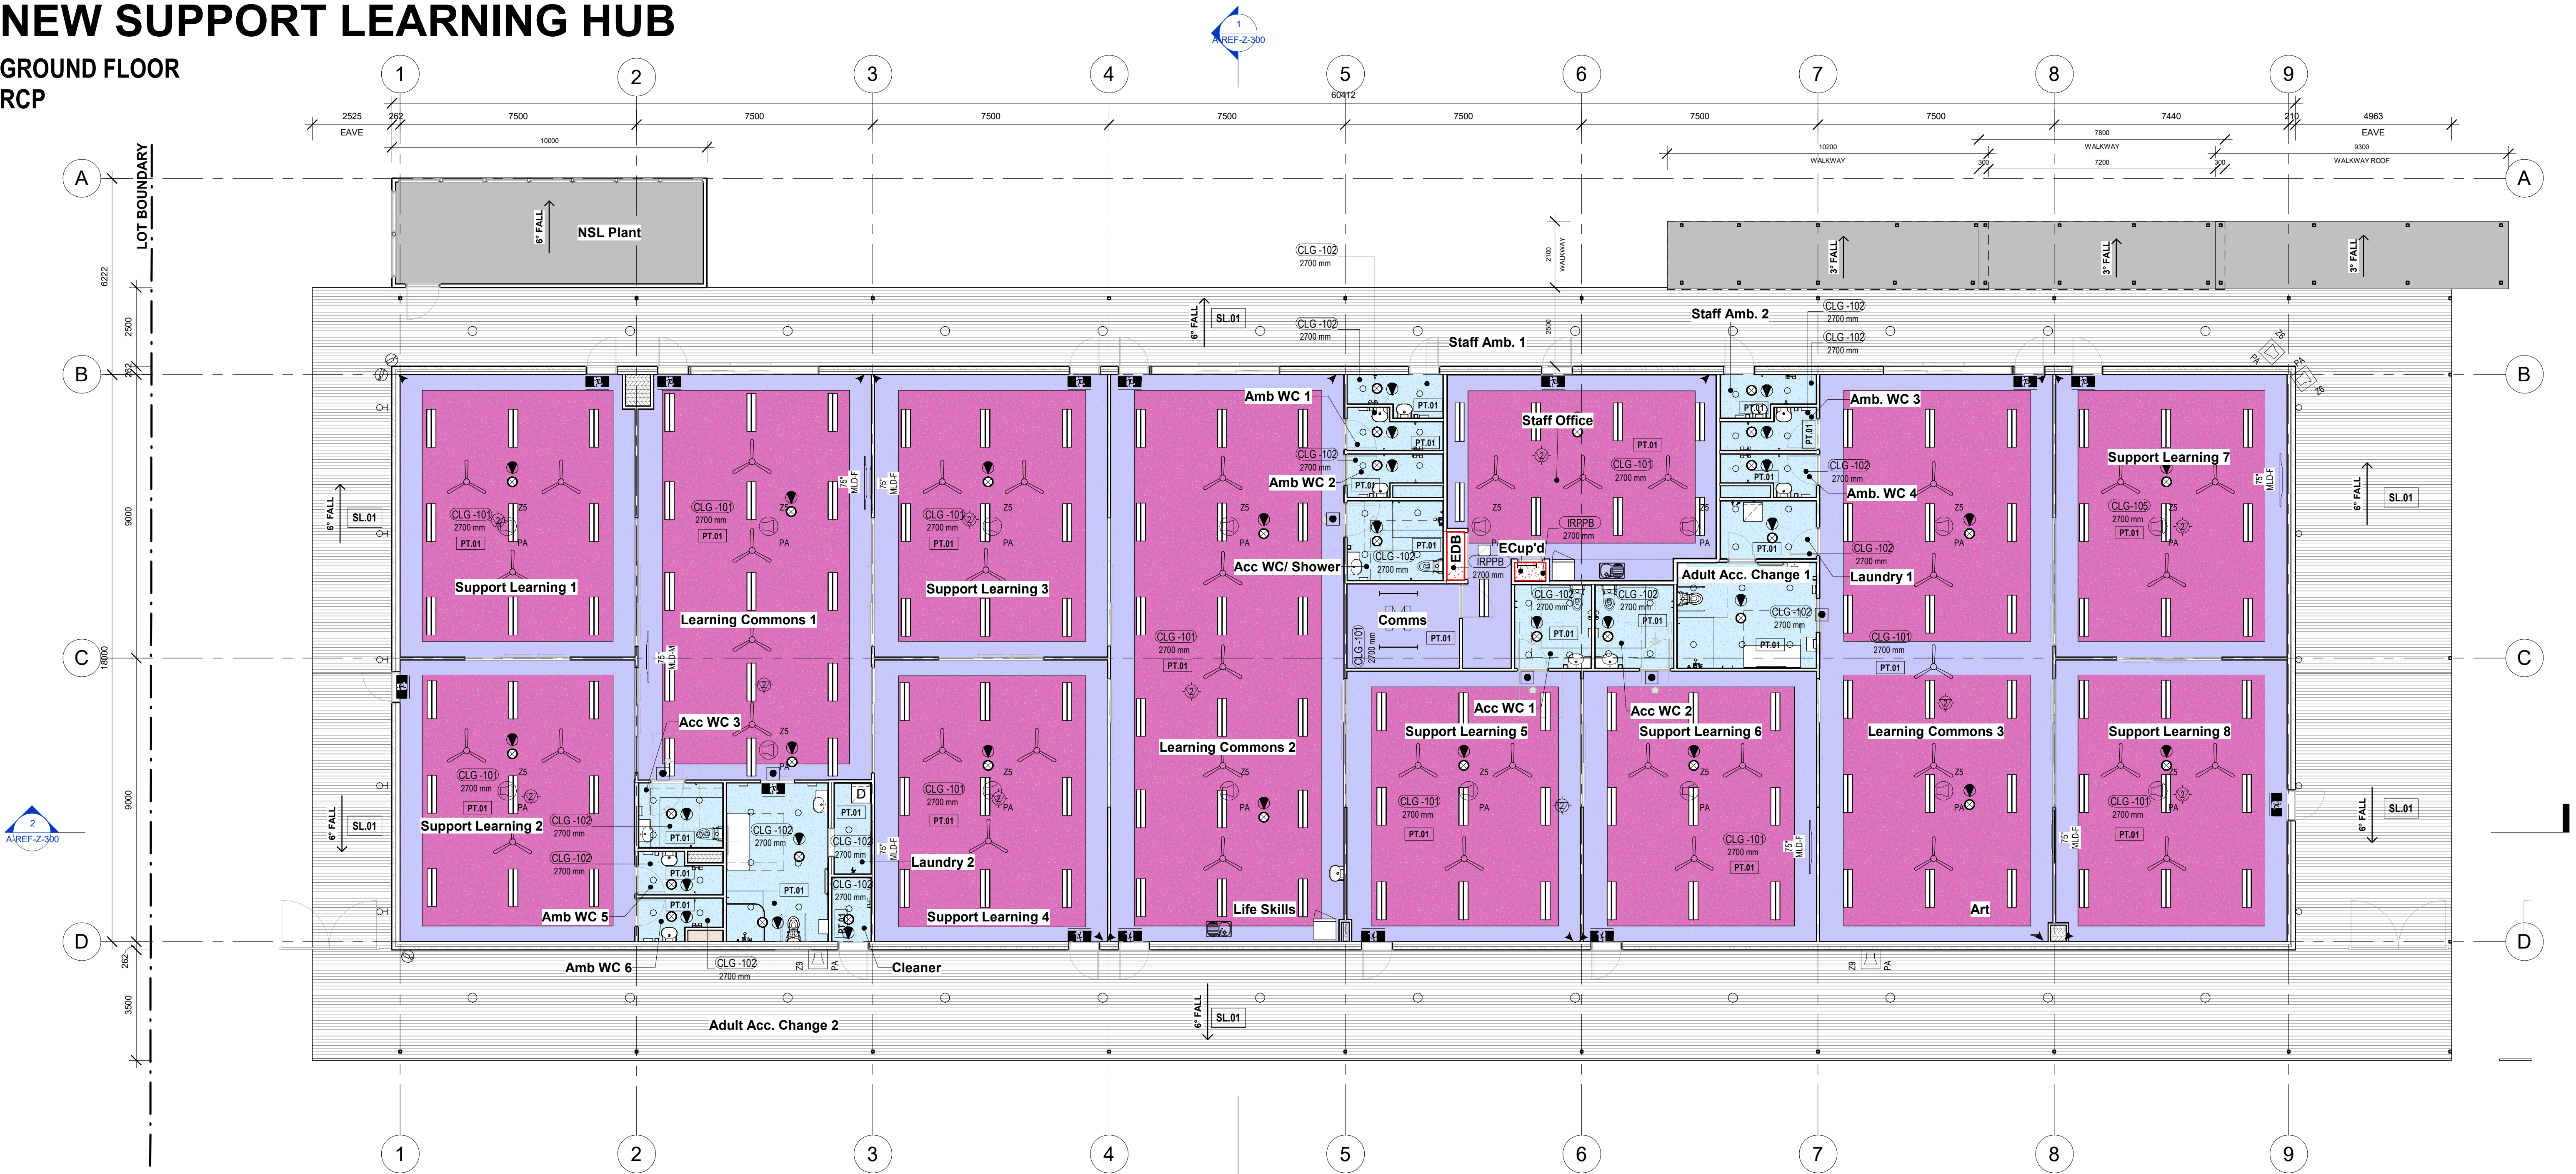
WORK IN FIGURED DIMENSIONS IN PREFERENCE TO SCALE. CHECK DIMENSIONS AND LEVELS ON SITE PRIOR TO THE ORDERING OF MATERIALS OR THE COMPLETION OF WORKSHOP DRAWINGS. IF IN DOUBT ASK. REPORT ALL ERRORS AND OMISSIONS.

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NEW SUPPORT LEARNING HUB

GROUND FLOOR
RCP



STANDARD TAGS	
	WINDOW TAG TOP LINE IS THE "WINDOW IDENTIFIER" BOTTOM LINE IS THE "LEVEL WINDOW NUMBER" ie. (G) GROUND LEVEL, (01) WINDOW 1 ON THAT LEVEL
	DOOR TAG TOP LINE IS THE "DOOR IDENTIFIER" BOTTOM LINE IS THE "LEVEL DOOR NUMBER" ie. (G) GROUND LEVEL, (01) DOOR 1 ON THAT LEVEL
	WALL TAG "WALL MAKEUP/TYPE IDENTIFIER WALL TYPE NUMBER" ie. (S) STEEL STUD (D) 92mm, (1) TYPE 1
	JOINERY TAG "JOINERY IDENTIFIER JOINERY NUMBER" ie. (JR) JOINERY, (1) JOINERY ITEM 1
	MATERIAL TAG "MATERIAL IDENTIFIER, MATERIAL FINISH NUMBER" ie. (M) MATERIALS, (PT) PAINT FINISH (1) TYPE 1
	GENERAL TAG "CATEGORY/SCHEDULE IDENTIFIER ITEM IDENTIFIER/ITEM TYPE" ie. (LT) LIGHTING, (DL) DOWNLIGHT (1) TYPE 1
	REVISION TAG IN TRIANGLE IS REVISION NUMBER OUTSIDE TRIANGLE IS CHANGE COMMENT ie. COMMENT MIGHT BE "DOOR ADDED"
	GATE TAG TOP LINE IS THE "GATE IDENTIFIER" BOTTOM LINE IS THE "LEVEL GATE NUMBER" ie. (G) GROUND LEVEL, (01) DOOR 1 ON THAT LEVEL


MATERIALS LEGEND	
CODE	DESCRIPTION
ACP.02	ACOUSTIC PANEL AS SCHEDULE
ACP.03	ACOUSTIC PANEL AS SCHEDULE
CPT.01	CARPET TILE AS SCHEDULED
CPT.02	CARPET TILE AS SCHEDULED
CPT.03	CARPET TILE AS SCHEDULED
CST.01	COVED SKIRTING TILE
CVS.02	COVED VINYL SKIRTING AS SCHEDULED
FC.03	CEMENT WALL SHEETING FEATURE
FC.05	FIBRE CEMENT COLUMN CLADDING SHEETING
FLM.01	PRIVACY WINDOW FILM
LAM.01	LAMINATE TYPE 01 AS SCHEDULED
LAM.02	LAMINATE TYPE 02 AS SCHEDULED
LAM.03	LAMINATE TYPE 03 AS SCHEDULED
LAM.04	LAMINATE TYPE 04 AS SCHEDULED
PIN.01	PINBOARD FINISH TYPE 01 AS SCHEDULED
PIN.02	PINBOARD FINISH TYPE 02 AS SCHEDULED
PIN.03	PINBOARD FINISH TYPE 03 AS SCHEDULED
PT.01	PAINT FINISH AS SCHEDULED
PT.02	PAINT FINISH AS SCHEDULED
PT.03	PAINT FINISH AS SCHEDULED
RCS.01	RECONSTITUTED STONE BENCHTOP AS SCHEDULED
SL.01	SLIP RESISTANT TILE AS SCHEDULED

MATERIALS LEGEND	
CODE	DESCRIPTION
TL.02	WALL TILE AS SCHEDULED
TL.03	FEATURE WALL TILE AS SCHEDULED
TL.04	SLIP RESISTANT TILE AS SCHEDULED
VF.01	VINYL FLOORING TYPE 1 AS SCHEDULED
VF.02	VINYL FLOORING TYPE 2 AS SCHEDULED
VF.03	VINYL FLOORING TYPE 3 AS SCHEDULED

CEILING FIXTURES/ FITTINGS LEGEND

A1	RECESSED/ SURFACED LED LIGHT TYPE 1 - REFER TO ELECTRICAL ENG. DRAWINGS	ILLUMINATED EXIT SIGN - REFER TO ELECTRICAL ENG. DRAWINGS
B1	LED BATTEN LIGHT - REFER TO ELECTRICAL ENG. DRAWINGS	DIRECTIONAL ILLUMINATED EXIT SIGN - REFER TO ELECTRICAL ENG. DRAWINGS
B1E	LED BATTEN LIGHT W. EMERGENCY BATTERY SYSTEM TYPE 1 - REFER TO ELECTRICAL ENG. DRAWINGS	LED EMERGENCY LIGHT - REFER TO ELECTRICAL ENG. DRAWINGS
B2	LED BATTEN LIGHT - REFER TO ELECTRICAL ENG. DRAWINGS	MOVEMENT SENSOR - REFER TO ELECTRICAL ENG. DRAWINGS
D1	RECESSED LED DOWNLIGHT TYPE 1 - REFER TO ELECTRICAL ENG. DRAWINGS	WALL FAN - REFER TO ELECTRICAL ENG. DRAWINGS (FINAL COLOUR AND LOCATIONS TO BE ADVISED BY ARCHITECT)
D2	RECESSED LED DOWNLIGHT TYPE 2 - REFER TO ELECTRICAL ENG. DRAWINGS	
S1	SURFACE MOUNTED LED OYSTER LIGHT - REFER TO ELECTRICAL ENG. DRAWINGS	CEILING FAN - REFER TO ELECTRICAL ENG. DRAWINGS
W1	SURFACE MOUNTED LED WALL LIGHT - REFER TO ELECTRICAL ENG. DRAWINGS	

	RETURN/ EXHAUST AIR EGG GRILLE - REFER TO MECHANICAL ENG. DRAWINGS
	ACCESS PANEL - REFER TO MECHANICAL ENG. DRAWINGS
	CASSETTE STYLE AIR SUPPLY - REFER TO MECHANICAL ENG. DRAWINGS
	BIG ASS FAN - REFER TO ELECTRICAL ENG. DRAWINGS

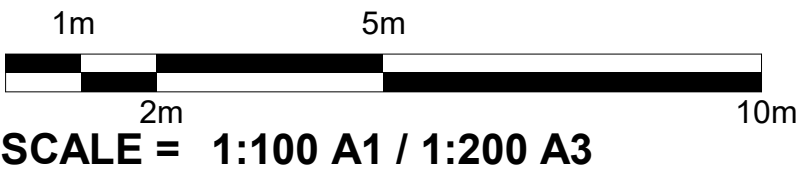

CEILING FINISHES LEGEND	
	EXPOSED CLT
	CLG-104 NRC: 0.6 - 0.8 ABSORPTIVE CEILING
	CLG-101 FLUSH PLASTERBOARD PAINT FINISH
	CLG-102 MOISTURE RESISTANT PLASTERBOARD PAINT FINISH
	CLG-105 NRC >0.85 HIGHLY ABSORPTIVE CEILING
	CLG-106 FIRE RATED PLASTERBOARD PAINT FINISH
	CLG-107, CLG-108 & CLG-109 PRE-FINISHED FC
	SL.01 SOFFIT LINING - SHEET METAL

NOTE:
1. ROOF/ CEILING ENVELOPE R3.7 (DOWNWARDS) SOLAR ABSORBANCE NO MORE THAN 0.45
2. CONTRACTOR TO REFER TO ACOUSTIC ENGINEERS REPORT FOR CEILING NRC REQUIREMENTS
3. REFER TO FIRE ENGINEER DOCUMENTATION FOR FIRE SAFETY CEILING ACCESSORIES/ SERVICES

REF 1

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B	11/07/2023	ISSUE FOR REF 1
C	25/08/2023	REF 1 ISSUE
D	27/03/2024	REVISED REF1 SD FOR COORDINATION
E	08/04/2024	REVISED REF1 ISSUE
F	17/04/2024	REF1 ISSUE

DRN	CHKD	VRFD
MJD	HN	
MJD	HN	
MJD	HN	
MJD	HN	
MJD	HN	

PROJECT: Hunter River High School Upgrade
36 Elkin Ave,
Heatherbrae
NSW 2324


CLIENT: School Infrastructure NSW

DRAWING: New Support Learning Hub - Block Z -
Reflected Ceiling Plan




DRAWN: MJD
DATE: 08/04/2024
As indicated @ A1
1: 200 @ A3

PROJECT No: 14276
PHASE: SD A-REF-Z-110
DRAWING No: F
REV: F

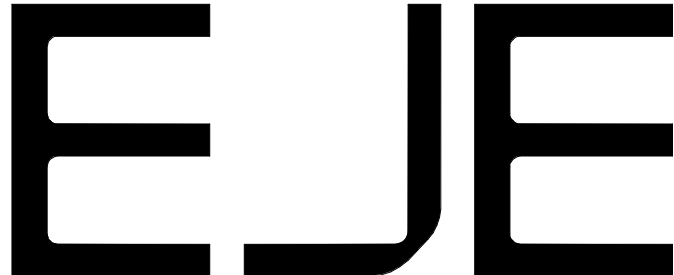

NEW SUPPORT LEARNING HUB

ROOF PLAN

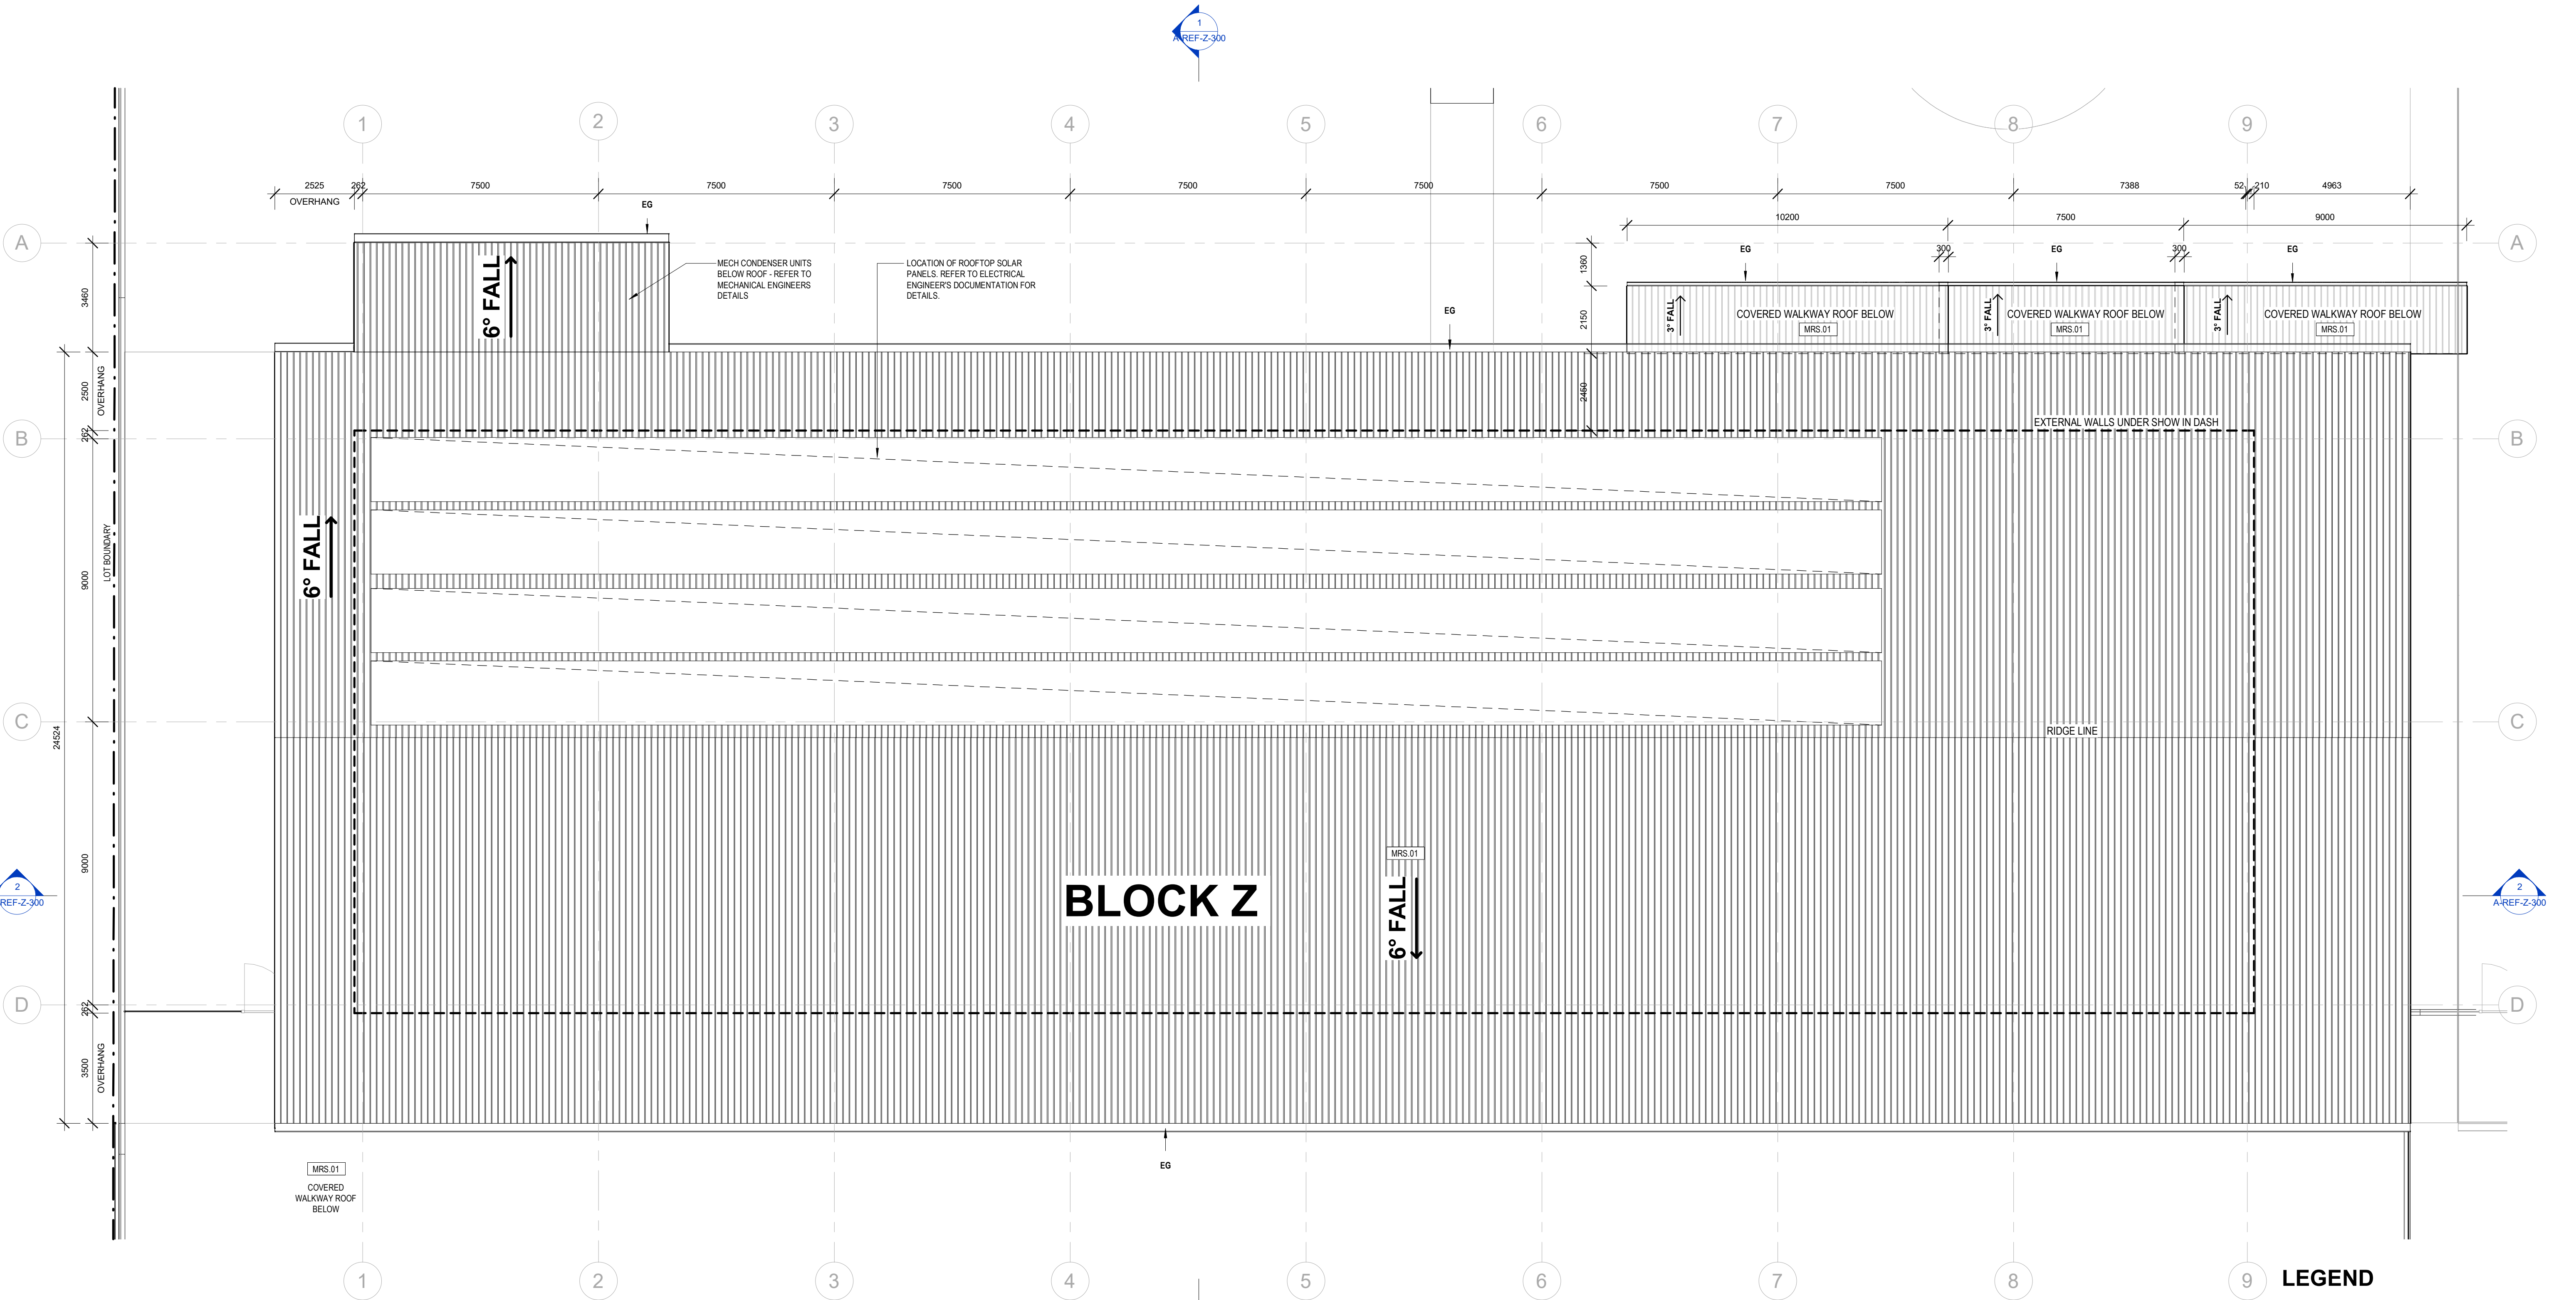

LEGEND


ABBREVIATIONS

EG- EAVES GUTTER AS HYDRAULIC ENG.
DP- DOWN PIPES AS HYDRAULIC ENG.
MRS- METAL ROOF SHEETING - AS SCHEDULED

NOTE:

1. ROOF/ CEILING ENVELOPE R3.7 (DOWNWARDS) SOLAR ABSORBANCE NO MORE THAN 0.45
2. ALL DOORS, OR ONE LEAF OF A DOUBLE DOOR, ARE TO HAVE A CLEAR UNOBSTRUCTED OPENING WIDTH OF MIN. 850MM

REF 1

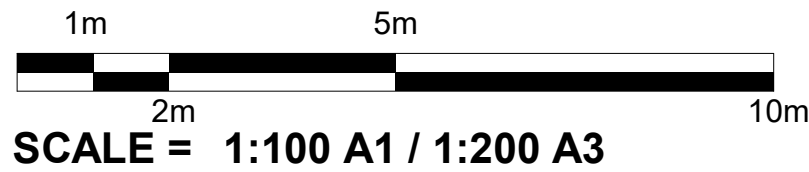


SCALE = 1:100 A1 / 1:200 A3

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DRN	CHKD	VRFD
MJD	HN	
MJD	HN	
MJD	HN	
MJD	HN	
MJD	HN	

PROJECT: Hunter River High School Upgrade
36 Elkin Ave,
Heatherbrae
NSW 2324

CLIENT: School Infrastructure NSW

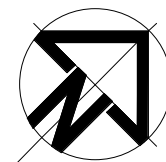DRAWING: New Support Learning Hub - Block Z - Roof Plan




DRAWN: MJD
DATE: 08/04/2024
As indicated @ A1
1:200 @ A3

Autodesk Docs/Hunter River High School/HRS-EJE-ZZ-ZZ-AG-A-0001.rvt


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PHASE: SD A-REF-Z-140
DRAWING No: F
REV: F

NEW SUPPORT LEARNING HUB

ELEVATIONS

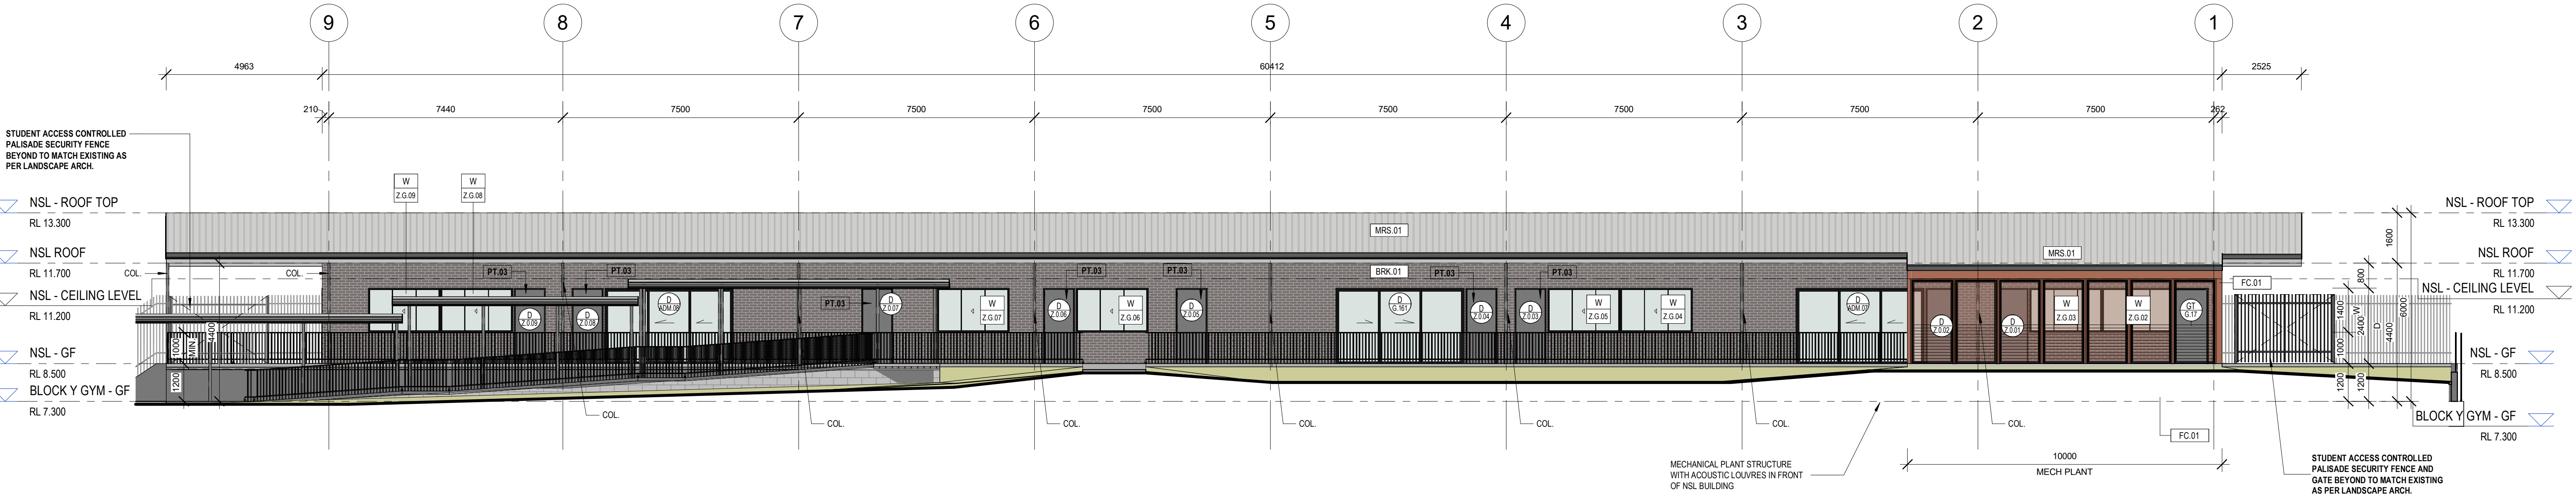

1 NSL North Elevation
1 : 100

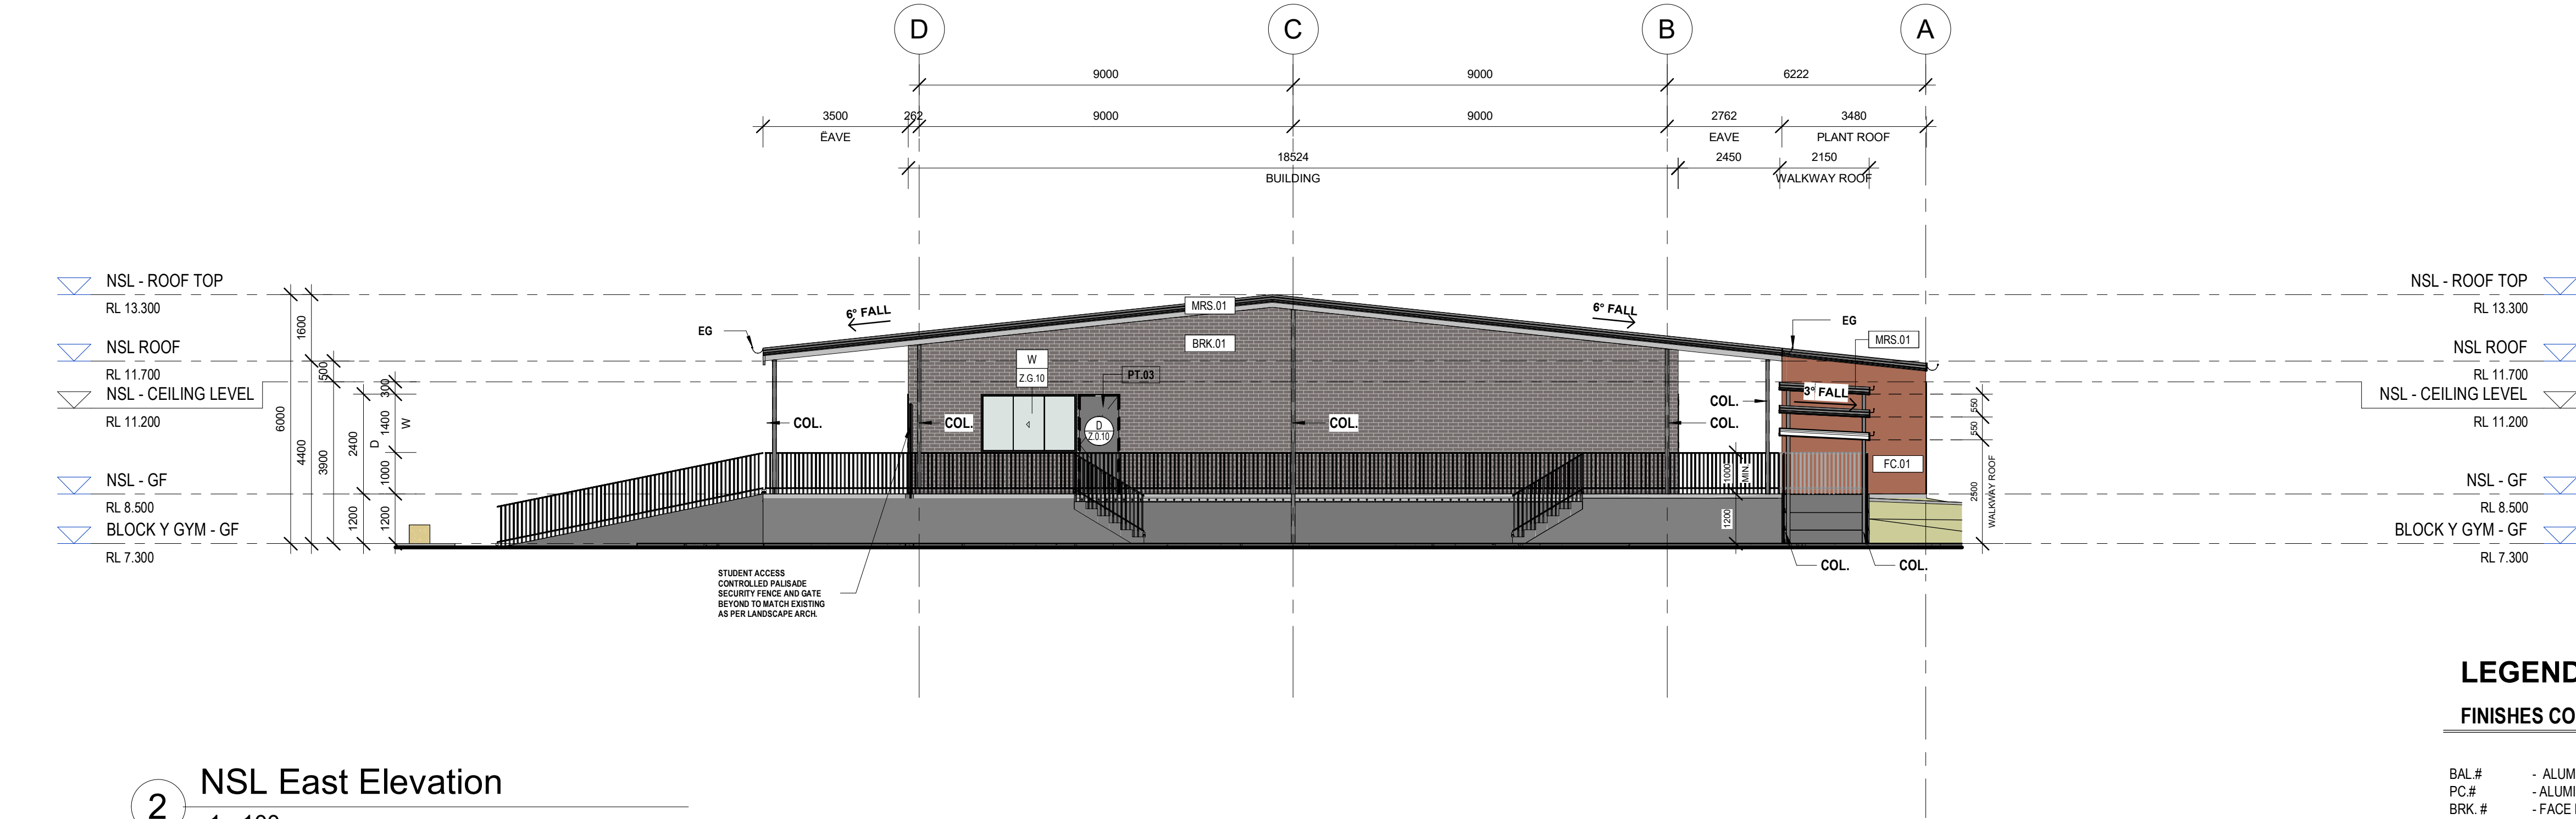

2 NSL East Elevation
1 : 100

STANDARD TAGS	
	WINDOW TAG TOP LINE IS THE "WINDOW IDENTIFIER" BOTTOM LINE IS THE "LEVEL WINDOW NUMBER" ie. (S) GROUND LEVEL, (01) WINDOW 1 ON THAT LEVEL
	DOOR TAG TOP LINE IS THE "DOOR IDENTIFIER" BOTTOM LINE IS THE "LEVEL DOOR NUMBER" ie. (S) GROUND LEVEL, (01) DOOR 1 ON THAT LEVEL
	WALL TAG "WALL MAKEUP/TYPE IDENTIFIER.WALL TYPE NUMBER" ie. (S) STEEL STUD (D) 92mm, (1) TYPE 1
	JOINERY TAG "JOINERY IDENTIFIER.JOINERY NUMBER" ie. (JR) JOINERY, (1) JOINERY ITEM 1
	MATERIAL TAG "MATERIAL IDENTIFIER.MATERIAL FINISH NUMBER" ie. (M) MATERIALS, (PT) PAINT FINISH (1) TYPE 1
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LEGEND

FINISHES CODES

BAL.#	- ALUMINIUM BALUSTRADE WITH PC FINISH
PC.#	- ALUMINIUM DOOR & WINDOW FRAMES, SASHES, MULLIONS
BRK.#	- FACE BRICK AS SCHEDULED & TO COMPLY WITH AS.3700
ALS.#	- ALUMINIUM LOUVRE SCREEN AS SCHEDULED
SN.#	- STAIR NOSING AS SCHEDULED
TGSI.#	- TACTILE GROUND SURFACE INDICATORS
MS.#	- PREFINISHED METAL SHEETING AS SCHEDULED
MRS.#	- PREFINISHED METAL ROOF SHEETING AS SCHEDULED
DP.#	- RAINWATER DOWNPIPE
EG.#	- RAINWATER GUTTERING
CONC.#	- CONCRETE SLAB / BEAMS / STAIRS/ PATHWAY AS SCHEDULED
COL.#	- CONCRETE COLUMNS AS SCHEDULE
FC.#	- PREFINISHED FC SHEETING AS SCHEDULED
BLK.#	- BLOCK WORK
PT.#	- PAINT FINISH AS SCHEDULED
SL.#	- EAVES SOFFIT LININGS

NOTE:

DOWNPIPE PROTECTION TO BE PROVIDED TO ALL DOWNPIPES IN ACCORDANCE WITH EFSG REQUIREMENTS.
ALL LOUVRE WINDOWS TO BEGIN ABOVE 1000MM FFL


FC = PREFINISHED FIBRE CEMENT SHEETING - AS SCHEDULED

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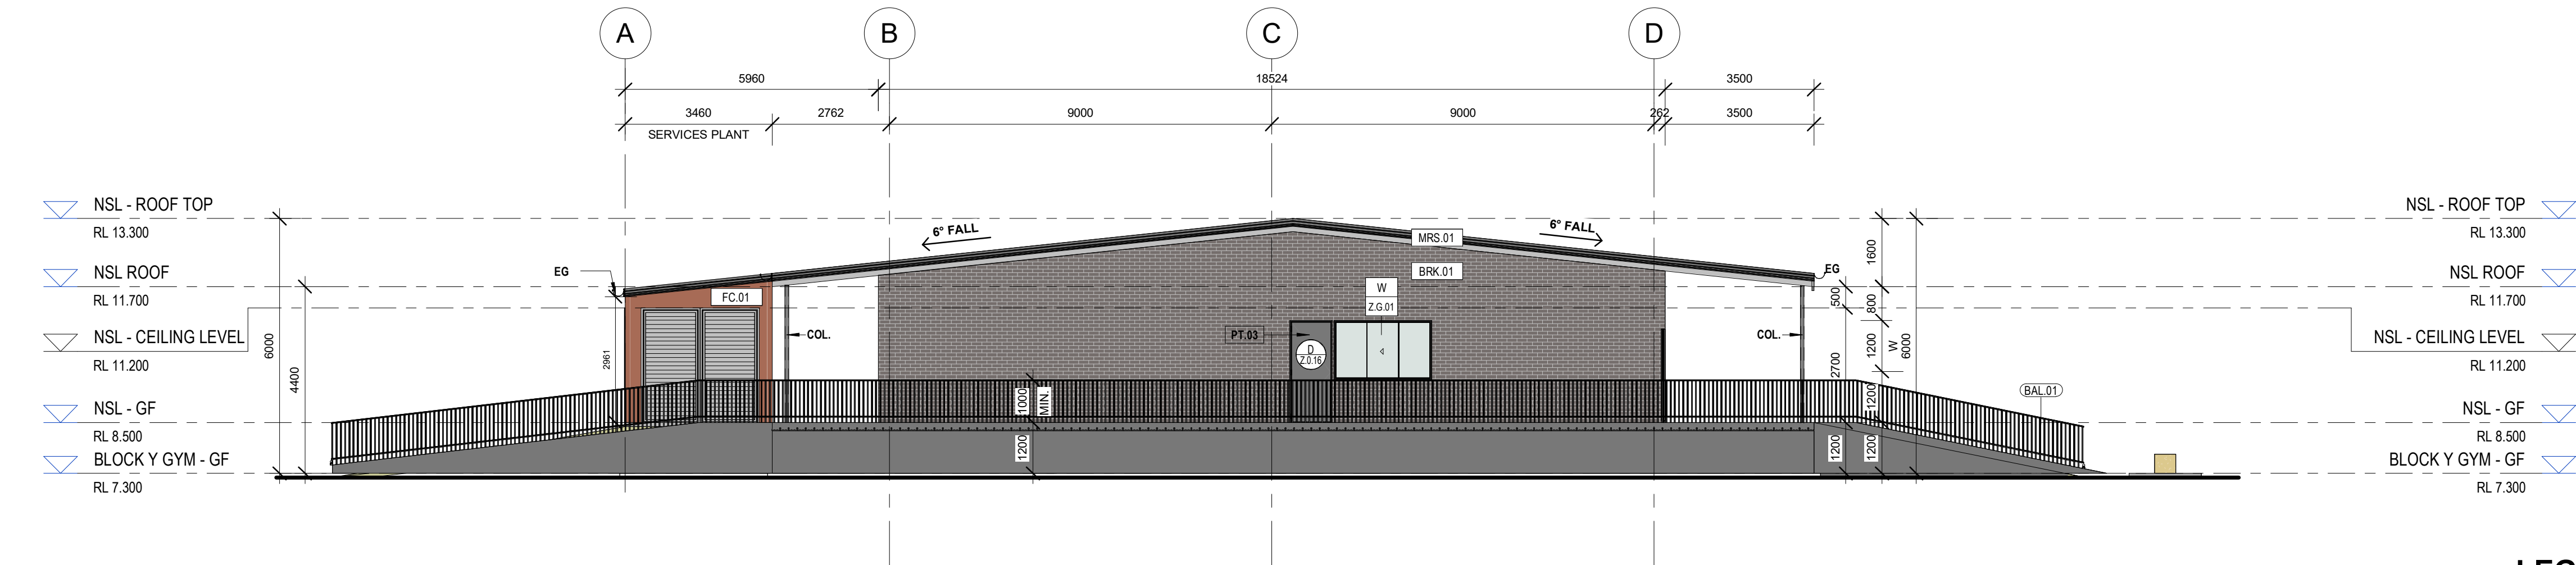


NEW SUPPORT LEARNING HUB

ELEVATIONS

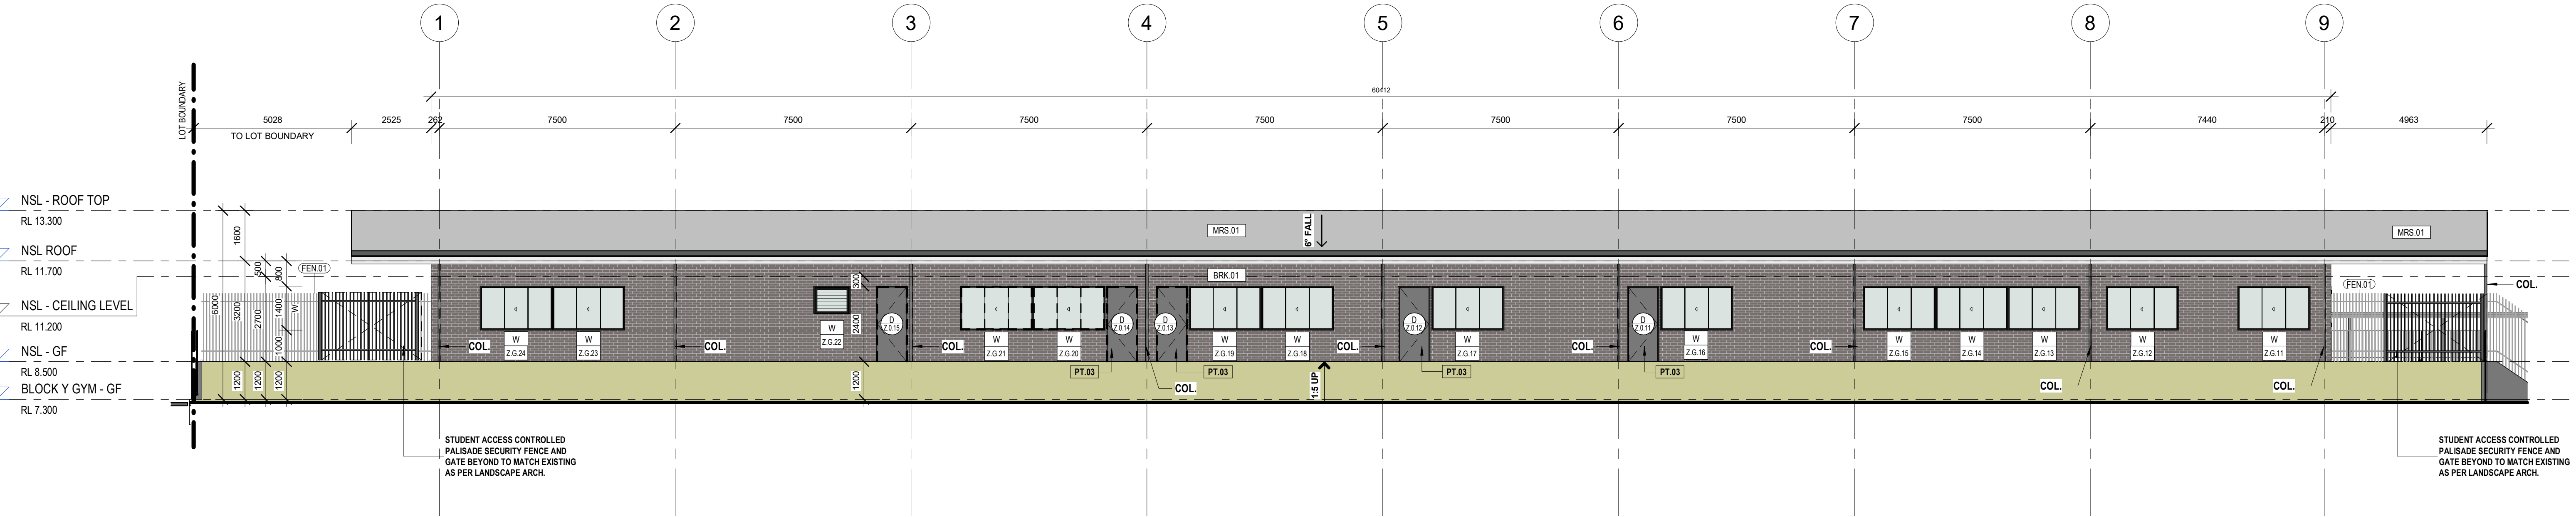

1 NSL South Elevation
1 : 100



2 NSL West Elevation
1 : 100

STANDARD TAGS	
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	WALL TAG "WALL MAKEUP/TYPE IDENTIFIER.WALL TYPE NUMBER" ie. (S) STEEL STUD (D) 92mm, (I) TYPE 1
	JOINERY TAG "JOINERY IDENTIFIER.JOINERY NUMBER" ie. (JR) JOINERY, (I) JOINERY ITEM 1
	MATERIAL TAG "MATERIAL IDENTIFIER.MATERIAL FINISH NUMBER" ie. (M) MATERIALS, (PT) PAINT FINISH (I) TYPE 1
	GENERAL TAG "CATEGORY/SCHEDULE IDENTIFIER.ITEM IDENTIFIER/ITEM TYPE" ie. (LT) LIGHTING, (DL) DOWNLIGHT (I) TYPE 1
	REVISION TAG IN TRIANGLE IS REVISION NUMBER OUTSIDE TRIANGLE IS CHANGE COMMENT ie. COMMENT MIGHT BE "DOOR ADDED"
	GATE TAG TOP LINE IS THE "GATE IDENTIFIER" BOTTOM LINE IS THE "LEVEL GATE NUMBER" ie. (G) GROUND LEVEL, (01) DOOR 1 ON THAT LEVEL

LEGEND

FINISHES CODES

- | | |
|--------|--|
| BAL.# | - ALUMINIUM BALUSTRADE WITH PC FINISH |
| PC.# | - ALUMINIUM DOOR & WINDOW FRAMES, SASHES, MULLIONS |
| BRK.# | - FACE BRICK AS SCHEDULED & TO COMPLY WITH AS.3700 |
| ALS.# | - ALUMINIUM LOUVRE SCREEN AS SCHEDULED |
| SN.# | - STAIR NOSING AS SCHEDULED |
| TGSI.# | - TACTILE GROUND SURFACE INDICATORS |
| MS.# | - PREFINISHED METAL SHEETING AS SCHEDULED |
| MRS.# | - PREFINISHED METAL ROOF SHEETING AS SCHEDULED |
| DP.# | - RAINWATER DOWNPIPE |
| EG.# | - RAINWATER GUTTERING |
| CONC.# | - CONCRETE SLAB / BEAMS / STAIRS/ PATHWAY AS SCHEDULED |
| COL.# | - CONCRETE COLUMNS AS SCHEDULE |
| FC.# | - PREFINISHED FC SHEETING AS SCHEDULED |
| BLK.# | - BLOCK WORK |
| PT.# | - PAINT FINISH AS SCHEDULED |
| SL.# | - EAVES SOFFIT LININGS |

NOTE:

DOWNPIPE PROTECTION TO BE PROVIDED TO ALL DOWNPIPES IN ACCORDANCE WITH EFSG REQUIREMENTS.
ALL LOUVRE WINDOWS TO BEGIN ABOVE 1000MM FFL

FC = PREFINISHED FIBRE CEMENT SHEETING - AS SCHEDULED

REF 1

NEW SUPPORT LEARNING HUB



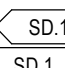

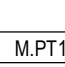
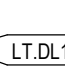


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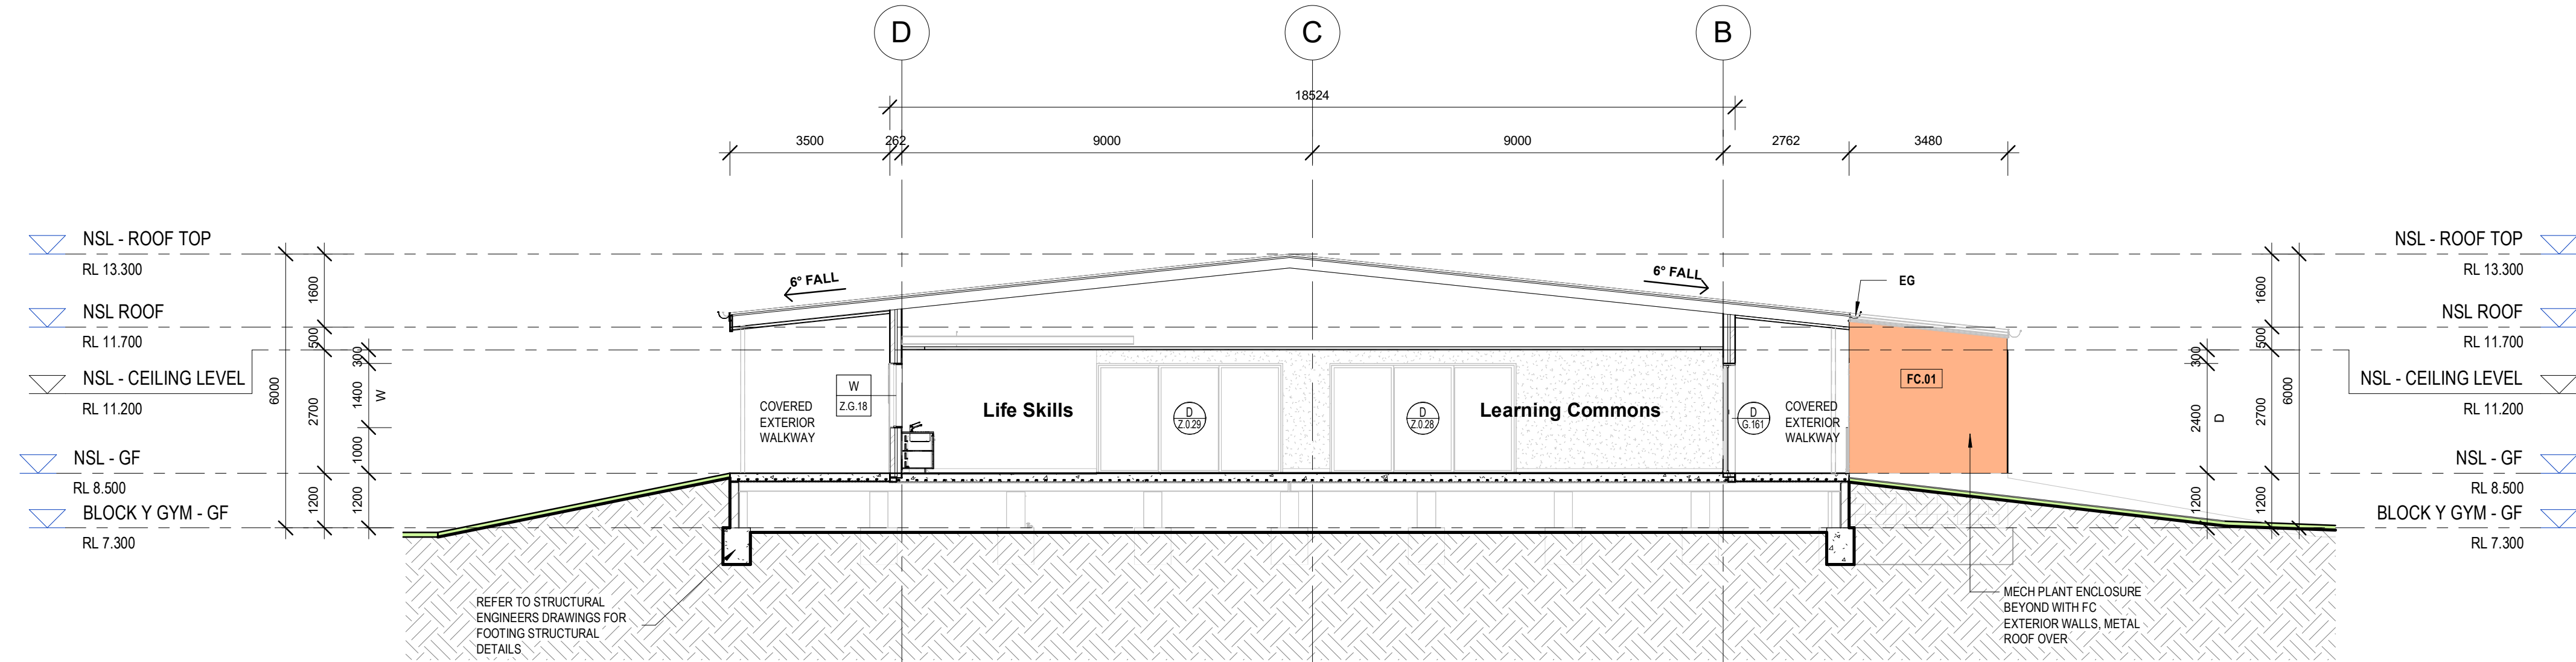
NEW SUPPORT LEARNING BUILDING FABRIC REQUIREMENTS

- ALL ROOF TO HAVE TOTAL CONSTRUCTION R-VALUE OF R13.7 (SA<0.45) (DOWNWARD)
- ENVELOPE WALLS TO HAVE TOTAL CONSTRUCTION R-VALUE OF R1.4
- ENVELOPE FLOORS (INCLUDING SLAB ON GROUND) TO HAVE TOTAL CONSTRUCTION R-VALUE OF R12.0 (DOWNWARD)


NB:

- IT IS A TOTAL SYSTEM PERFORMANCE VALUE AND NOT THE INSULATION
- THE IMPACT OF THERMAL BRIDGING MUST BE INCLUDED IN THE BUILDING ENVELOPE TOTAL SYSTEM R-VALUE CALCULATIONS
- ROOF SOLAR ABSORBANCE MUST BE NO MORE THAN 0.45 (LIGHTER COLOUR)

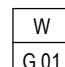STANDARD TAGS	
 W G.01	WINDOW TAG TOP LINE IS THE "WINDOW IDENTIFIER" BOTTOM LINE IS THE "LEVEL WINDOW NUMBER" ie. (G) GROUND LEVEL, (01) WINDOW 1 ON THAT LEVEL
 D G.01	DOOR TAG TOP LINE IS THE "DOOR IDENTIFIER" BOTTOM LINE IS THE "LEVEL DOOR NUMBER" ie. (G) GROUND LEVEL, (01) DOOR 1 ON THAT LEVEL
 SD.1 SD.1	WALL TAG "WALL MAKEUP/TYPE IDENTIFIER WALL TYPE NUMBER" ie. (S) STEEL STUD, (D) 92mm, (1) TYPE 1
 J.1	JOINERY TAG "JOINERY IDENTIFIER JOINERY NUMBER" ie. (JR) JOINERY, (1) JOINERY ITEM 1
 M.PT1	MATERIAL TAG "MATERIAL IDENTIFIER MATERIAL FINISH NUMBER" ie. (M) MATERIALS, (PT) PAINT FINISH (1) TYPE 1
 LT.DL1	GENERAL TAG "CATEGORY/SCHEDULE IDENTIFIER ITEM IDENTIFIER ITEM TYPE" ie. (LT) LIGHTING, (DL) DOWNLIGHT (1) TYPE 1
 COMMENT	REVISION TAG IN TRIANGLE IS REVISION NUMBER OUTSIDE TRIANGLE IS CHANGE COMMENT ie. COMMENT MIGHT BE "DOOR ADDED"
 GT G.01	GATE TAG TOP LINE IS THE "GATE IDENTIFIER" BOTTOM LINE IS THE "LEVEL GATE NUMBER" ie. (G) GROUND LEVEL, (01) GATE 1 ON THAT LEVEL



1 NSL - Section 1
1 : 100

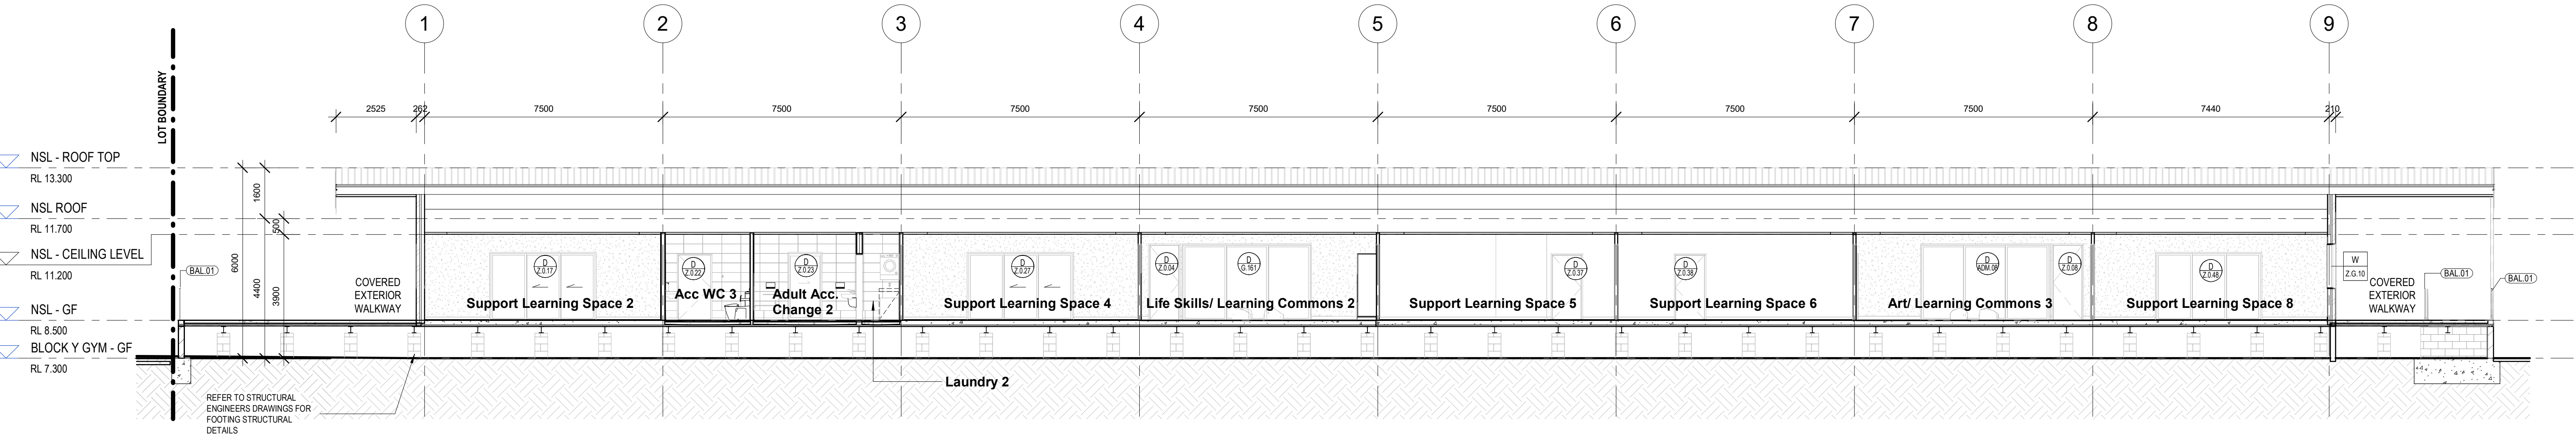

2 NSL - Section 2
1 : 100

LEGEND

FINISHES CODES

BAL.#	- ALUMINIUM BALUSTRADE WITH PC FINISH
PC.#	- ALUMINIUM DOOR & WINDOW FRAMES, SASHES, MULLIONS
BRK.#	- FACE BRICK AS SCHEDULED & TO COMPLY WITH AS.3700
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MS.#	- PREFINISHED METAL SHEETING AS SCHEDULED
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COL.#	- CONCRETE COLUMNS AS SCHEDULED
FC.#	- PREFINISHED FC SHEETING AS SCHEDULED
BLK.#	- BLOCK WORK
PT.#	- PAINT FINISH AS SCHEDULED
SL.#	- EAVES SOFFIT LININGS

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C	25/08/2023	REF 1 ISSUE
D	27/03/2024	REVISED REF1 SD FOR COORDINATION
E	08/04/2024	REVISED REF1 ISSUE
F	17/04/2024	REF1 ISSUE

DRN	CHKD	VRFD
MJD	HN	
MJD	HN	
MJD	HN	
MJD	HN	
MJD	HN	

PROJECT: Hunter River High School Upgrade
36 Elkin Ave,
Heatherbrae
NSW 2324

CLIENT: School Infrastructure NSW

DRAWING: New Support Learning Hub - Block Z -
Sections



DRAWN: MJD
DATE: 08/04/2024
As indicated @ A1
1 : 200 @ A3

PROJECT No: 14276
PHASE: SD A-REF-Z-300
DRAWING No: F
REV: F

SCALES: