


AMENDMENTS				DESCRIPTION
REV	BY	DATE		
A	YP	06.07.2021		ISSUED FOR RTS




TaylorBrammer
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DRAWING NAME
LANDSCAPE: OVERALL SITE PLAN

PROJECT
**EPPING WEST PUBLIC SCHOOL
ALTERATIONS AND ADDITIONS
96 CARLINGFORD RD EPPING NSW**

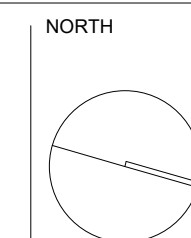

5000 10000 15000 20000 25000 50000
SCALE 1 : 500 @ A1
07 JULY 2021
PROJECT DISCIPLINE PHASE SERIES NUMBER REVISION
EPPW - LA - SSDA - L100 A

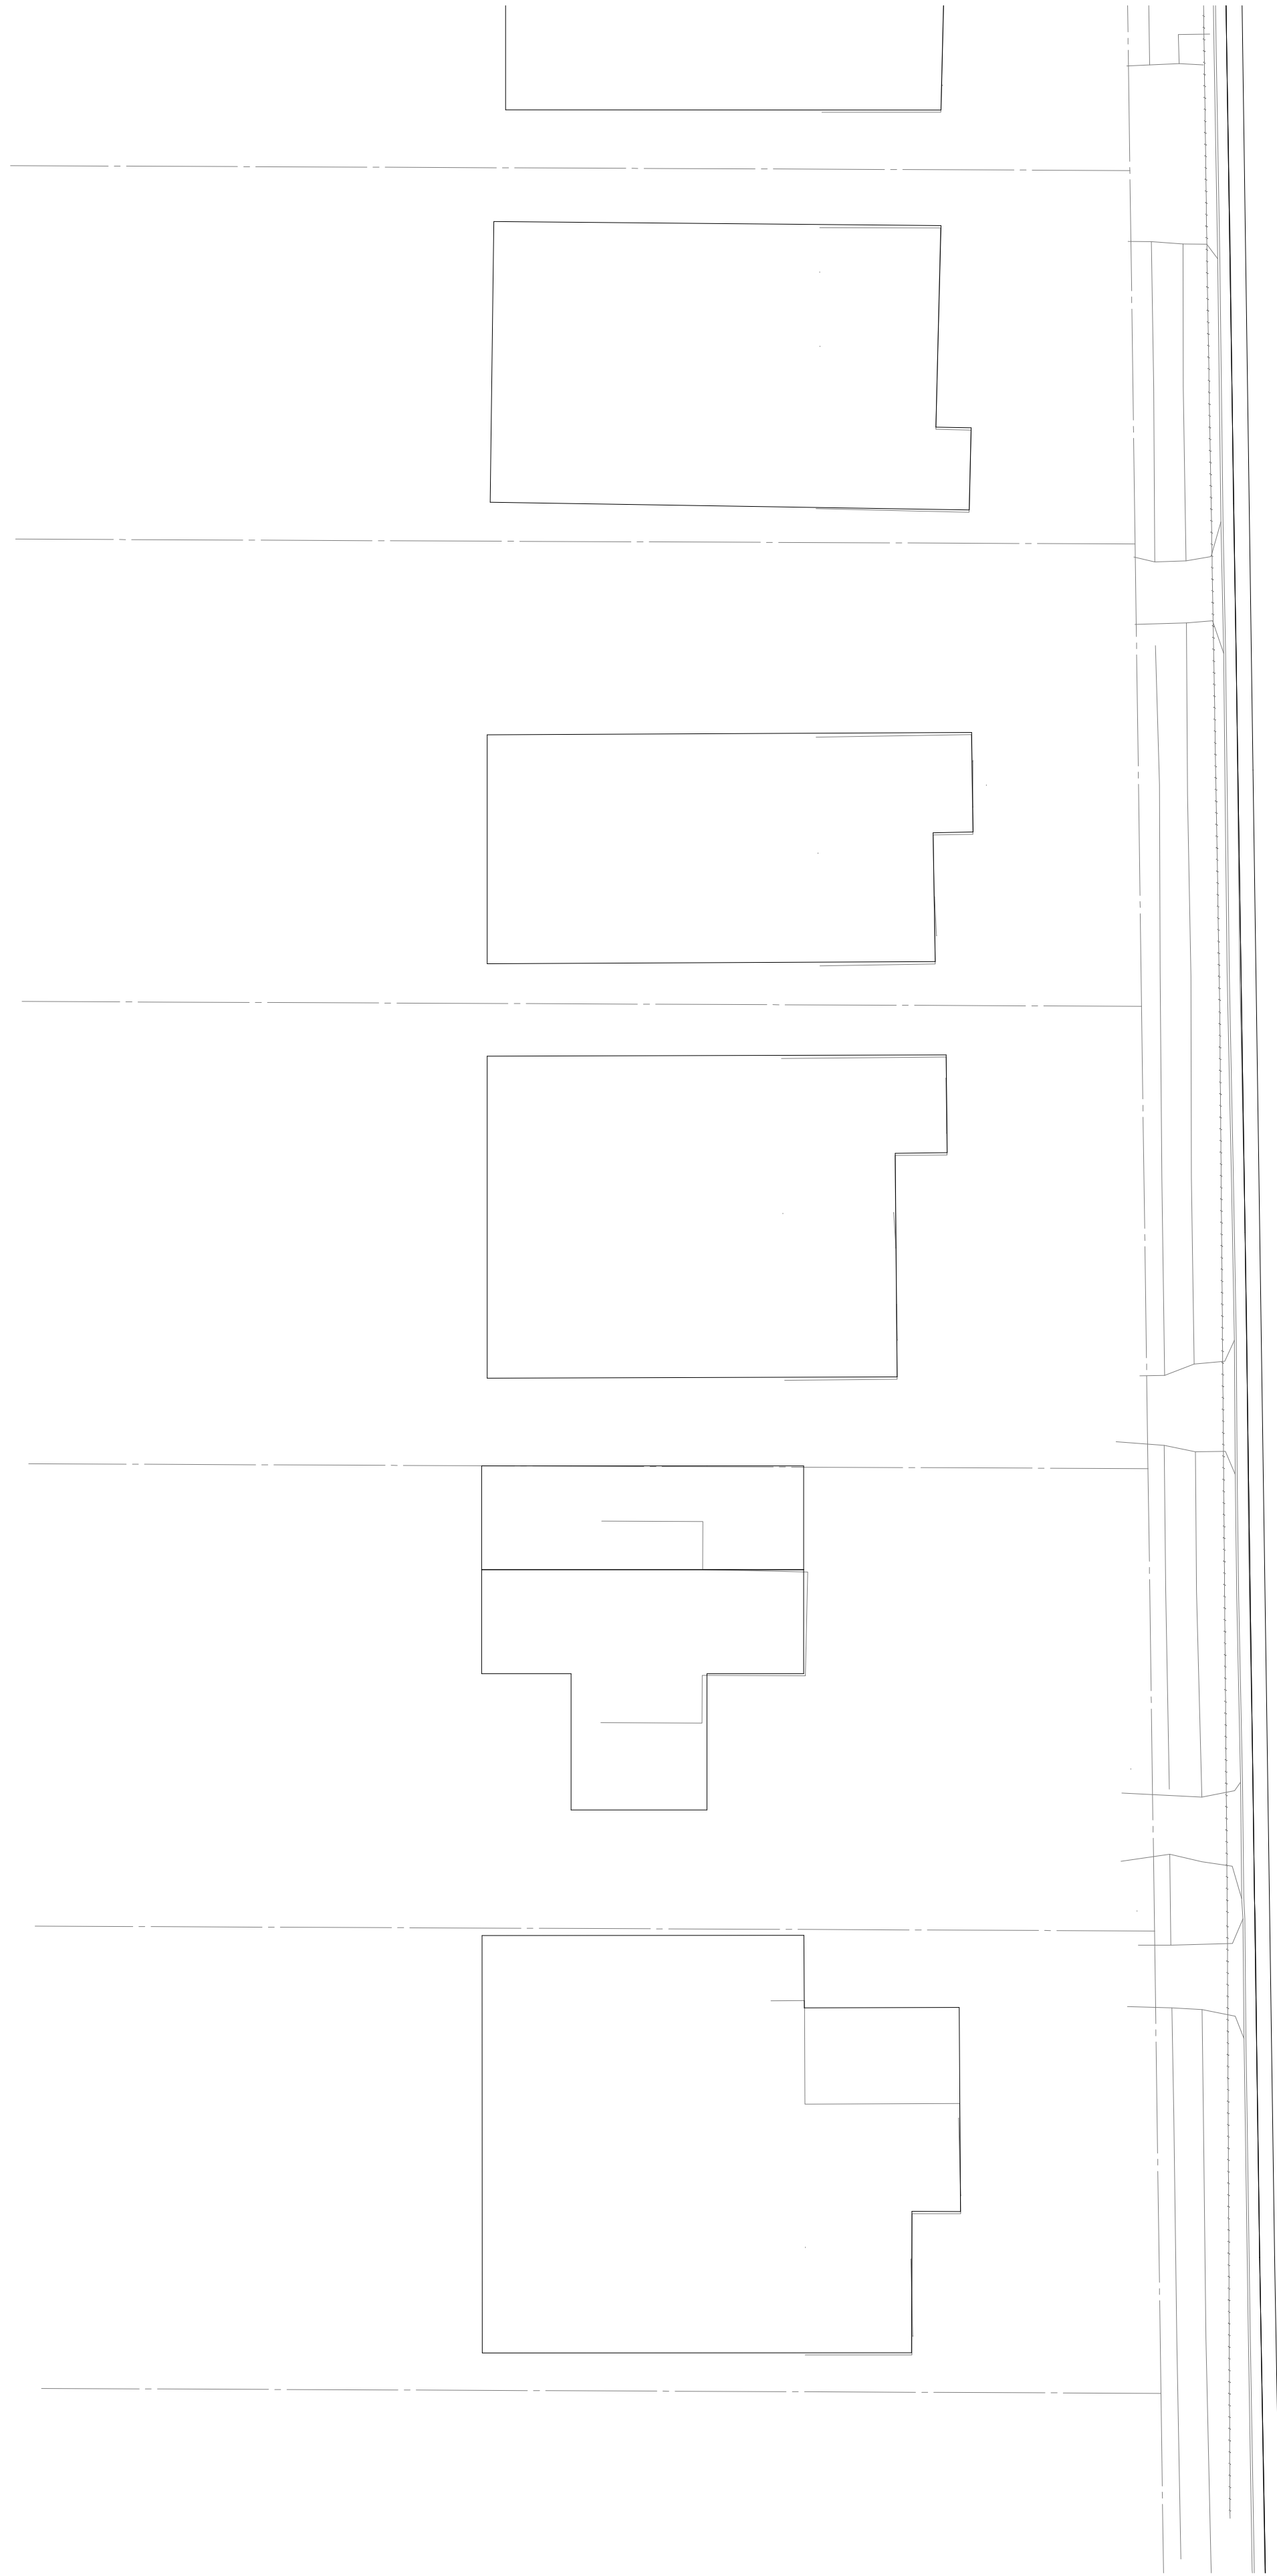

ROAD

CARLINGFORD



WARD


ADJOINS L201

AMENDMENTS			
REV	BY	DATE	DESCRIPTION
A	YP	07.07.2021	ISSUED FOR RTS



DRAWING NAME
LANDSCAPE: FINISHES PLAN

PROJECT
EPPING WEST PUBLIC SCHOOL
ALTERATIONS AND ADDITIONS
96 CARLINGFORD RD EPPING NSW

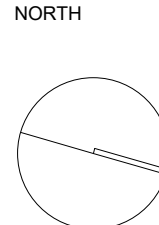

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SCALE 1 : 200 @ A1

07 JULY 2021


PROJECTDISCIPLINEPHASESERIES NUMBERREVISION

EPPW - LA - SSDA - L200A



PLANT LIST						
SYMBOL	BOTANICAL NAME	COMMON NAME	QUANTITY	SIZE	HEIGHT X WDMTH	NATIVE SPECIES
CUMBERLAND PLAIN WOODLAND						
TREES (TO BE CONSIDERED UNDER A SEPARATE PLANNING PATHWAY)						
BMJ	<i>Backhousia myrtifolia</i>	Grey Myrtle	9	200 Pot	6 x 4m	y
MLJ	<i>Melaleuca linariifolia</i>	Snow in Summer	9	200 Pot	7 x 5m	y
SHRUBS (TO BE CONSIDERED UNDER A SEPARATE PLANNING PATHWAY)						
BSP	<i>Banksia spinulosa</i>	Heath Banksia	20	150 Pot	3 x 2m	y
BOB	<i>Breynia oblongifolia</i>	Coffee Bush	20	150 Pot	2 x 2m	y
CSU	<i>Callistemon subulatus</i>	Bottlebrush	20	150 Pot	2 x 2m	y
CTO	<i>Clerodendrum tomentosum</i>	Hairy Lilly Bush	20	150 Pot	4 x 3m	y
DFA	<i>Dodonaea falcata</i>	Hop Bush	20	150 Pot	2 x 2m	y
GJU	<i>Grevillea juniperina</i>	Juniper Grevillea	20	150 Pot	2 x 2m	y
GSE	<i>Grevillea sericea</i>	Pink Spider Flower	20	150 Pot	2 x 1m	y
ODI	<i>Ozothamnus diosmifolius</i>	Sago	20	150 Pot	2 x 1m	y
GRASSES (TO BE CONSIDERED UNDER A SEPARATE PLANNING PATHWAY)						
DLO	<i>Dianella longifolia</i>	Blueberry Lily	375	75 Tube	1 x 0.5m	y
DREV	<i>Dianella revoluta</i>	Blue Flax-Lily	375	75 Tube	0.4 x 0.3m	y
DREP	<i>Dichondra repens</i>	Kidney Weed	375	75 Tube	0.14 x 0.5m	y
MST	<i>Microlaena stipoides</i>	Weeping Grass	375	75 Tube	0.25 x .5m	y
TAU	<i>Themeda australis</i>	Kangaroo Grass	375	75 Tube	1.5 x 0.5m	y
WST	<i>Wahlenbergia stricta</i>	Australian Bluebell	375	75 Tube	0.4 x 0.4m	y
GENERAL PLANTING						
INDIGENOUS TREES						
ASM	<i>Acmena smithii</i>	Lilly Pilly	2	200 Pot	5 x 3m	y
ALL	<i>Allocasuarina littoralis</i>	Black Sheoak	2	200 Pot	10 x 4m	y
BIN	<i>Banksia integrifolia</i>	Coast Banksia	2	200 Pot	10 x 6m	y
CGU	<i>Ceratopetalum gummiferum</i>	Christmas Bush	2	200 Pot	5 x 3m	y
ERE	<i>Elaeocarpus reticulatus</i>	Blueberry Ash	2	200 Pot	8 x 6m	y
TLA	<i>Tristanopsis laurina</i>	Water Gum	2	200 Pot	12 x 6m	y
DECIDUOUS TREES						
ASS	<i>Acer 'autumn blaze'</i>	Freeman Maple	3	75L	15 x 7m	
FPUR	<i>Fraxinus 'urbanite'</i>	Ash	3	75L	11 x 8m	
PCA	<i>Pyrus 'capital'</i>	Ornamental Pear	3	75L	12 x 3m	
SCREENING PLANTS						
ACS	<i>Acmena allyn magic</i>	Dwarf Lilly Pilly	35	150 Pot	3 x 2m	y
AFI	<i>Acmena Firescreen</i>	New Zealand Christmas Bush	35	150 Pot	5 x 5m	
GRH	<i>Grevillea 'Superb'</i>	Grevillea	35	150 Pot	2 x 3m	y
MLS	<i>Melaleuca linariifolia 'snow storm'</i>	Snowstorm	35	150 Pot	3 x 3m	y
MUP	<i>Muraya paniculata</i>	Mock Orange	35	150 Pot	3 x 3m	y
SNS	<i>Syzygium Northern Select</i>	Scrub Cherry	35	150 Pot	5 x 1.5m	y
VOD	<i>Viburnum odoratissimum</i>	Sweet Viburnum	35	150 Pot	6 x 4m	
SMALL/MEDIUM SHRUBS						
GGJ	<i>Callistemon 'Little John'</i>	Bottlebrush	55	150 Pot	1 x 1m	y
HDD	<i>Hebe diosmifolia Dwarf</i>	White Veronica	55	150 Pot	1 x 1m	
NDN	<i>Nandina domestica 'Nana'</i>	Sacred Bamboo	55	150 Pot	0.6 x 0.6m	y
LDB	<i>Russelia equisetiformis</i>	Fountainbush	55	150 Pot	2 x 1m	
WSM	<i>Westringia zena</i>	Coast Rosemary	55	150 Pot	1 x 1m	y
GROUNDCOVERS AND GRASSES						
CAP	<i>Carex appressa</i>	Sedge	95	150 Pot	0.7 x 0.7m	y
CCI	<i>Casuarina 'Cousin It'</i>	Prostrate Casuarina	95	150 Pot	0.2 x 1m	y
DCA	<i>Dianella caerulea</i>	Blue Flax-Lily	95	150 Pot	0.5 x 1m	y
GGG	<i>Grevillea obtusifolia</i>	Grevillea	95	150 Pot	0.2 x 1m	y
LLT	<i>Lomandra 'Lime Tuff'</i>	Dwarf Matt Rush	95	150 Pot	0.7 x 0.7m	y
MPA	<i>Myoporum parvifolium</i>	Creeping Myoporum	95	150 Pot	0.3 x 1m	y
RAF	<i>Rhagodia 'Aussie Flat Bush'</i>	Salt Bush	95	150 Pot	0.4 x 1m	y
SSE	<i>Scenicio serpens</i>	Chalk Sticks	95	150 Pot	0.2 x 1m	
TAU	<i>Themeda australis</i>	Kangaroo Grass	95	150 Pot	0.7 x 0.7m	y
BUSH FOOD PLANT SCHEDULE						
TREES						
BCI	<i>Backhousia citriodora</i>	Lemon Myrtle	1	75L	8 x 4m	y
MPJ	<i>Macadamia integrifolia x tetraphylla</i>	Macadamia	1	75L	6 x 3m	y
PEL	<i>Podocarpus elatus</i>	Illawarra Plum Pine	2	75L	8 x 4m	y
SHRUBS						
BER	<i>Banksia ericifolia</i>	Heath Banksia	70	200 Pot	3 x 3m	y
CVI	<i>Callistemon viminalis</i>	Weeping Bottlebrush	70	200 Pot	4 x 3m	y
ATE	<i>Pultenaea villosa</i>	Hairy Bush Pea	70	200 Pot	1 x 1m	y
GRASSES/GROUNDCOVERS						
BSC	<i>Billardiera scandens</i>	Apple Berry	30	150 Pot	0.5 x 0.5m	y
DCA	<i>Dianella caerulea</i>	Blue Flax-Lily	30	150 Pot	0.5 x 1m	y
LLO	<i>Lomandra longifolia</i>	Spiny-Head Mat-Rush	30	150 Pot	1 X 0.6m	y
RSP	<i>Rhagodia spinescens</i>	Salt Bush	30	150 Pot	0.5 x 1m	y
RRO	<i>Rubus probus</i>	Atherton Raspberry	30	150 Pot	0.5 x 1m	y
SGLA	<i>Smilax glyciphylla</i>	Sarsparella	30	150 Pot	0.5 x 0.5m	y
TTE	<i>Tetragonia tetragonoides</i>	Native Spinach	30	150 Pot	0.2 x 1m	y

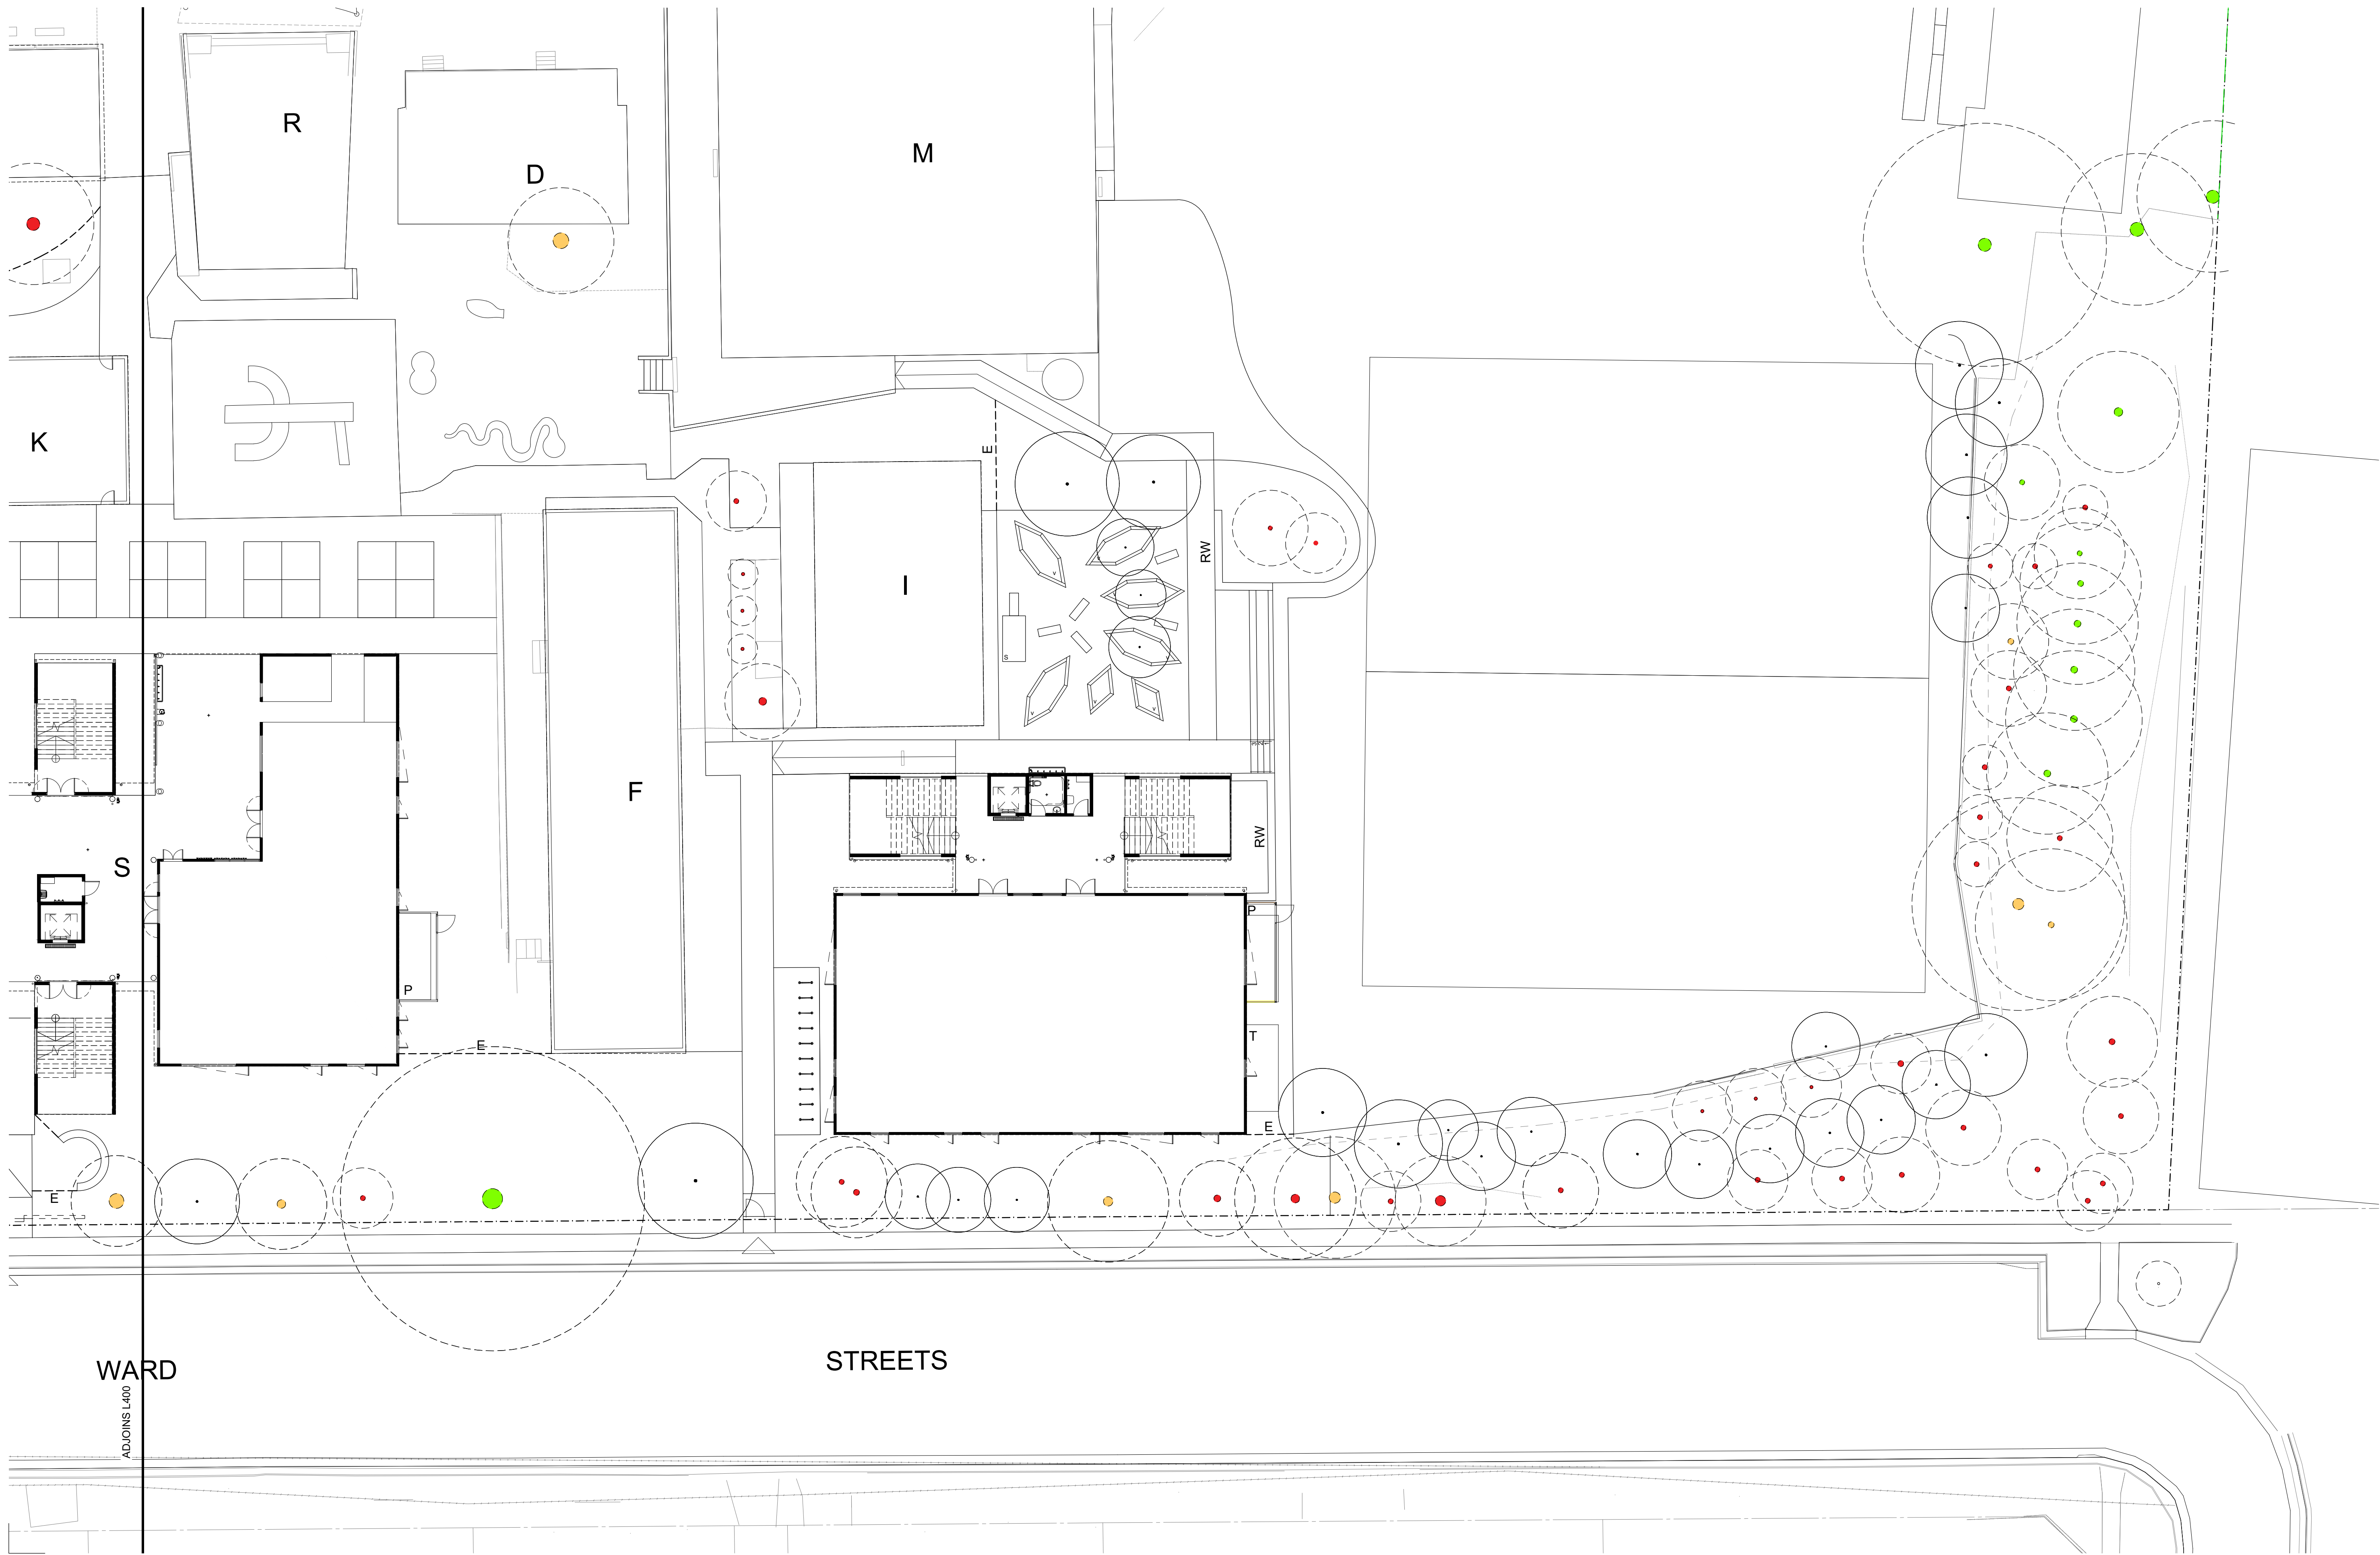


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REV	BY			
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Education



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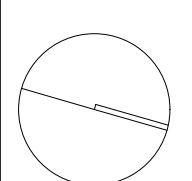
DRAWING NAME

LANDSCAPE: PLANTING PLAN

PROJECT

EPPING WEST PUBLIC SCHOOL
ALTERATIONS AND ADDITIONS
96 CARLINGFORD RD EPPING NSW

NORTH




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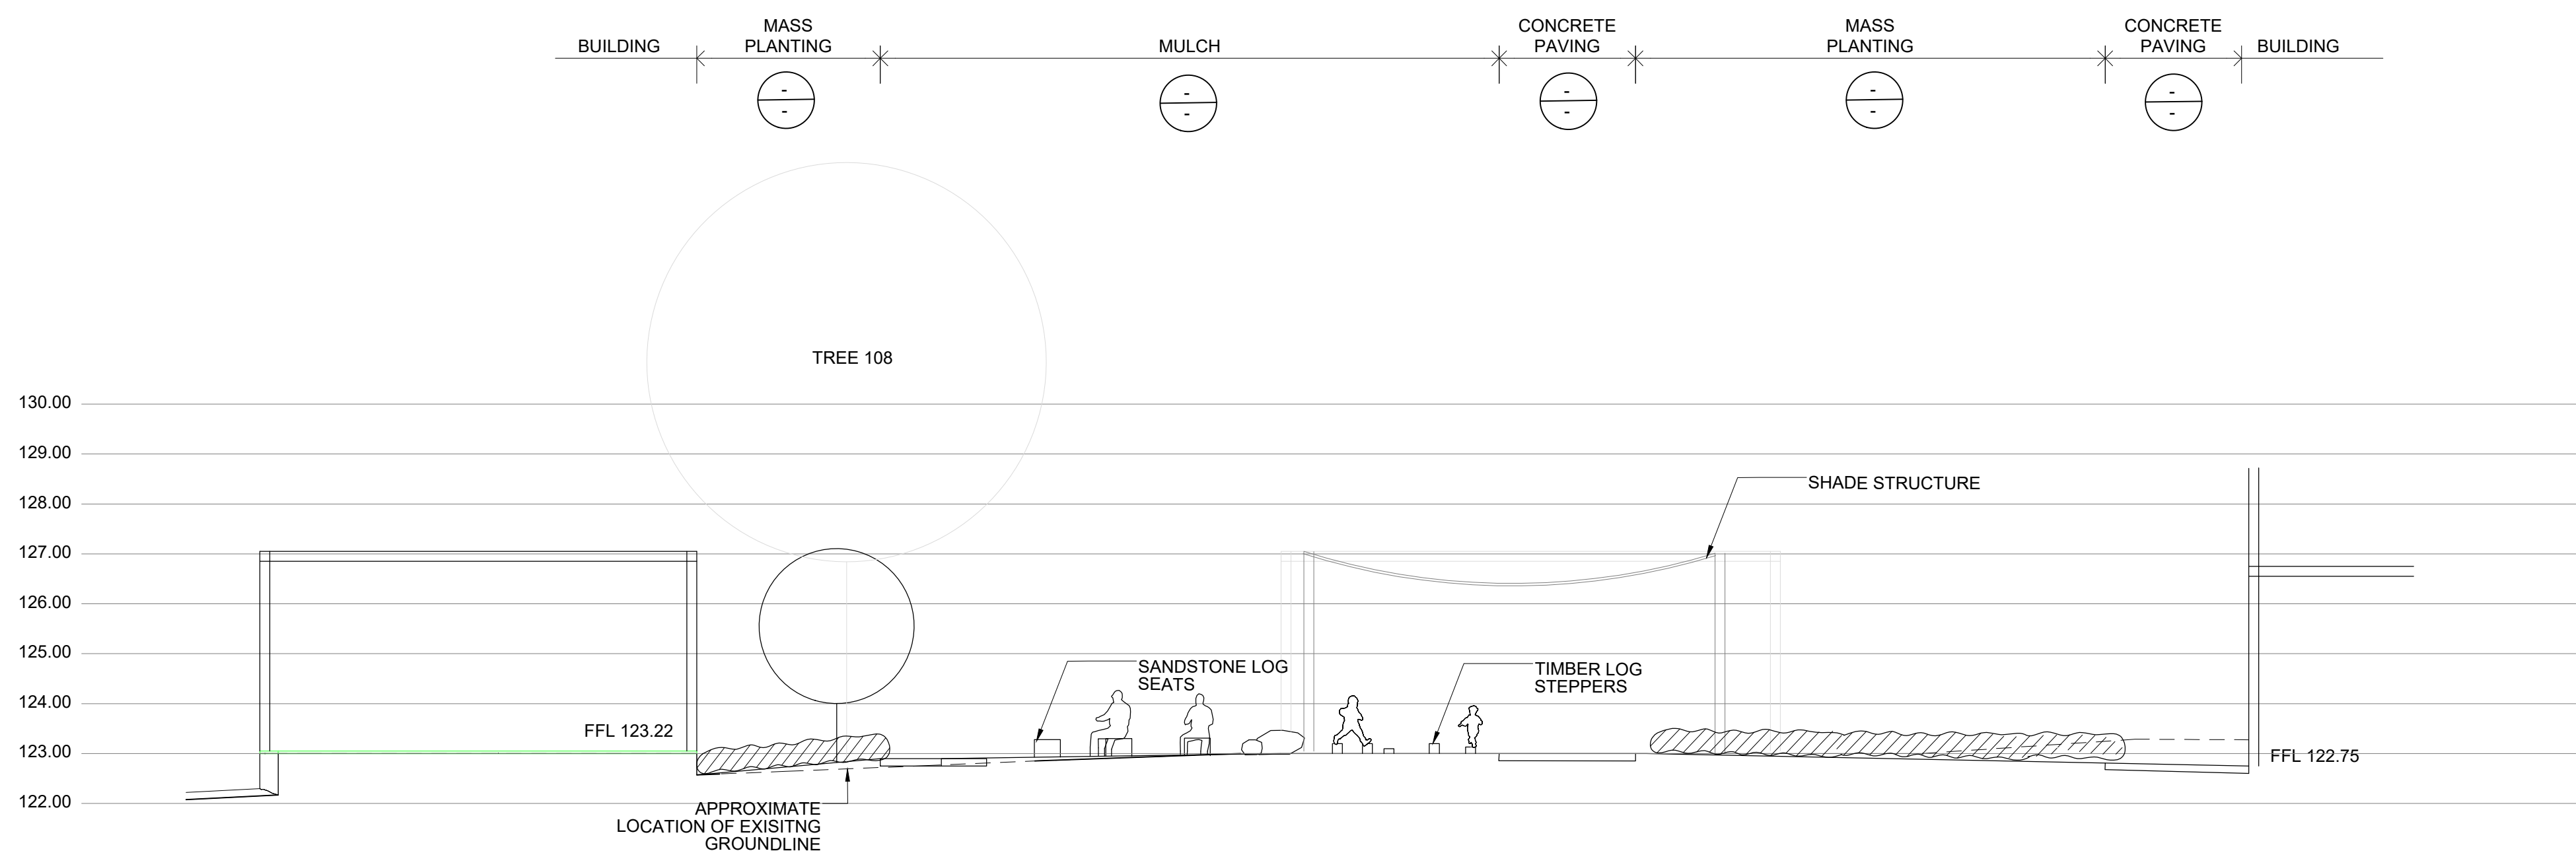
07 JULY 2021

PROJECT DISCIPLINE PHASE SERIES NUMBER REVISION


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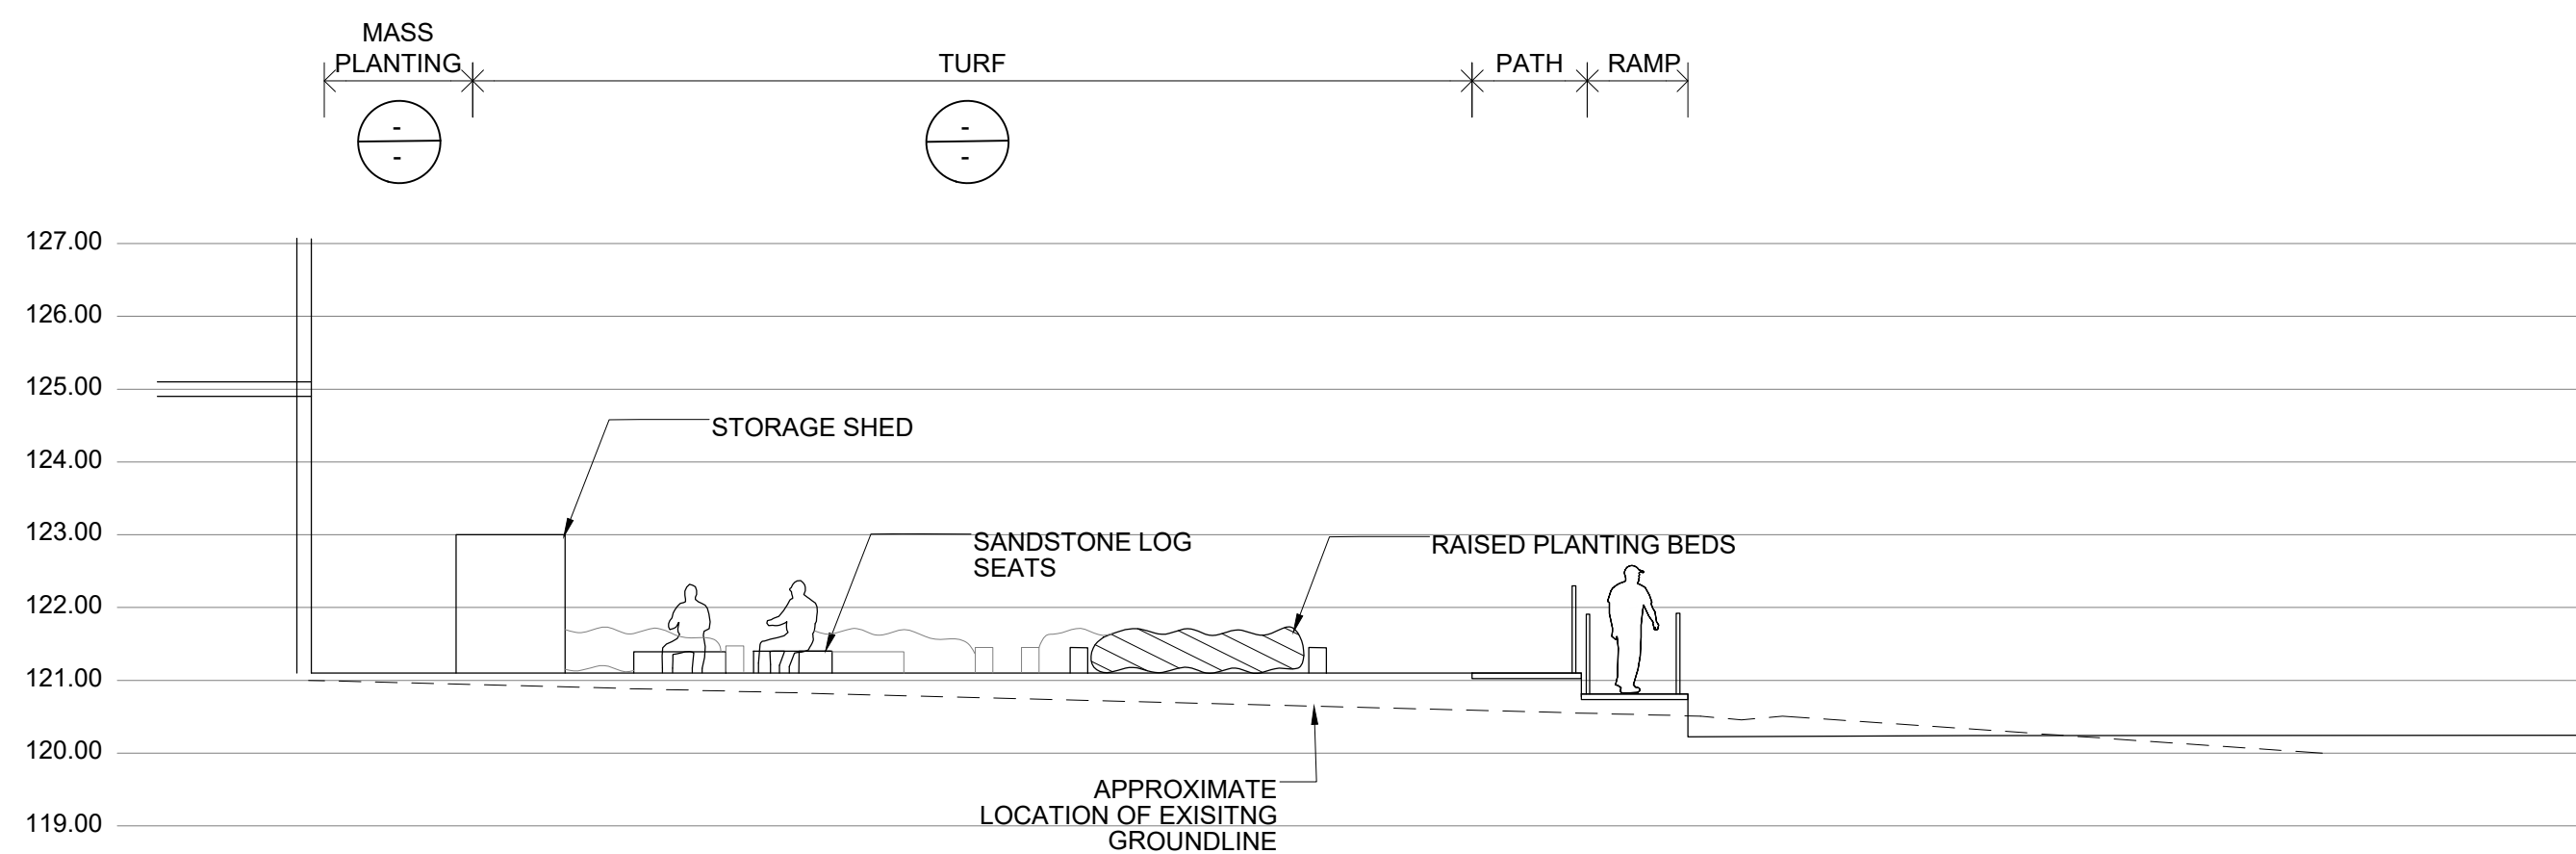
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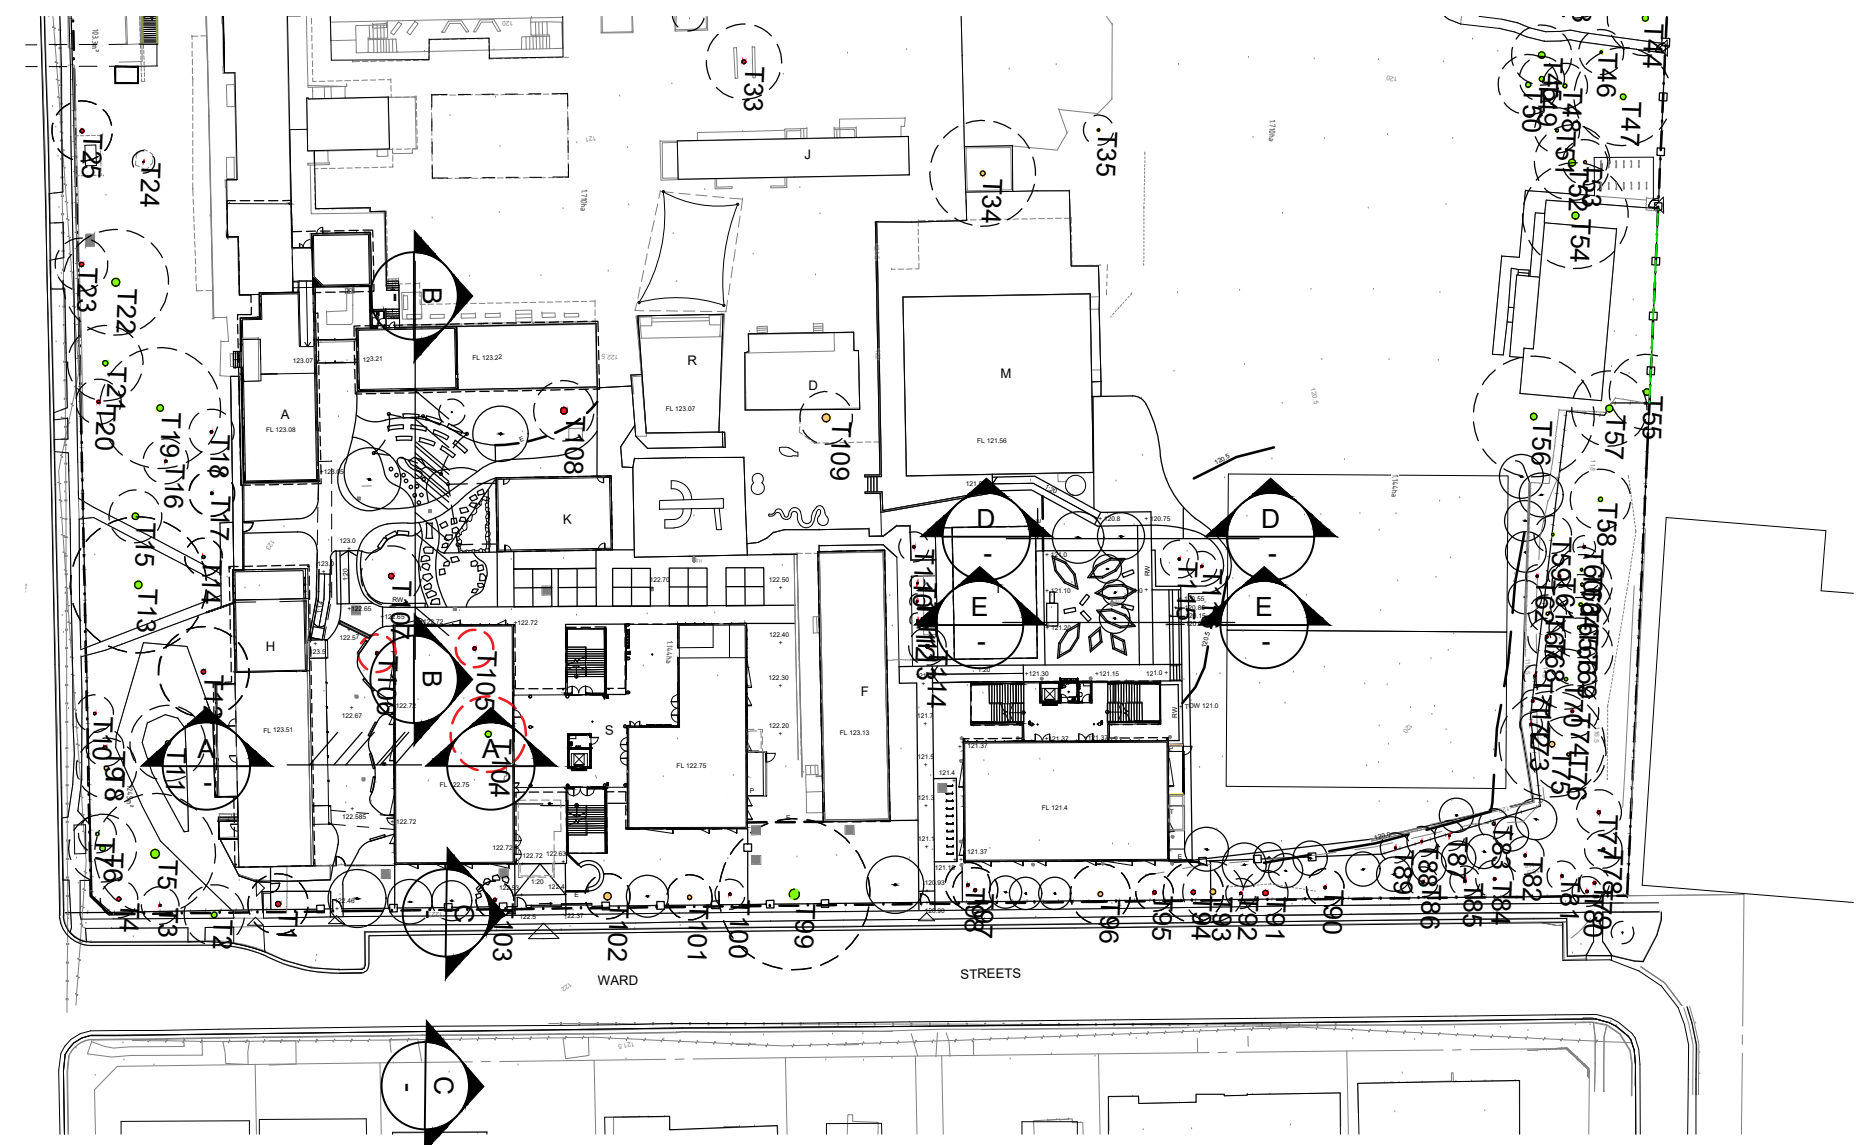
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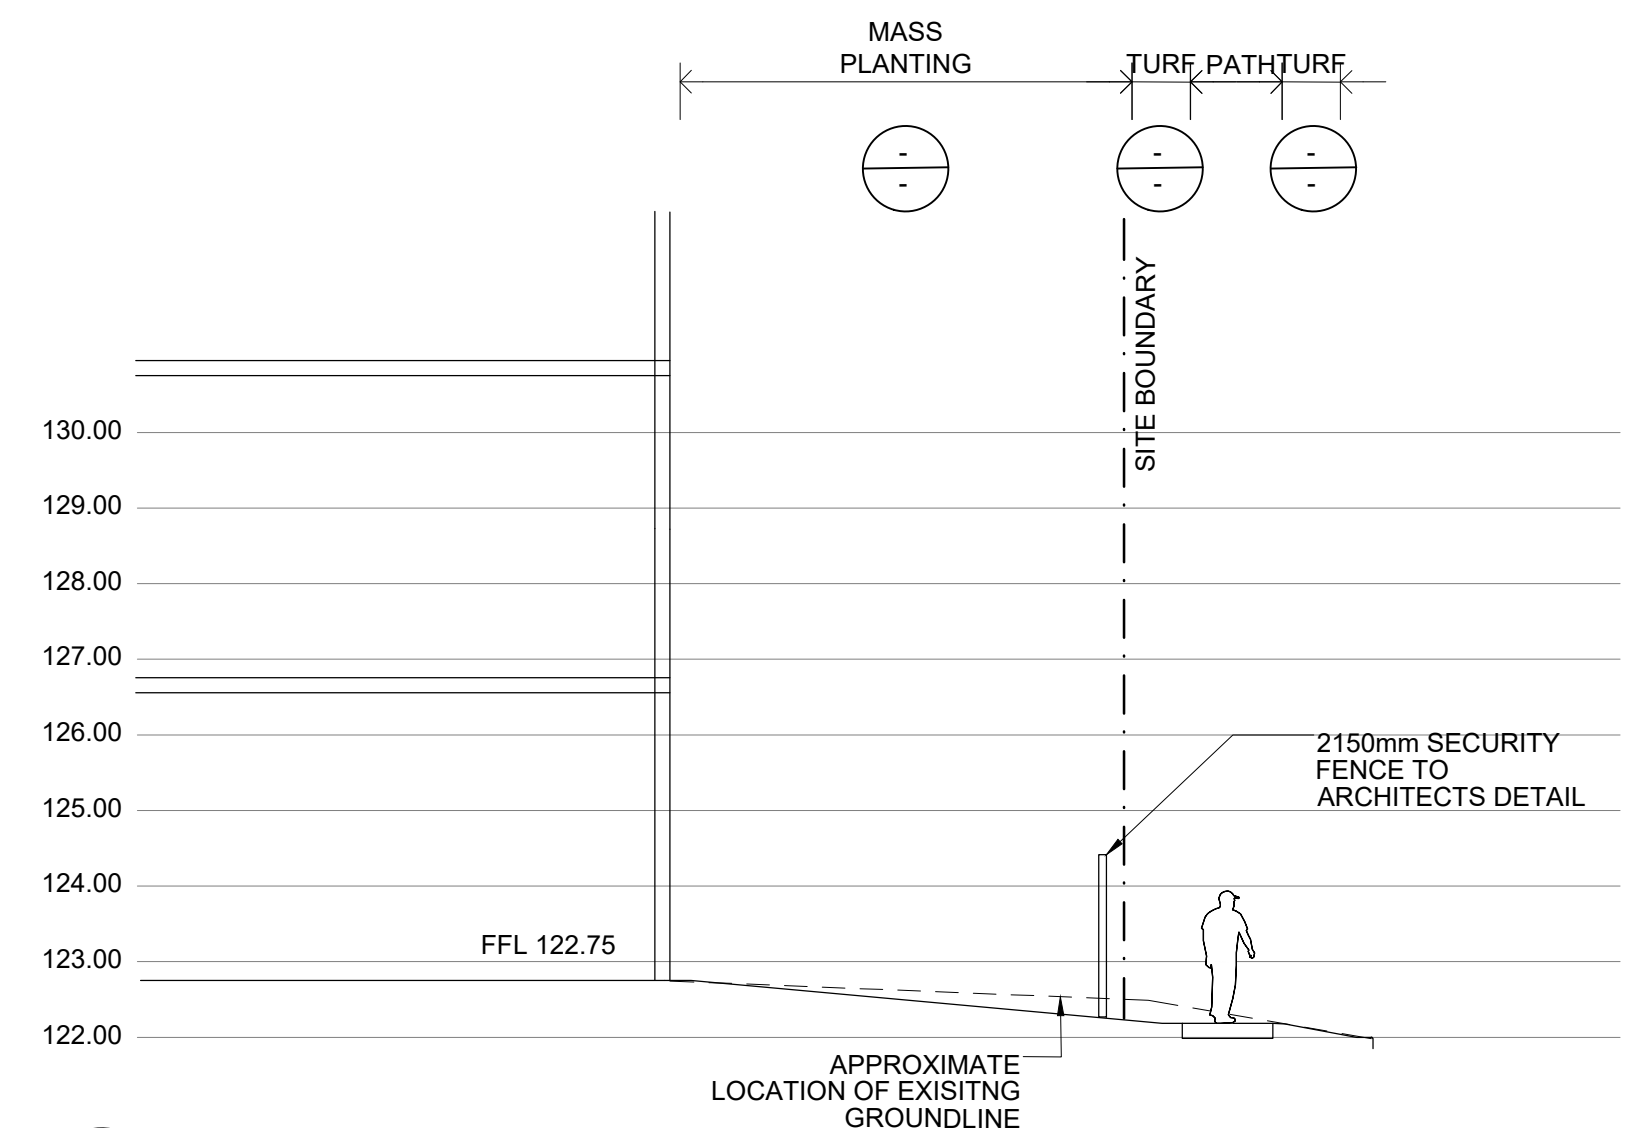
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SECTION EE
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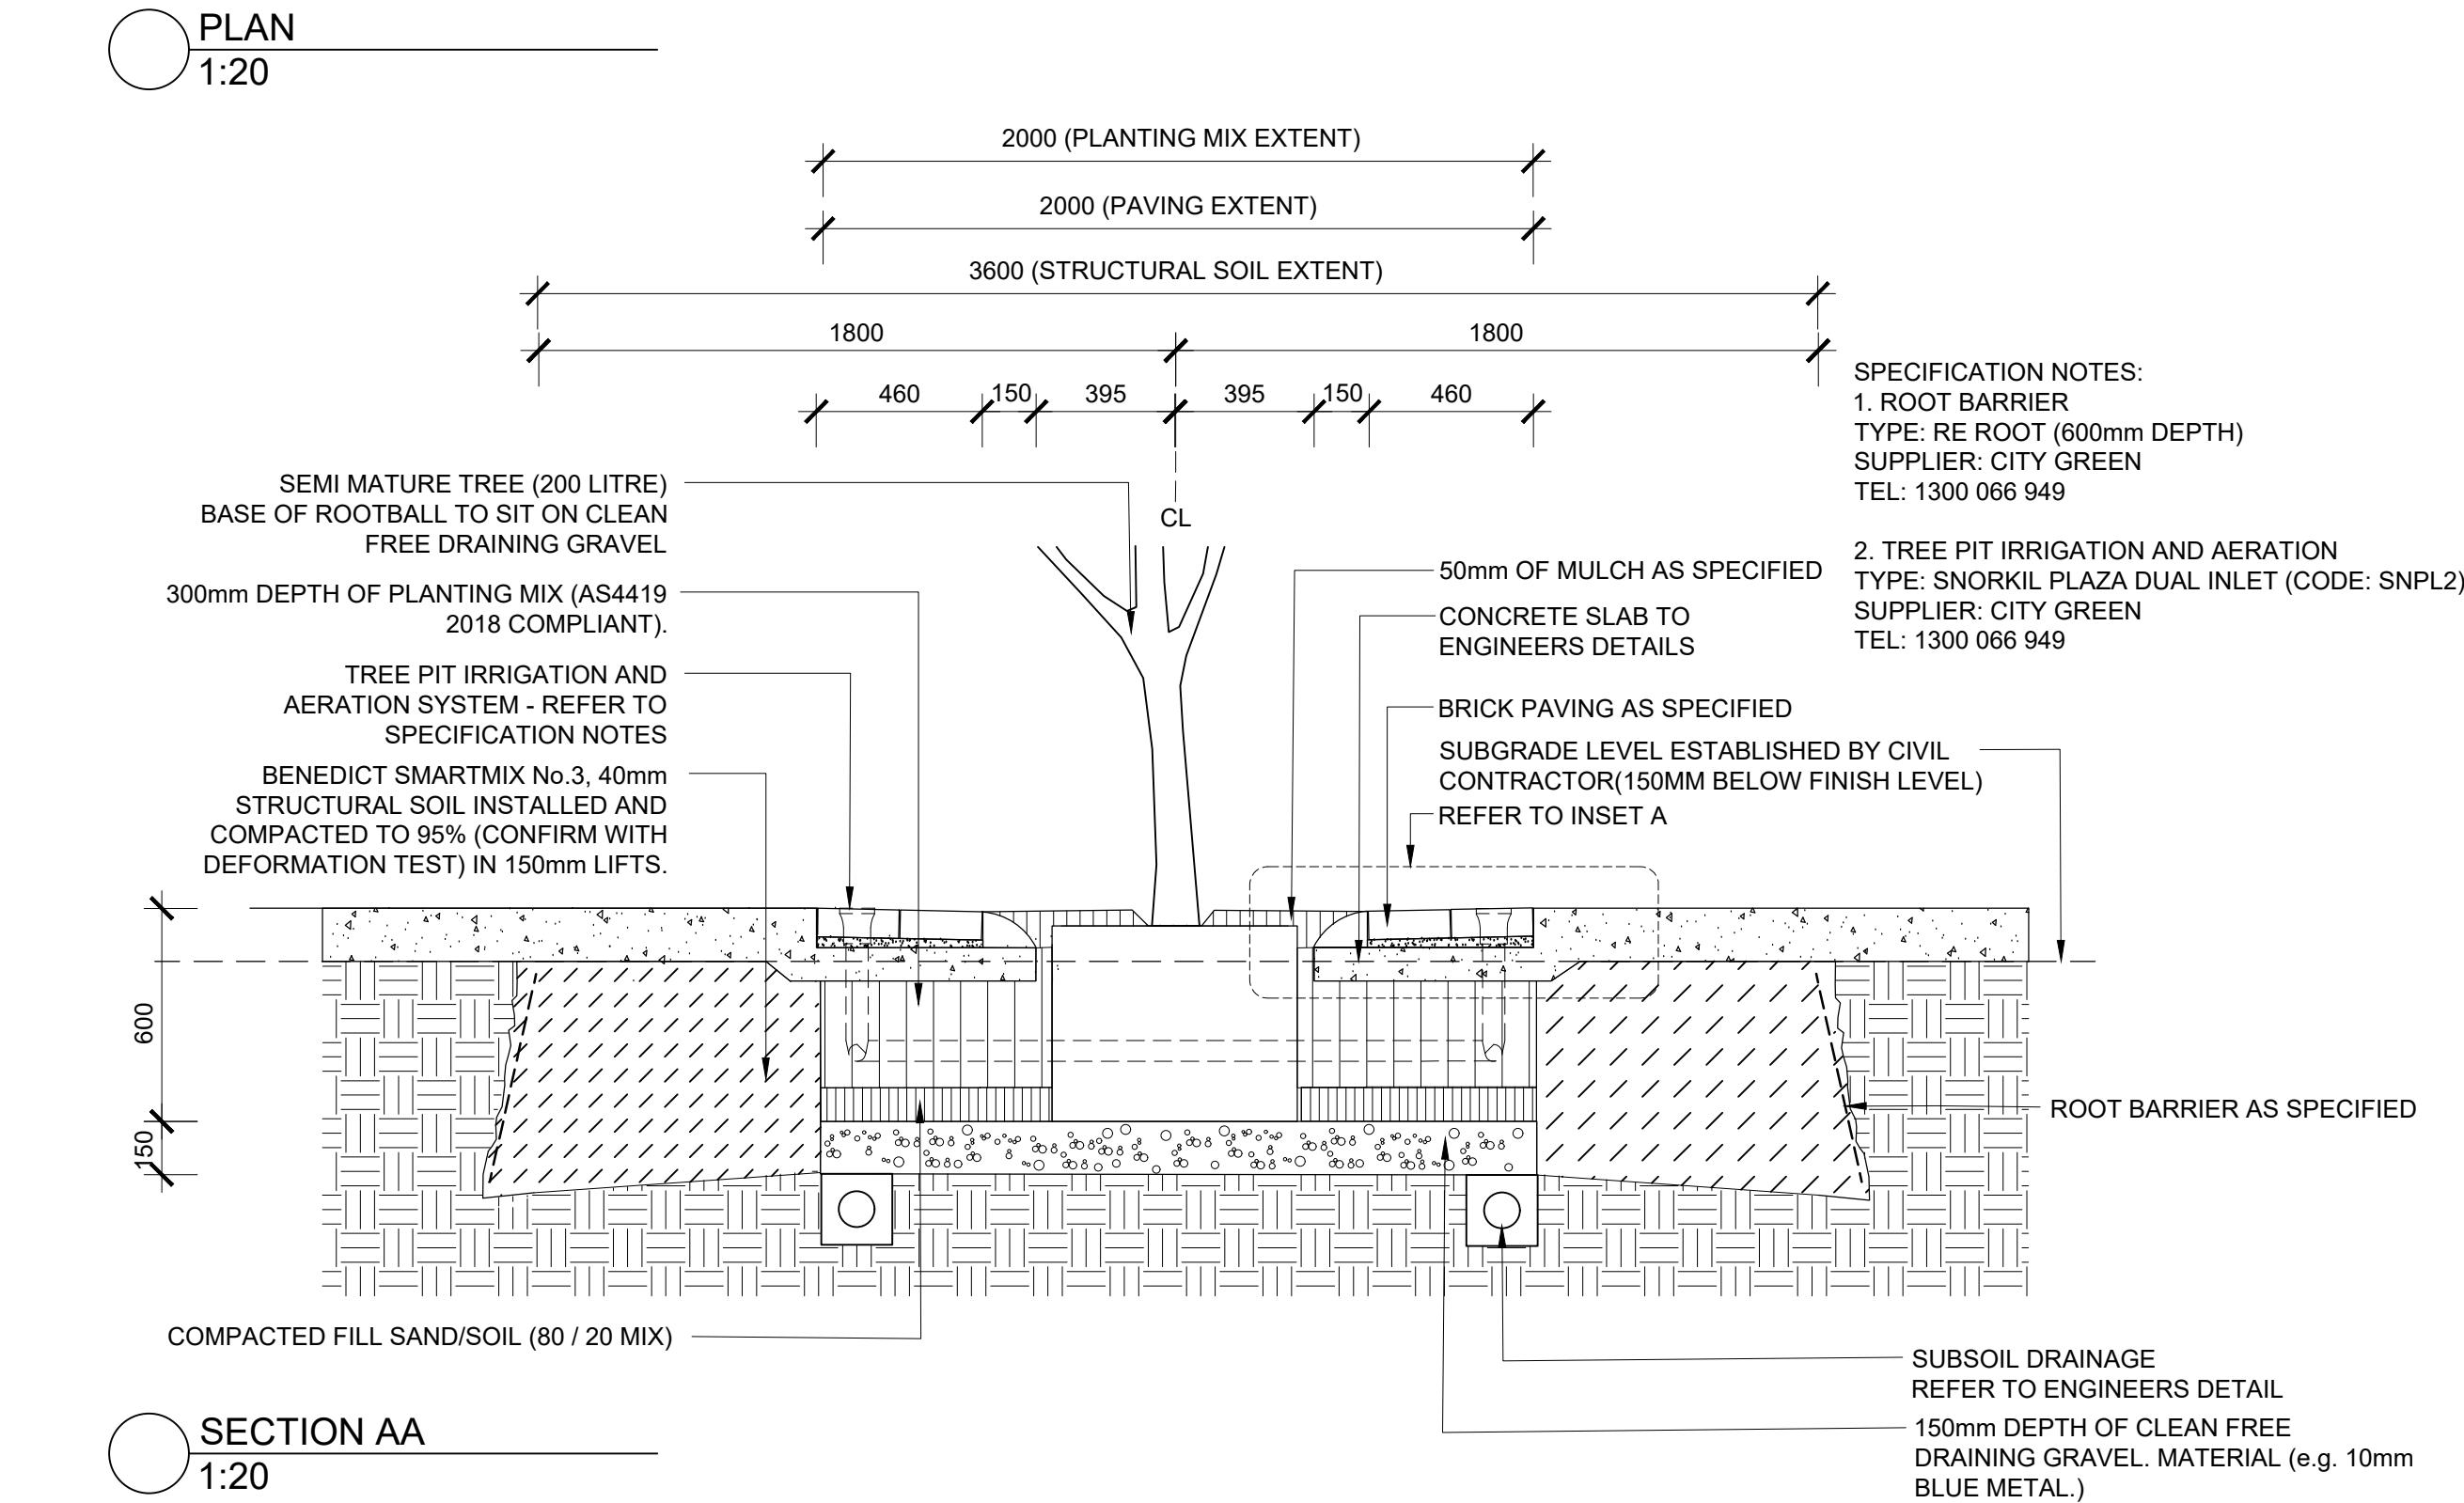
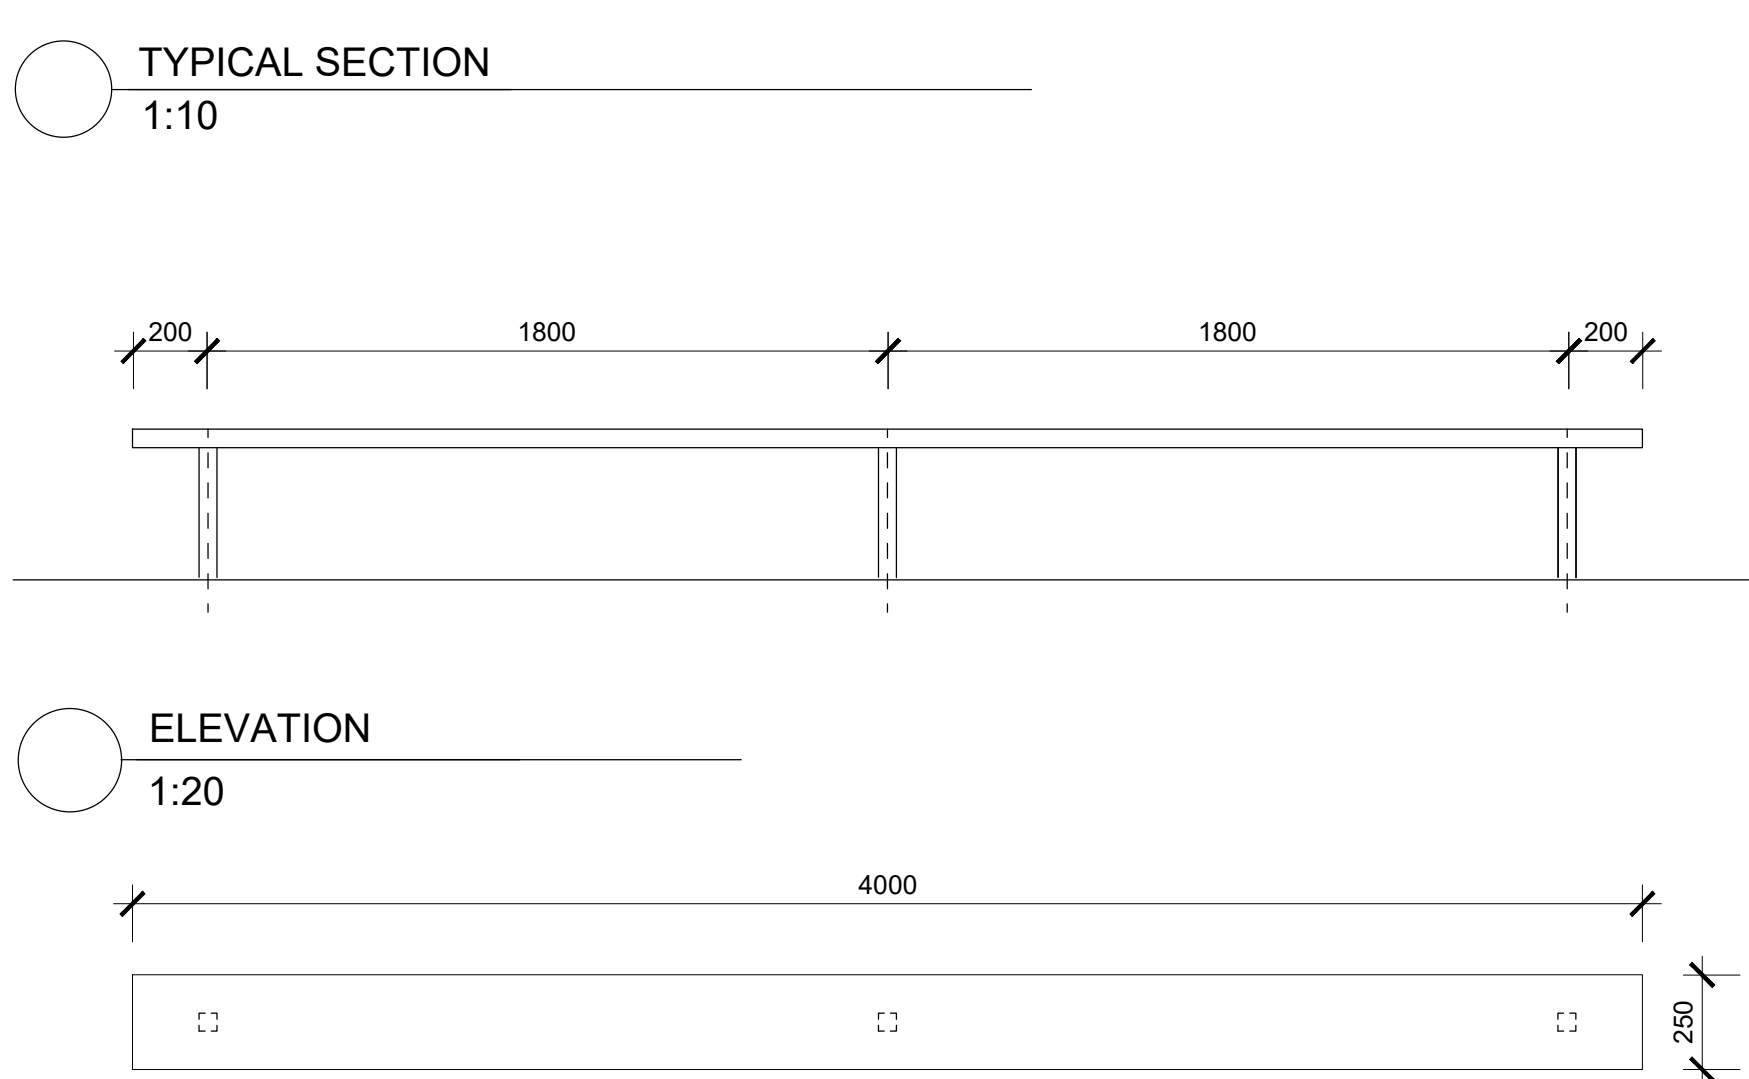
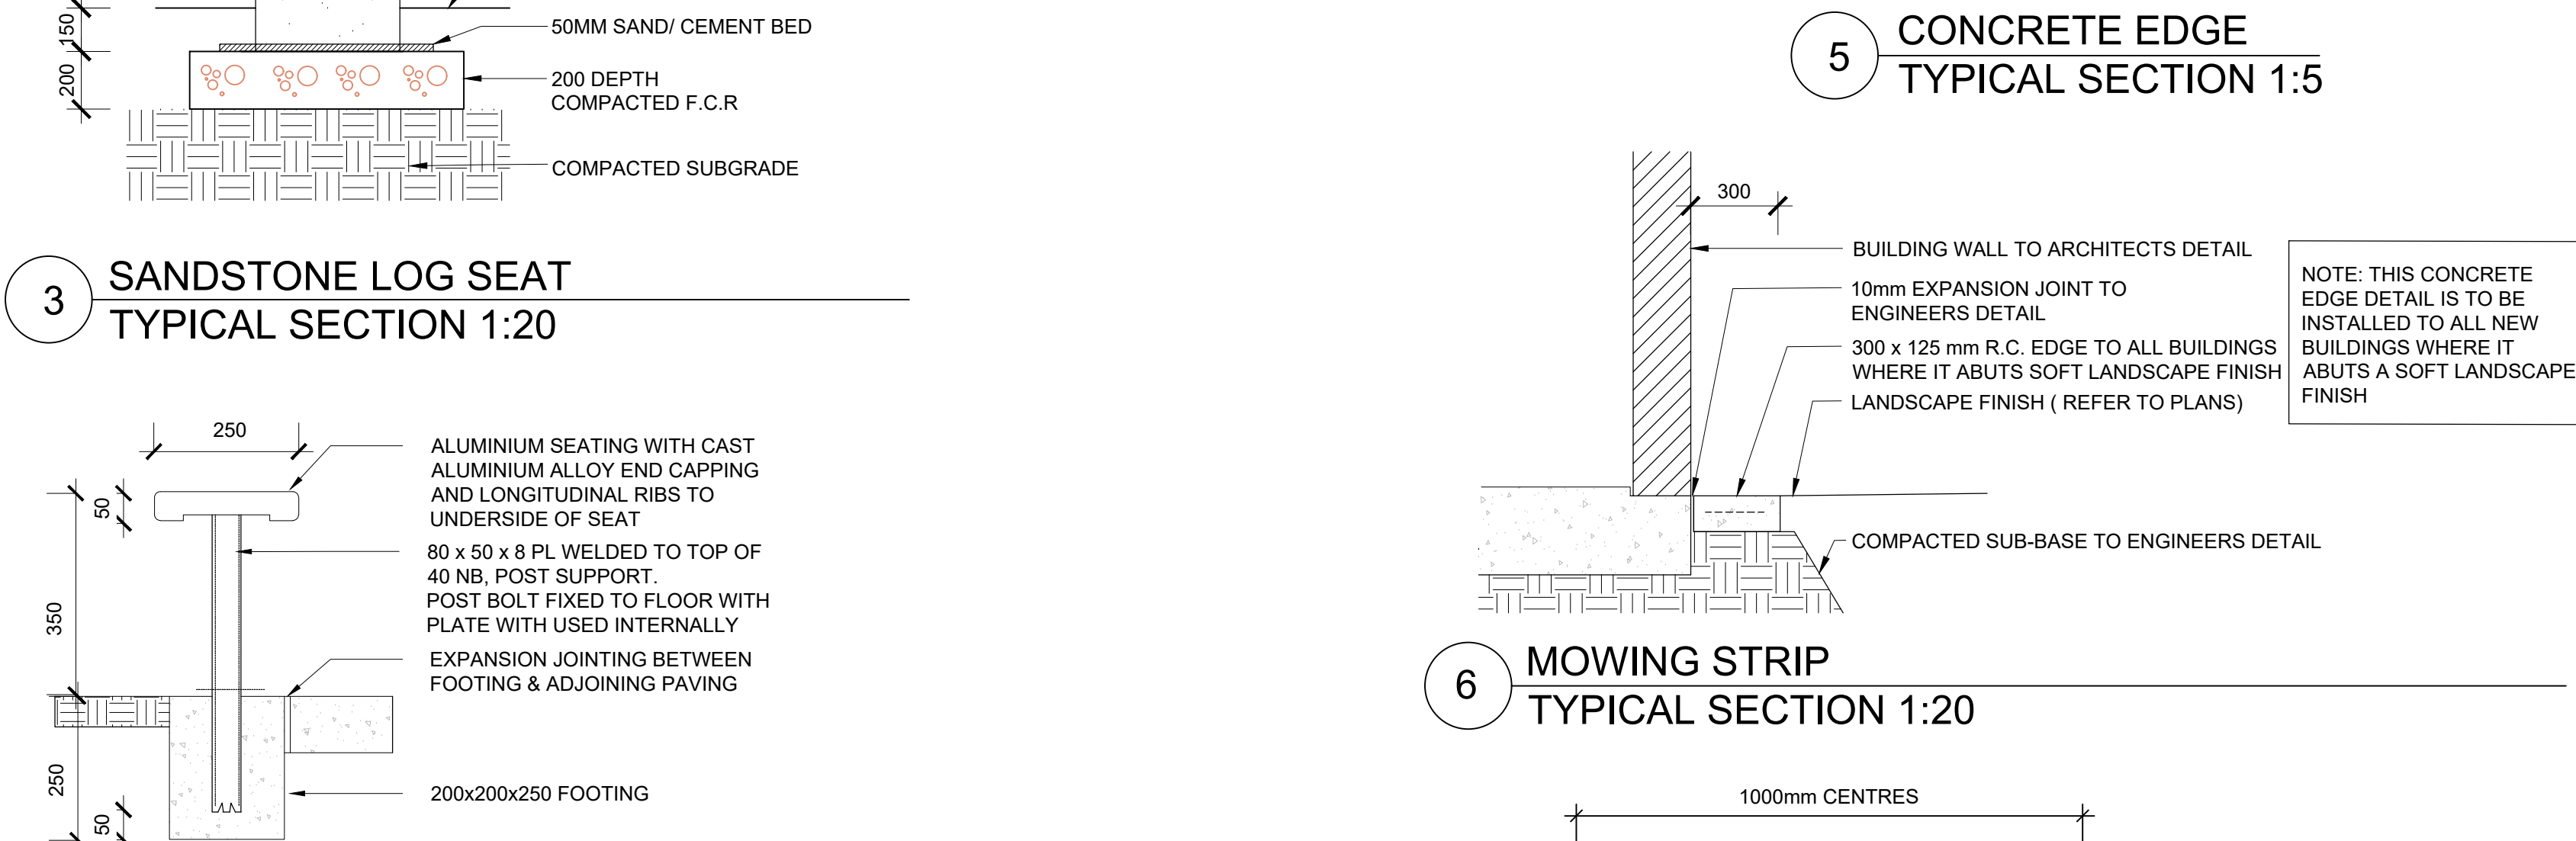
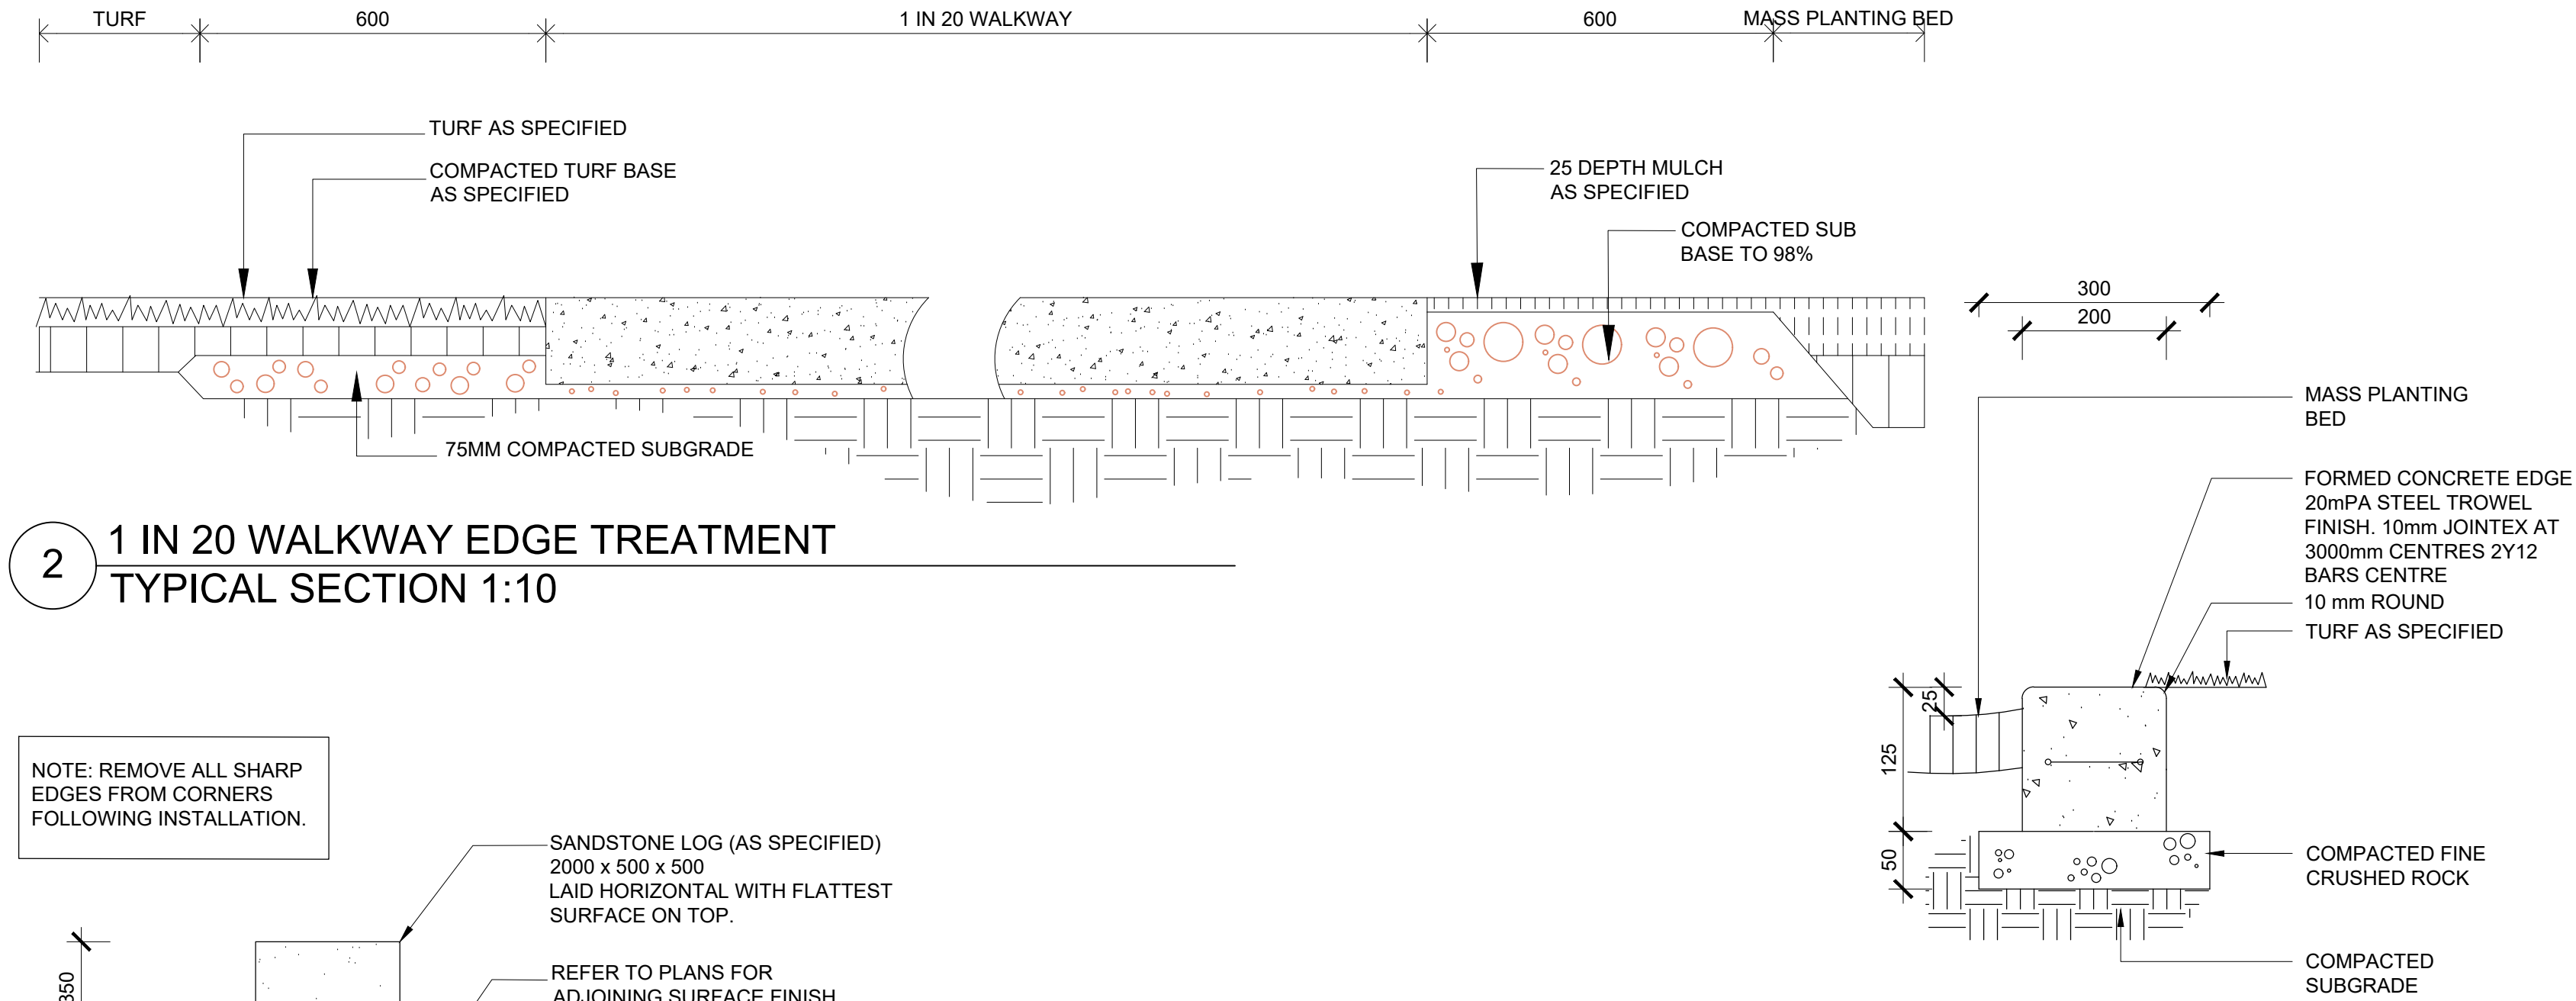
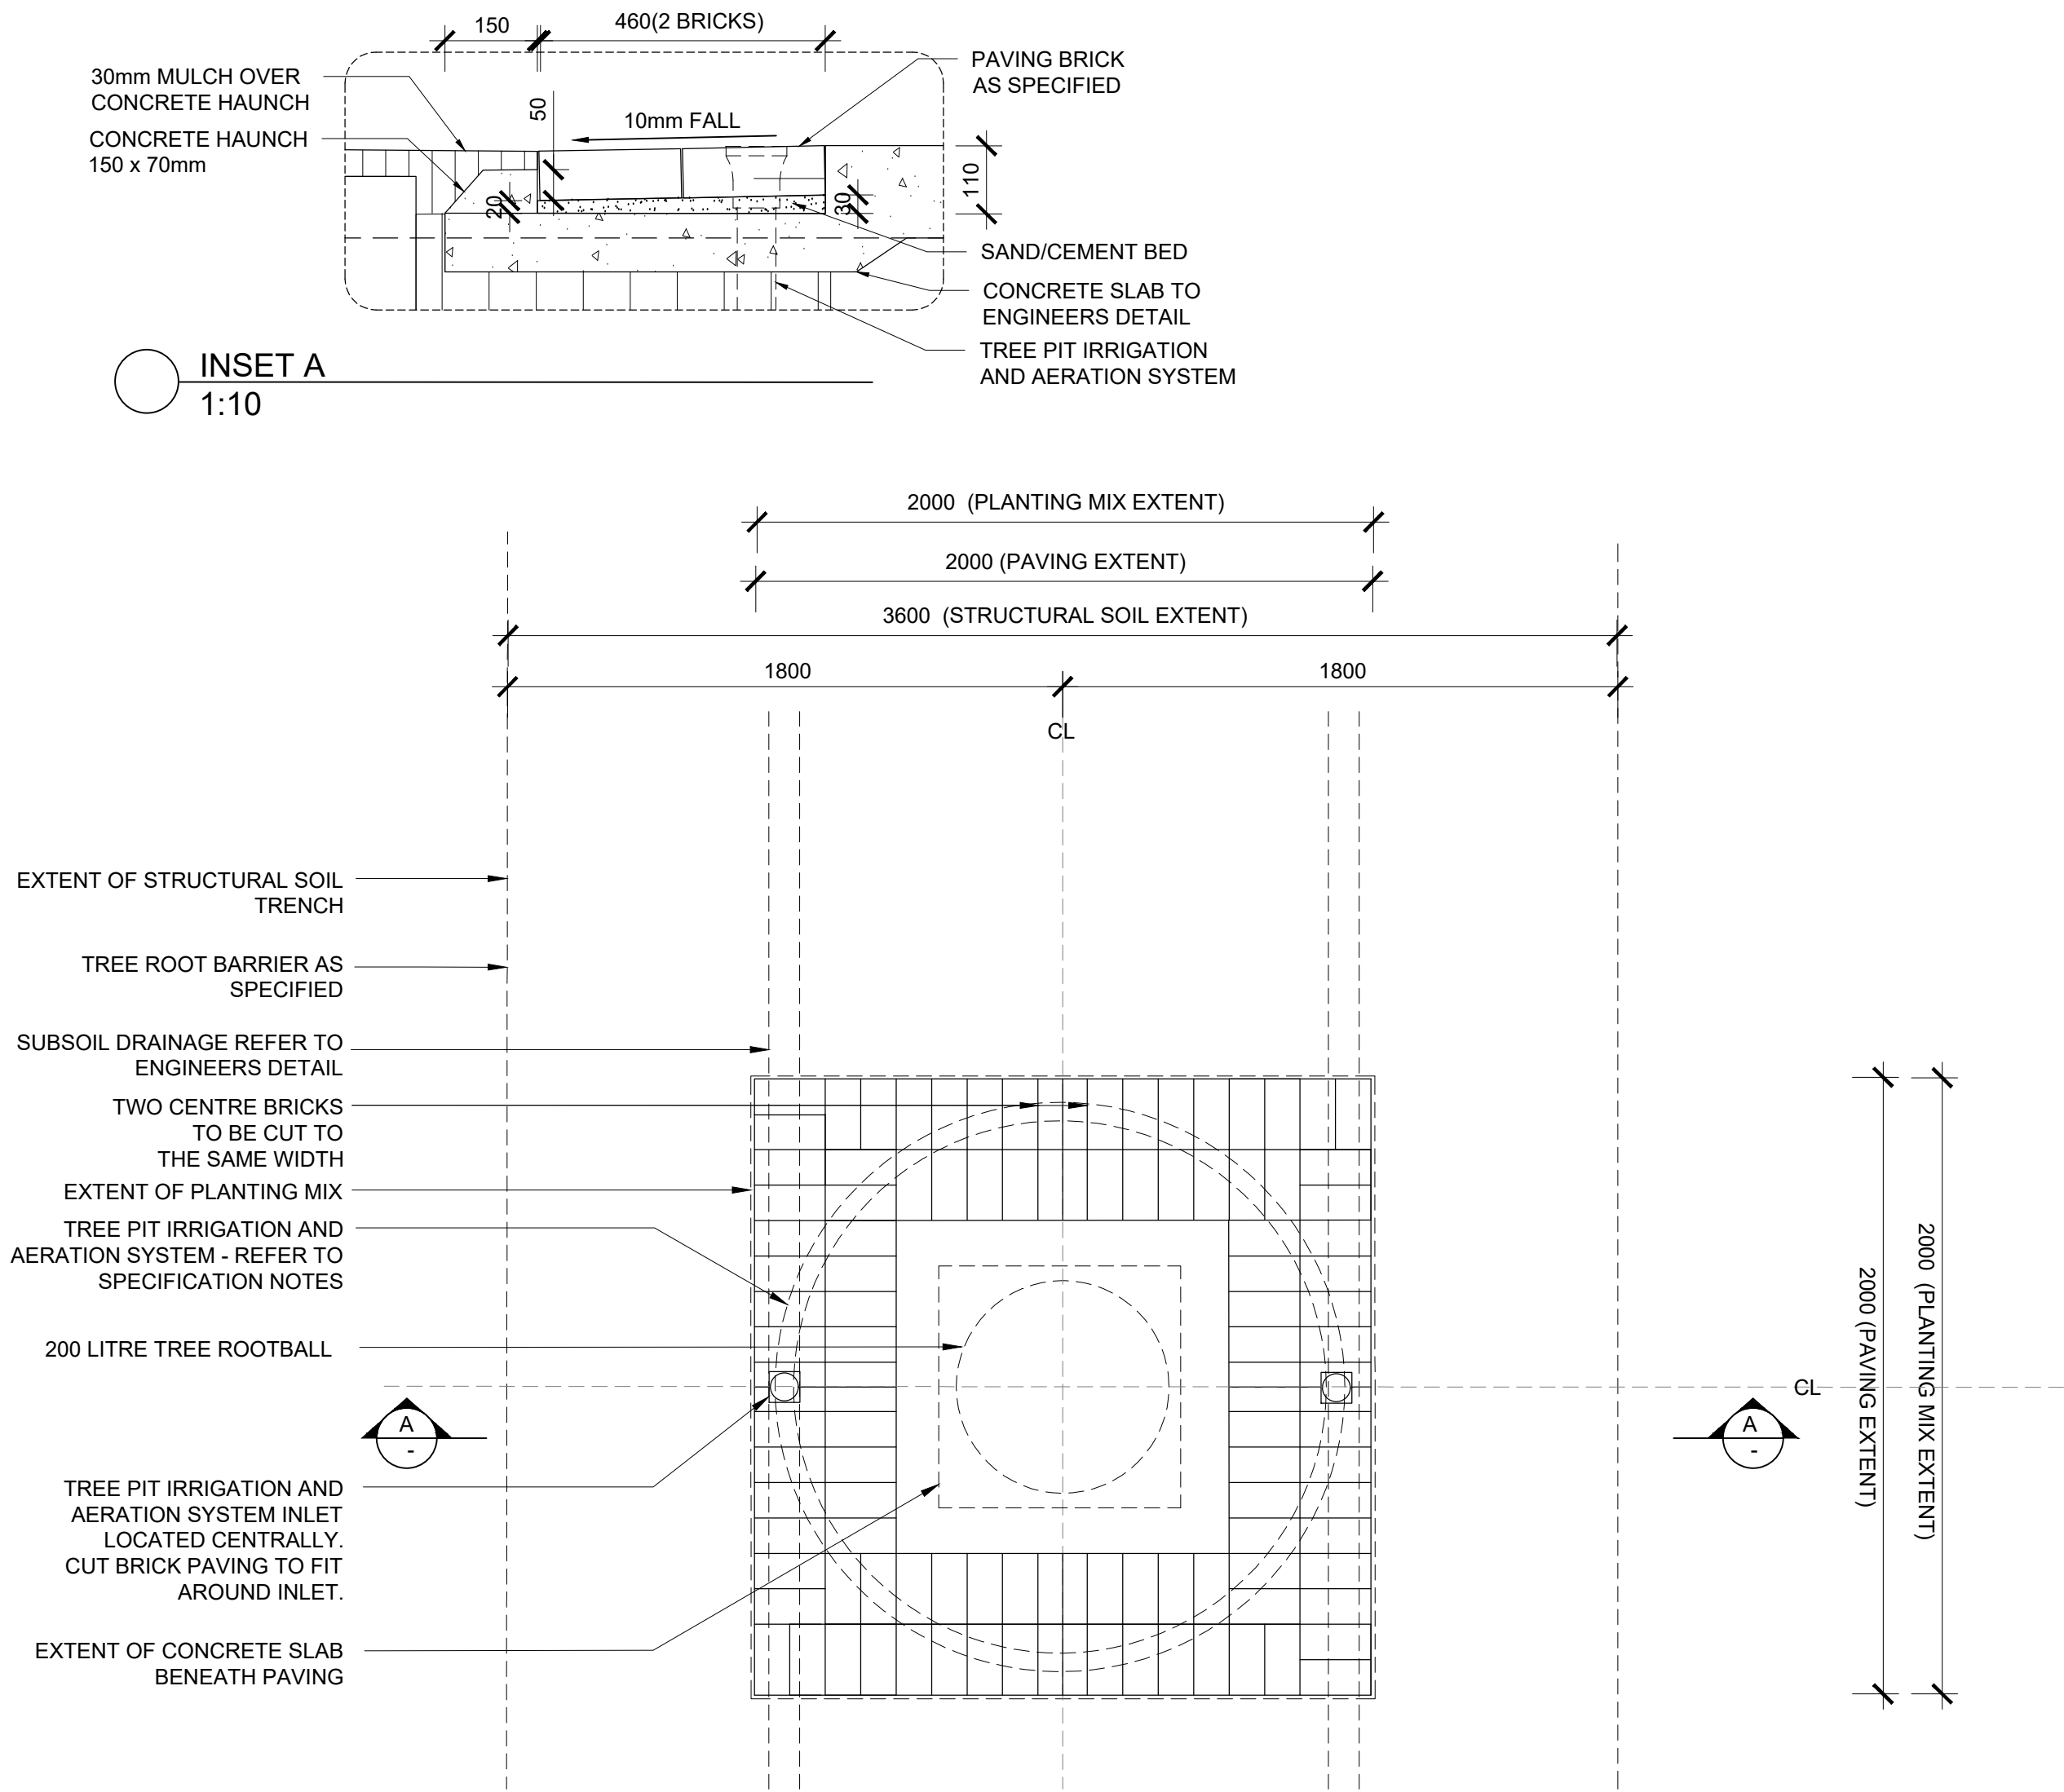


KEY PLAN



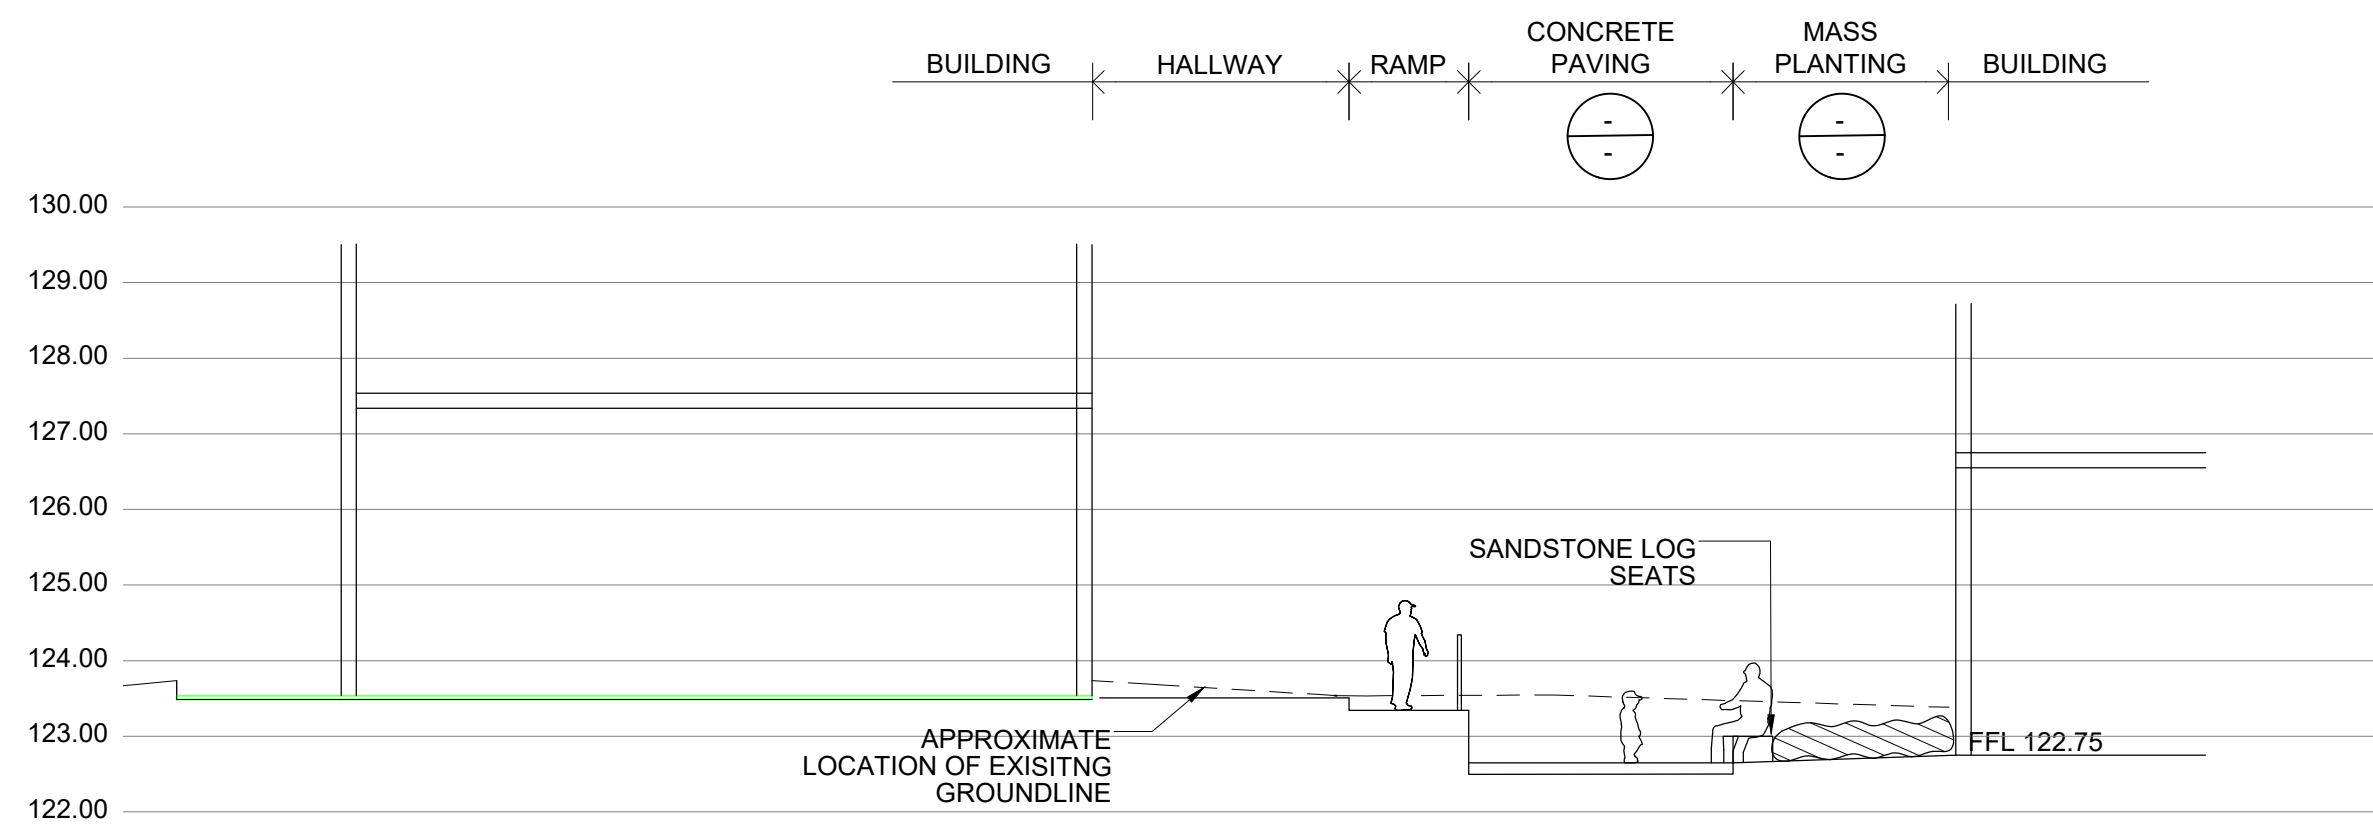


SECTION CC
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AMENDMENTS			
REV	BY	DATE	DESCRIPTION
A	YP	07.07.2021	ISSUED FOR RTS

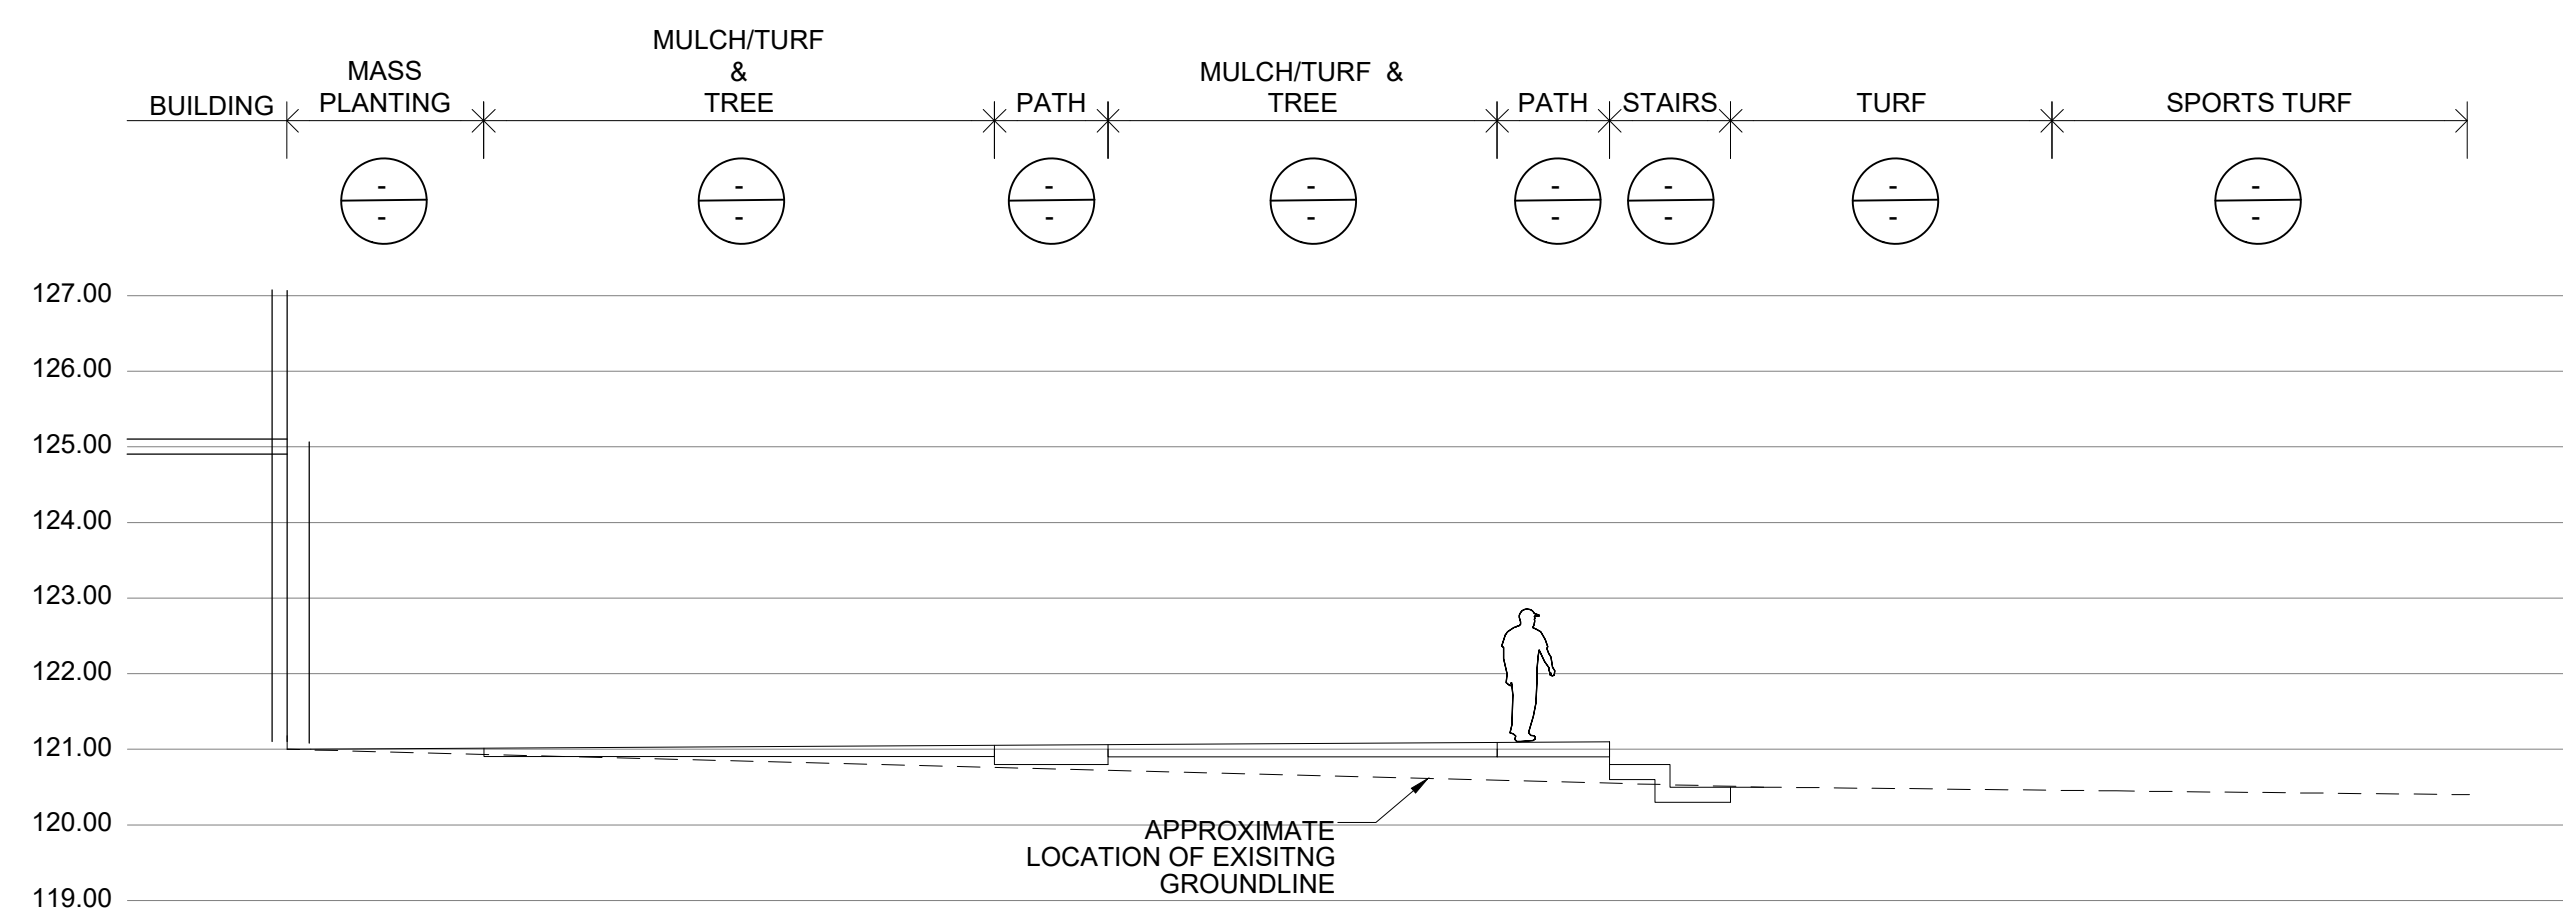

AMENDMENTS			
REV	BY	DATE	DESCRIPTION
A	YP	07.07.2021	ISSUED FOR RTS

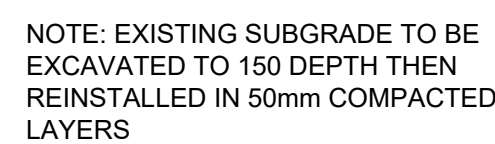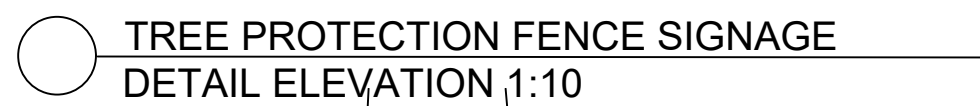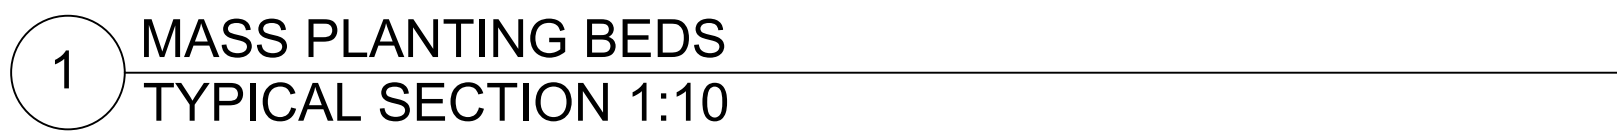

HANSEN YUNCKEN

 **NSW**
GOVERNMENT

Education

DRAWING NAME

LANDSCAPE: CONSTRUCTION DETAILS

NORTH	SCALE AS SHOWN @ A1				
	07 JULY 2021				
	PROJECT	DISCIPLINE	PHASE	SERIES NUMBER	REVISION
	EPPW - LA - SSDA - L601				A

SPECIFICATION NOTES				
GENERAL	HARDSCAPE	HARDSCAPE	FURNITURE AND FIXTURES	FURNITURE AND FIXTURES
<p>1.0 SERVICES</p> <p>Before landscape work is commenced. The Landscape Contractor is to establish the position of all servicelines and ensure tree planting is to be carried out at least 3 metres away from these services. Service lids, vents and hydrants shall be left exposed and not covered by any landscape finishes (turfing, paving, garden beds etc.) Finish adjoining surfaces flush with pit lids.</p> <p>Dial Before You Dig - It is the landscape contractor's full responsibility to complete a full services search and take all required measures to ensure protection of these services including potholing to confirm locations. The client in no way will be held responsible for any damage caused to services as a result of the contract works.</p> <p>Excavation Do not excavate by machine within 1m of existing underground services.</p> <p>2.0 GENERAL</p> <ul style="list-style-type: none">Do not scale from drawings.Larger scale drawings and written dimensions take preference.All dimensions in mm unless stated otherwise.All tree dimensions and RLs in metres.Use figured dimensions only.Verify all dimensions on site before the commencement of any works.Contractors shall locate and protect all services prior to construction.All work shall be carried out in accordance with current versions of Australian Standards, BCA and Local Government Regulations.Structural Details shall be subject to Engineer's Specifications.Drainage & Water Feature Details shall be subject to Hydraulic Engineer's Specifications.All work shall be carried out in a professional manner by Qualified Tradesperson according to the Landscape Drawings & Technical Specification and Engineer's Specifications.Protect all adjoining property building, walls and paving. Damaged elements are to be replaced at no cost to the client. <p>3.0 FINISHES</p> <ul style="list-style-type: none">There are to be no sharp protrusions or abrasive edges, obtrusive fittings and fixtures.Adjust extent of each type of soilworks and edging locally as required to accommodate final constructed locations of walls and pavements.All garden bed levels must be a minimum of 150mm below facade flashing and waterproof membrane to slab. Refer typical details.All paving and deck levels must be setout and co-ordinated with civil stormwater pits and trench drains prior to construction. Refer Civil Engineer's documentation.Contractor to provide an access hatch in timber decking for each pit located beneath timber deck.Adjust final location of soilworks and edging locally to suit service infrastructure including services, lines, pillars, valves and the like.Each area of turf extends to the entire area bounded by adjacent walls, pavements, edges and kerbs as shown.For all lighting locations to landscape areas refer to Electrical Engineers drawings. FinalLocation to be confirmed with Project Landscape Architect.Finish surface levels and contours are indicative only. Refer to Civil Engineers drawings for final levels.For all structural details of walls, pavements, and the like refer to Structural and/or CivilEngineer's documentation and specification.Sub soil drainage indicative only. Refer to Civil or Hydraulic Engineer's documentation for overland flow requirements, extent and details of all sub soil drainage.Existing trees to be retained are to be protected to Council and Project Arborist's requirements. No vehicular traffic, stockpiling or storage of materials within Tree Protection Zones (TPZs). <p>4.0 PLANTING NOTES</p> <ul style="list-style-type: none">Adjust final location of planting locally to suit service infrastructure including service lines, pillars, valves and the like.Adjust final variation of plant material as directed by Project Landscape Architect to suit final extent of each planting area.All trees in landscape grass seeded batter and turf areas are, unless otherwise noted, to be provided with a mulch ring with spade finish edge.Project Landscape Architect to inspect and approve all Plant material prior to delivery to site.Project Landscape Architect to inspect and approve all Plant material setout prior to install.Plant substitutes shall be approved by the Project Landscape Architect prior to ordering.	<p>1.0 CONCRETE PAVING</p> <p>Construction: Refer to engineers detail Finish: Broom finish. 50cm steel trowel either side of construction joints. Colours: Type 1: General Use - Standard Grey Colour Samples: Prepare 1000 x 1000mm sample of concrete pavement and finish for approval prior to construction.</p> <p>2.0 DRY CREEK BED</p> <p>Construction: Refer to detail on the Landscape Plans Edge Rock - 1-2 man sandstone Base Rock - Sandstone Random Dimensions Joints - base rock to have 10-20mm wide recessed mortar joint. Supplier: Australian Native Landscapes or an approved equivalent.</p> <p>3.0 BRICK PAVING</p> <p>Type: TECHPAVE 80 Size: 230 x 115 x 80 Colour: Natural Supplier: Austral Masonry (tel:02 9840 2333) Samples: Provide 5 pieces for approval prior to construction.</p> <p>4.0 SANDSTONE LOG SEAT</p> <p>Type:Sandstone Retaining A grade Wall Blocks. Dimension: 500 x 500 x 2000mm Grader: Wheel Sawn Premium 'A' Grade Blocks Supplier: Kimberley Sandstone or approved equivalent.</p> <p>5.0 TREE PIT IRRIGATION AND AERATION</p> <p>Type: Snorkil plaza dual inlet Code: SNPL2 Diameter D: 1790mm Supplier: Citygreen Australia. (Tel. 1300 066 949)</p>		<p>1.0 BIKE RAIL</p> <p>Type: Bicycle Hitch Rail (BR85B) - Surface mount. Material: 40NB (50.0) x 1.5mm Grade 304 Stainless Steel Size: 859 x 800mm Supplier: Leda (Ledasecurity.com.au) or an approved equivalent.</p>	

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LANDSCAPE: SPECIFICATIONS

PROJECT
EPPING WEST PUBLIC SCHOOL
ALTERATIONS AND ADDITIONS
96 CARLINGFORD RD EPPING NSW

NORTH

SCALE NTS @ A1			
07 JULY 2021			
PROJECT	DISCIPLINE	PHASE	SERIES NUMBER
EPPW - LA	- SSDA	- L700	A

