


29/04/2020 5:45:57 PM

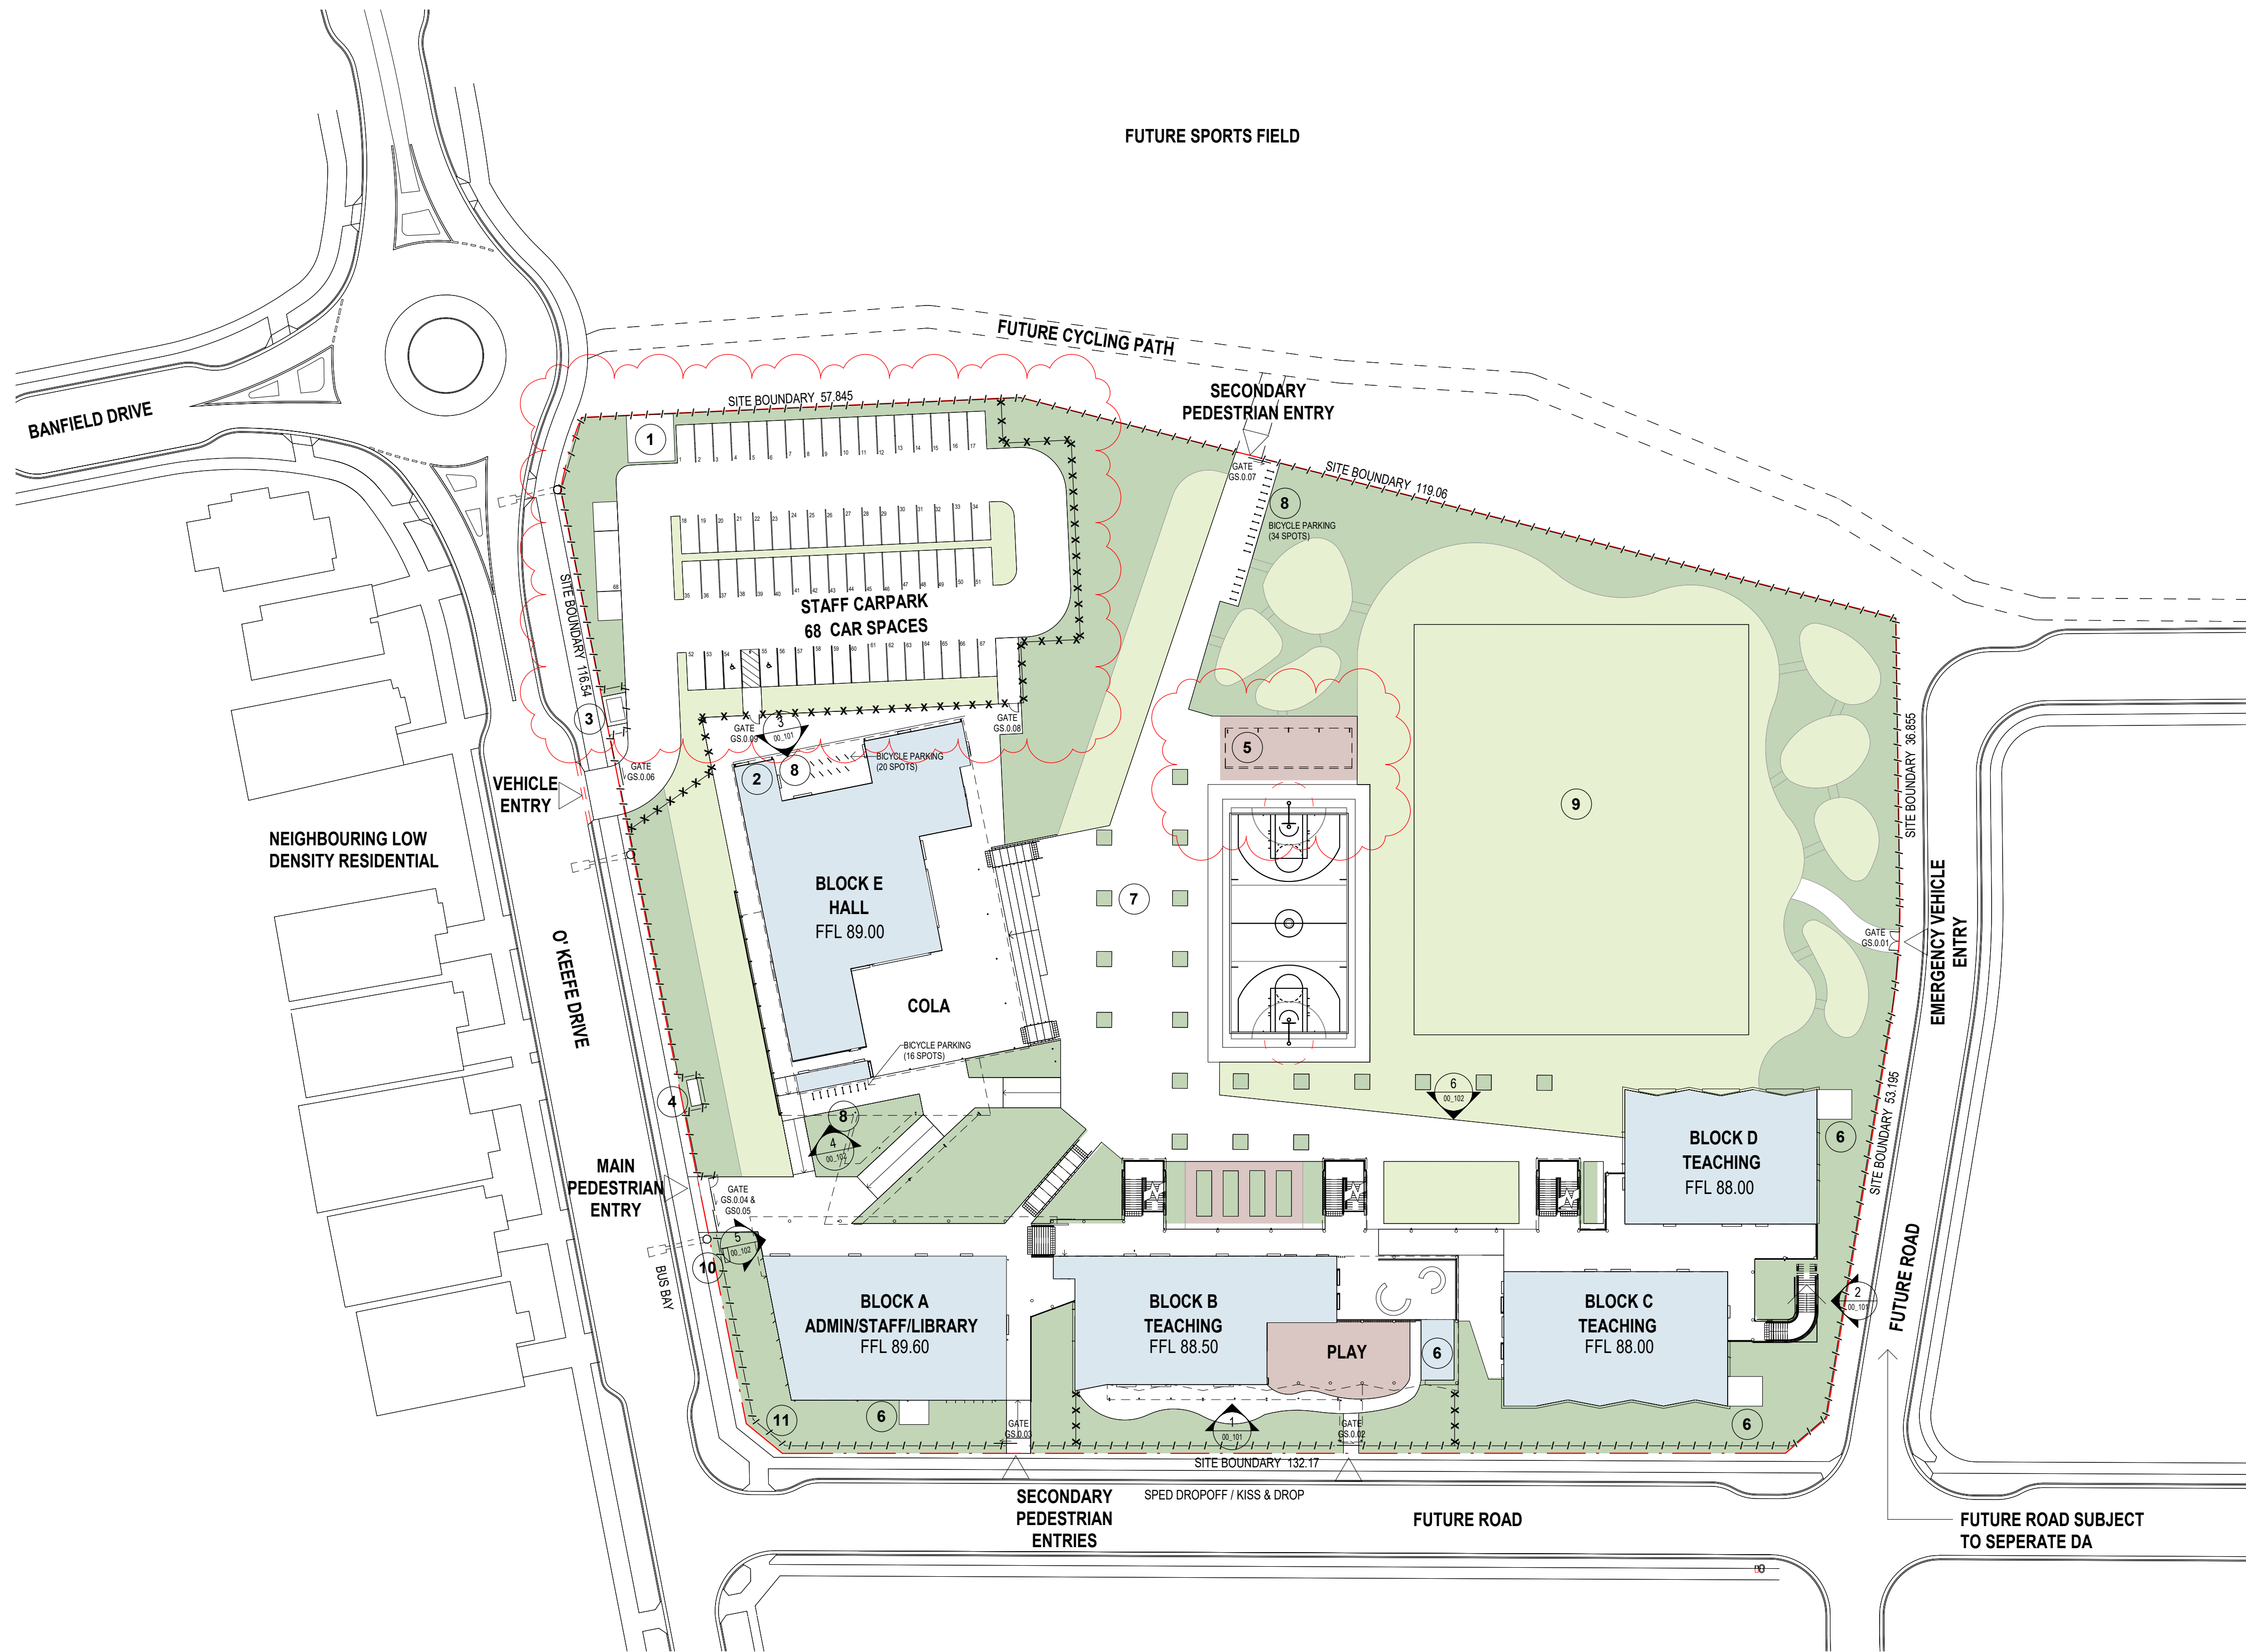

SITE SERVICES

NUMBER	DESCRIPTION
1	WASTE PAD
2	MAIN SWITCHBOARD ROOM
3	SUBSTATION
4	PUMPS
5	SHADE STRUCTURE
6	PLANT WITH SCREEN
7	ASSEMBLY
8	BICYCLE PARKING (TOTAL OF 60 SPOTS)
9	SPORTS FIELD
10	MAIN SCHOOL SIGN
11	FUTURE ELECTRIC SCHOOL SIGN
---	SITE BOUNDARY
- - - - -	FENCE LINE - 2.1m HIGH DIPLOMAT PALISSADE FENCE TYPE.
* * * * *	FENCE LINE - 1.2m

NOTE:
REFER TO LANDSCAPE ARCHITECT
DRAWINGS FOR MORE INFORMATION


AMMENDMENTS			
REV	BY	DATE	DESCRIPTION
A	VL	13.08.19	PRELIMINARY ISSUE FOR REVIEW
B	RO	30.08.19	ISSUE FOR SSDA TRA
C	HS	11.02.20	ISSUE FOR RTS - BICYCLE PARKING NOTE ADDED, LEGEND, AWNING & PLAYSPACE AMENDED & STAIR MOVED
D	SJ	10.03.20	ISSUE FOR RTS - CAR & BIKE PARKING AMENDED
		29.04.20	ISSUE FOR RTS - CAR PARKING NUMBERS ADDED, SHADE STRUCTURE AMENDED

LEGEND	
CON	CONCRETE
CFC1	CLADDING CFC, NEUTRAL COLOUR
CFC2a	CLADDING CFC, FEATURE COLOUR A
CFC2b	CLADDING CFC, FEATURE COLOUR B
CFC2c	CLADDING CFC, FEATURE COLOUR C
DP	DOWNPIPE
LV1	ALUMINIUM LOUVRES - TYPE 1
LV2	ALUMINIUM LOUVRES - TYPE 2
MWC1b	METAL WALL CLADDING, COLOUR B


MR1a	METAL ROOFING, COLOUR A - UPPER LEVEL
MR1b	METAL ROOFING, COLOUR B - LOWER LEVEL
PC-b	POWDERCOAT, FEATURE COLOUR B
PC-e	POWDERCOAT, FEATURE COLOUR E
PC-f	POWDERCOAT, FEATURE COLOUR F
PMS	PERFORATED MESH SCREEN



STRUCTURAL, CIVIL NORTHROP ENGINEERS (02) 9241 4188 MECHANICAL, ELECTRICAL STEINSEN WARMING (02) 9967 2200 HYDRAULIC WOOLACOTT (02) 8241 9900 FIRE MCD FIRE ENGINEERING (04) 2392 2745	PERUMAL PEDAVOLI ARCHITECTS T: 02 9291 0000 WEB: www.pp-a.com.au Nominated Architect: Vince Pedavoli NSW reg No 5045 LANDSCAPE ARCHITECT TAYLOR BRAMMER LANDS, ARCH. (02) 9387 8855
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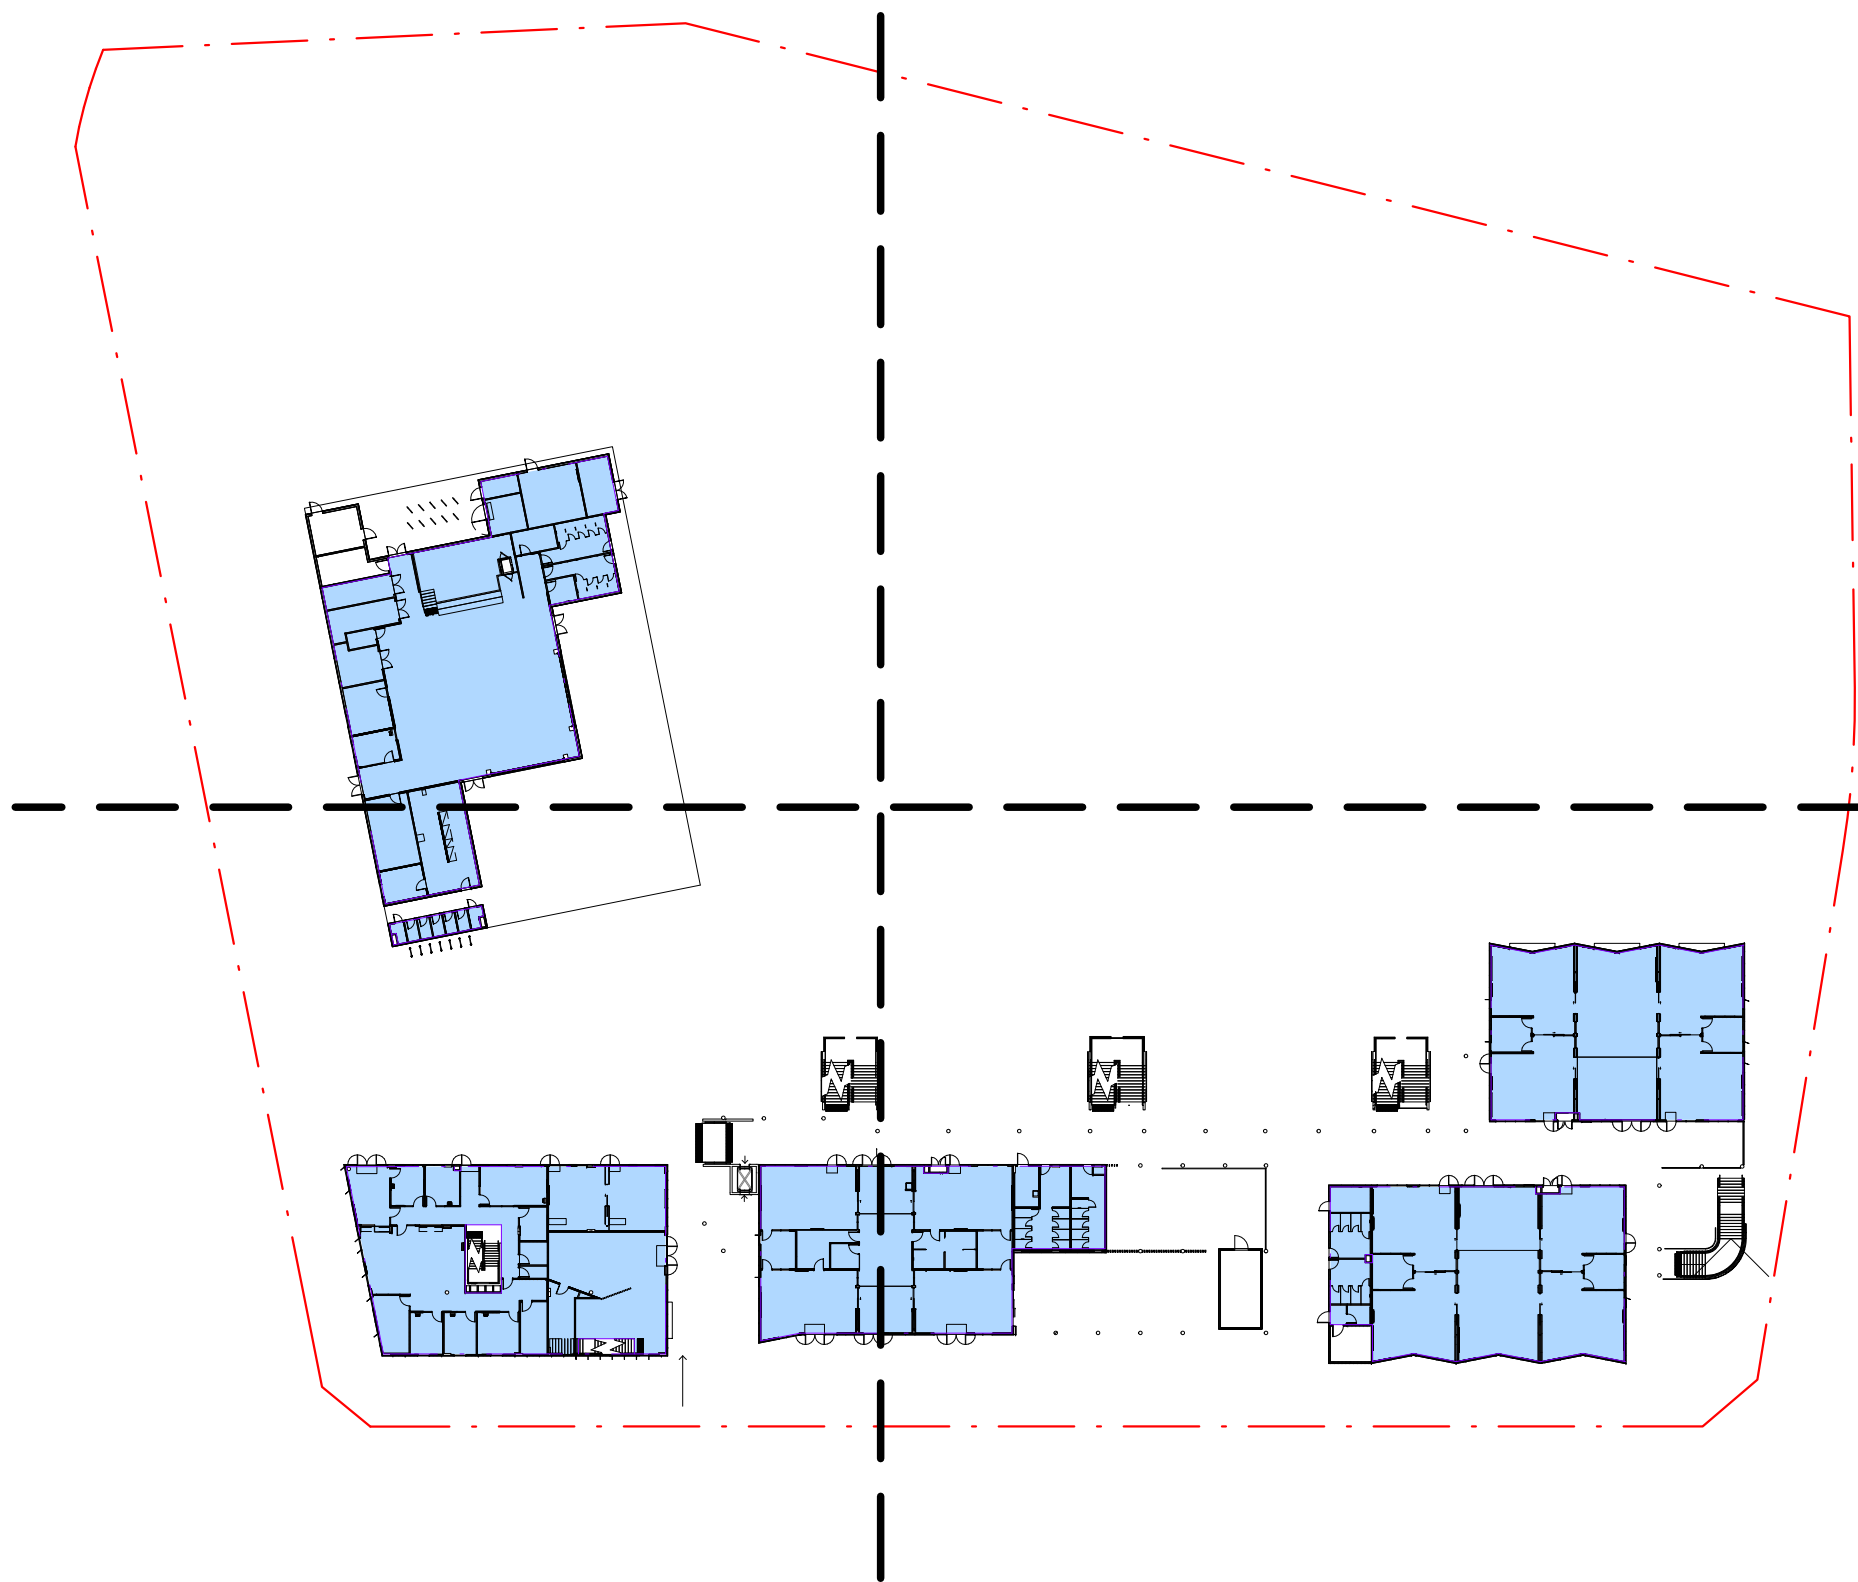


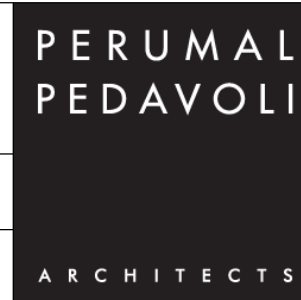CATHERINE FIELD PS
O'KEEFE DRIVE, ORAN PARK, NSW, 2570
NEW HIGH QUALITY CLASSROOMS PACKAGE 2
DRAWING NAME
SITE PLAN


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	DRAWN		CHECKED		VERIFIED		DATE		
	HS		KLC		SR		1 MAY 2020		
	DRAWING NUMBER							REVISION	
	PROJECT CODE		SCH. REF.		DISC.		TYPE		SERIES#
NHQC2 - CF - AR - SSDA-00_002									

FOR COORDINATION


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GFA - LEVEL 00	
Building	Area
BLOCK A	521.61 m²
BLOCK B	487.56 m²
BLOCK C	477.57 m²
BLOCK D	421.01 m²
BLOCK E	715.74 m²
BLOCK E WC	18.22 m²
	2641.71 m²



GFA - LEVEL 01	
Building	Area
BLOCK A	540.39 m²
BLOCK B	845.58 m²
BLOCK C	477.57 m²
BLOCK D	421.01 m²
	2284.55 m²

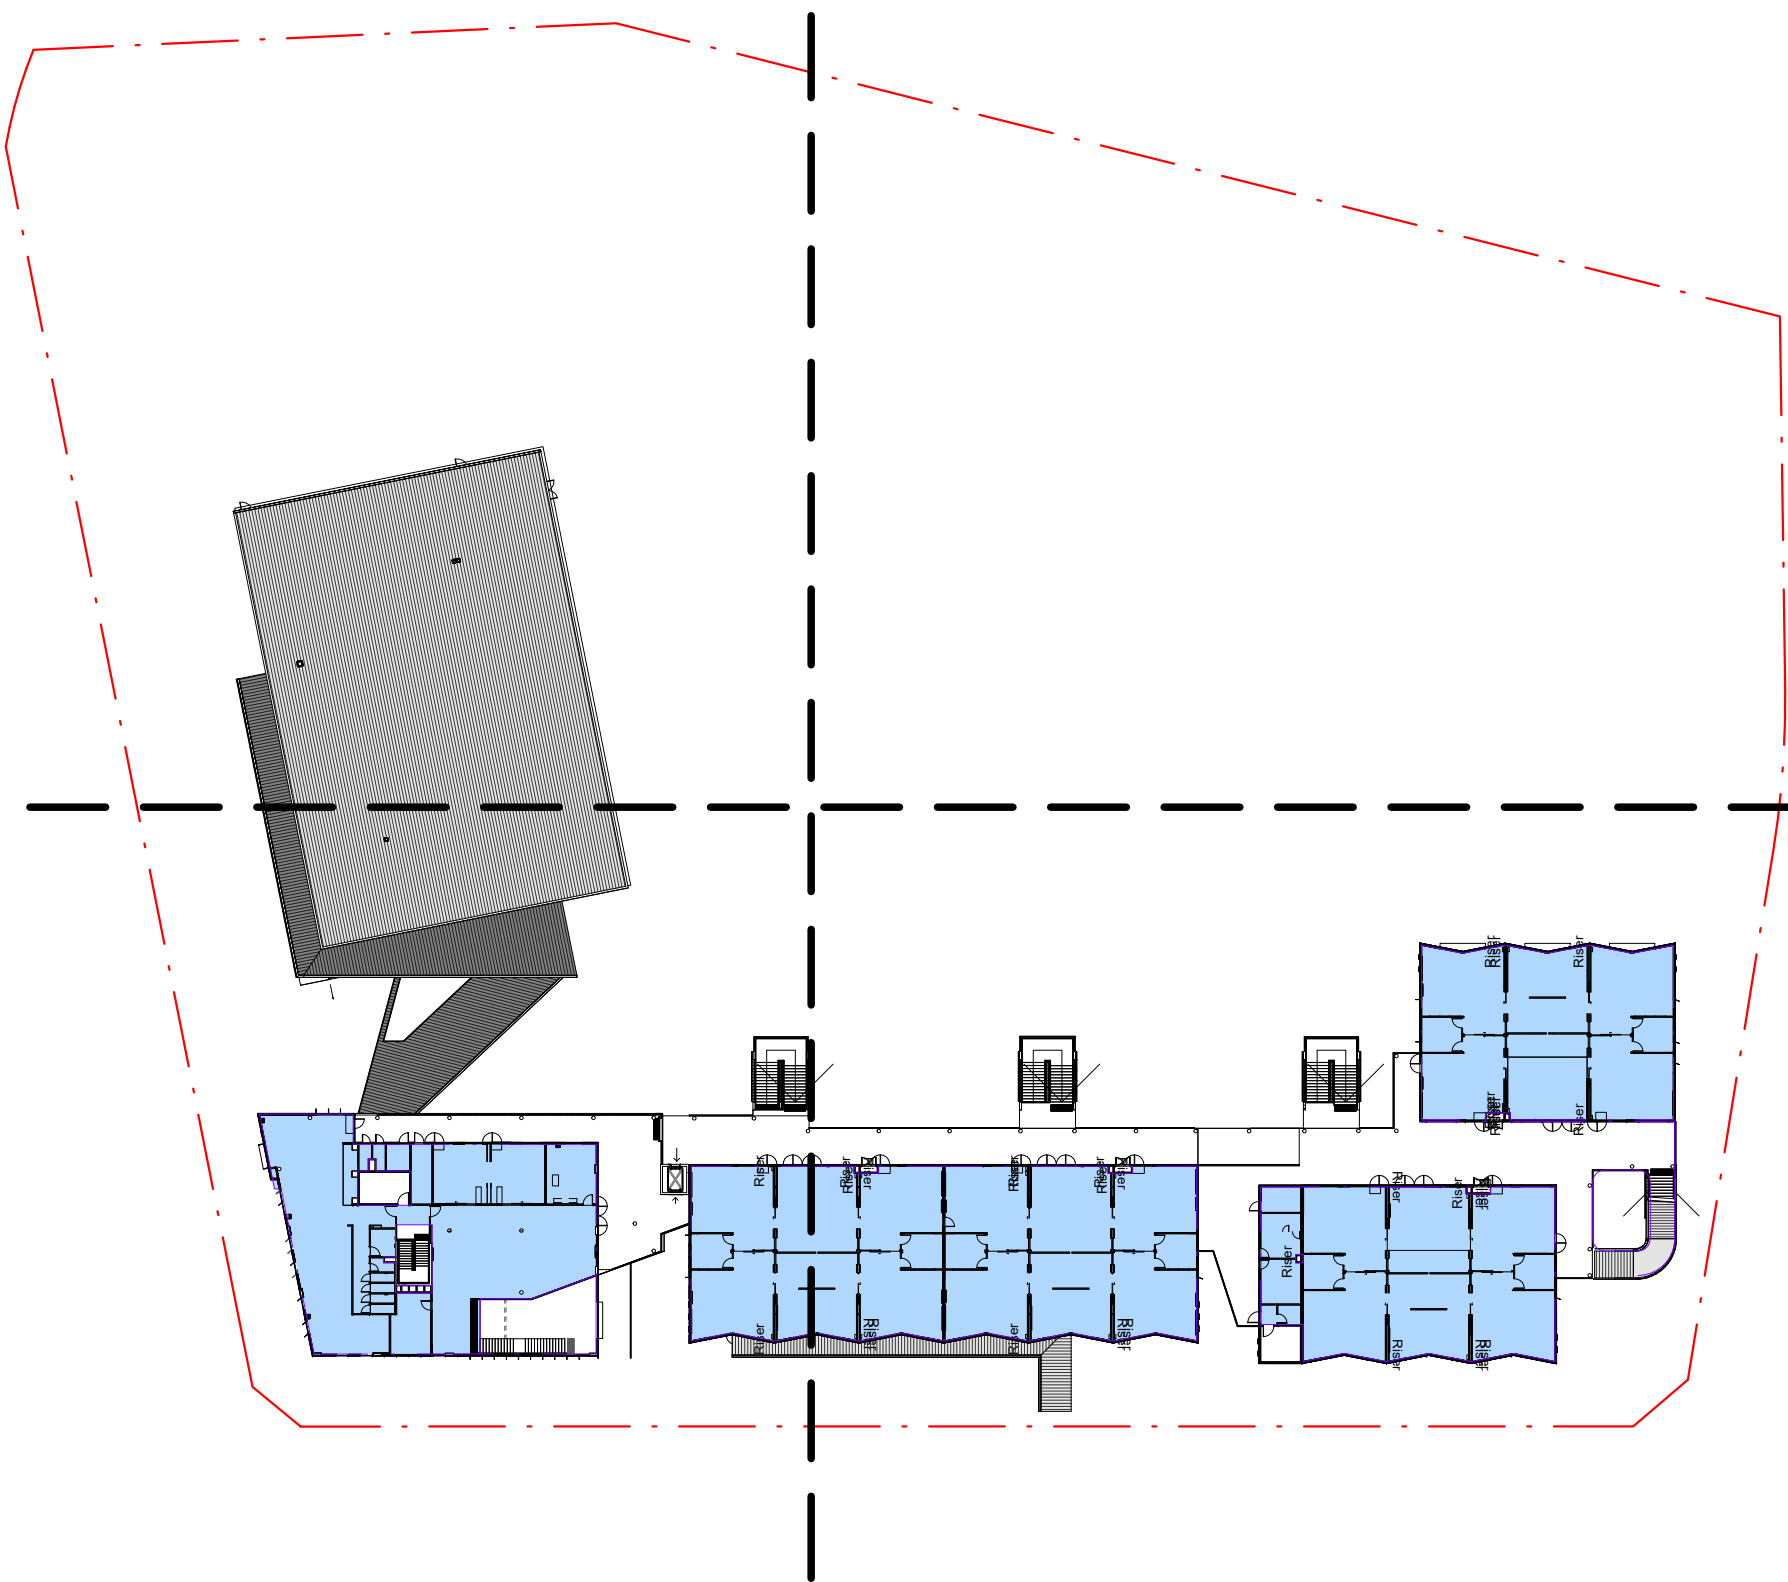

GFA - LEVEL 02	
Building	Area
BLOCK B	845.54 m²
BLOCK C	477.64 m²
BLOCK D	421.02 m²
	1744.20 m²

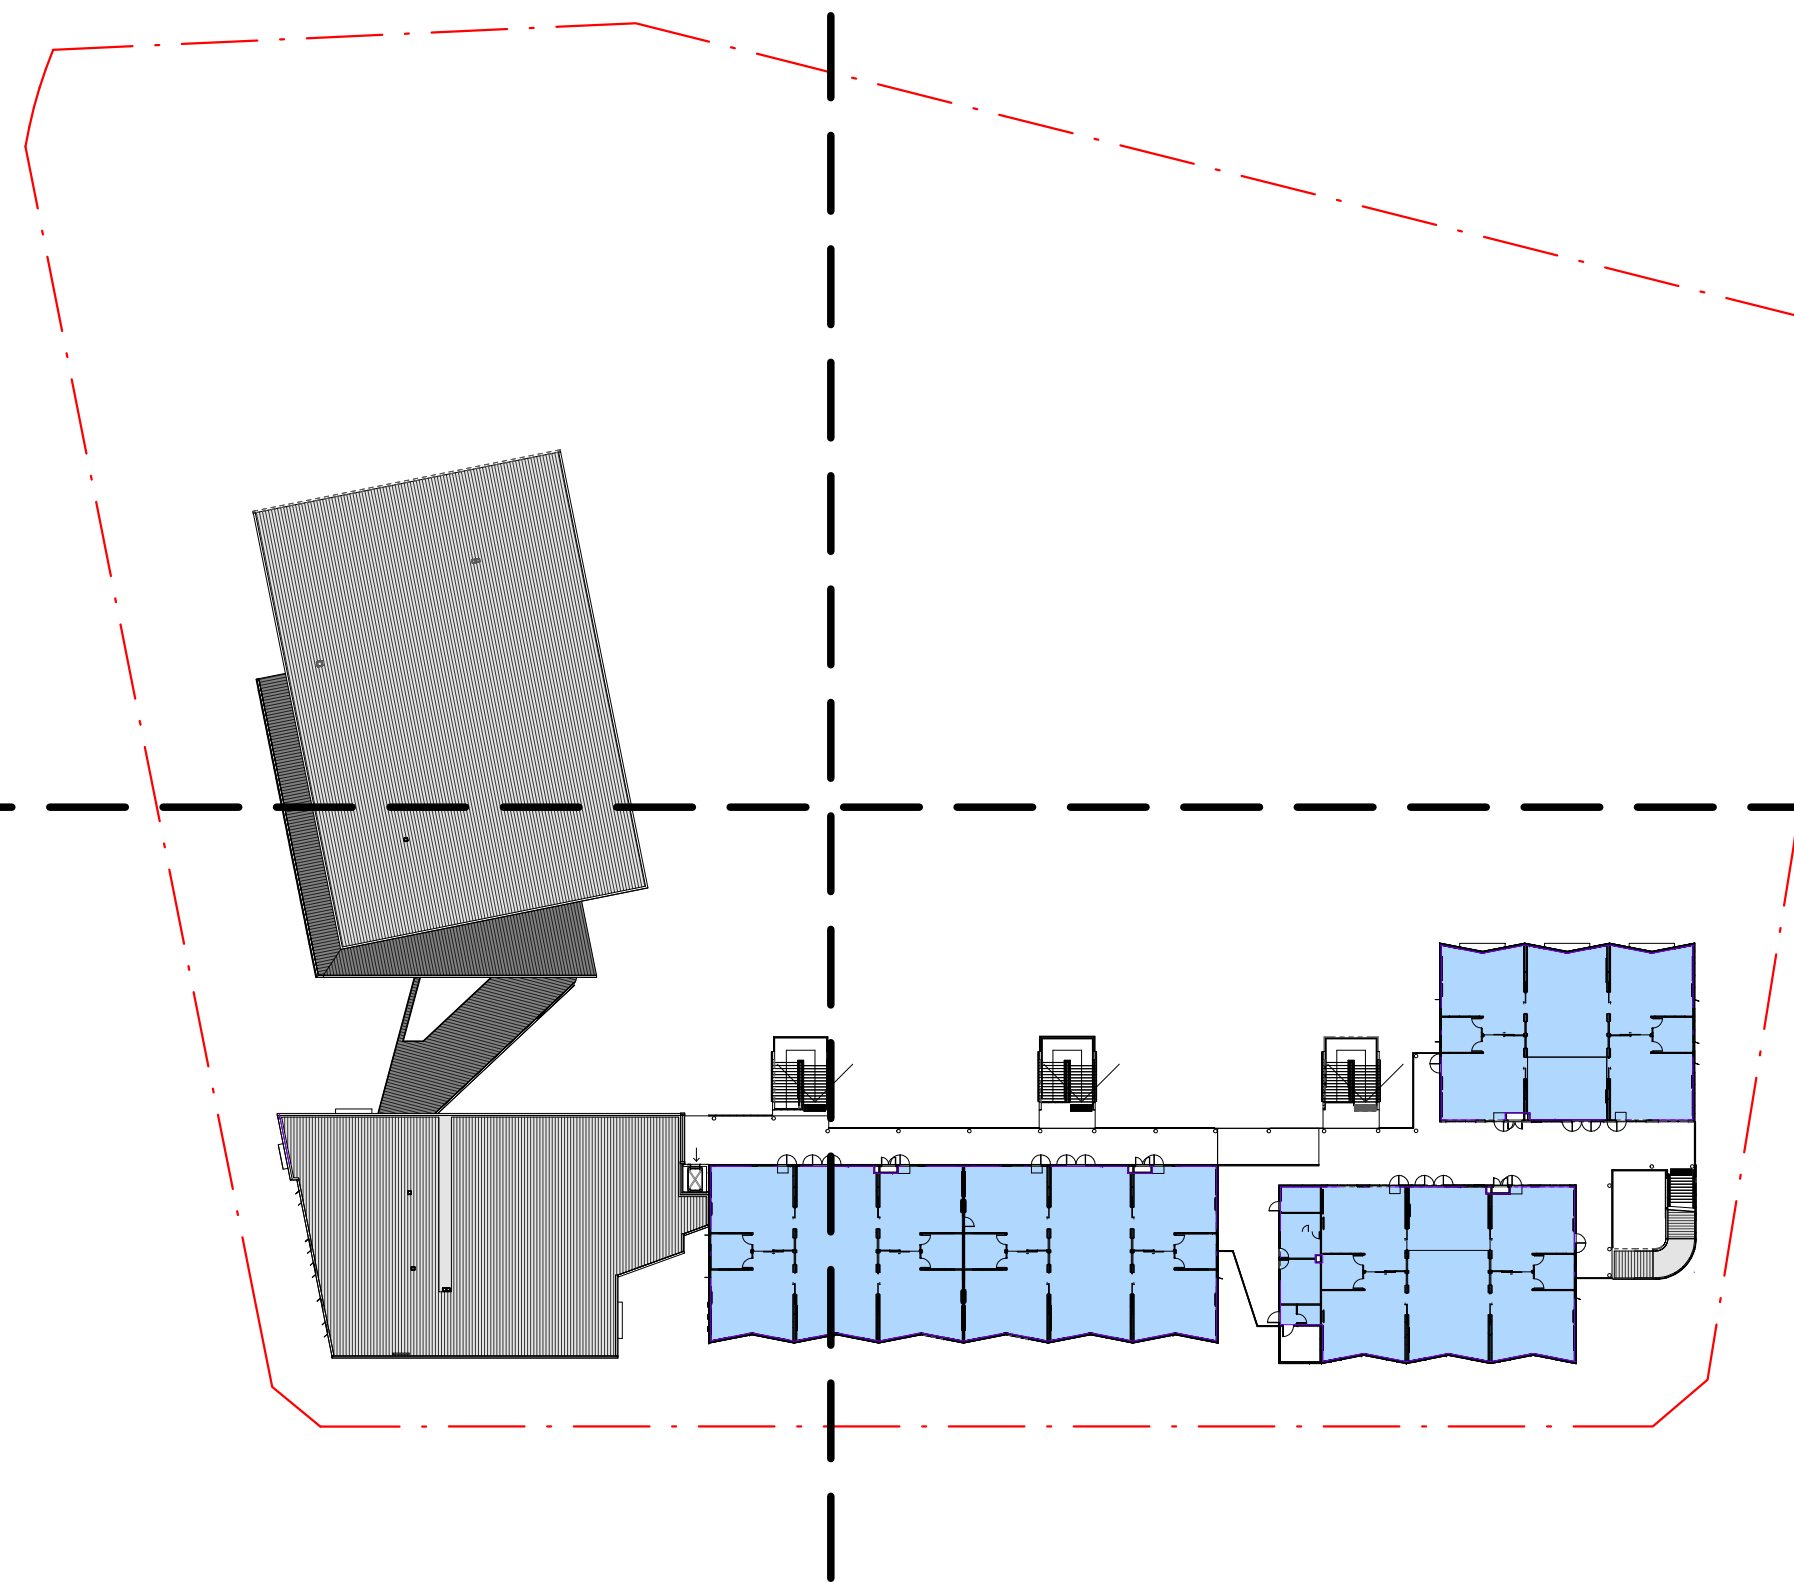
GFA - TOTAL		
Level	Building	Area
BLOCK A		
00	BLOCK A	521.61 m²
01	BLOCK A	540.39 m²
BLOCK B		
00	BLOCK B	487.56 m²
01	BLOCK B	845.58 m²
02	BLOCK B	845.54 m²
BLOCK C		
00	BLOCK C	477.57 m²
01	BLOCK C	477.57 m²
02	BLOCK C	477.64 m²
BLOCK D		
00	BLOCK D	421.01 m²
01	BLOCK D	421.01 m²
02	BLOCK D	421.02 m²
BLOCK E		
00	BLOCK E	715.74 m²
BLOCK E WC		
00	BLOCK E WC	18.22 m²
		6670.46 m²
FSR		
GFA = 6,754 m²		
SITE AREA = 20,812 m²		
= 0.32 : 1		

GFA CALCULATED FOLLOWING THE LEP DEFINITION.

AMMENDMENTS				LEGEND
REV	BY	DATE	DESCRIPTION	
A	HS	10.03.20	ISSUE FOR RTS	



STRUCTURAL CIVIL NORTHROP ENGINEERS (02) 9241 4188 MECHANICAL ELECTRICAL STEINER WARMING (02) 9967 2200 HYDRAULIC WOOLACOTT (02) 8241 9900 FIRE MCD FIRE ENGINEERING (04) 2392 2745	PERUMAL PEDAVOLI ARCHITECTS T: 02 9291 0000 WEB: www.pp-a.com.au Nominated Architect: Vince Pedavoli NSW reg No.5045 LANDSCAPE ARCHITECT TAYLOR BRAMMER LANDS. ARCH. (02) 9387 8855
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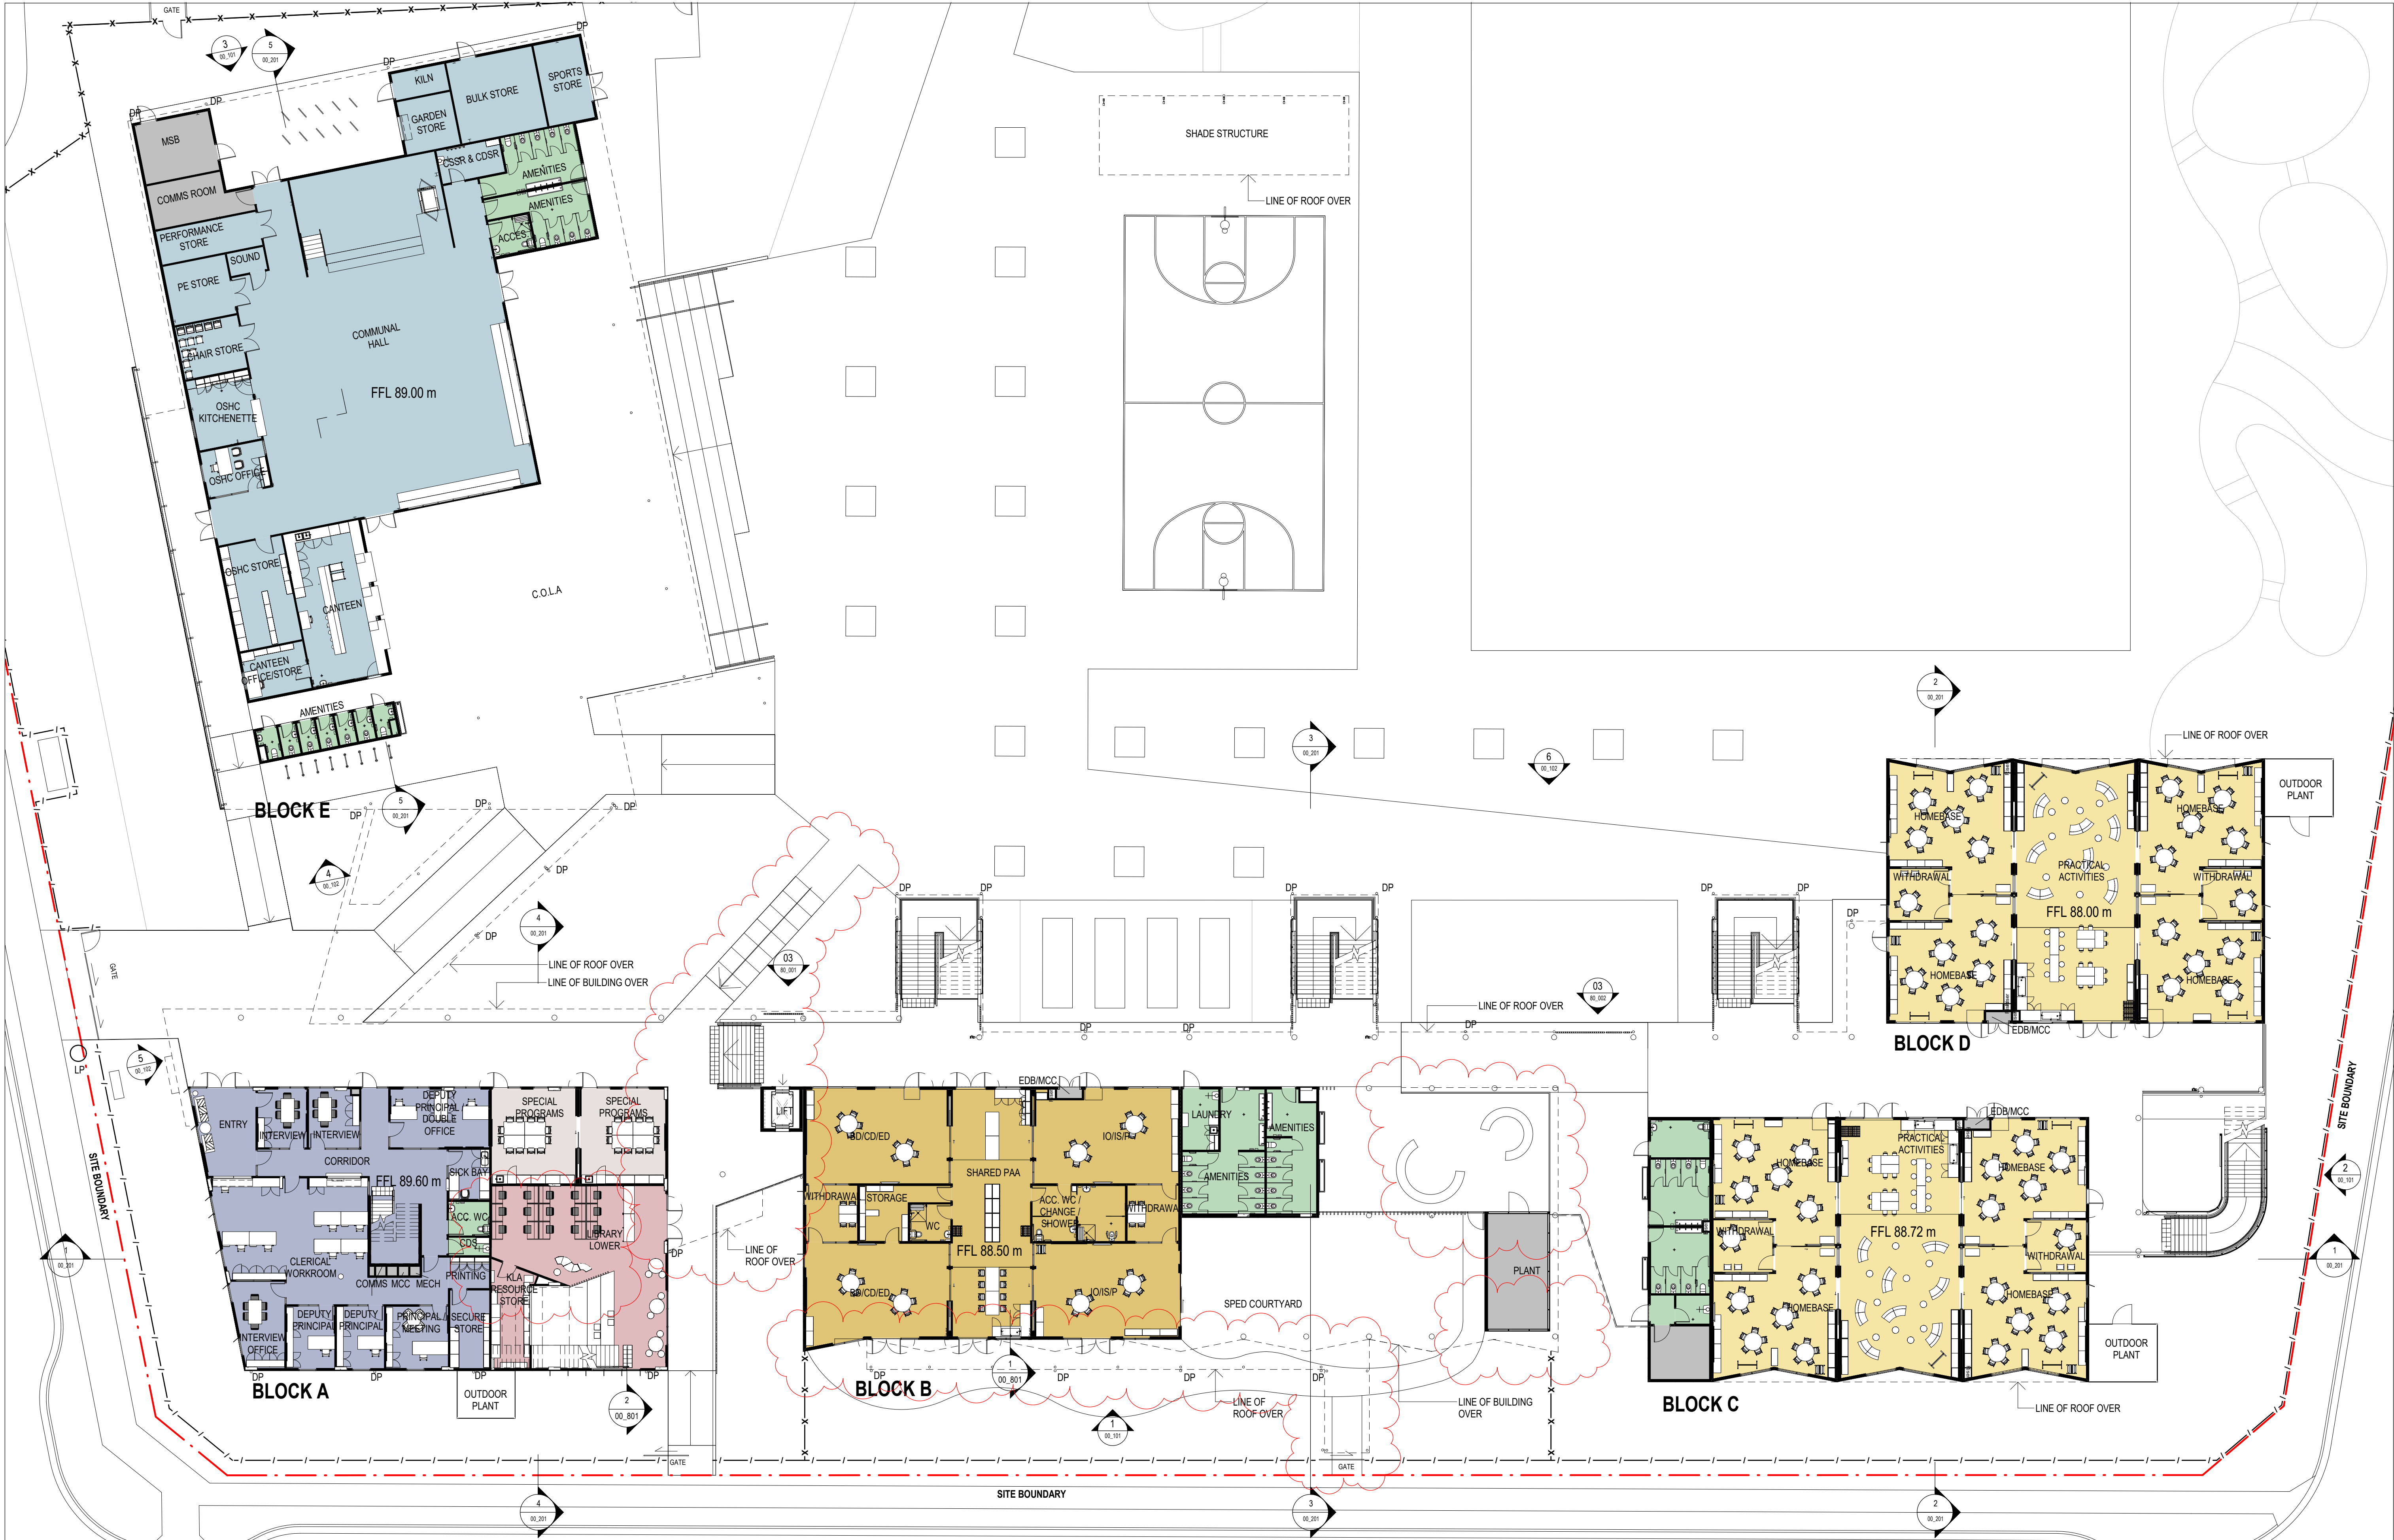


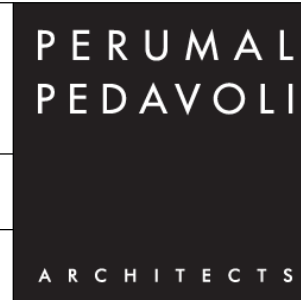CATHERINE FIELD PS
O'KEEFE DRIVE, ORAN PARK, NSW, 2570
NEW HIGH QUALITY CLASSROOMS PACKAGE 2
DRAWING NAME
GFA PLANNING AREA
CALCULATIONS

PROJECT NORTH			
DRAWN	CHECKED	VERIFIED	DATE
Author	Checker	Approver	10 MARCH 2020
DRAWING NUMBER			
PROJECT CODE	SCH. REF.	DISC.	TYPE
NHQC2 - CF - AR -SSDA-00_004			
REVISION			
A			

FOR CO-ORDINATION

11/02/2020 11:11:59 AM



AMENDMENTS			DESCRIPTION
REV	BY	DATE	
A	VL	13.08.19	PRELIMINARY ISSUE FOR REVIEW
B	VL	30.08.19	ISSUE FOR SSDA 1a
B	KLC	31.10.19	ISSUE FOR SSDA
C	RO	11.02.20	ISSUE FOR RTS - STAIR, AWNING, PLAYSPACE AMENDED, PLANT LOUVRES SETBACK, SPED ENTRANCE RELOCATED.

LEGEND	
CON	CONCRETE
CFC1	CLADDING CFC, NEUTRAL COLOUR
CFC2a	CLADDING CFC, FEATURE COLOUR A
CFC2b	CLADDING CFC, FEATURE COLOUR B
CFC2c	CLADDING CFC, FEATURE COLOUR C
DP	DOWNPIPE
LV1	ALUMINIUM LOUVRES - TYPE 1
LV2	ALUMINIUM LOUVRES - TYPE 2
MWC1b	METAL WALL CLADDING, COLOUR B

MR1a	METAL ROOFING, COLOUR A - UPPER LEVEL
MR1b	METAL ROOFING, COLOUR B - LOWER LEVEL
PC-b	POWDERCOAT, FEATURE COLOUR B
PC-e	POWDERCOAT, FEATURE COLOUR E
PC-f	POWDERCOAT, FEATURE COLOUR F
PMS	PERFORATED MESH SCREEN

ADMIN/STAFF	SERVICES
AMENITIES	SPECIAL EDUCATION
HALL	SPECIAL PROGRAMS
LIBRARY	TEACHING SPACE



STRUCTURAL CIVIL
NORTHROP ENGINEERS
(02) 9241 4188
MECHANICAL ELECTRICAL
STEINER WARMING
(02) 9967 2200
HYDRAULIC
WOOLACOTT
(02) 8241 9900
FIRE
MCD FIRE ENGINEERING
(04) 2392 2745

PERUMAL PEDAVOLI ARCHITECTS
T: 02 9291 0000
WEB: www.pp-a.com.au
Nominated Architect:
Vince Pedavoli NSW reg No 5045
LANDSCAPE ARCHITECT
TAYLOR BRAMMER LANDS ARCH.
(02) 9387 8855


PERUMAL
PEDAVOLI
ARCHITECTS

CATHERINE FIELD PS
O'KEEFE DRIVE, ORAN PARK, NSW, 2570
NEW HIGH QUALITY CLASSROOMS PACKAGE 2
DRAWING NAME
COMPOSITE PLAN - LEVEL 00

PROJECT NORTH		0 2000 4000 6000 8000 10000 20000		SCALE 1: 200 @ A1	
DRAWN	CHECKED	VERIFIED	DATE		
HS	KLC	SR	11 FEBRUARY 2020		
DRAWING NUMBER		REVISION			
PROJECT CODE	SCH. REF.	DISC.	TYPE	SERIES	
NHQC2 - CF - AR -SSDA-00_011					C

SSDA

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AMMENDMENTS				DESCRIPTION
REV	BY	DATE		
VL		13.08.19		PRELIMINARY ISSUE FOR REVIEW
VL		30.08.19		ISSUE FOR SSDA 10A
B	KLC	31.10.19		ISSUE FOR SSDA
C	RO	11.02.20		ISSUE FOR RTB - BLOCK A WEST FACING EXTERIOR WALL AMENDED & WINDOW TYPE CHANGED BLOCK A EAST, STAIR, RAMP, AWNING AMENDED.

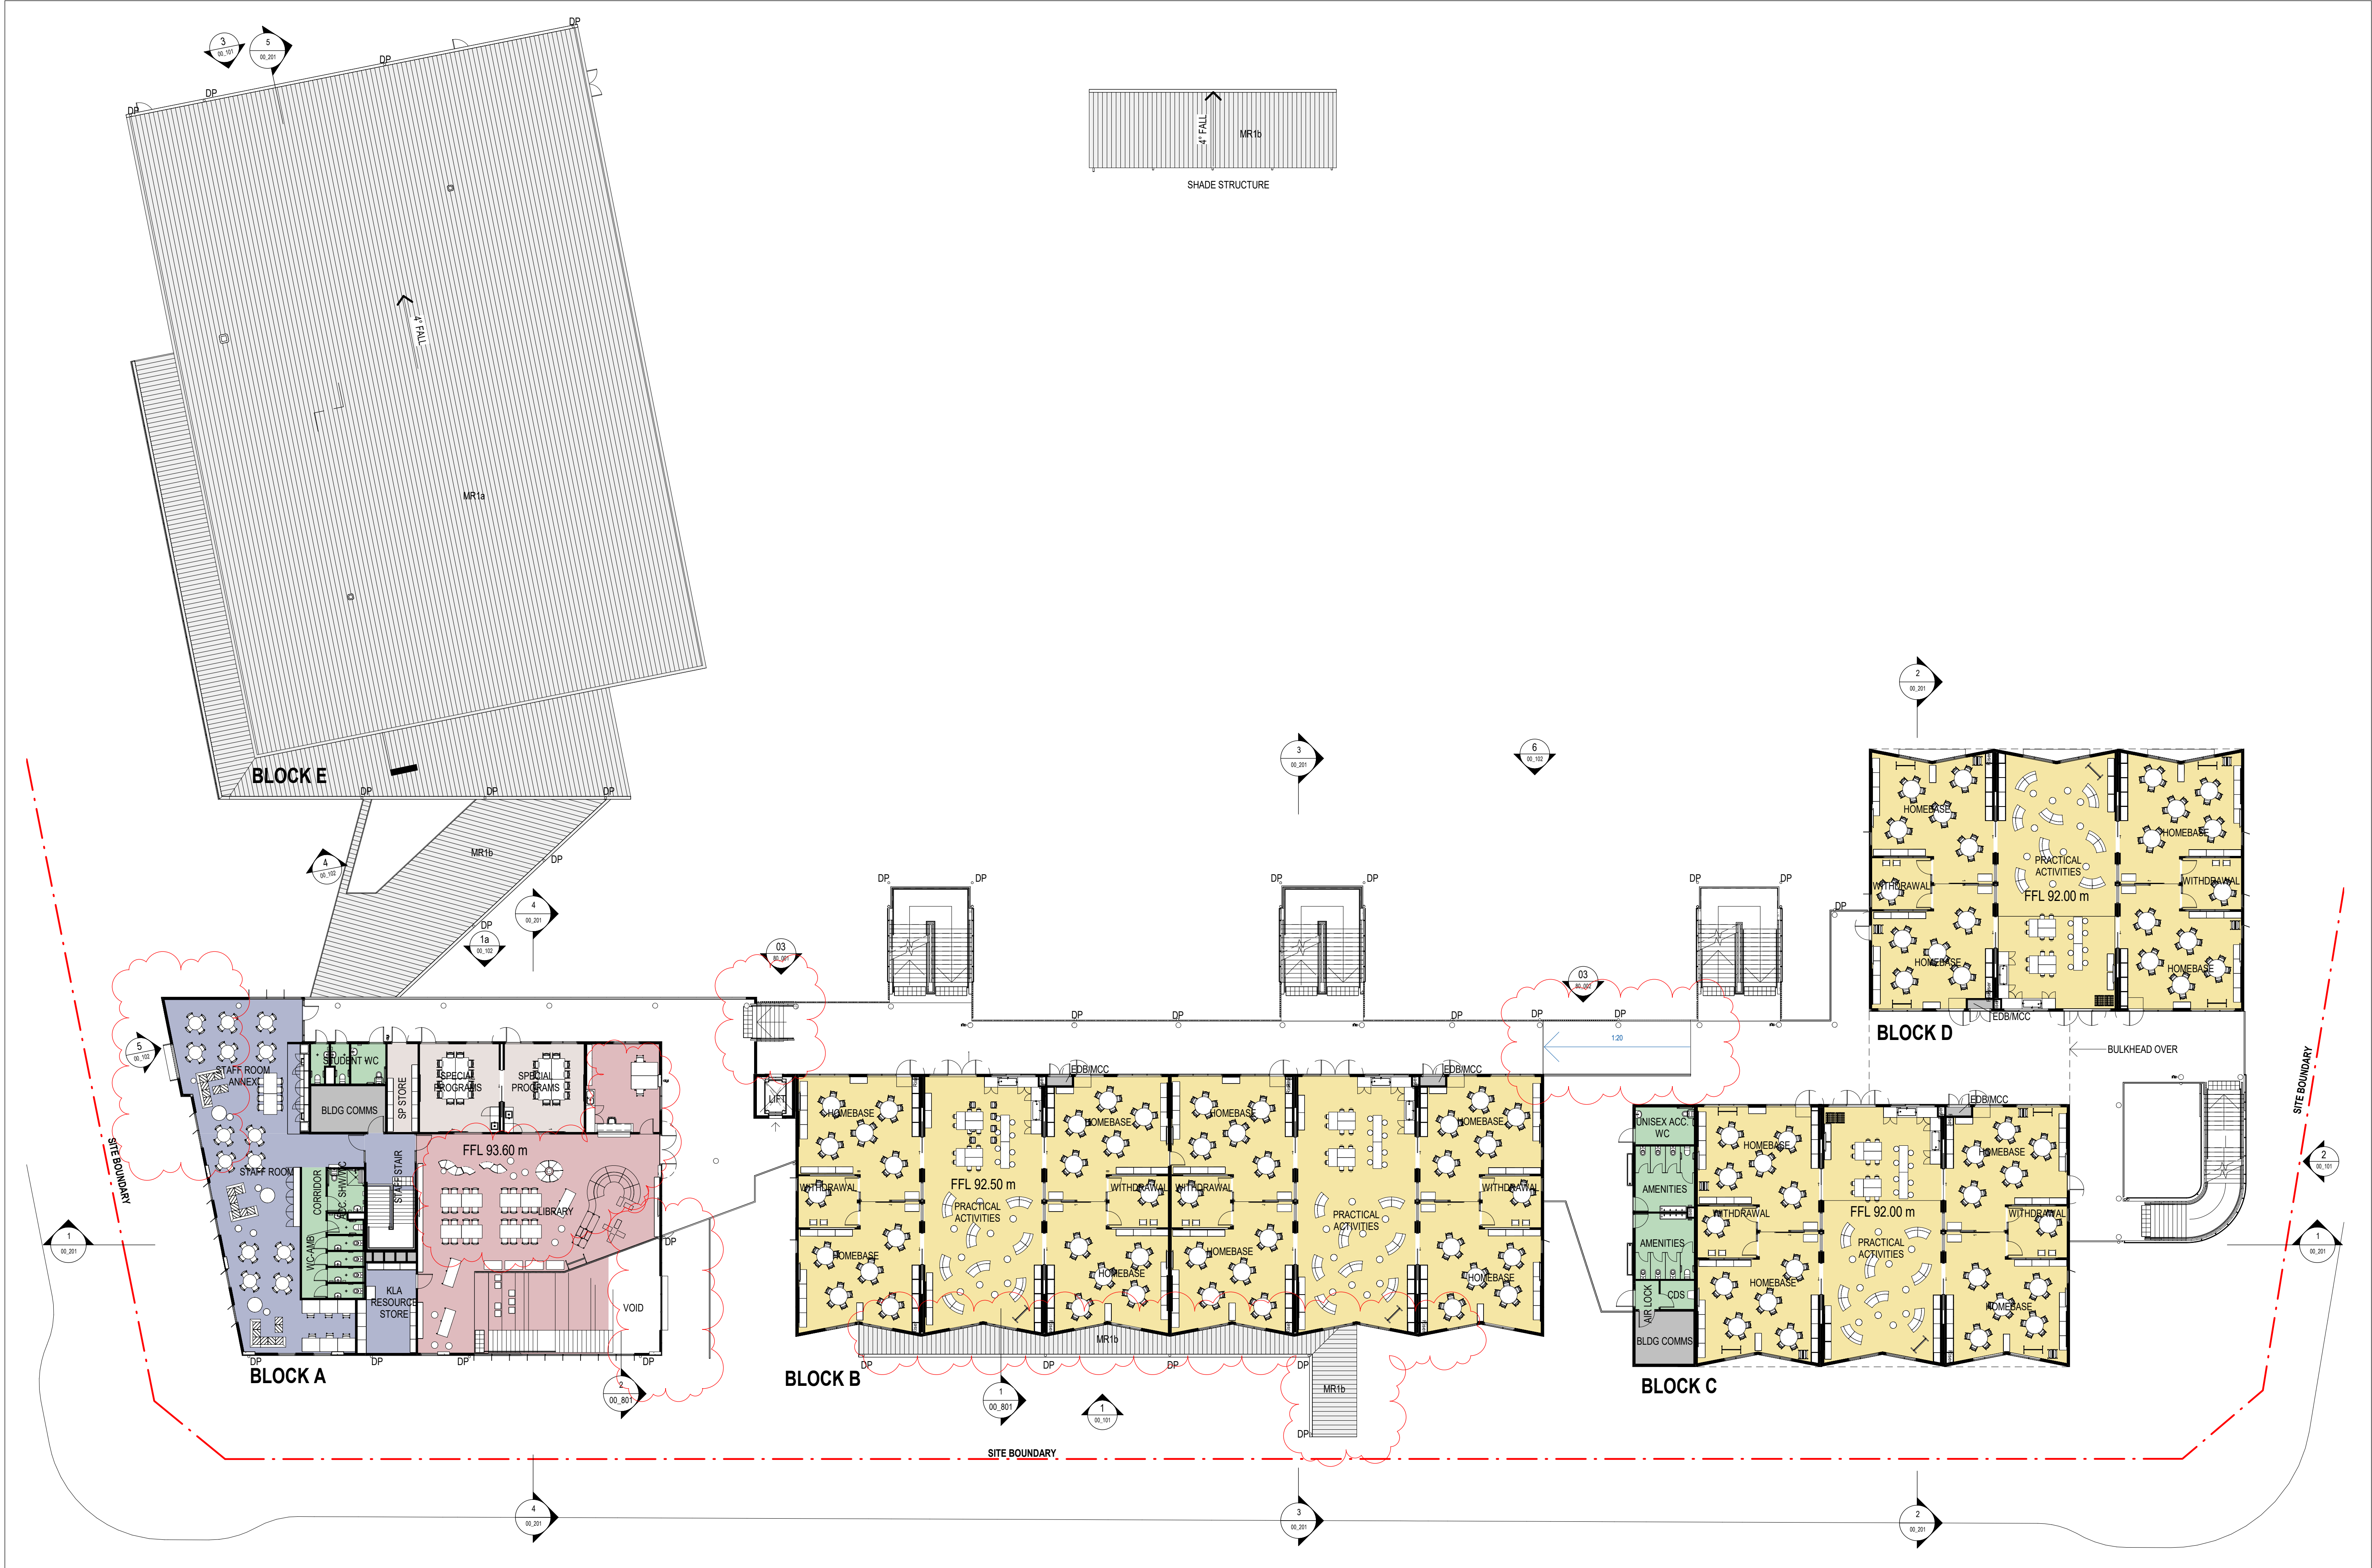
LEGEND	
CON	CONCRETE
CFC1	CLADDING CFC, NEUTRAL COLOUR
CFC2a	CLADDING CFC, FEATURE COLOUR A
CFC2b	CLADDING CFC, FEATURE COLOUR B
CFC2c	CLADDING CFC, FEATURE COLOUR C
DP	DOWNPIPE
LV1	ALUMINIUM LOUVRES - TYPE 1
LV2	ALUMINIUM LOUVRES - TYPE 2
MWC1b	METAL WALL CLADDING, COLOUR B

MR1a	METAL ROOFING, COLOUR A - UPPER LEVEL
MR1b	METAL ROOFING, COLOUR B - LOWER LEVEL
PC-b	POWDERCOAT, FEATURE COLOUR B
PC-e	POWDERCOAT, FEATURE COLOUR E
PC-f	POWDERCOAT, FEATURE COLOUR F
PMS	PERFORATED MESH SCREEN


ADMIN/STAFF	SERVICES
AMENITIES	SPECIAL EDUCATION
HALL	SPECIAL PROGRAMS
LIBRARY	TEACHING SPACE




STRUCTURAL CIVIL NORTHROP ENGINEERS (02) 9241 4188 MECHANICAL ELECTRICAL STEINER WARMING (02) 9967 2200 HYDRAULIC WOOLACOTT (02) 8241 9900 FIRE MCD FIRE ENGINEERING (04) 2392 2745	PERUMAL PEDAVOLI ARCHITECTS T: 02 9291 0000 WEB: www.pp-a.com.au Nominated Architect: Vince Pedavoli NSW reg No. 5045 LANDSCAPE ARCHITECT TAYLOR BRAMMER LANDS, ARCH. (02) 9387 8855
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CATHERINE FIELD PS
O'KEEFE DRIVE, ORAN PARK, NSW, 2570
NEW HIGH QUALITY CLASSROOMS PACKAGE 2
DRAWING NAME
COMPOSITE PLAN - LEVEL 01

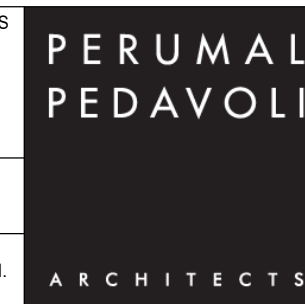	PROJECT NORTH						0 2000 4000 6000 8000 10000 20000		SCALE 1: 200 @ A1		
	DRAWN		CHECKED		VERIFIED		DATE				
	HS		KLC		SR		11 FEBRUARY 2020				
	DRAWING NUMBER									REVISION	
	PROJECT CODE		SCH. REF.		DISC.		TYPE		SERIES#		
	NHQC2 - CF - AR -SSDA-00_012								C		

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AMMENDMENTS			
REV	BY	DATE	DESCRIPTION
A	VL	13.08.19	PRELIMINARY ISSUE FOR REVIEW
B	VL	30.08.19	ISSUE FOR SSDA 1a
B	KLC	31.10.19	ISSUE FOR SSDA
C	RO	11.02.20	ISSUE FOR RTB - STAIR, RAMP & ROOF LINE AMENDED

LEGEND	
CON	CONCRETE
CFC1	CLADDING CFC, NEUTRAL COLOUR
CFC2a	CLADDING CFC, FEATURE COLOUR A
CFC2b	CLADDING CFC, FEATURE COLOUR B
CFC2c	CLADDING CFC, FEATURE COLOUR C
DP	DOWNPIPE
LV1	ALUMINIUM LOUVRES - TYPE 1
LV2	ALUMINIUM LOUVRES - TYPE 2
MWC1b	METAL WALL CLADDING, COLOUR B


MR1a	METAL ROOFING, COLOUR A - UPPER LEVEL
MR1b	METAL ROOFING, COLOUR B - LOWER LEVEL
PC-b	POWDERCOAT, FEATURE COLOUR B
PC-e	POWDERCOAT, FEATURE COLOUR E
PC-f	POWDERCOAT, FEATURE COLOUR F
PMS	PERFORATED MESH SCREEN

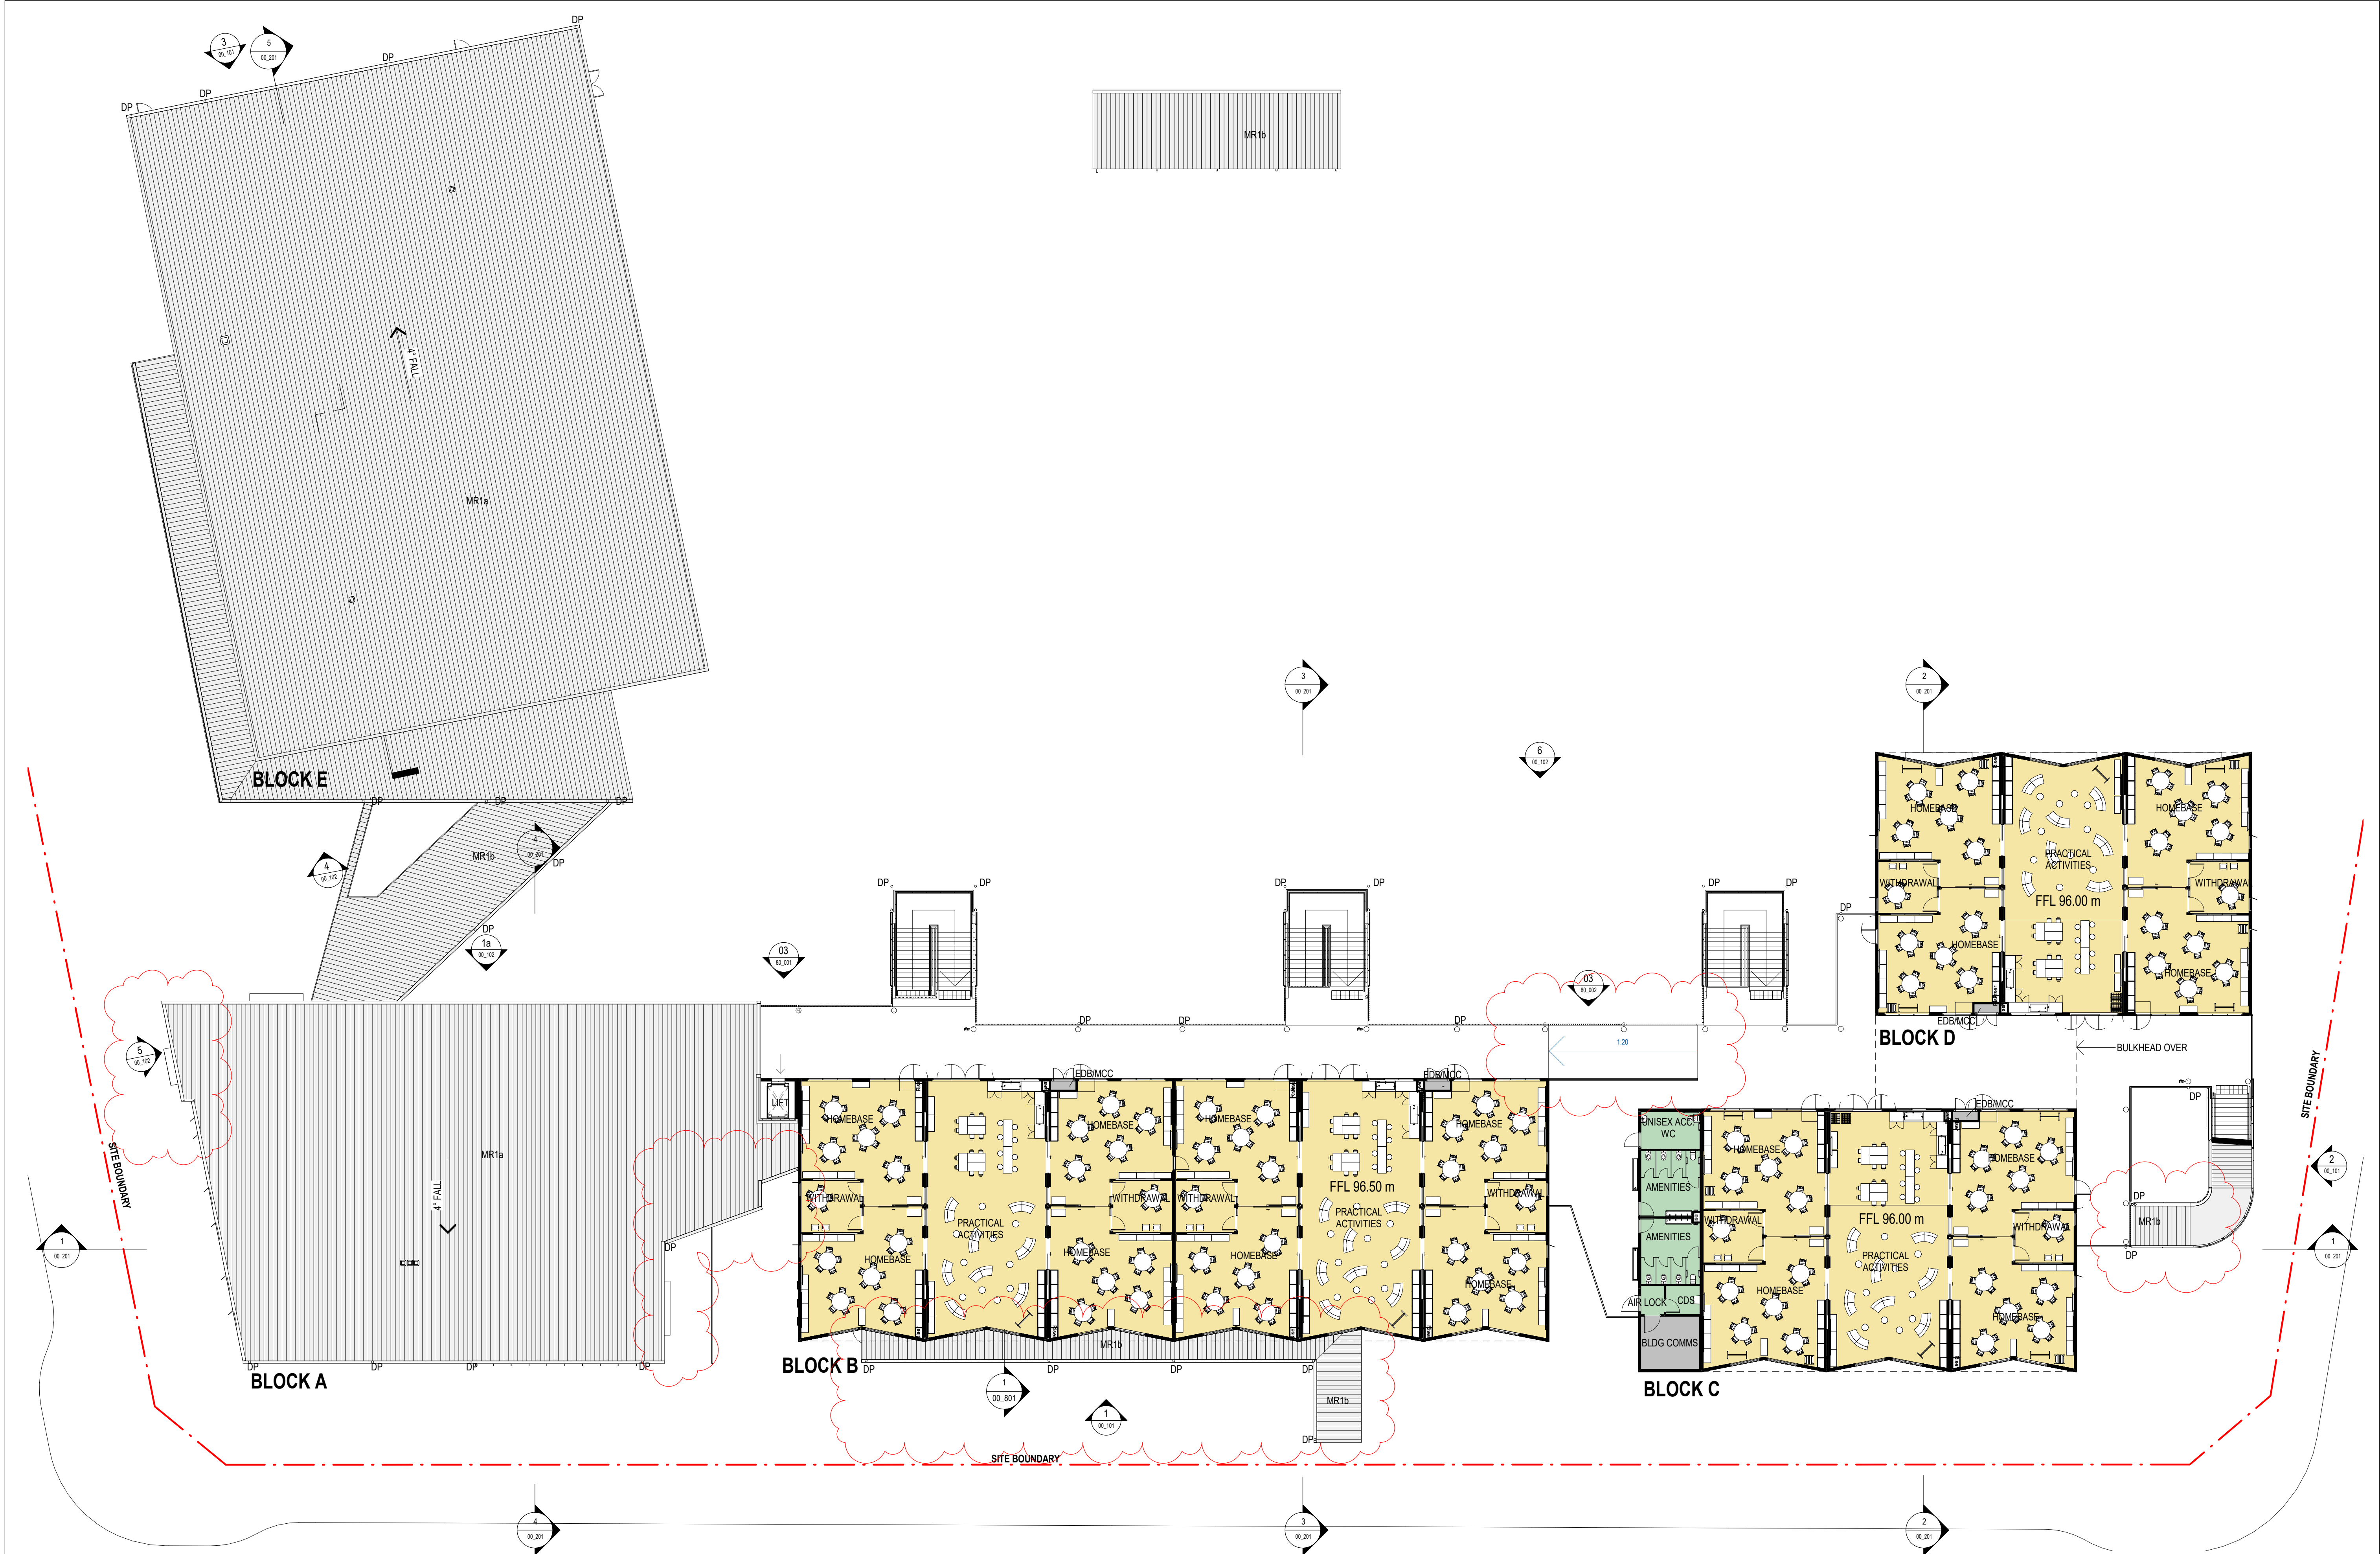ADMIN/STAFF	SERVICES
AMENITIES	SPECIAL EDUCATION
HALL	SPECIAL PROGRAMS
LIBRARY	TEACHING SPACE



STRUCTURAL, CIVIL NORTHROP ENGINEERS (02) 9241 4188 MECHANICAL, ELECTRICAL STEINER WARMING (02) 9967 2200 HYDRAULIC WOOLACOTT (02) 8241 9900 FIRE MCD FIRE ENGINEERING (04) 2392 2745
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PERUMAL PEDAVOLI ARCHITECTS T: 02 9291 0000 WEB: www.pp-a.com.au Nominated Architect: Vince Pedavoli NSW reg No. 5045 LANDSCAPE ARCHITECT TAYLOR BRAMMER LANDS, ARCH. (02) 9387 8855

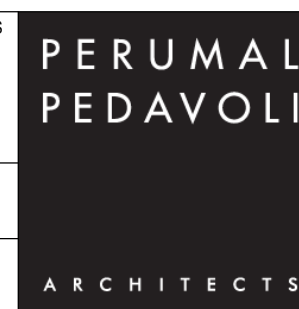


CATHERINE FIELD PS
O'KEEFE DRIVE, ORAN PARK, NSW, 2570
NEW HIGH QUALITY CLASSROOMS PACKAGE 2
DRAWING NAME
COMPOSITE PLAN - LEVEL 02

	PROJECT NORTH				
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	SCALE 1: 200 @ A1				
	DRAWN	CHECKED	VERIFIED	DATE	
	HS	KLC	SR	11 FEBRUARY 2020	
DRAWING NUMBER				REVISION	
PROJECT CODE		SCH. REF.	DISC.	TYPE	SERIES#
NHQC2 - CF - AR -SSDA-00_013					C

SSDA

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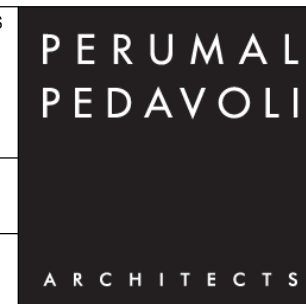
AMMENDMENTS			
REV	BY	DATE	DESCRIPTION
A	VL	13.08.19	PRELIMINARY ISSUE FOR REVIEW
B	VL	30.08.19	ISSUE FOR SSDA 10A
B	KLC	31.10.19	ISSUE FOR SSDA
C	RO	11.02.20	ISSUE FOR RTS - ROOF LINE AMENDED

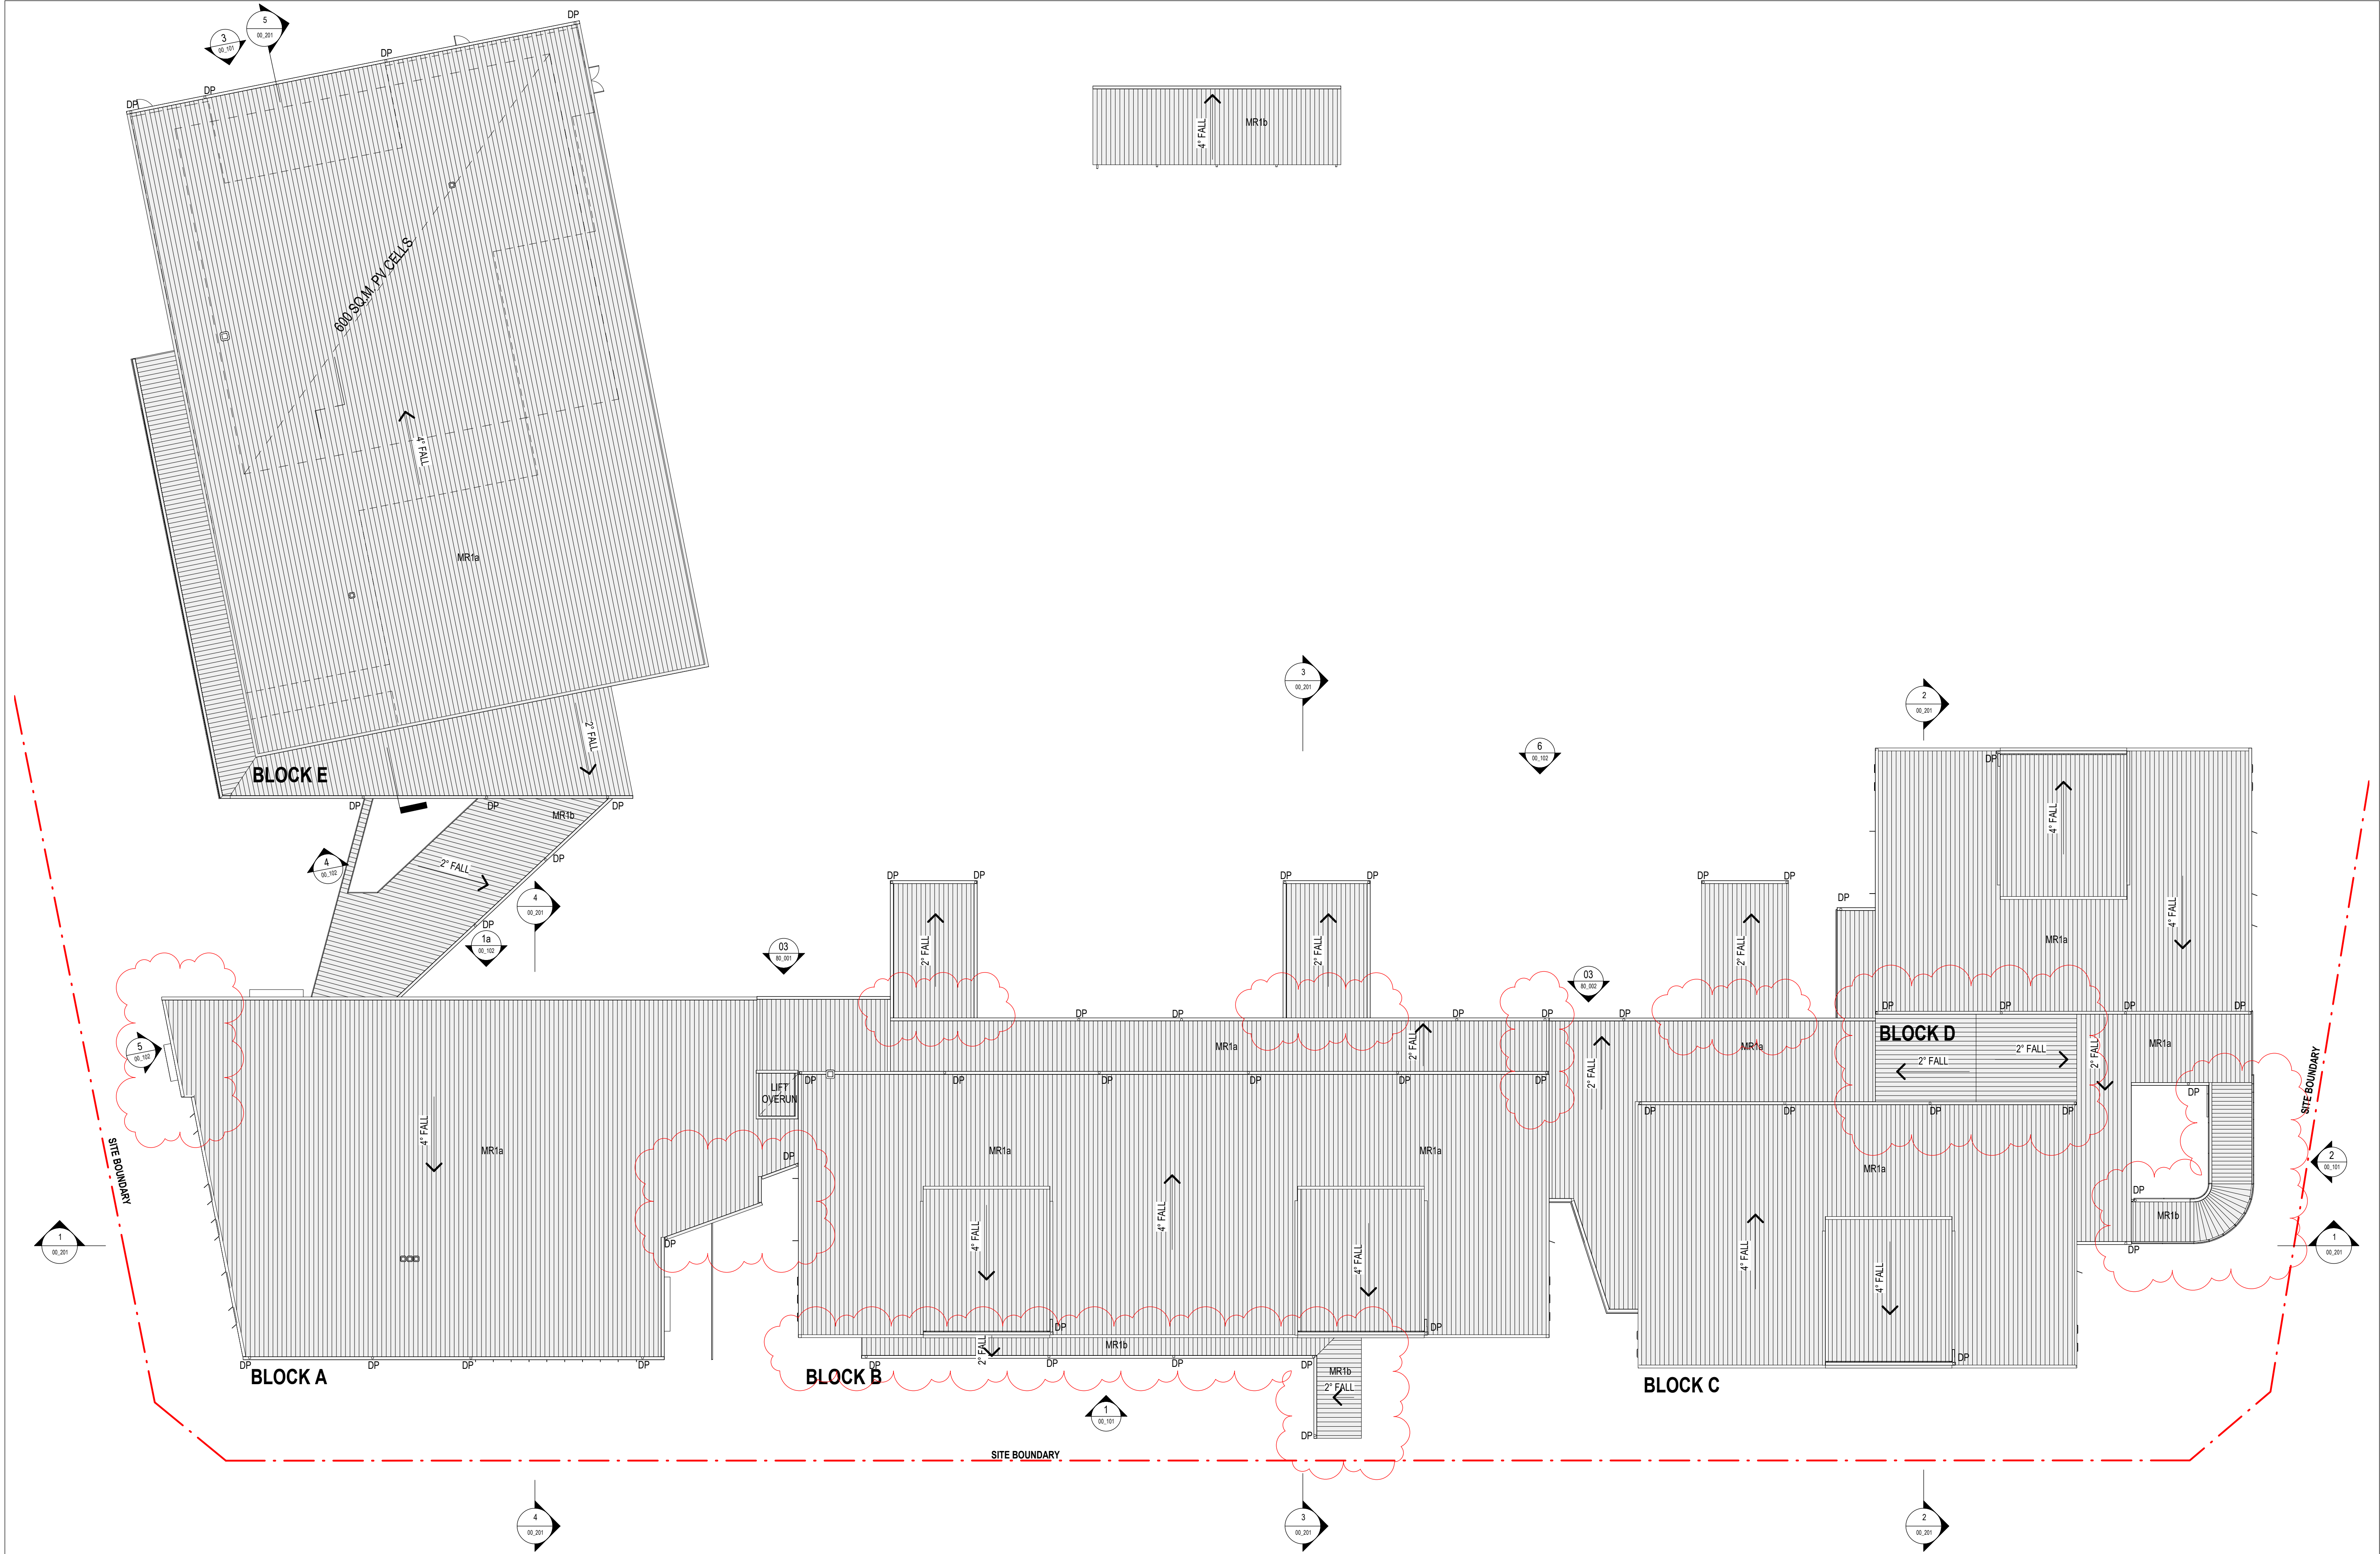LEGEND	
CON	CONCRETE
CFC1	CLADDING CFC, NEUTRAL COLOUR
CFC2a	CLADDING CFC, FEATURE COLOUR A
CFC2b	CLADDING CFC, FEATURE COLOUR B
CFC2c	CLADDING CFC, FEATURE COLOUR C
DP	DOWNSPIPE
LV1	ALUMINIUM LOUVRES - TYPE 1
LV2	ALUMINIUM LOUVRES - TYPE 2
MWC1b	METAL WALL CLADDING, COLOUR B


MR1a	METAL ROOFING, COLOUR A - UPPER LEVEL
MR1b	METAL ROOFING, COLOUR B - LOWER LEVEL
PC-b	POWDERCOAT, FEATURE COLOUR B
PC-e	POWDERCOAT, FEATURE COLOUR E
PC-f	POWDERCOAT, FEATURE COLOUR F
PMS	PERFORATED MESH SCREEN



STRUCTURAL, CIVIL NORTHROP ENGINEERS (02) 9241 4188 WEB: www.pp-a.com.au	PERUMAL PEDAVOLI ARCHITECTS T: 02 9291 0000 WEB: www.pp-a.com.au
MECHANICAL, ELECTRICAL STENSHEN VARMING (02) 9967 2200	Nominated Architect: Vince Pedavoli NSW reg No. 5045
HYDRAULIC WOOLACOTT'S (02) 8241 9900	LANDSCAPE ARCHITECT TAYLOR BRAMMER LANDS, ARCH. (02) 9387 8855
FIRE MCD FIRE ENGINEERING (04) 2392 2745	



CATHERINE FIELD PS
O'KEEFE DRIVE, ORAN PARK, NSW, 2570
NEW HIGH QUALITY CLASSROOMS PACKAGE 2
DRAWING NAME
COMPOSITE ROOF PLAN

	PROJECT NORTH					0 2000 4000 6000 8000 10000 20000					SCALE 1: 200 @ A1		
	DRAWN		CHECKED		VERIFIED		DATE						
	HS		KLC		SR		11 FEBRUARY 2020						
	DRAWING NUMBER										REVISION		
	PROJECT CODE		SCH. REF.		DISC.		TYPE		SERIES#				
	NHQC2 - CF - AR -SSDA-00_021										C		

SSDA


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1
00_002
SOUTH ELEVATION
1 : 200



2
00_002
EAST ELEVATION
1 : 200



3
00_002
NORTH ELEVATION - BLOCK E
1 : 200

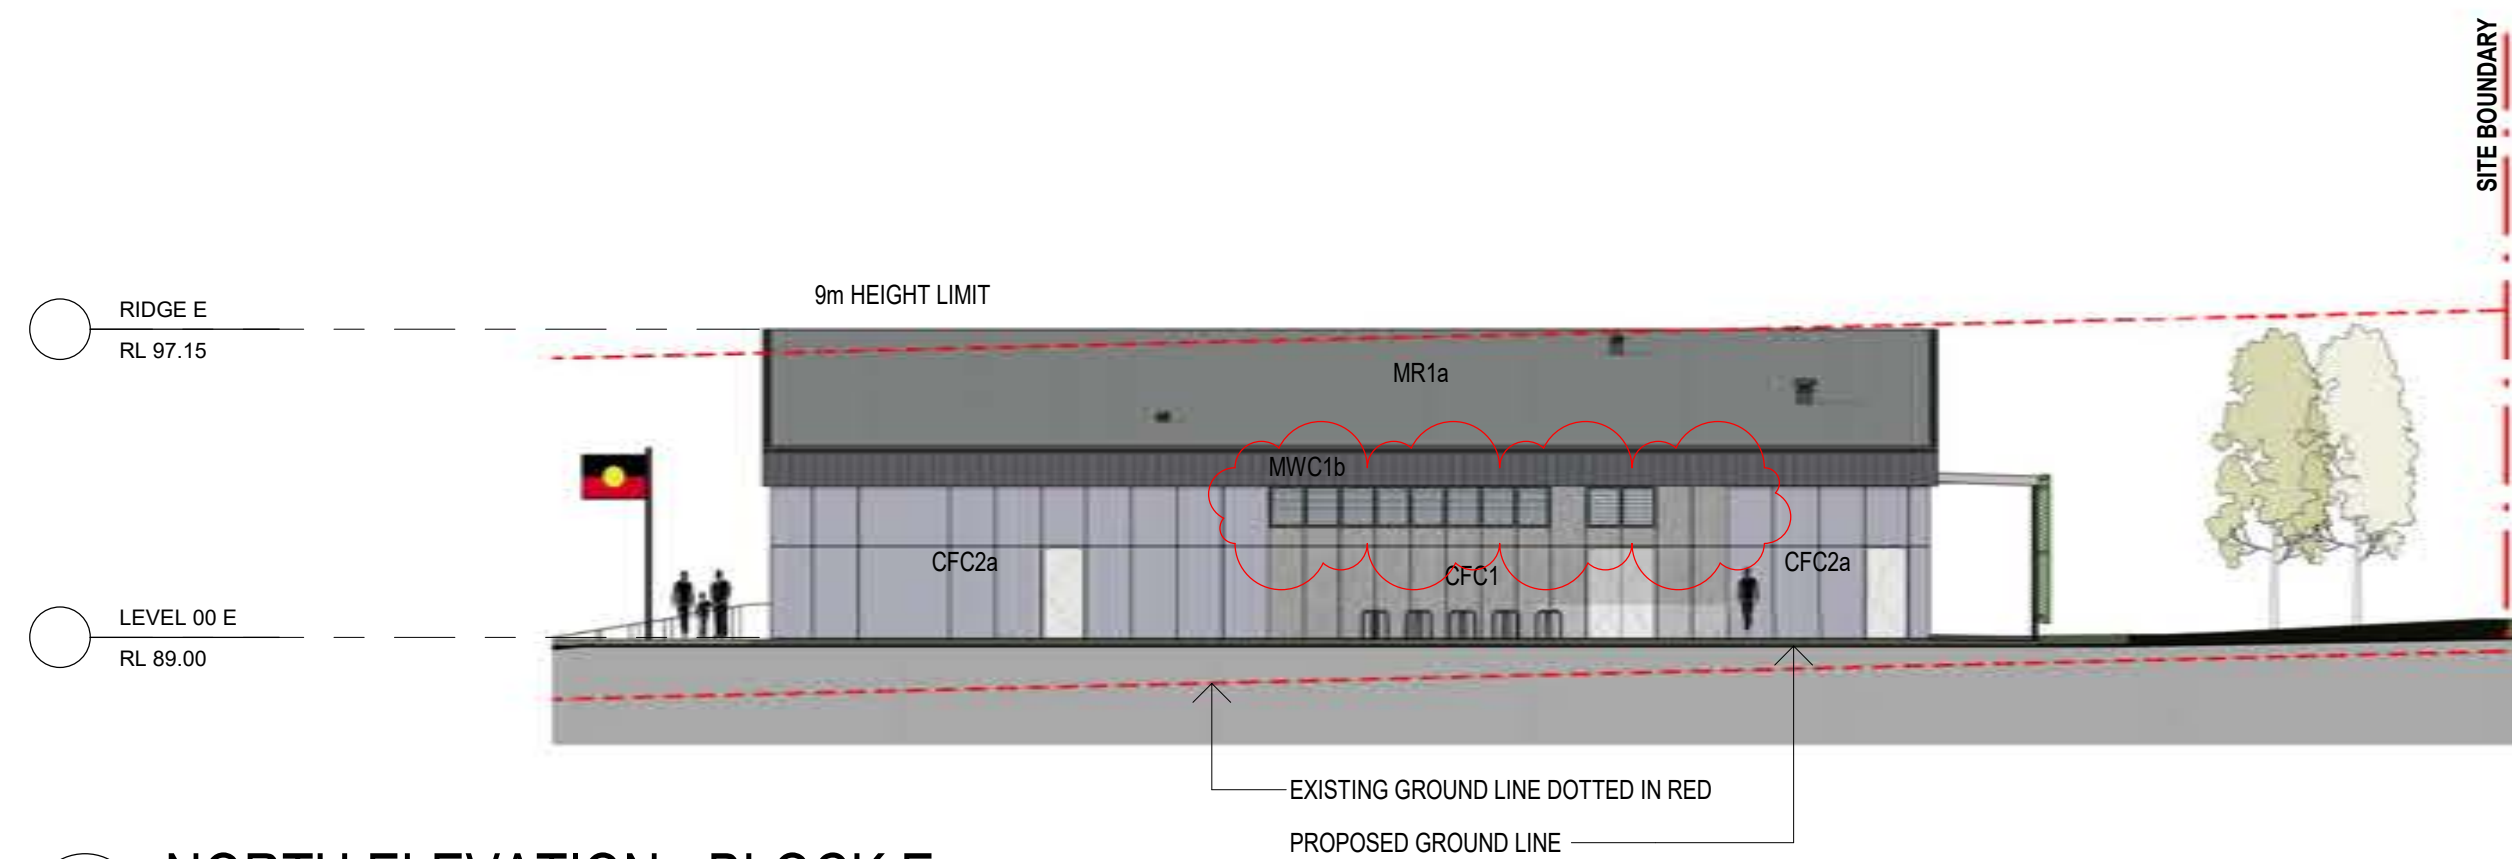
AMMENDMENTS				DESCRIPTION
REV	BY	DATE		
A	VL	30.08.19		ISSUE FOR SSDA 1GA
B	KLC	31.10.19		ISSUE FOR SSDA
C	RO	11.02.20		ISSUE FOR RTG - WINDOW LOUVRES ADDED TO BLOCK A & E. VERT. ALUMINIUM BLADES ADDED TO WALKWAY. OVERHEAD DOOR HEIGHT AMENDED BLOCK E

LEGEND	
CON	CONCRETE
CFC1	CLADDING CFC_NEUTRAL COLOUR
CFC2a	CLADDING CFC_FEATURE COLOUR A
CFC2b	CLADDING CFC_FEATURE COLOUR B
CFC2c	CLADDING CFC_FEATURE COLOUR C
DP	DOWNPIPE
LV1	ALUMINIUM LOUVRES - TYPE 1
LV2	ALUMINIUM LOUVRES - TYPE 2
MWC1b	METAL WALL CLADDING_COLOUR B


MR1a	METAL ROOFING_COLOUR A - UPPER LEVEL
MR1b	METAL ROOFING_COLOUR B - LOWER LEVEL
PC-b	POWDERCOAT_FEATURE COLOUR B
PC-e	POWDERCOAT_FEATURE COLOUR E
PC-f	POWDERCOAT_FEATURE COLOUR F
PMS	PERFORATED MESH SCREEN




STRUCTURAL CIVIL NORTHROP ENGINEERS (02) 9241 4188 MECHANICAL ELECTRICAL STEINSEN WARMING (02) 9967 2200 HYDRAULIC WOOLACOTT (02) 8241 9900 FIRE MCD FIRE ENGINEERING (04) 2392 2745	PERUMAL PEDAVOLI ARCHITECTS T: 02 9291 0000 WEB: www.pp-a.com.au Nominated Architect: Vince Pedavoli NSW reg No.5045 LANDSCAPE ARCHITECT TAYLOR BRAMMER LANDS. ARCH. (02) 9387 8855
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CATHERINE FIELD PS
O'KEEFE DRIVE, ORAN PARK, NSW, 2570
NEW HIGH QUALITY CLASSROOMS PACKAGE 2
DRAWING NAME
SOUTH, EAST & NORTH
ELEVATIONS

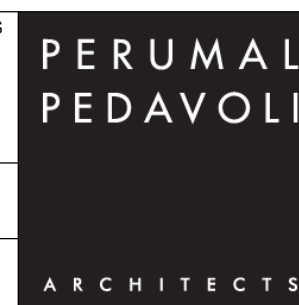PROJECT NORTH							20000
							SCALE 1 : 200 @ A1
DRAWN	CHECKED	VERIFIED	DATE				
HS	KLC	SR	11 FEBRUARY 2020				
DRAWING NUMBER						REVISION	
PROJECT CODE	SCH. REF.	DISC.	TYPE	SERIES#		C	
NHQC2 - LP - AR -SSDA-00_101							


SSDA



4 SOUTH SECTION-ELEVATION - BLOCK E
1 : 200

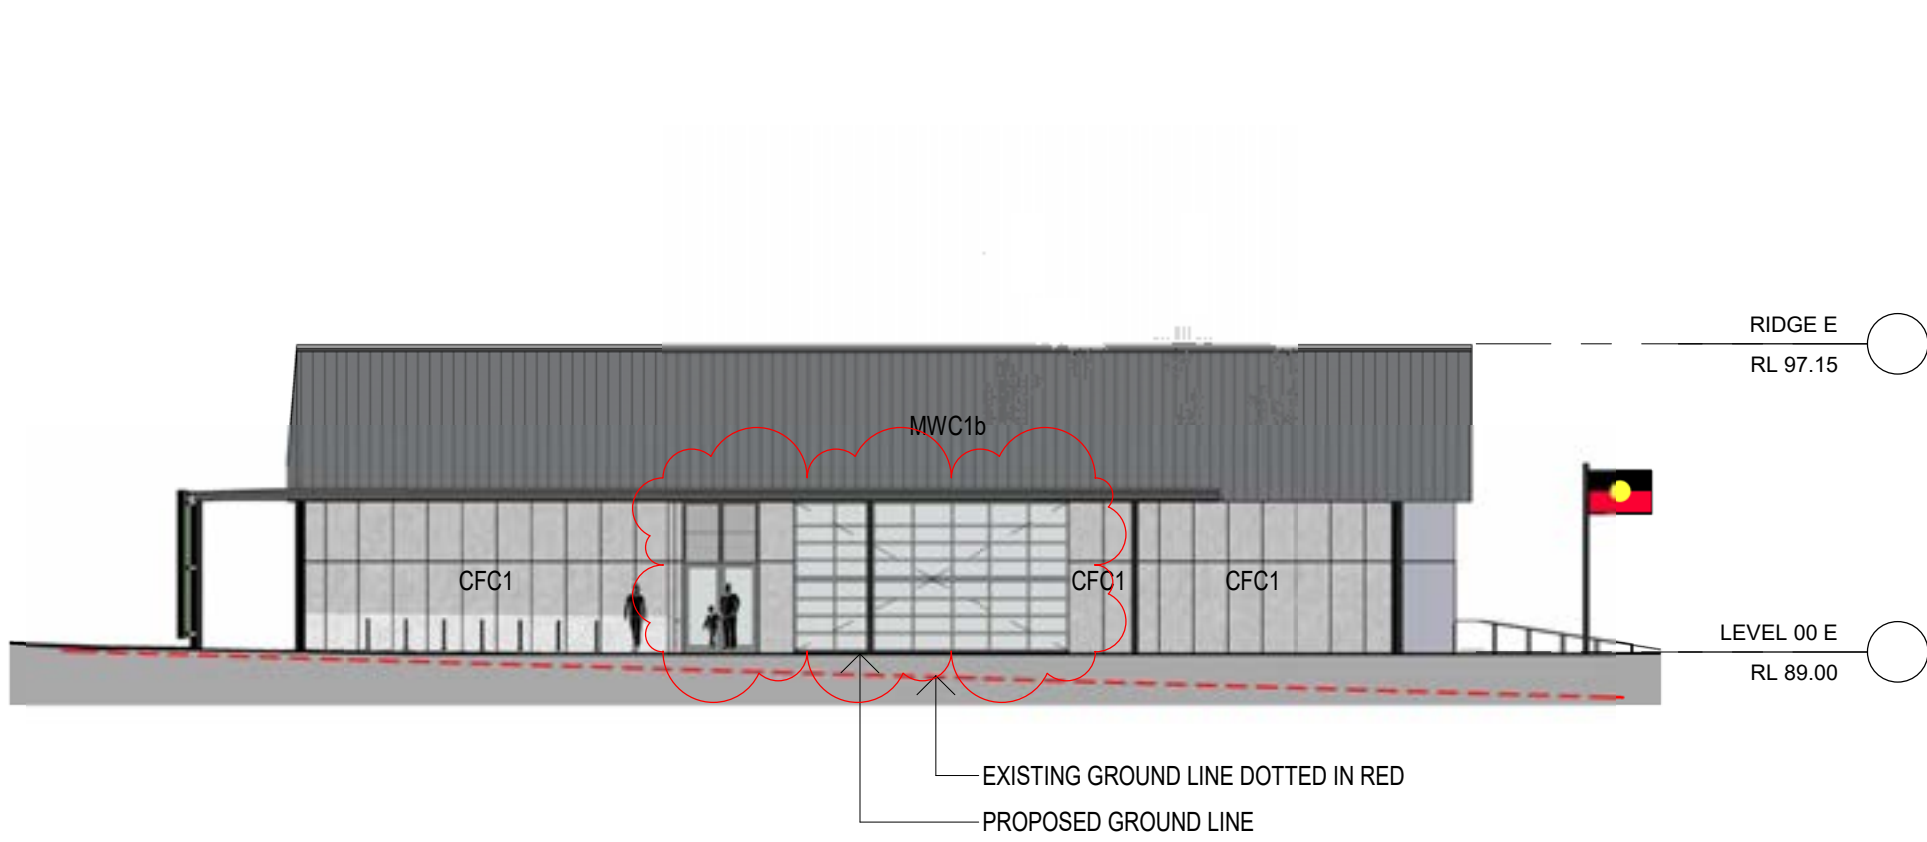

5 WEST ELEVATION - O'KEEFE DRIVE
1 : 200

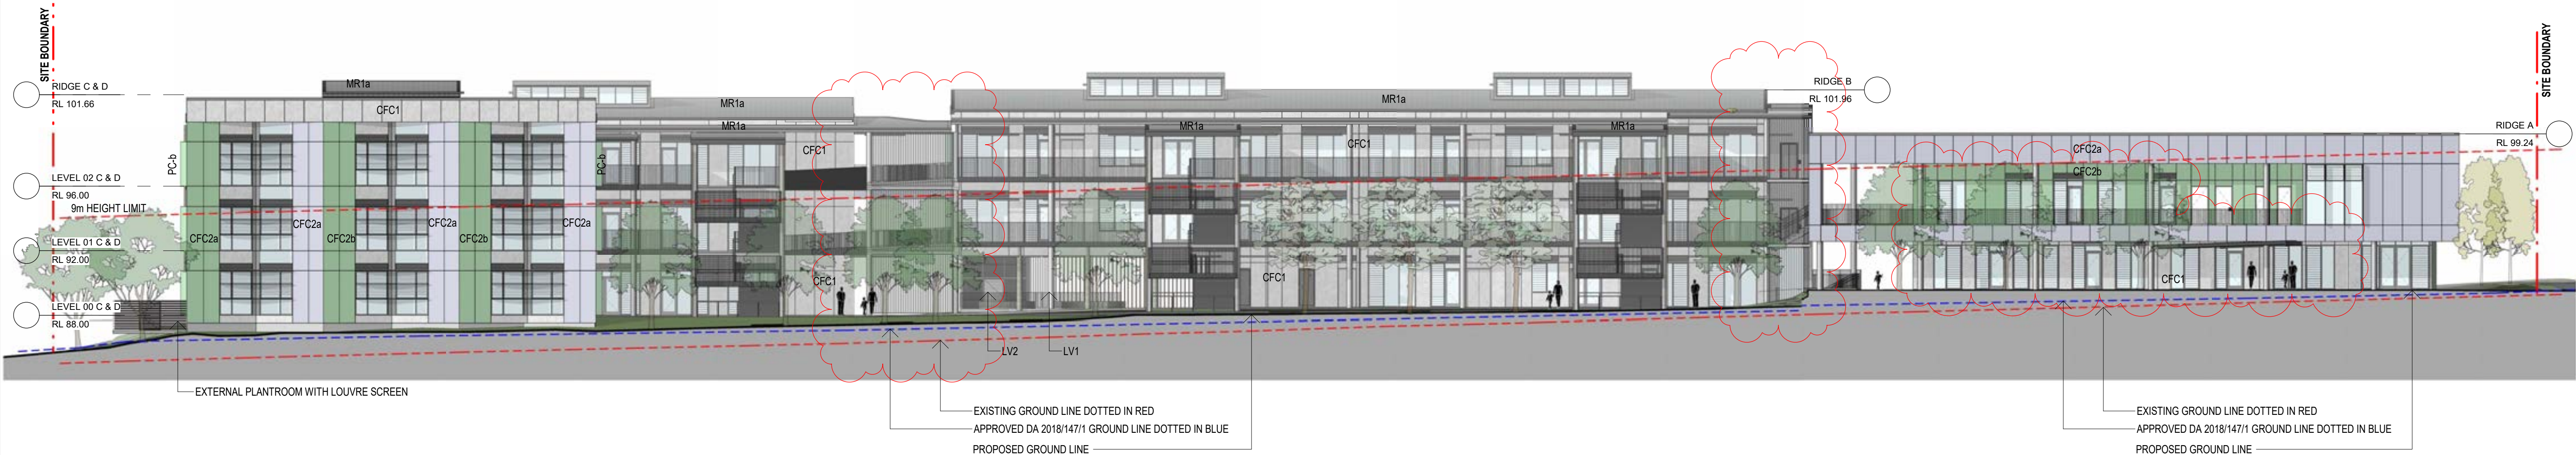

6 NORTH SECTION-ELEVATION A
1 : 200

AMMENDMENTS				DESCRIPTION
REV	BY	DATE		
A	VL	13.08.19		PRELIMINARY ISSUE FOR REVIEW
B	VL	30.08.19		ISSUE FOR SSSA 1a
B	KLC	31.10.19		ISSUE FOR SSSA
C	RO	11.02.20		ISSUE FOR RTIS - BLOCK A WEST FACADE AMENDED. WINDOW LOUVRES ADDED TO BLOCK A NORTH ELEVATION. VERTICAL ALUMINIUM BLADES ADDED TO WALKWAY. BLOCK E OVERHEAD DOOR HEIGHT AMENDED AND WINDOW LOUVRES ADDED


LEGEND	
CON	CONCRETE
CFC1	CLADDING CFC_NEUTRAL COLOUR
CFC2a	CLADDING CFC_FEATURE COLOUR A
CFC2b	CLADDING CFC_FEATURE COLOUR B
CFC2c	CLADDING CFC_FEATURE COLOUR C
DP	DOWNPIPE
LV1	ALUMINIUM LOUVRES - TYPE 1
LV2	ALUMINIUM LOUVRES - TYPE 2
MWC1b	METAL WALL CLADDING_COLOUR B

MR1a	METAL ROOFING_COLOUR A - UPPER LEVEL
MR1b	METAL ROOFING_COLOUR B - LOWER LEVEL
PC-b	POWDERCOAT_FEATURE COLOUR B
PC-e	POWDERCOAT_FEATURE COLOUR E
PC-f	POWDERCOAT_FEATURE COLOUR F
PMS	PERFORATED MESH SCREEN



STRUCTURAL CIVIL NORTHROP ENGINEERS (02) 9241 4188 WEB: www.pp-a.com.au
MECHANICAL ELECTRICAL STEENSEN WARMING (02) 9967 2200
HYDRAULIC WOOLACOTT (02) 8241 9900
FIRE MCD FIRE ENGINEERING (04) 2392 2745


PERUMAL PEDAVOLI ARCHITECTS T: 02 9291 0000 WEB: www.pp-a.com.au
Nominated Architect: Vince Pedavoli NSW reg No.5045
LANDSCAPE ARCHITECT TAYLOR BRAMMER LANDS ARCH. (02) 9387 8855

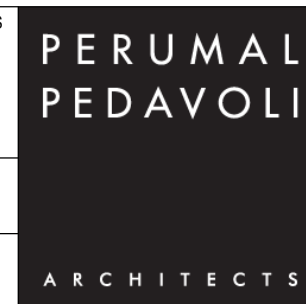


CATHERINE FIELD PS
O'KEEFE DRIVE, ORAN PARK, NSW, 2570
NEW HIGH QUALITY CLASSROOMS PACKAGE 2
DRAWING NAME
WEST ELEVATION & SOUTH & NORTH SECTION-ELEVATIONS

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DRAWN		CHECKED		VERIFIED		DATE		
HS		KLC		SR		11 FEBRUARY 2020		
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PROJECT CODE		SCH. REF.		DISC.		TYPE		SERIES#
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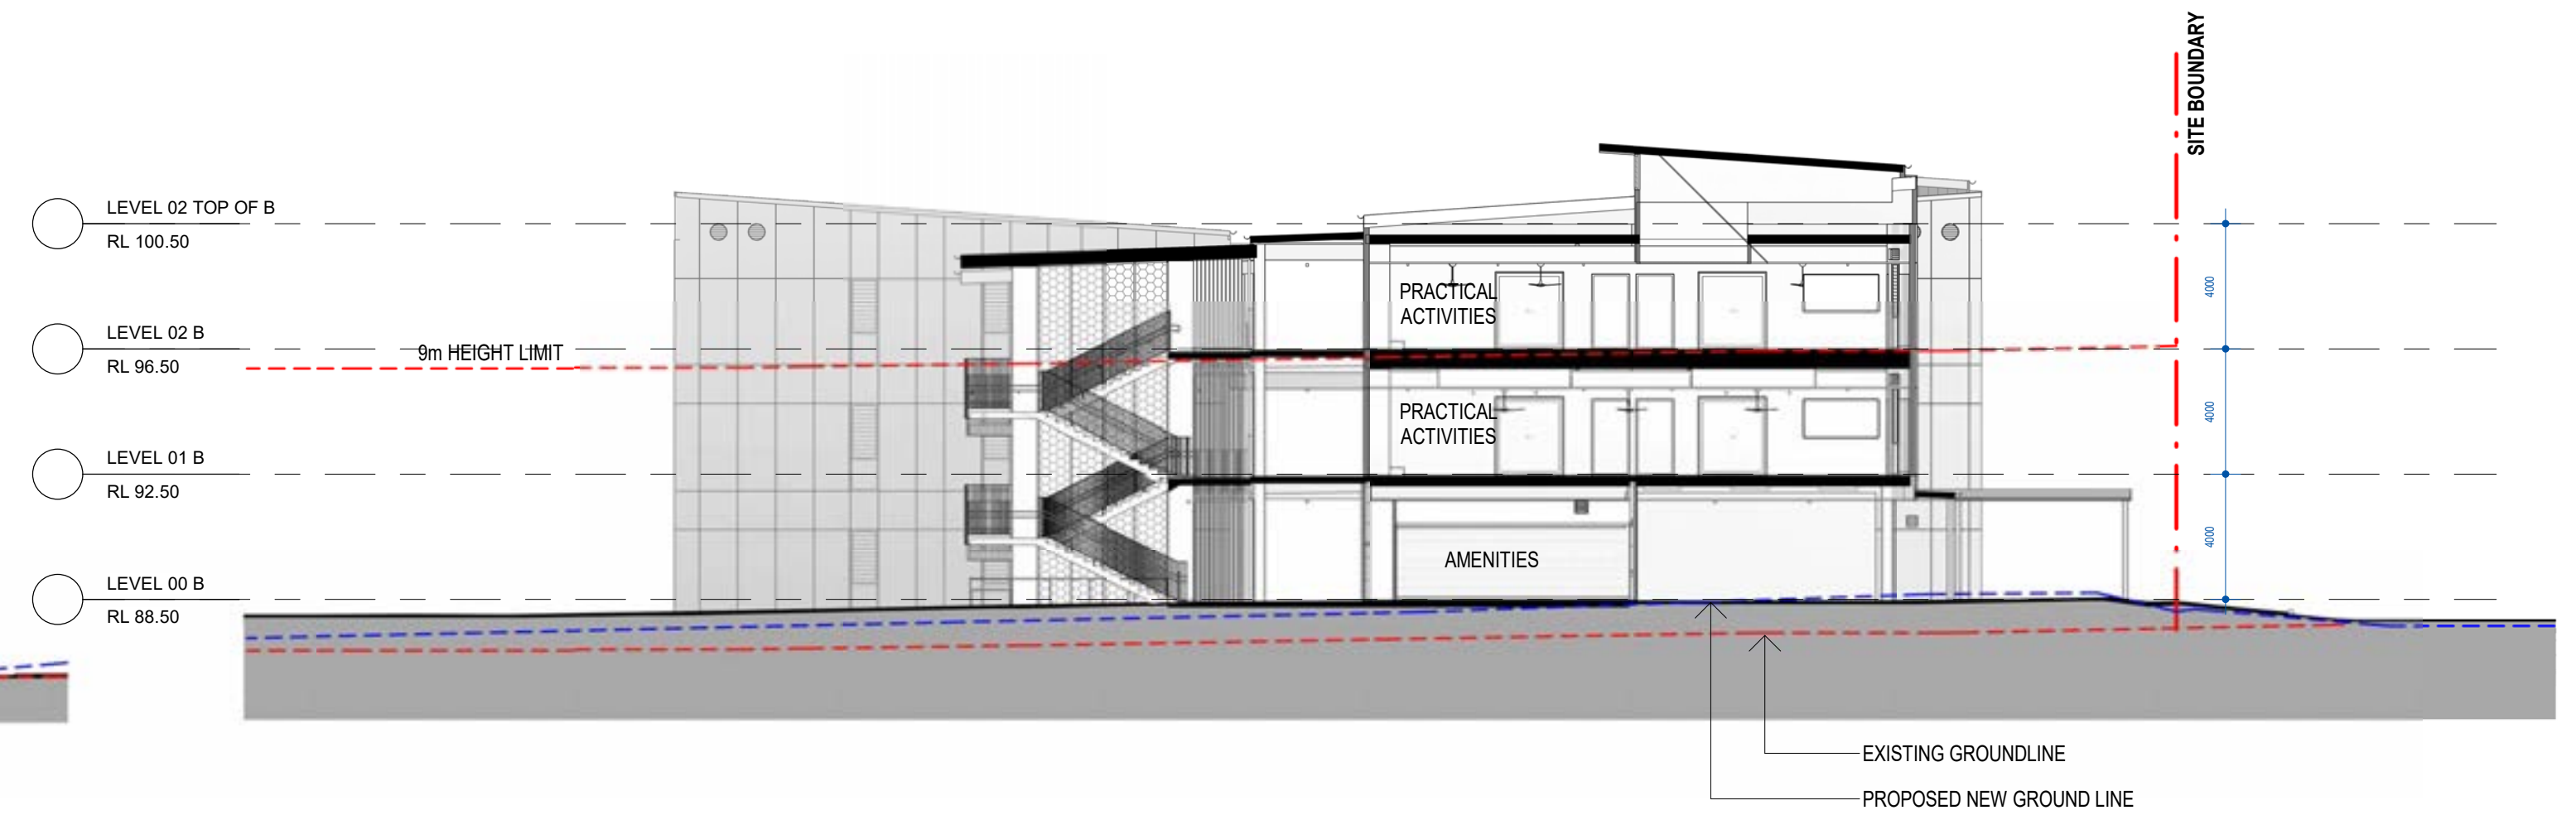
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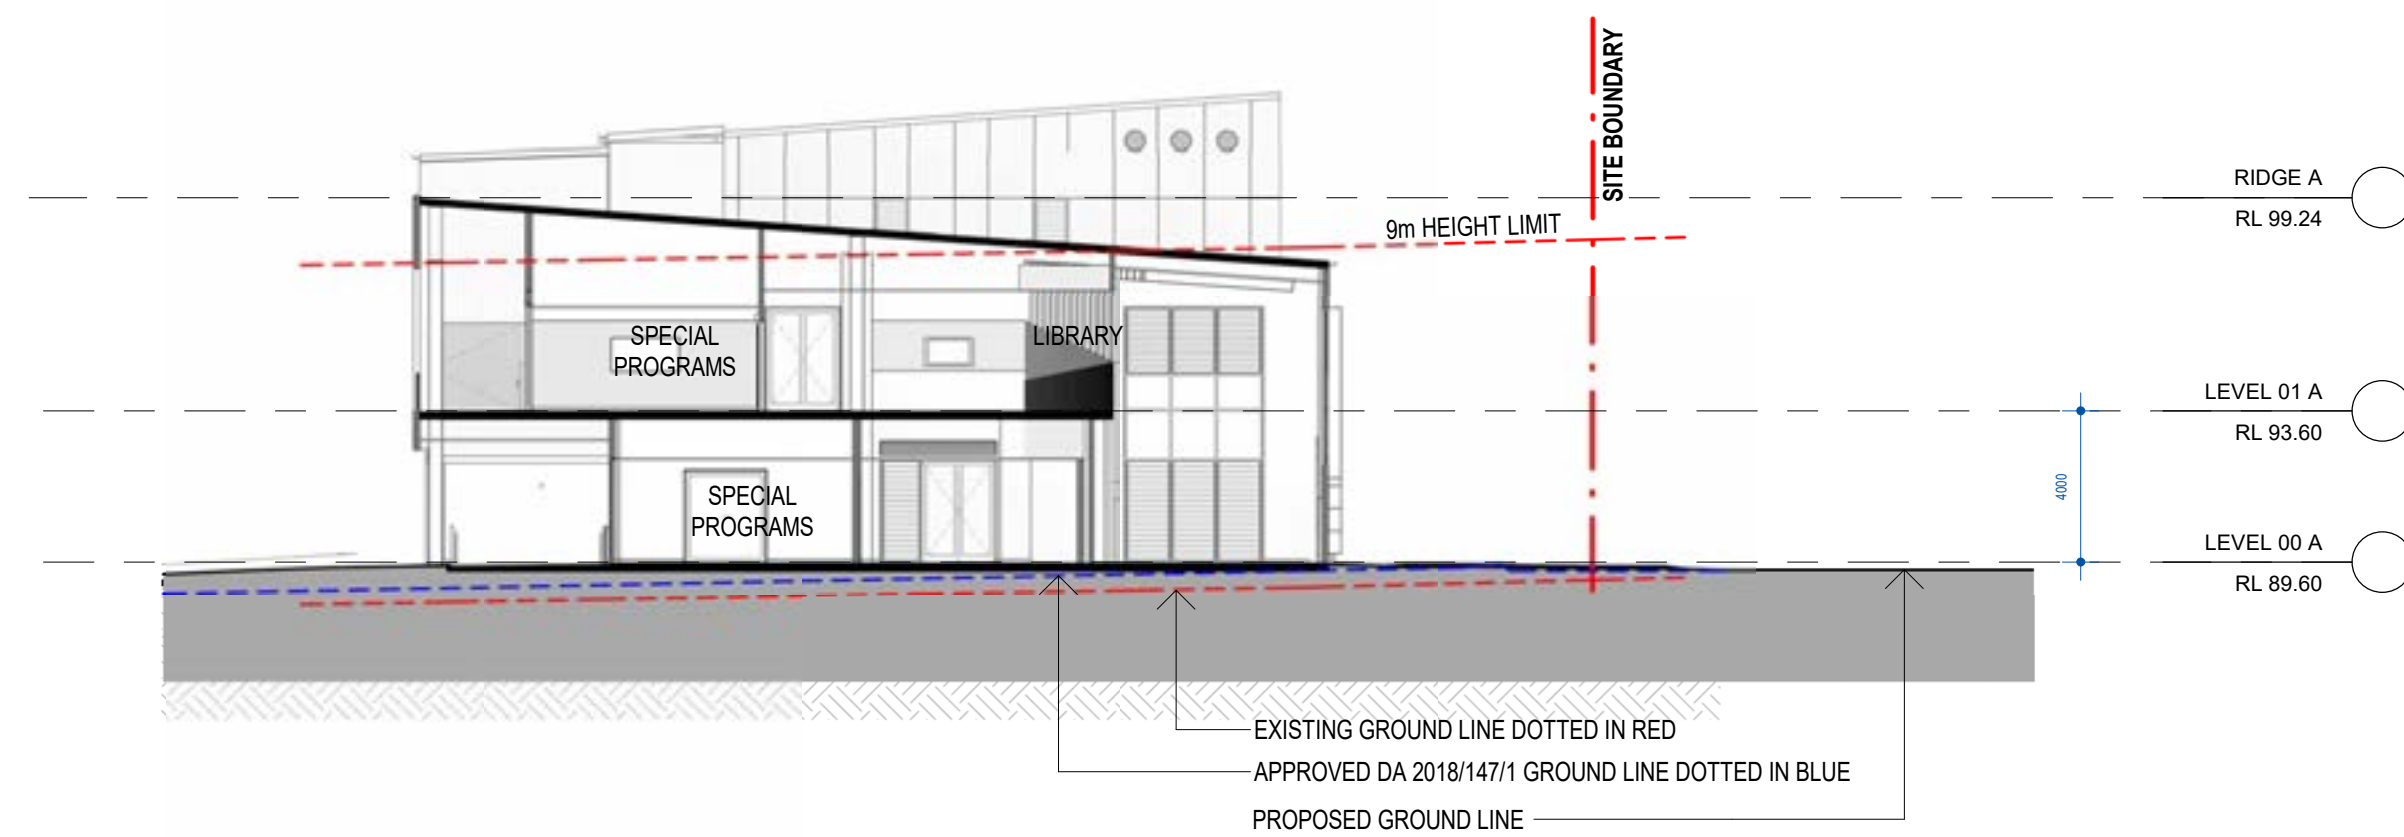
1 OVERALL SECTION 1
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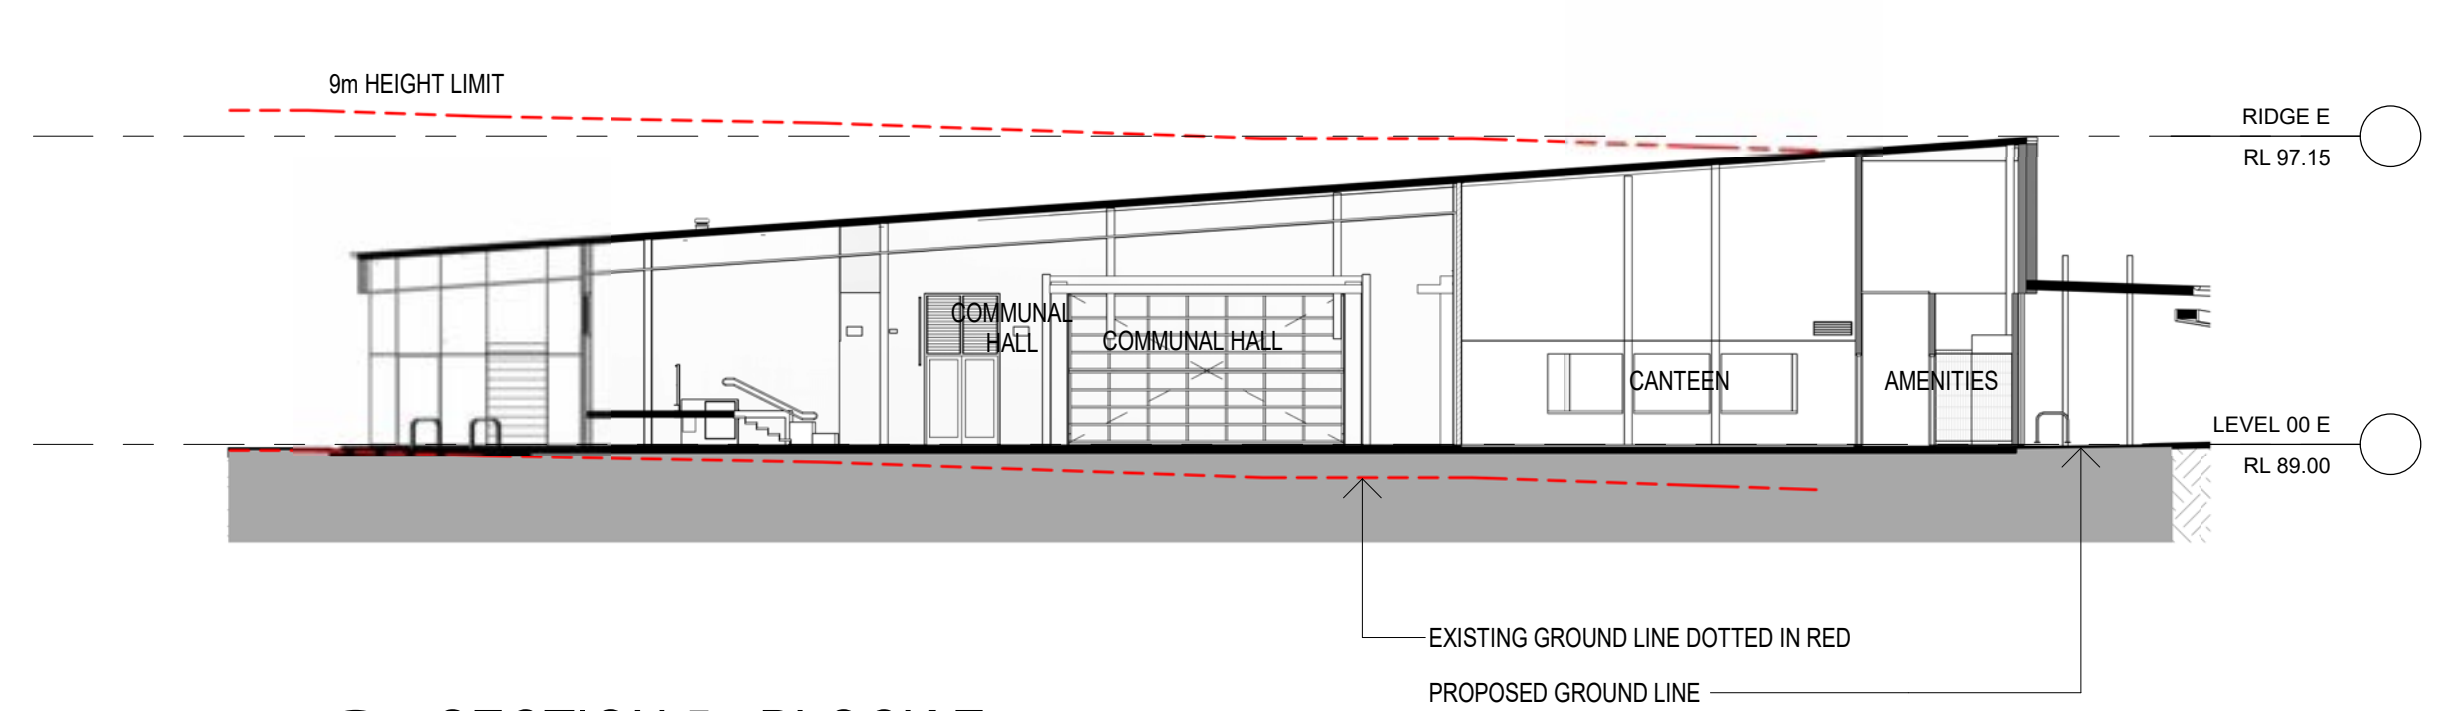
2 SECTION 2 - BLOCK C & D
1 : 200

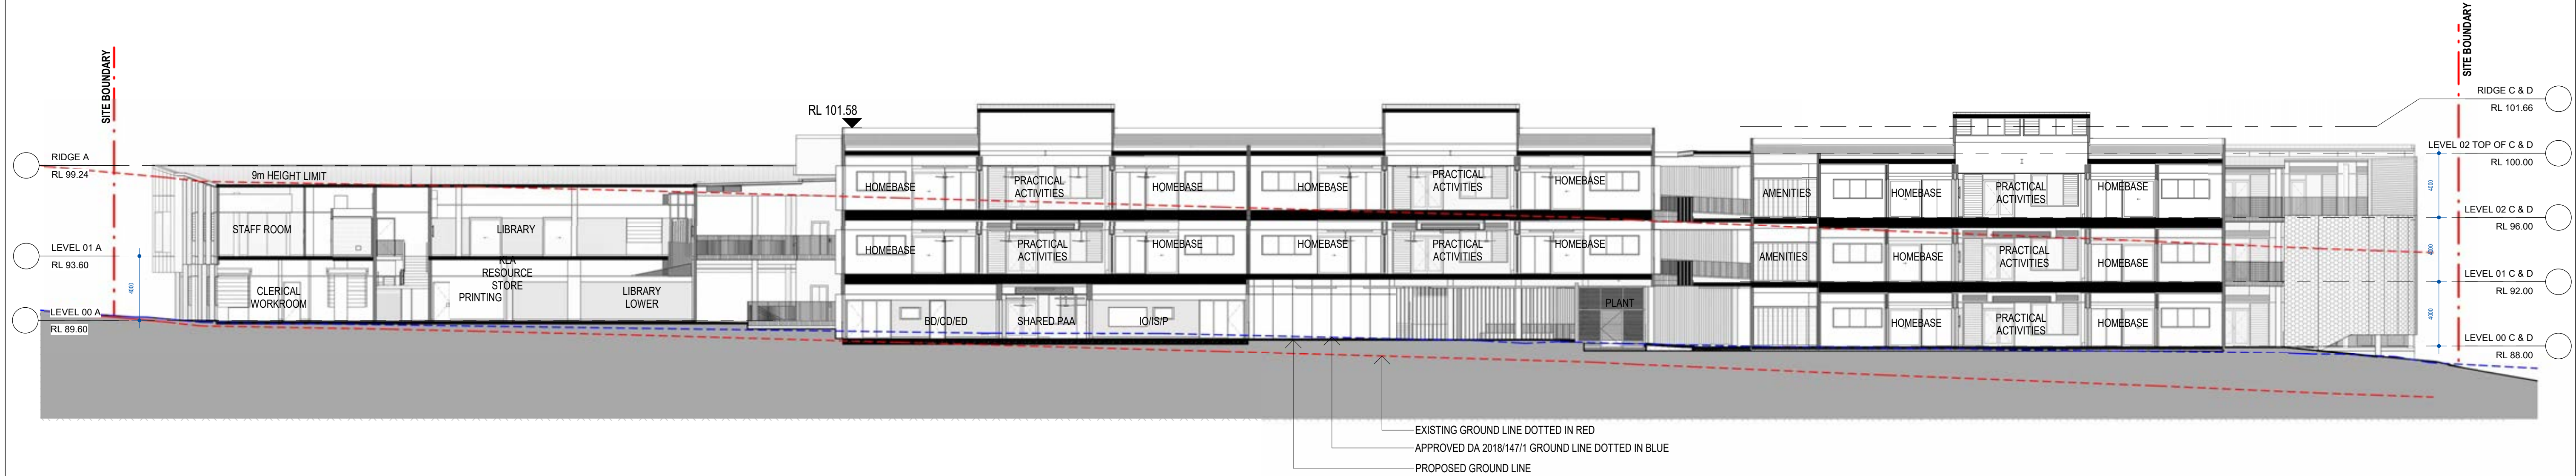

3 SECTION 3 - BLOCK B
1 : 200

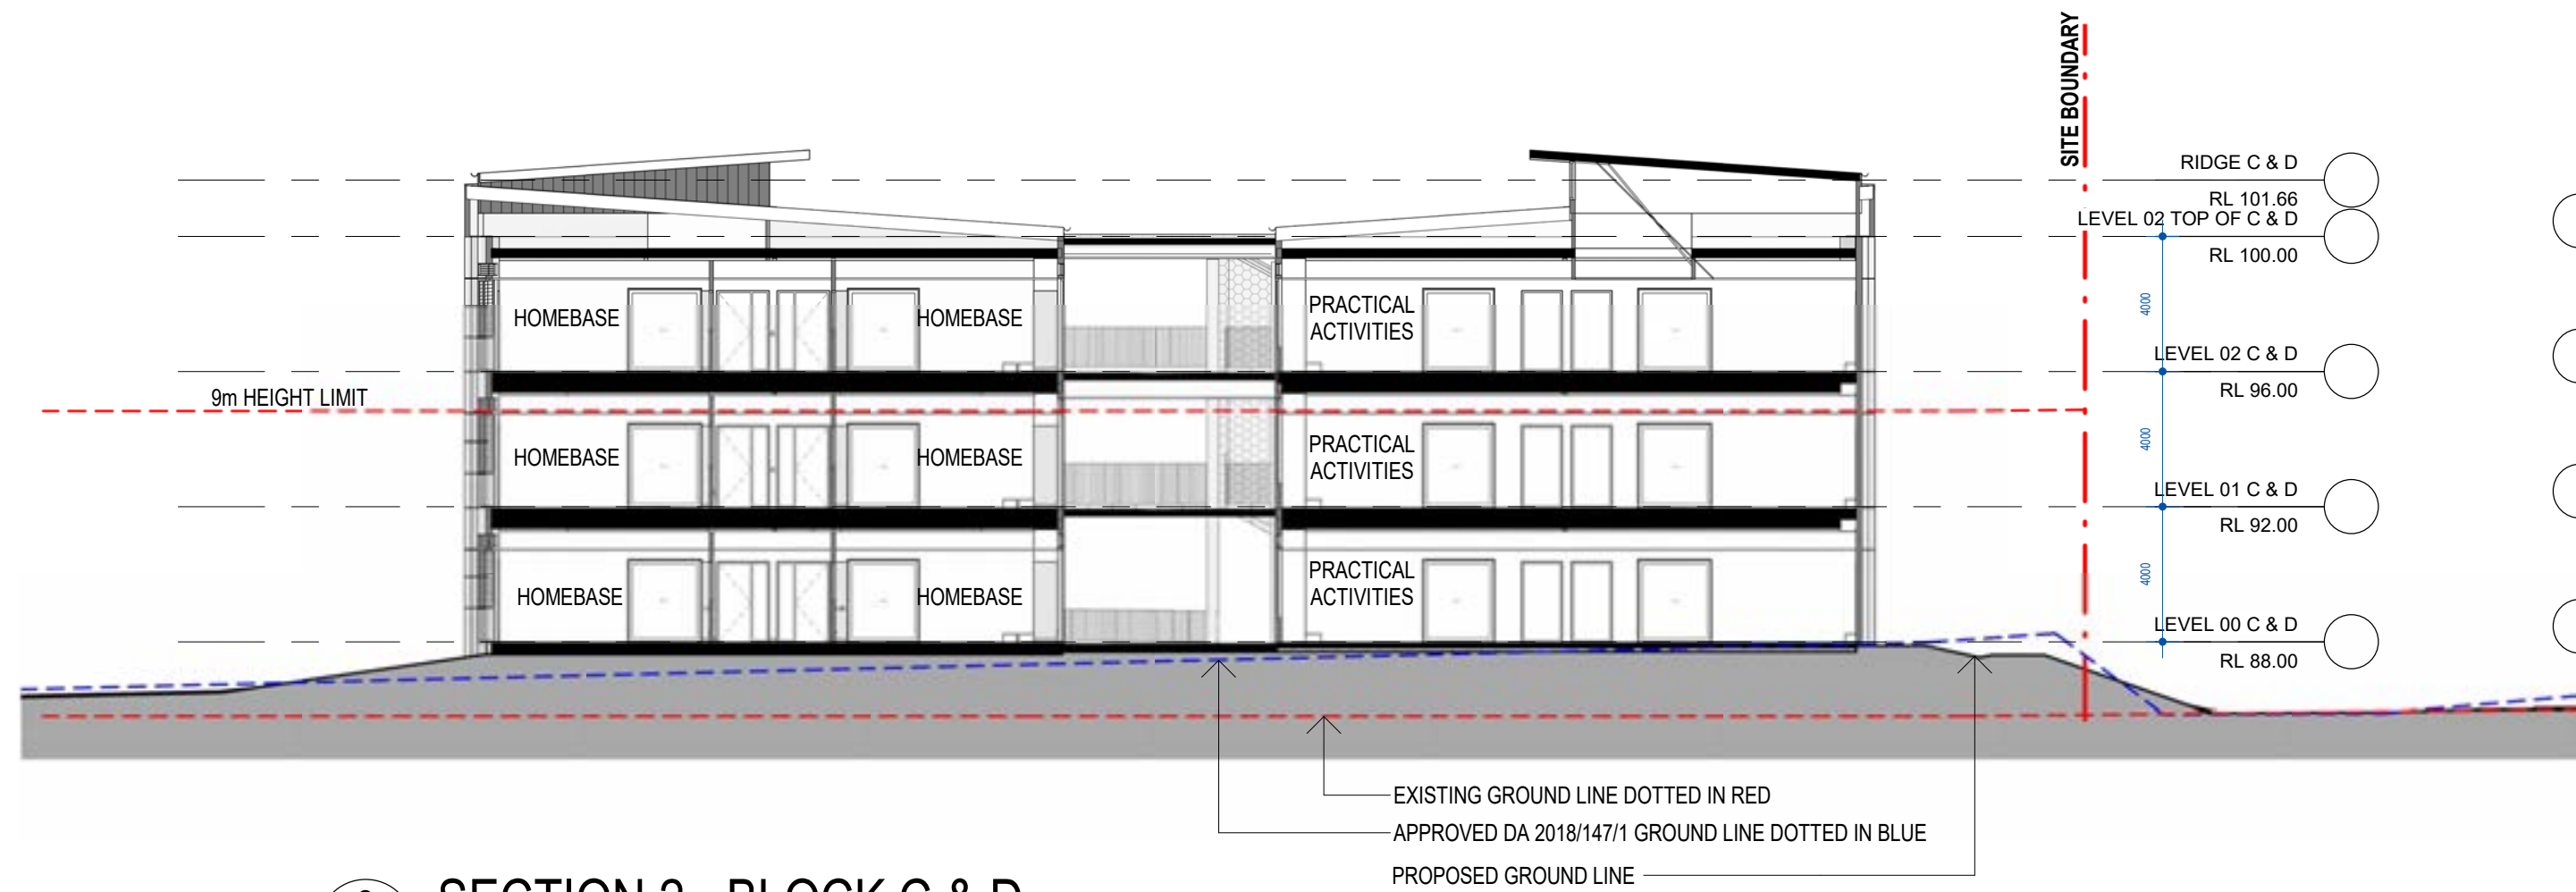

4 SECTION 4 - BLOCK A
1 : 200



5 SECTION 5 - BLOCK E
1 : 200

AMMENDMENTS				DESCRIPTION
REV	BY	DATE		
VL		13.08.19		PRELIMINARY ISSUE FOR REVIEW
VL		30.08.19		ISSUE FOR SSDA ToA
B	KLC	31.10.19		ISSUE FOR SSDA

LEGEND	
CON	CONCRETE
CFC1	CLADDING CFC_NEUTRAL COLOUR
CFC2a	CLADDING CFC_FEATURE COLOUR A
CFC2b	CLADDING CFC_FEATURE COLOUR B
CFC2c	CLADDING CFC_FEATURE COLOUR C
DP	DOWNPIPE
LV1	ALUMINIUM LOUVRES - TYPE 1
LV2	ALUMINIUM LOUVRES - TYPE 2
MWC1b	METAL WALL CLADDING_COLOUR B

MR1a	METAL ROOFING_COLOUR A - UPPER LEVEL
MR1b	METAL ROOFING_COLOUR B - LOWER LEVEL
PC-b	POWDERCOAT_FEATURE COLOUR B
PC-e	POWDERCOAT_FEATURE COLOUR E
PC-f	POWDERCOAT_FEATURE COLOUR F
PMS	PERFORATED MESH SCREEN



STRUCTURAL CIVIL
NORTHROP ENGINEERS
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MECHANICAL ELECTRICAL
STEINER WARMING
(02) 9967 2200
HYDRAULIC
WOOLACOTT
(02) 8241 9900
FIRE
MCD FIRE ENGINEERING
(04) 2392 2745

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TAYLOR BRAMMER LANDS ARCH.
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PERUMAL
PEDAVOLI
ARCHITECTS

CATHERINE FIELD PS
O'KEEFE DRIVE, ORAN PARK, NSW, 2570
NEW HIGH QUALITY CLASSROOMS PACKAGE 2
DRAWING NAME
SECTIONS

PROJECT NORTH		0 2000 4000 6000 8000 10000 20000				SCALE 1: 200 @ A1	
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HS	KLC	SR	11 FEBRUARY 2020			B	
DRAWING NUMBER		PROJECT CODE		SCH. REF.	DISC.	TYPE	SERIES
NHQC2 - CF - AR - SSDA - 00_201							

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MAIN ENTRY FROM O'KEEFE DRIVE



STREET VIEW FROM O'KEEFE DRIVE WITH HALL & MAIN ENTRIES



CFC1 - CLADDING
NEUTRAL COLOUR




PMS/PC-e - PERFORATED METAL SCREEN
POWDERCOATED



CON - CONCRETE



CFC2a - CLADDING
FEATURE COLOUR A

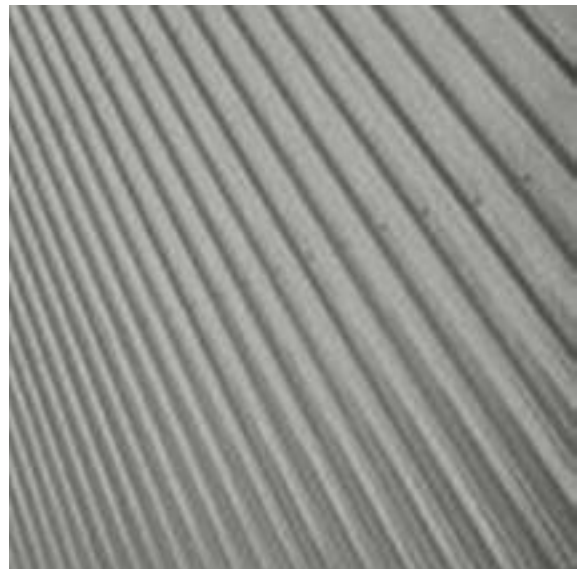


MR1a - METAL ROOFING
COLOUR A




LV1 - PRIVACY SCREEN
ALUMINIUM LOUVRES




CFC2b - CLADDING
FEATURE COLOUR B

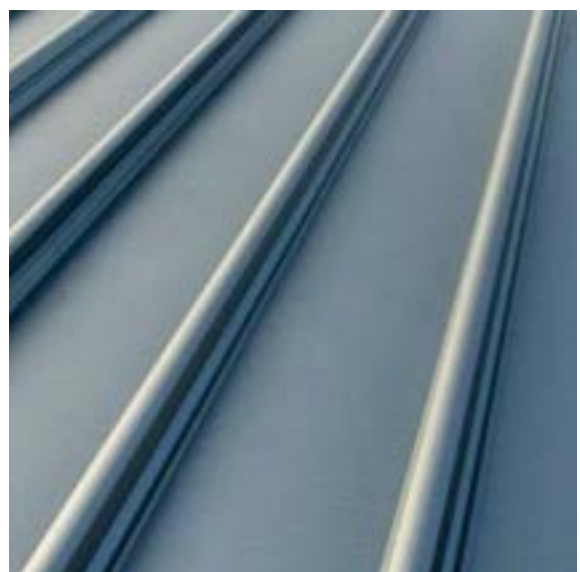

MR1b - METAL ROOFING
COLOUR B

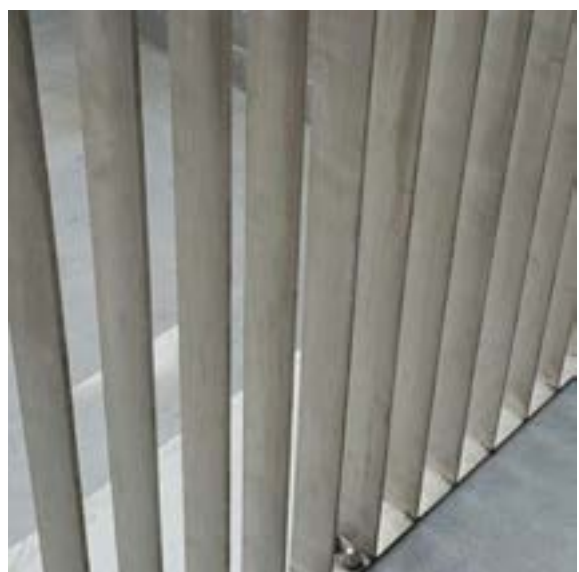

GALVANISED BALUSTRADES

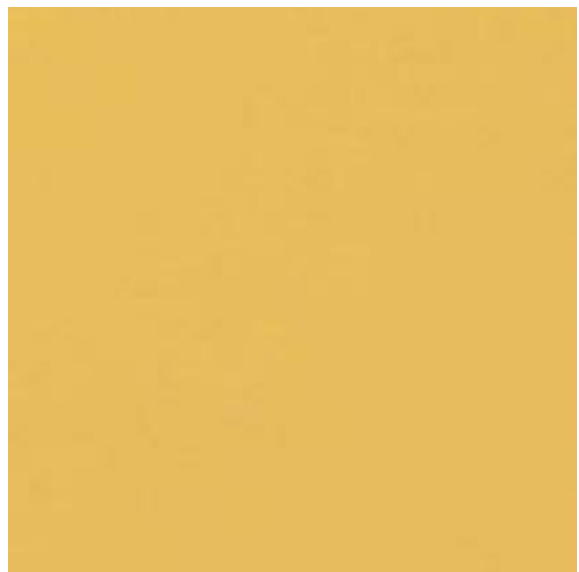


CFC2c - CLADDING
FEATURE COLOUR C



LV2, EXTERNAL DOOR & WINDOW FRAMES
& PC-f POWDERCOAT



PC-b & PC-e SUNSHADES ACCENT
POWDERCOAT

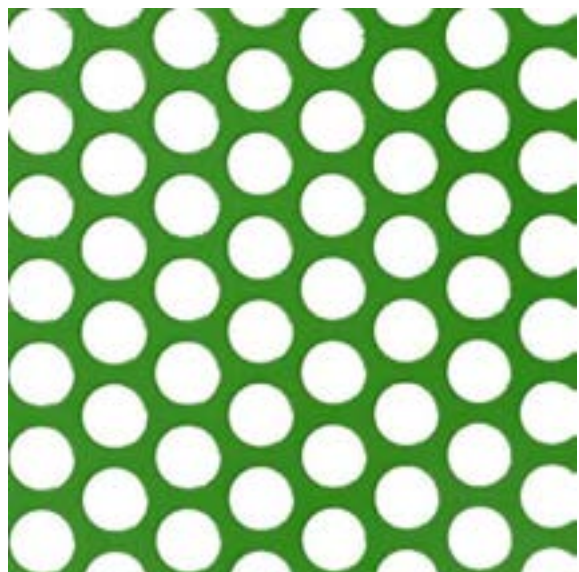

PMS / PC-g - HALL ENTRY SCREEN FEATURE
POWDERCOATED PERFORATED METAL



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REV	BY	DATE	ISSUE FOR SDA	
A	KLC	31.10.19		

LEGEND	
CON	CONCRETE
CFC1	CLADDING CFC_NEUTRAL COLOUR
CFC2a	CLADDING CFC_FEATURE COLOUR A
CFC2b	CLADDING CFC_FEATURE COLOUR B
CFC2c	CLADDING CFC_FEATURE COLOUR C
DP	DOWNPIPE
LV1	ALUMINIUM LOUVRES - TYPE 1
LV2	ALUMINIUM LOUVRES - TYPE 2
MWC1b	METAL WALL CLADDING_COLOUR B

MR1a	METAL ROOFING_COLOUR A - UPPER LEVEL
MR1b	METAL ROOFING_COLOUR B - LOWER LEVEL
PC-b	POWDERCOAT_FEATURE COLOUR B
PC-e	POWDERCOAT_FEATURE COLOUR E
PC-f	POWDERCOAT_FEATURE COLOUR F
PMS	PERFORATED MESH SCREEN



STRUCTURAL CIVIL NORTHROP ENGINEERS (02) 9241 4188	PERUMAL PEDAVOLI ARCHITECTS T: 02 9291 0000 WEB: www.pp-a.com.au
MECHANICAL ELECTRICAL STEENSEN WARMING (02) 9967 2200	Nominated Architect: Vince Pedavoli NSW reg No.5045
HYDRAULIC WOOLACOTT (02) 8241 9900	LANDSCAPE ARCHITECT TAYLOR BRAMMER LANDS. ARCH. (02) 9387 8855
FIRE MCD FIRE ENGINEERING (04) 2392 2745	




CATHERINE FIELD PS
O'KEEFE DRIVE, ORAN PARK, NSW, 2570
NEW HIGH QUALITY CLASSROOMS PACKAGE 2

DRAWING NAME
RENDERS & MATERIAL BOARD


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DRAWN	CHECKED	VERIFIED	DATE		
HS	KLC	SR	11 FEBURARY 2020		
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PROJECT CODE	SCH. REF.	DISC.	TYPE	SERIES#	
NHQC2 - LP - AR-SSDA-00_401					A

SSDA

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SECTION - BLOCK B

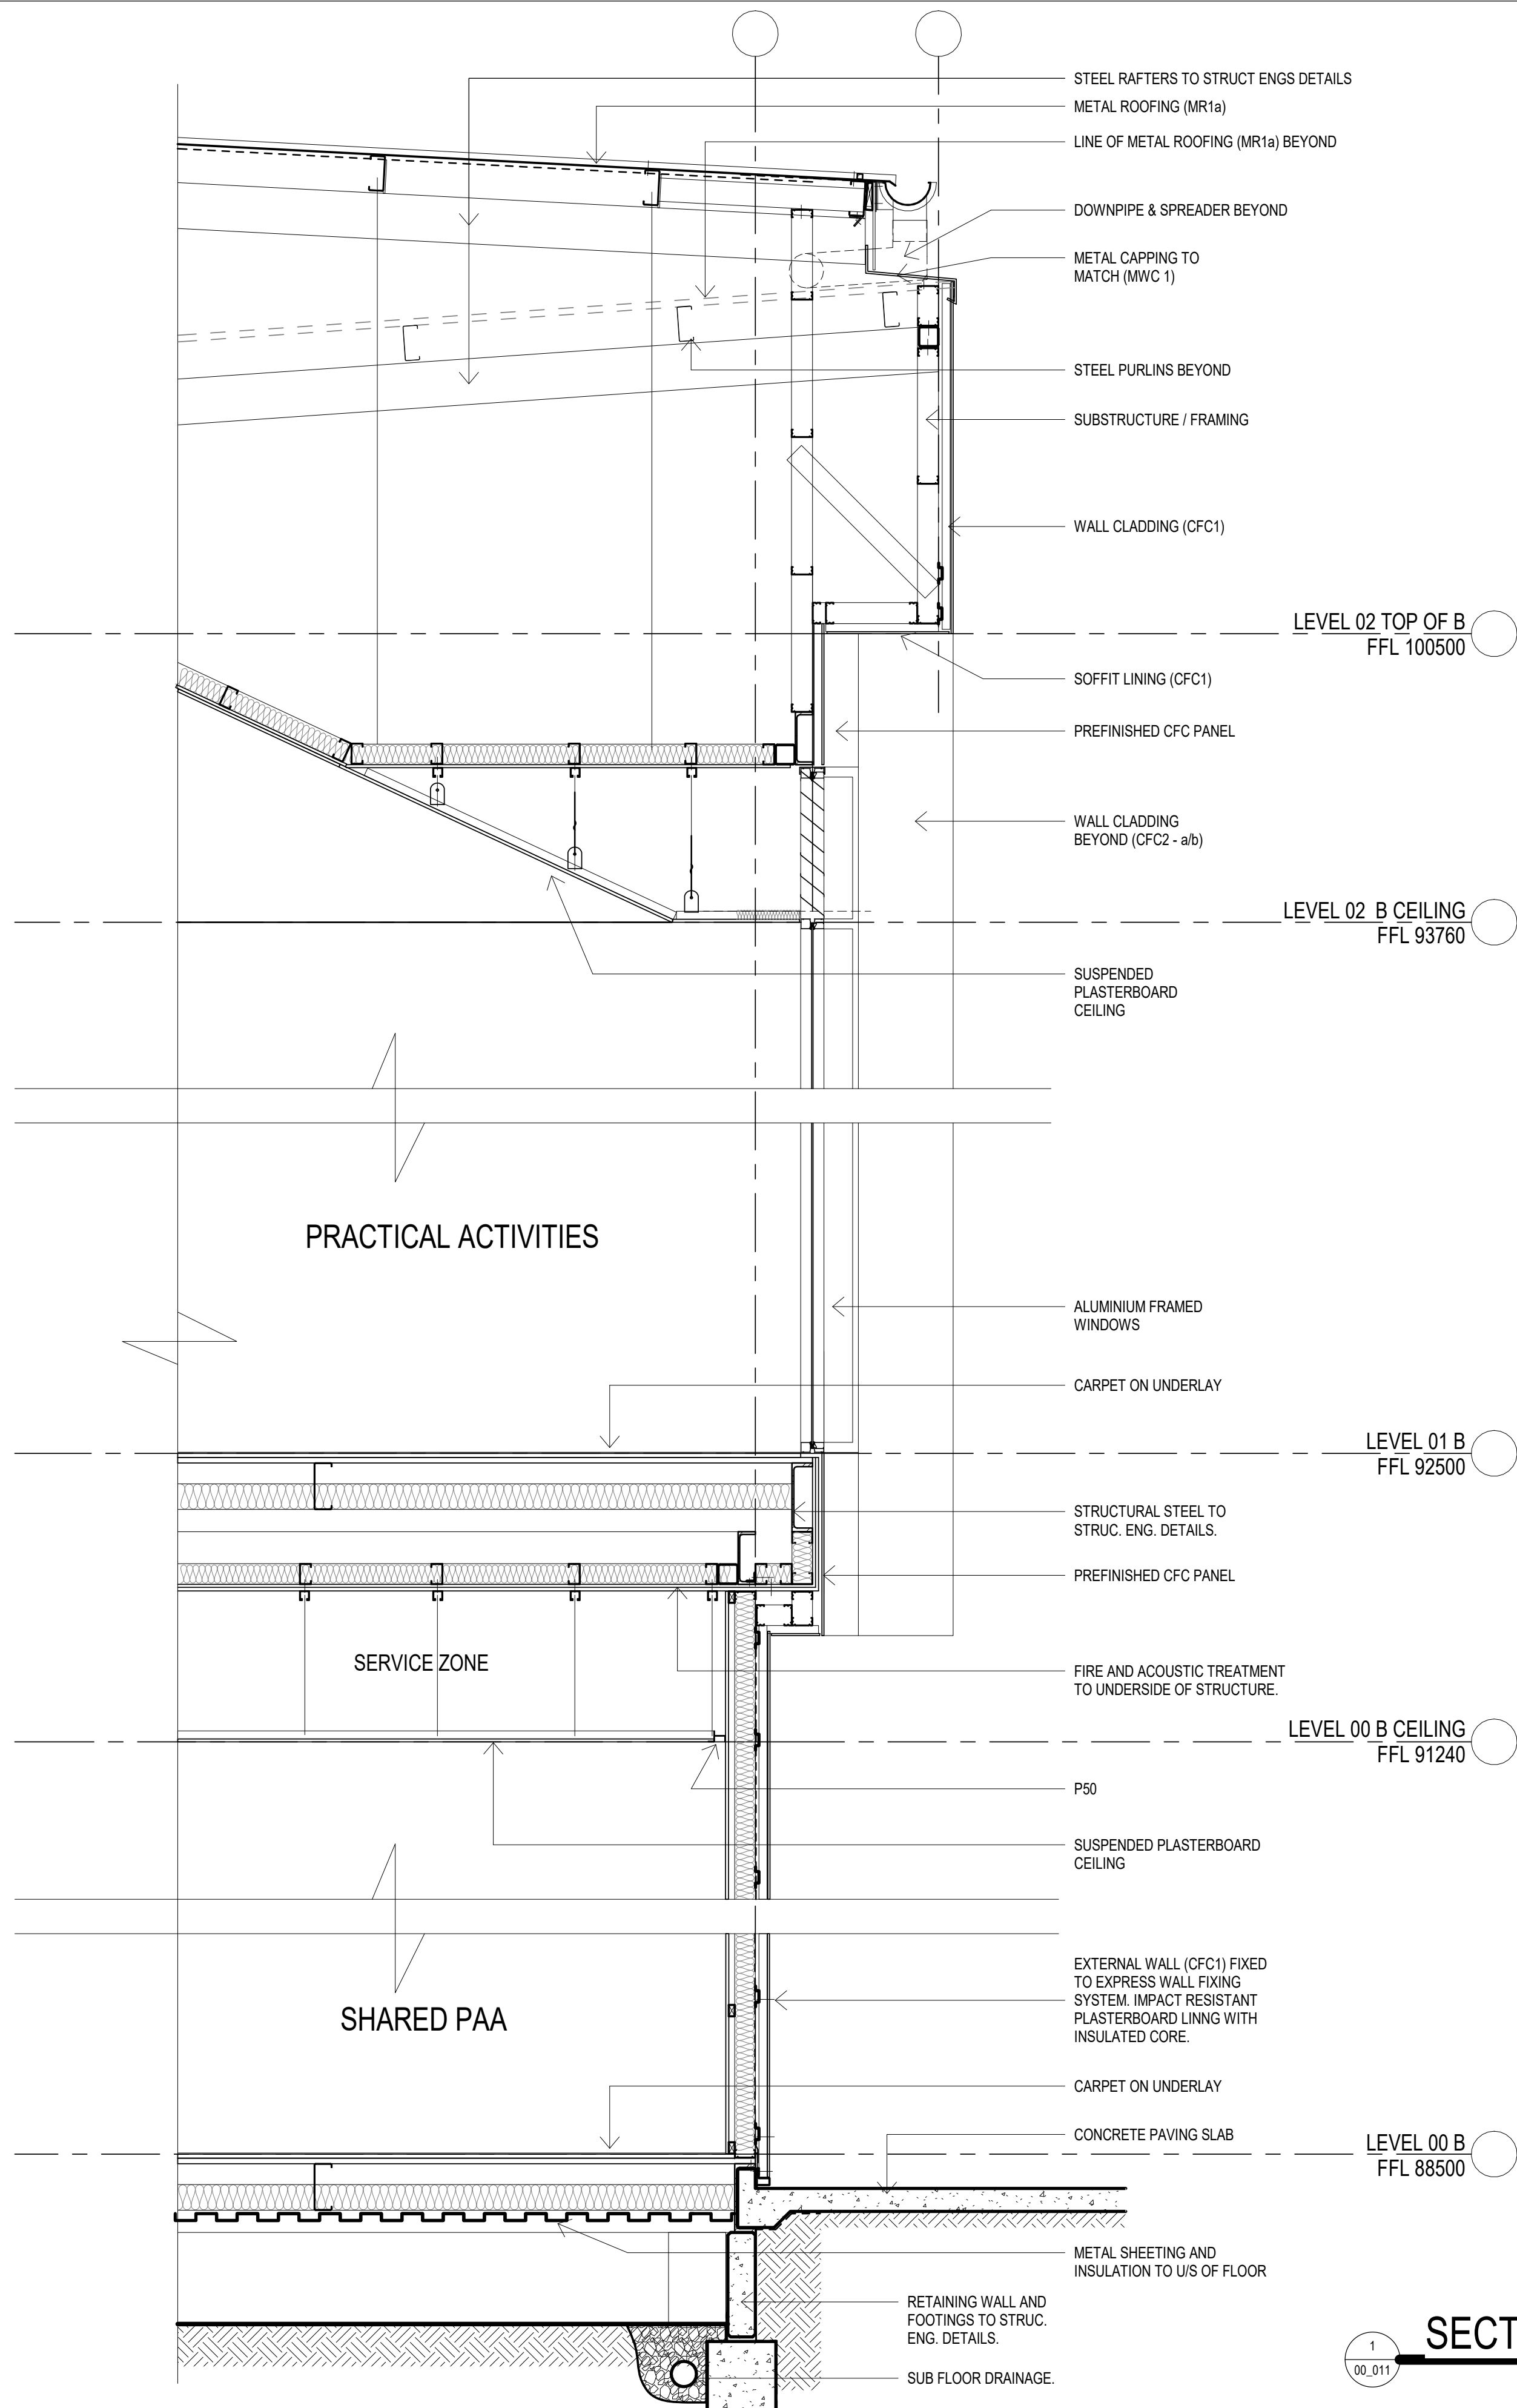

SECTION - BLOCK A

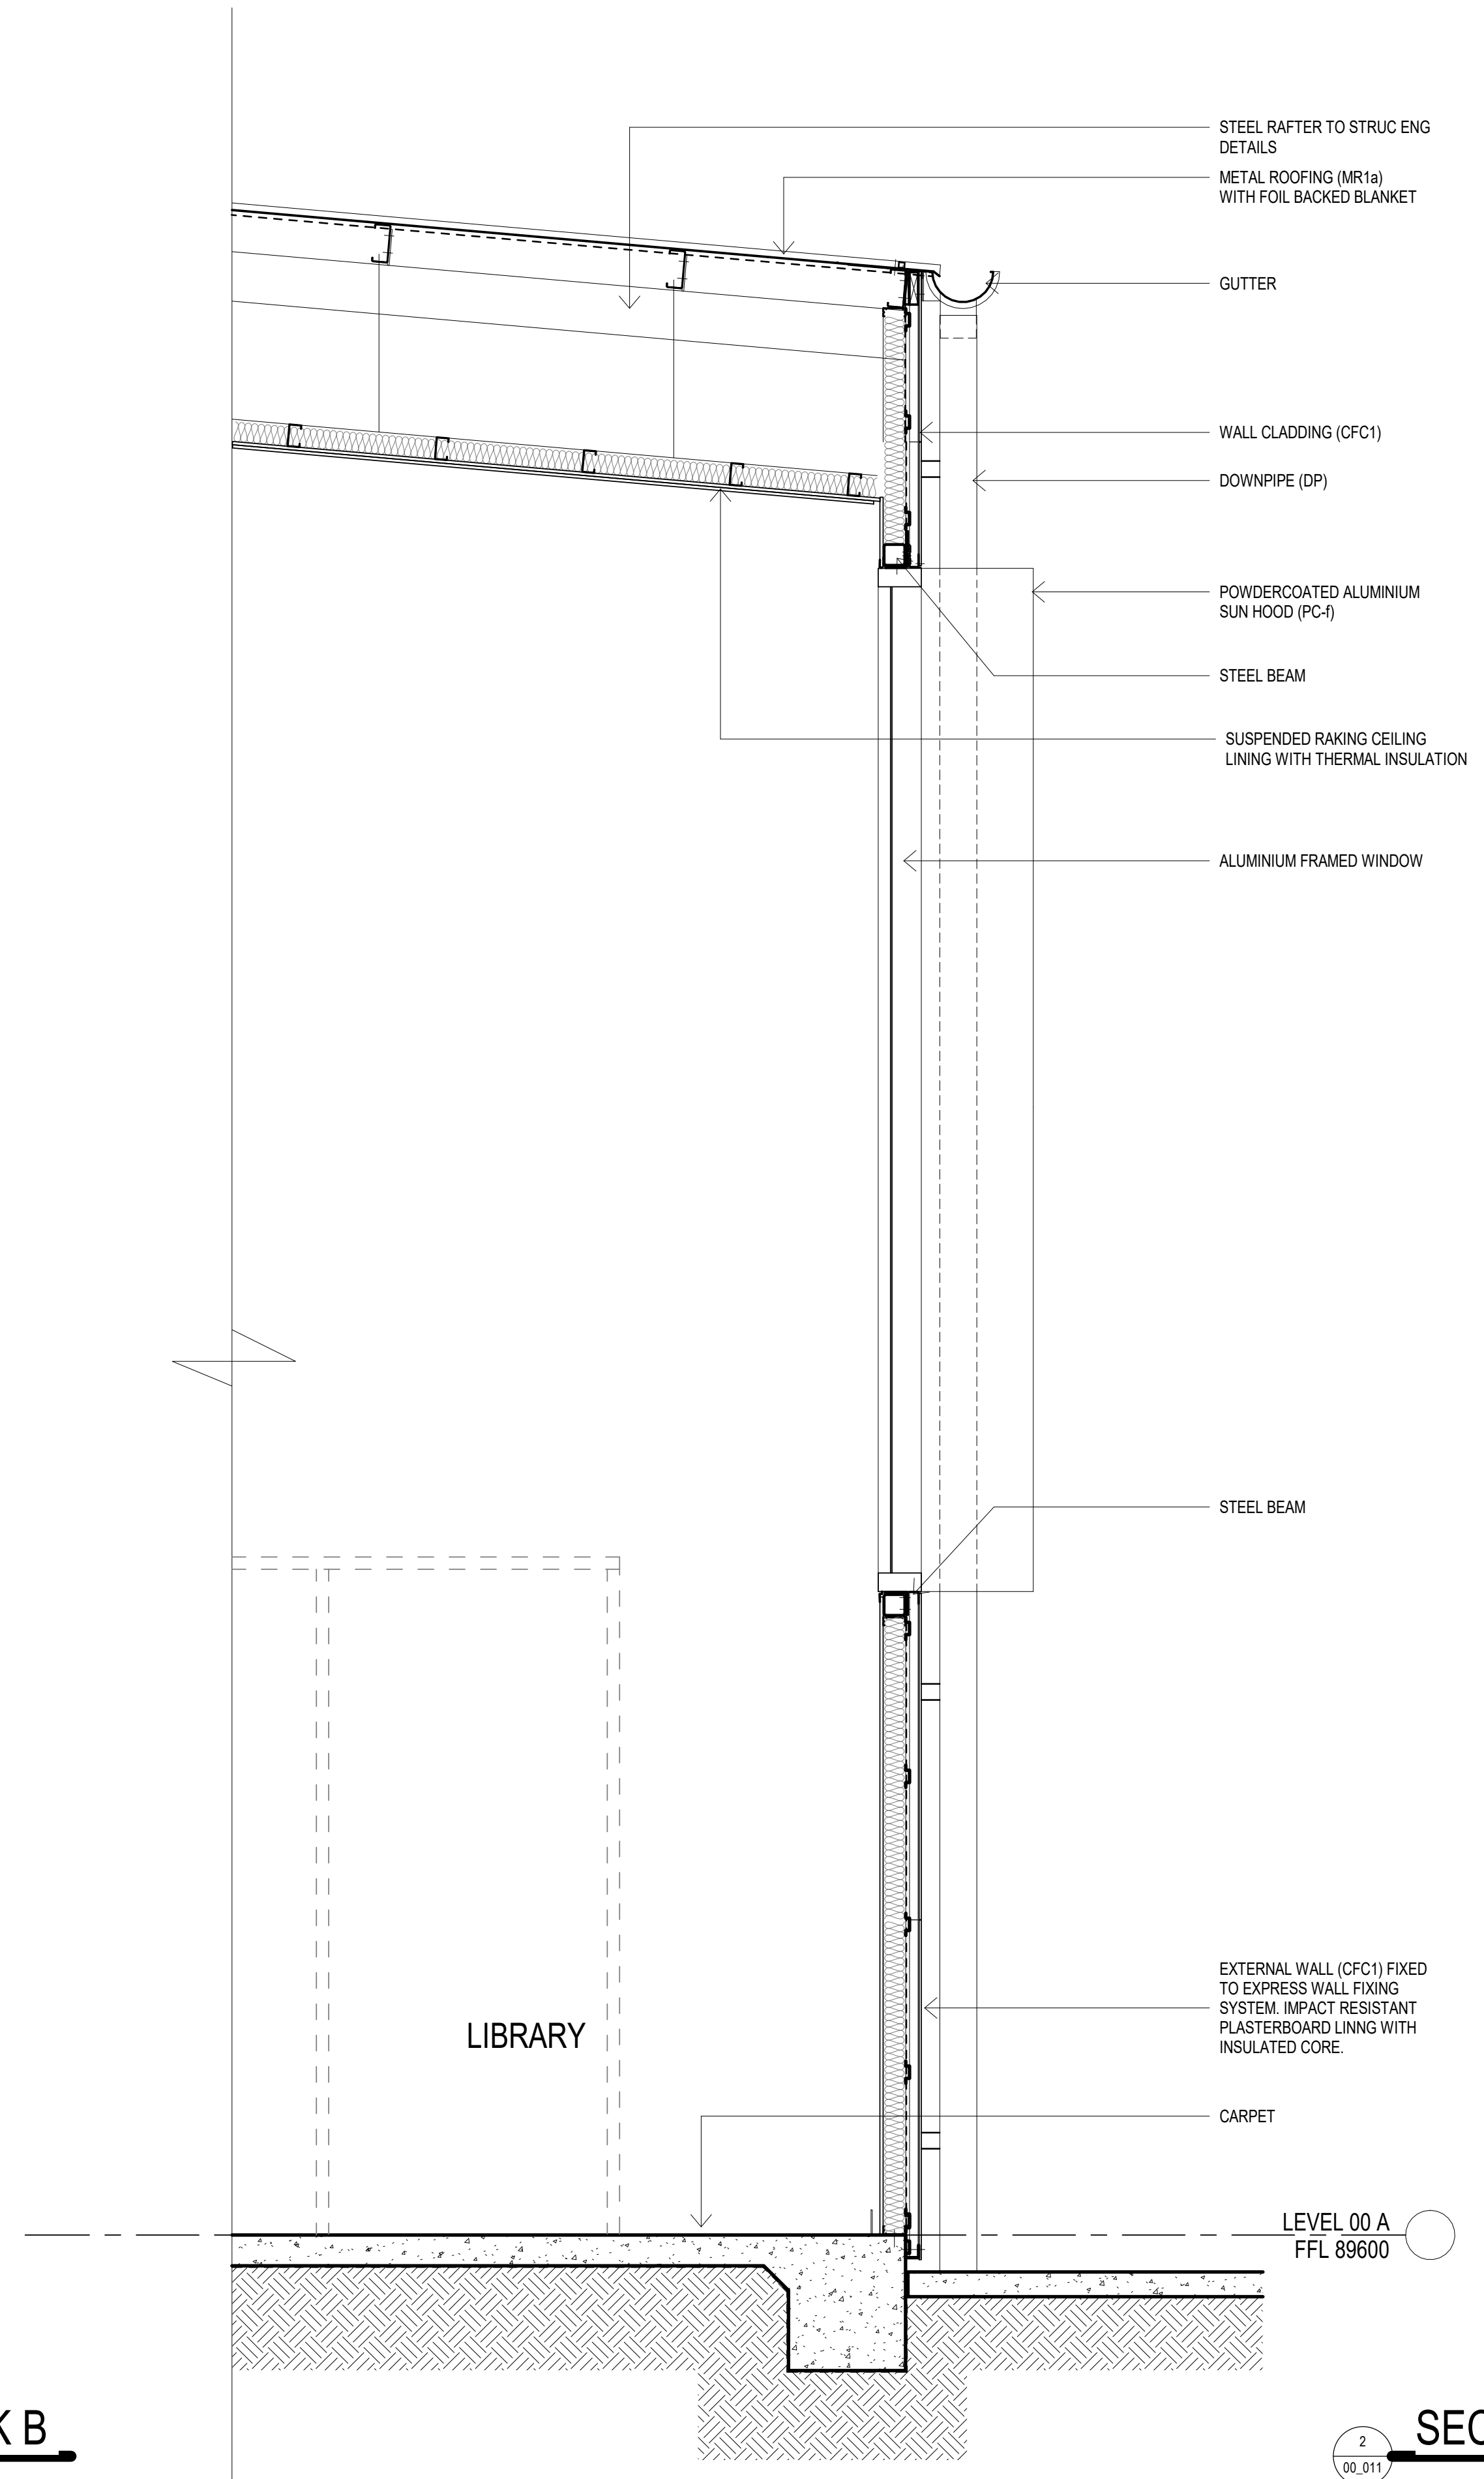AMMENDMENTS				DESCRIPTION
REV	BY	DATE		
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VL		30.08.19		ISSUE FOR SDA ToA
B	KLC	31.10.19		ISSUE FOR SDA


LEGEND	
CON	CONCRETE
CFC1	CLADDING CFC, NEUTRAL COLOUR
CFC2a	CLADDING CFC, FEATURE COLOUR A
CFC2b	CLADDING CFC, FEATURE COLOUR B
CFC2c	CLADDING CFC, FEATURE COLOUR C
DP	DOWNSPIPE
LV1	ALUMINIUM LOUVRES - TYPE 1
LV2	ALUMINIUM LOUVRES - TYPE 2
MWC1b	METAL WALL CLADDING, COLOUR B

MR1a	METAL ROOFING, COLOUR A - UPPER LEVEL
MR1b	METAL ROOFING, COLOUR B - LOWER LEVEL
PC-b	POWDERCOAT, FEATURE COLOUR B
PC-e	POWDERCOAT, FEATURE COLOUR E
PC-f	POWDERCOAT, FEATURE COLOUR F
PMS	PERFORATED MESH SCREEN



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MECHANICAL ELECTRICAL STEINER WARMING (02) 9967 2200
HYDRAULIC WOOLACOTT (02) 8241 9900
FIRE MCD FIRE ENGINEERING (04) 2392 2745

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Nominated Architect: Vince Pedavoli NSW reg No. 5045
LANDSCAPE ARCHITECT TAYLOR BRAMMER LANDS, ARCH. (02) 9387 8855

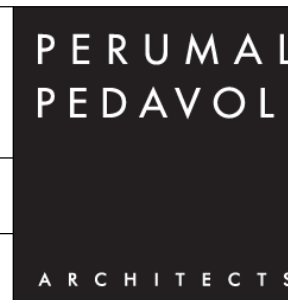


CATHERINE FIELD PS O'KEEFE DRIVE, ORAN PARK, NSW, 2570 NEW HIGH QUALITY CLASSROOMS PACKAGE 2
DRAWING NAME WALL SECTIONS

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PROJECT CODE		SCH. REF.	DISC.	TYPE	SERIES#	
NHQC2 - CF - AR -SSDA-00_801						
						B

SSDA

Date: 20.12.2019 2:48 PM
Printed By: J.O
Designed: T. BUGAEV
Job Manager: J. GILLIGAN
Verifier: J. GILLIGAN
Found: T:\2019 Jobs\19018 - New High Quality Classrooms Package 2 - HVAC - Catherine Field\Drawings\Northrop\CV\12-CAD02-CAB FILES\3-D\NHQC2-CF-CV-S-DDC201.21.dwg

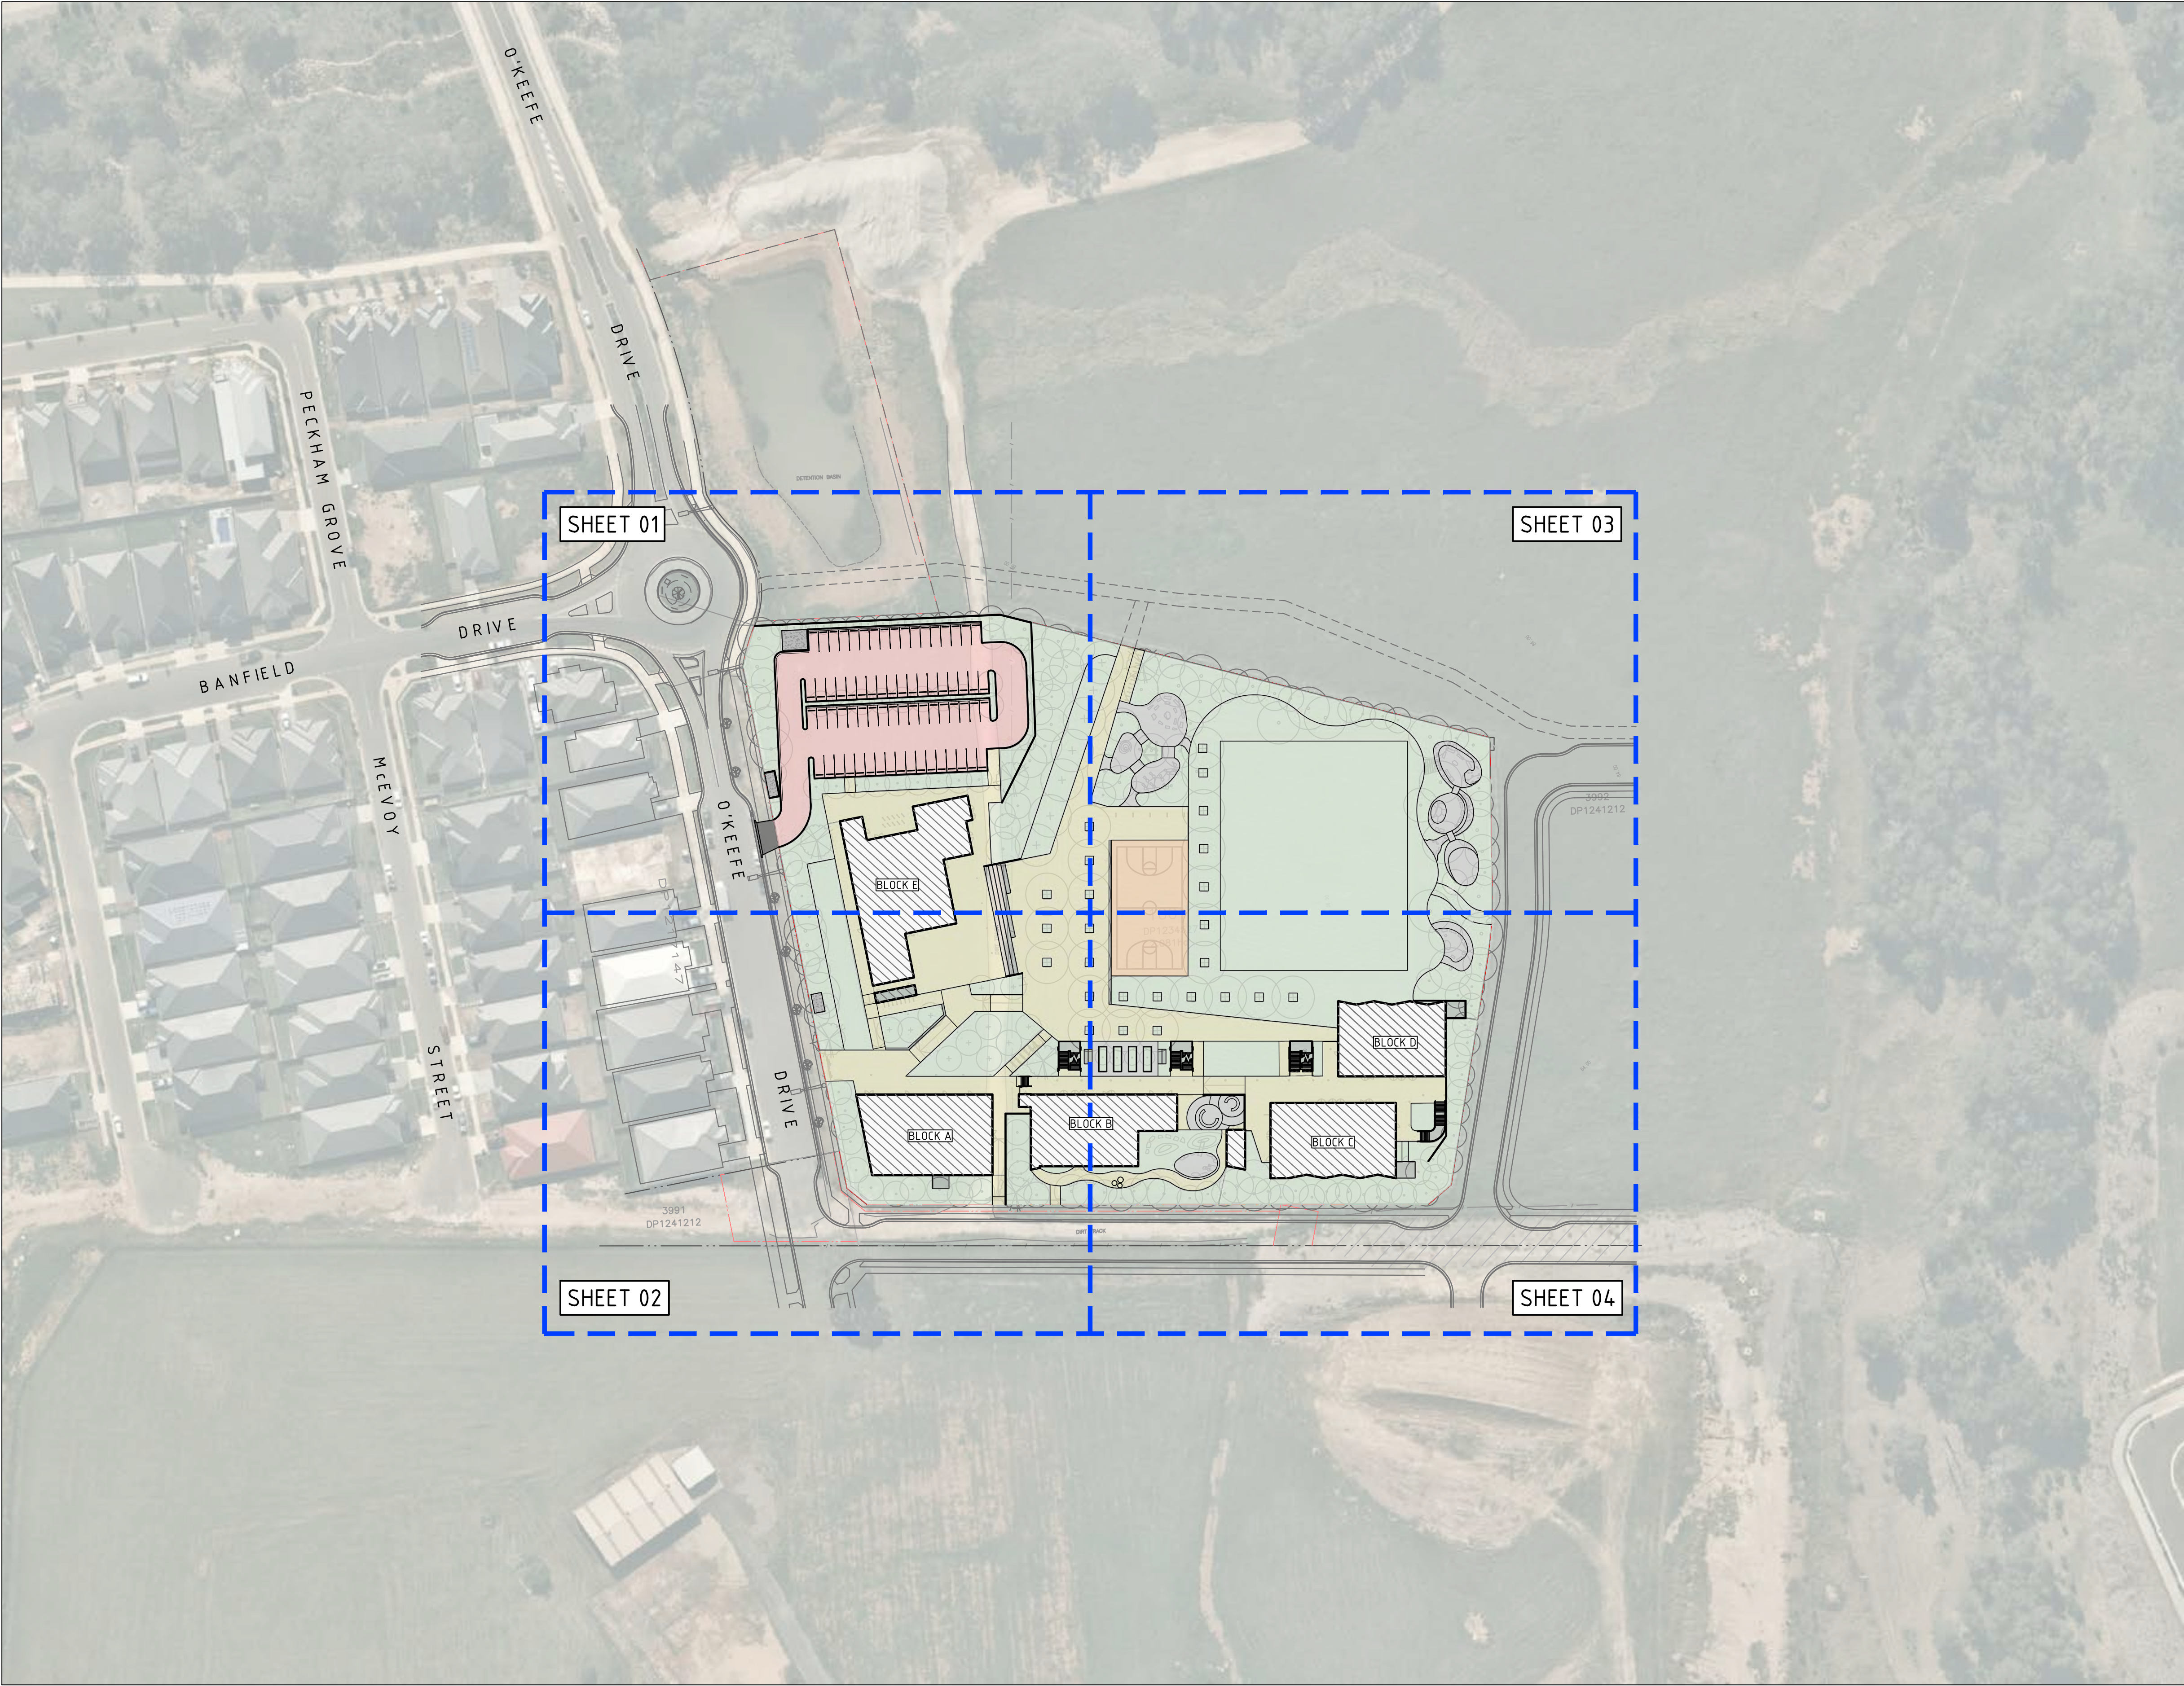

LEGEND

PROPOSED BOUNDARY LINE

EXISTING BOUNDARY LINE

SHEET EXTENTS

AMMENDMENTS				DESCRIPTION
REV	BY	DATE		
1	JO	20.11.19		ISSUE FOR 75% DESIGN DOCUMENTATION
2	JO	20.12.19		ISSUED FOR DETAILED DESIGN DOCUMENTATION

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Sydney

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NSW GOVERNMENT

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FIRE
MCD FIRE ENGINEERING
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LANDSCAPING
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PERUMAL PEDAVOLI ARCHITECTS

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NOMINATED ARCHITECT:
Vince Pedavoli NSW reg No. 5045

CATHERINE FIELD PS
NEW HIGH QUALITY CLASSROOMS

DRAWING NAME
GENERAL ARRANGEMENT PLAN

PROJECT NORTH




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DRAWN	CHECKED	VERIFIED	DATE
JO	JG	JG	20.12.19

PROJECT CODE	SCH. REF.	DISC. TYPE	SERIES#	REVISION
NHQC2-CF-CV-S-DDC201.21				2

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Des: 07.02.2020 10:19 AM
Printed By: J.O
Date: 07.02.2020 10:19 AM
DESIGNED: T. BUGAEV
JOB MANAGER: J. GILLIGAN
VERIFIER: .



LEGEND	
	PROPOSED BOUNDARY LINE
	EXISTING BOUNDARY LINE
	EXISTING CONTOURS
	SEDIMENT FENCE
	SECURITY FENCE
	WIRE MESH AND GRAVEL INLET FILTER
	GEOTEXTILE INLET FILTER TRAPS
	DRAINAGE SWALE
	STABILISED SITE ACCESS
	STOCKPILE
	SEDIMENT BASIN

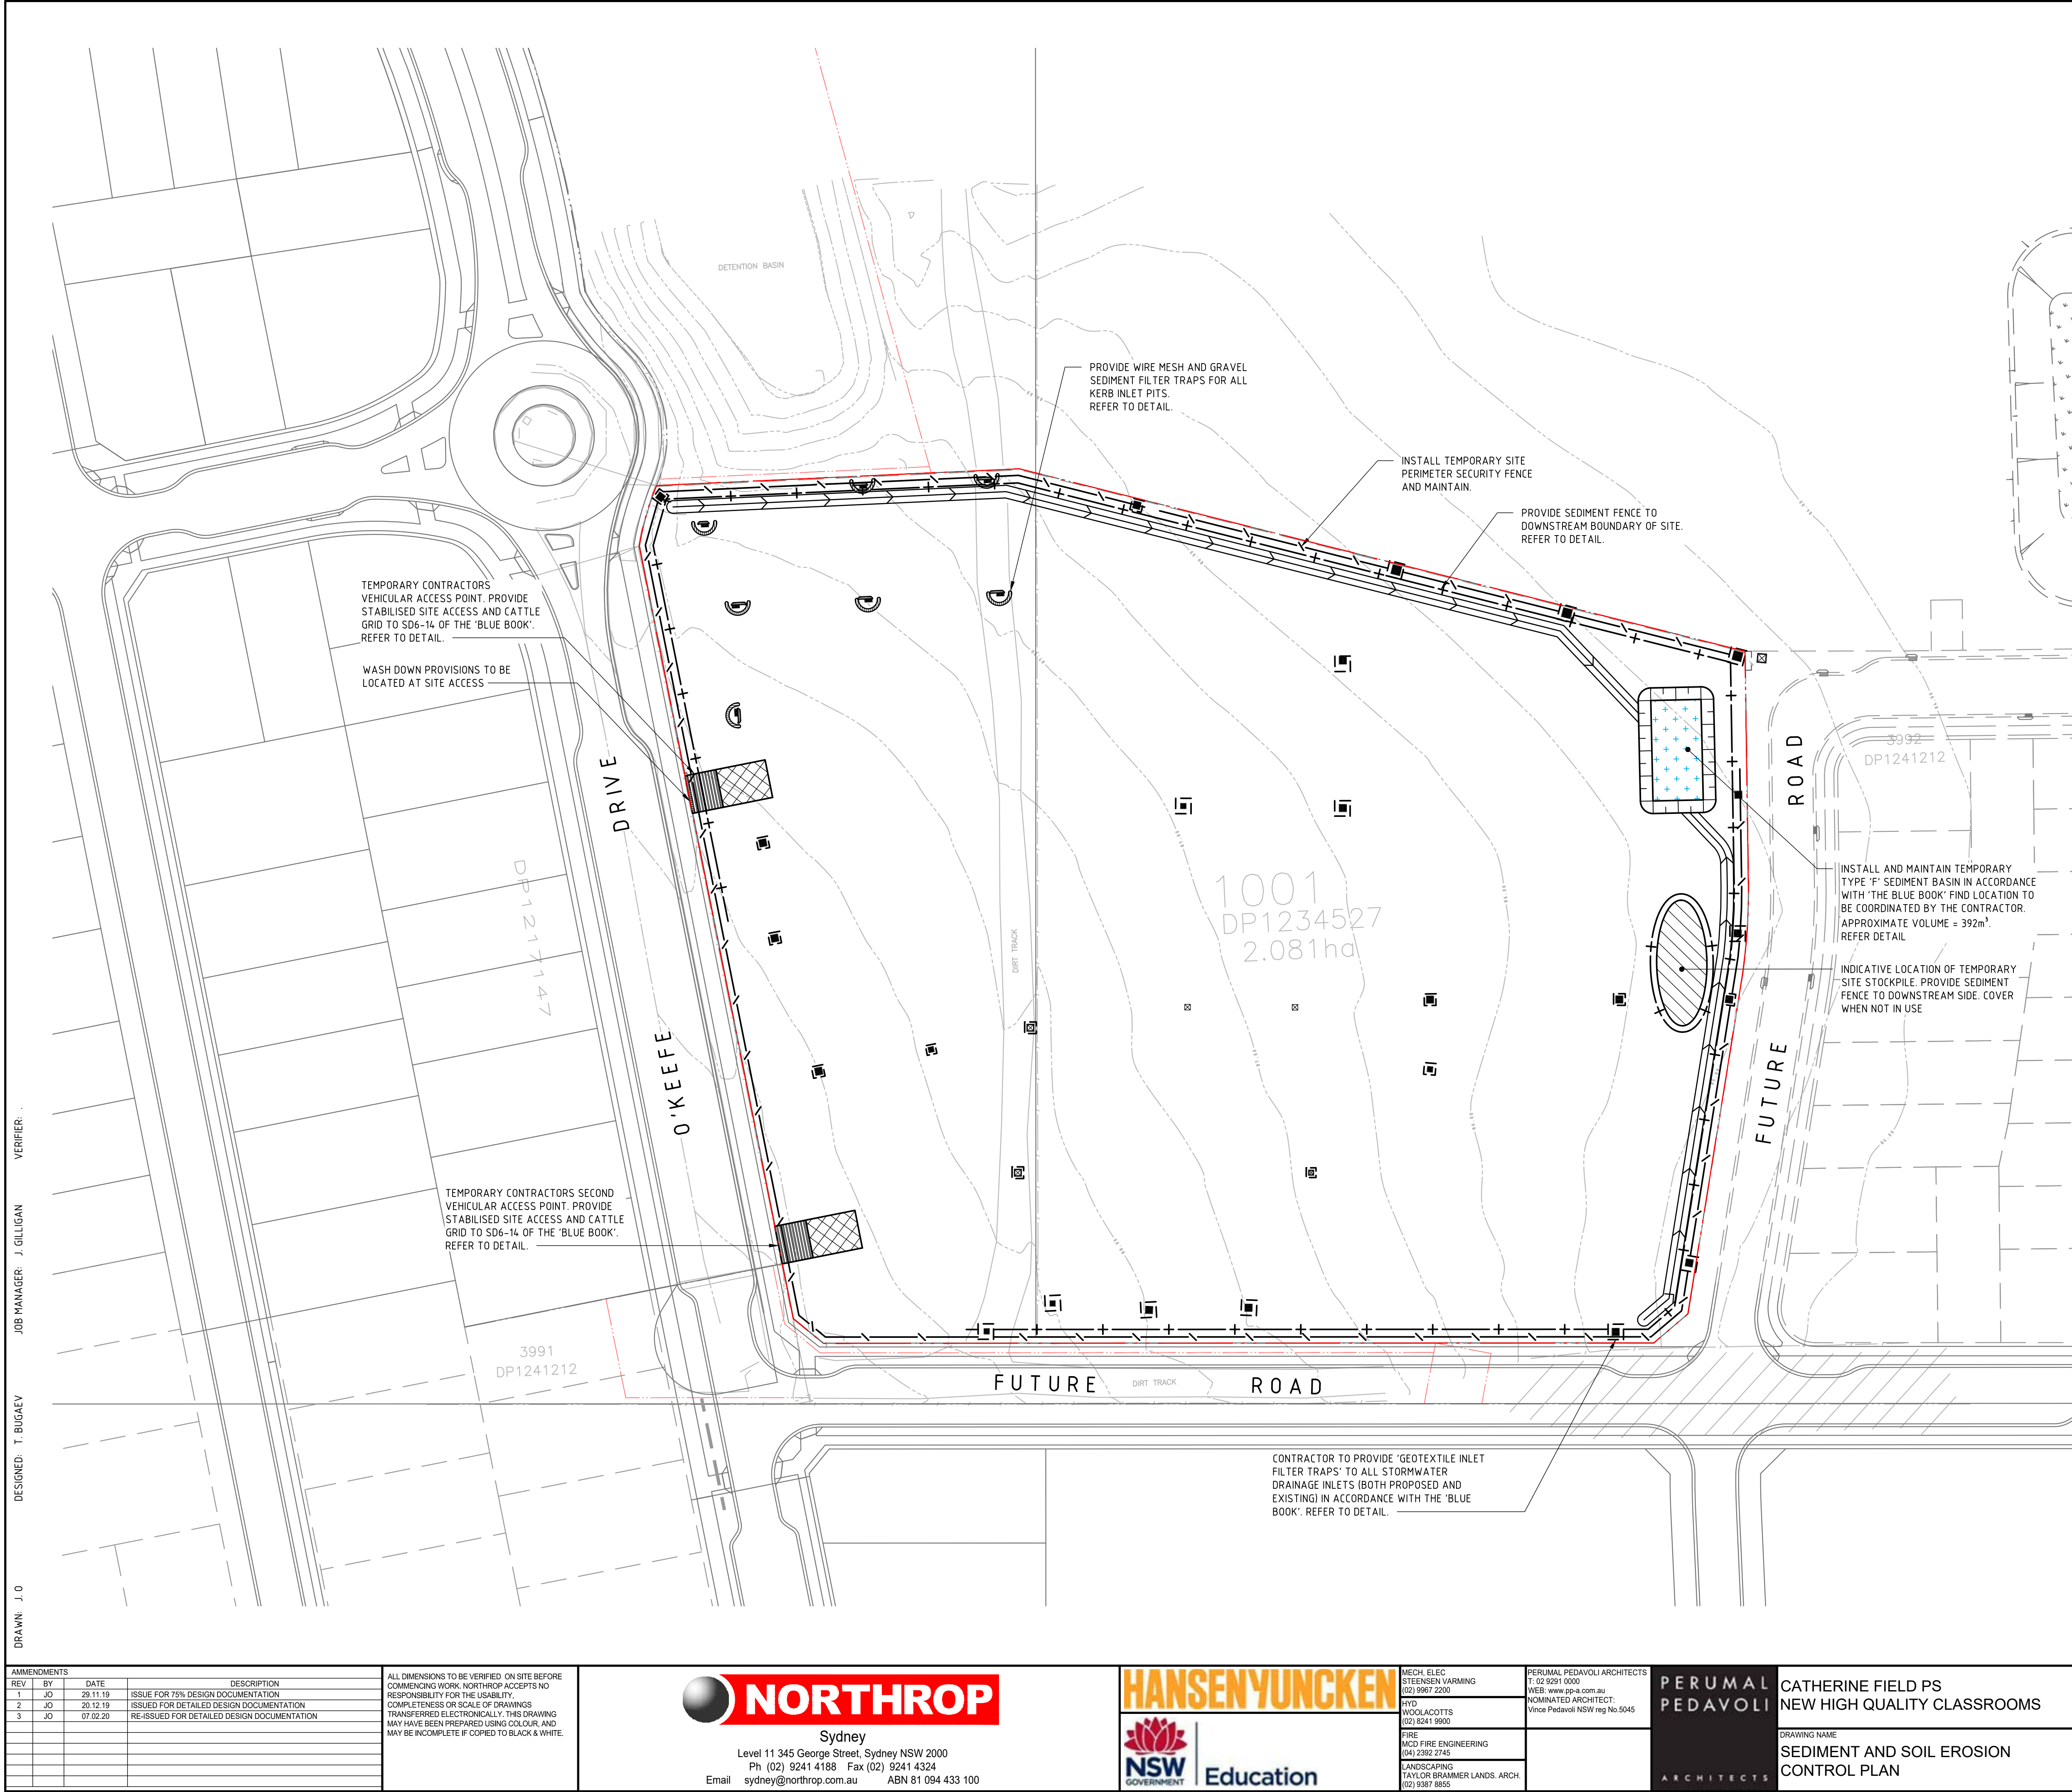SITE PARAMETERS	
CONSTRAINT	VALUE
SEDIMENT TYPE	D
SOIL HYDROLOGY GROUP	C
K = SOIL ERODIBILITY (K-FACTOR)	0.050
R = RAINFALL EROSIVITY (R-FACTOR)	3157
S = 2 YEAR, 6 HOUR STORM INTENSITY	12.1 mm/hr (LAKE HAVEN)
LS = SLOPE LENGTH/GRADIENT	0.87 (150m SLOPE @ 3% GRADE)
P = EROSION CONTROL PRACTICE (P-FACTOR)	1.3 (TYPICAL)
C = GROUND COVER (C-FACTOR)	1.0 (TYPICAL FOR STRIPPED SITE)
SOIL LOSS (RUSLE METHOD) (tonnes/ha/yr)	179
EROSION HAZARD (TABLE 4.2 BLUE BOOK)	LOW BASIN/TANKS REQUIRED

SEDIMENT BASIN/TANKS SIZING		
CONSTRAINT	VALUE	UNITS
CV = VOLUMETRIC RUNOFF COEFFICIENT	0.5	
R = 5 DAY, 75 TH PERCENTILE RAINFALL	25.1	mm/hr
A = CATCHMENT AREA	2.08	ha
SETTLING ZONE VOLUME (10xCVxRxA)	261	m ³
SOIL LOSS (CALC ABOVE)	138	m ³ /ha/yr
A2 = DISTURBED CATCHMENT AREA	2.08	ha
SEDIMENT STORAGE VOLUME (0.17xSOIL LOSSxA2)	131	m ³
TOTAL BASIN/TANKS VOLUME REQUIRED	392	m ³

NOT FOR CONSTRUCTION

REV	BY	DATE	DESCRIPTION
1	JO	29.11.19	ISSUE FOR 75% DESIGN DOCUMENTATION
2	JO	20.12.19	ISSUED FOR DETAILED DESIGN DOCUMENTATION
3	JO	07.02.20	RE-ISSUED FOR DETAILED DESIGN DOCUMENTATION

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NOMINATED ARCHITECT:
Vince Pedavoli NSW reg No. 5045

**CATHERINE FIELD PS
NEW HIGH QUALITY CLASSROOMS**

DRAWING NAME
**SEDIMENT AND SOIL EROSION
CONTROL PLAN**

PROJECT NORTH


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DRAWN	CHECKED	VERIFIED	DATE
JO	JG	JG	20.12.19

DRAWING NUMBER
NHQC2-CF-CV-S-DDC202.01

REVISION
3


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DESIGNED: T. BUGAEV
DRAWN: J. O
Plotted By: J.O
Date: 20.12.2019 2:48 PM
JOB MANAGER: J. GILLIGAN
VERIFIER:

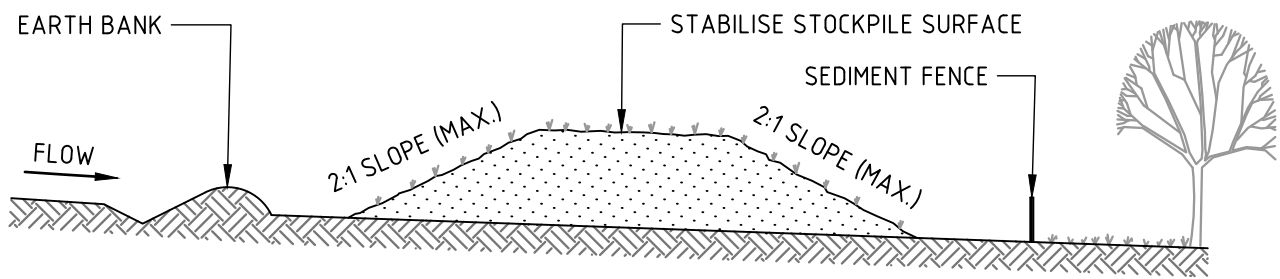

CONSTRUCTION NOTES

1. PLACE STOCKPILES MORE THAN 2m (PREFERABLY 5m) FROM EXISTING VEGETATION, CONCENTRATED WATER FLOW, ROADS AND HAZARD AREAS.
2. CONSTRUCT ON THE CONTOUR AS LOW, FLAT, ELONGATED MOUNDS.
3. WHERE THERE IS SUFFICIENT AREA, TOPSOIL STOCKPILES SHALL BE LESS THAN 2m IN HEIGHT.
4. WHERE THEY ARE TO BE IN PLACE FOR MORE THAN 10 DAYS, STABILISE FOLLOWING THE APPROVED ESCP OR SWMP TO REDUCE THE C-FACTOR TO LESS THAN 0.10.
5. CONSTRUCT EARTH BANKS (STANDARD DRAWING 5-5) ON THE UPSLOPE SIDE TO DIVERT WATER AROUND STOCKPILES AND SEDIMENT FENCES (STANDARD DRAWING 6-8) 1 TO 2m DOWNSLOPE.


STOCKPILE

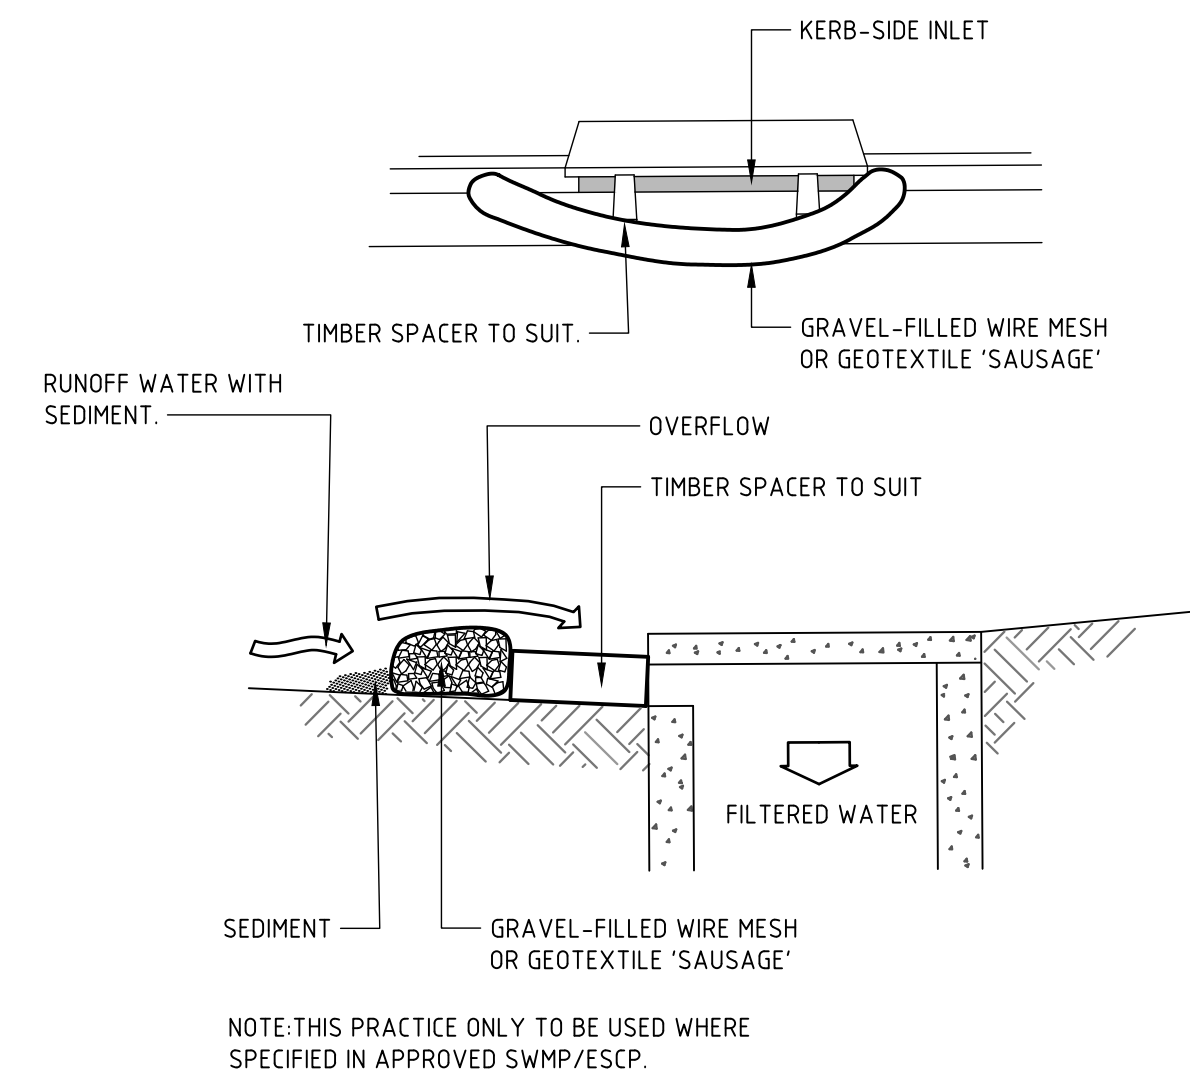

CONSTRUCTION NOTES

1. INSTALL FILTERS TO KERB INLETS ONLY AT SAG POINTS.
2. FABRICATE A SLEEVE MADE FROM GEOTEXTILE OR WIRE MESH LONGER THAN THE LENGTH OF THE INLET PIT AND FILL IT WITH 25mm TO 50mm GRAVEL.
3. FORM AN ELLIPTICAL CROSS-SECTION ABOUT 150mm HIGH x 400mm WIDE.
4. PLACE THE FILTER AT THE OPENING LEAVING AT LEAST A 100mm SPACE BETWEEN IT AND THE KERB INLET. MAINTAIN THE OPENING WITH SPACER BLOCKS.
5. FORM A SEAL WITH THE KERB TO PREVENT SEDIMENT BYPASSING THE FILTER.
6. SANDBAGS FILLED WITH GRAVEL CAN SUBSTITUTE FOR THE MESH OR GEOTEXTILE PROVIDING THEY ARE PLACED SO THAT THEY FIRMLY ABUT EACH OTHER AND SEDIMENT-LADEN WATERS CANNOT PASS BETWEEN.

WIRE MESH AND GRAVEL SEDIMENT FILTER

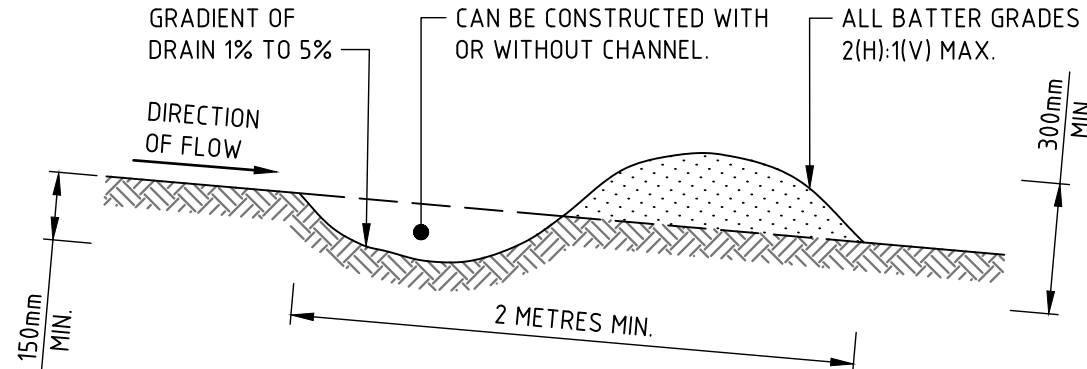


CONSTRUCTION NOTES

1. BUILD WITH GRADIENTS BETWEEN 1 AND 5 PERCENT.
2. AVOID REMOVING TREES AND SHRUBS IF POSSIBLE - WORK AROUND THEM.
3. ENSURE THE STRUCTURES ARE FREE OF PROJECTIONS OR OTHER IRREGULARITIES THAT COULD IMPEDE WATER FLOW.
4. BUILD THE DRAINS WITH CIRCULAR, PARABOLIC OR TRAPEZOIDAL CROSS SECTIONS, NOT V SHAPED.
5. ENSURE THE BANKS ARE PROPERLY COMPACTED TO PREVENT FAILURE.
6. COMPLETE PERMANENT OR TEMPORARY STABILISATION WITHIN 10 DAYS OF CONSTRUCTION.

NOTE: ONLY TO BE USED AS TEMPORARY BANK WHERE MAXIMUM UPSLOPE LENGTH IS 80 METRES.


DRAINAGE SWALE

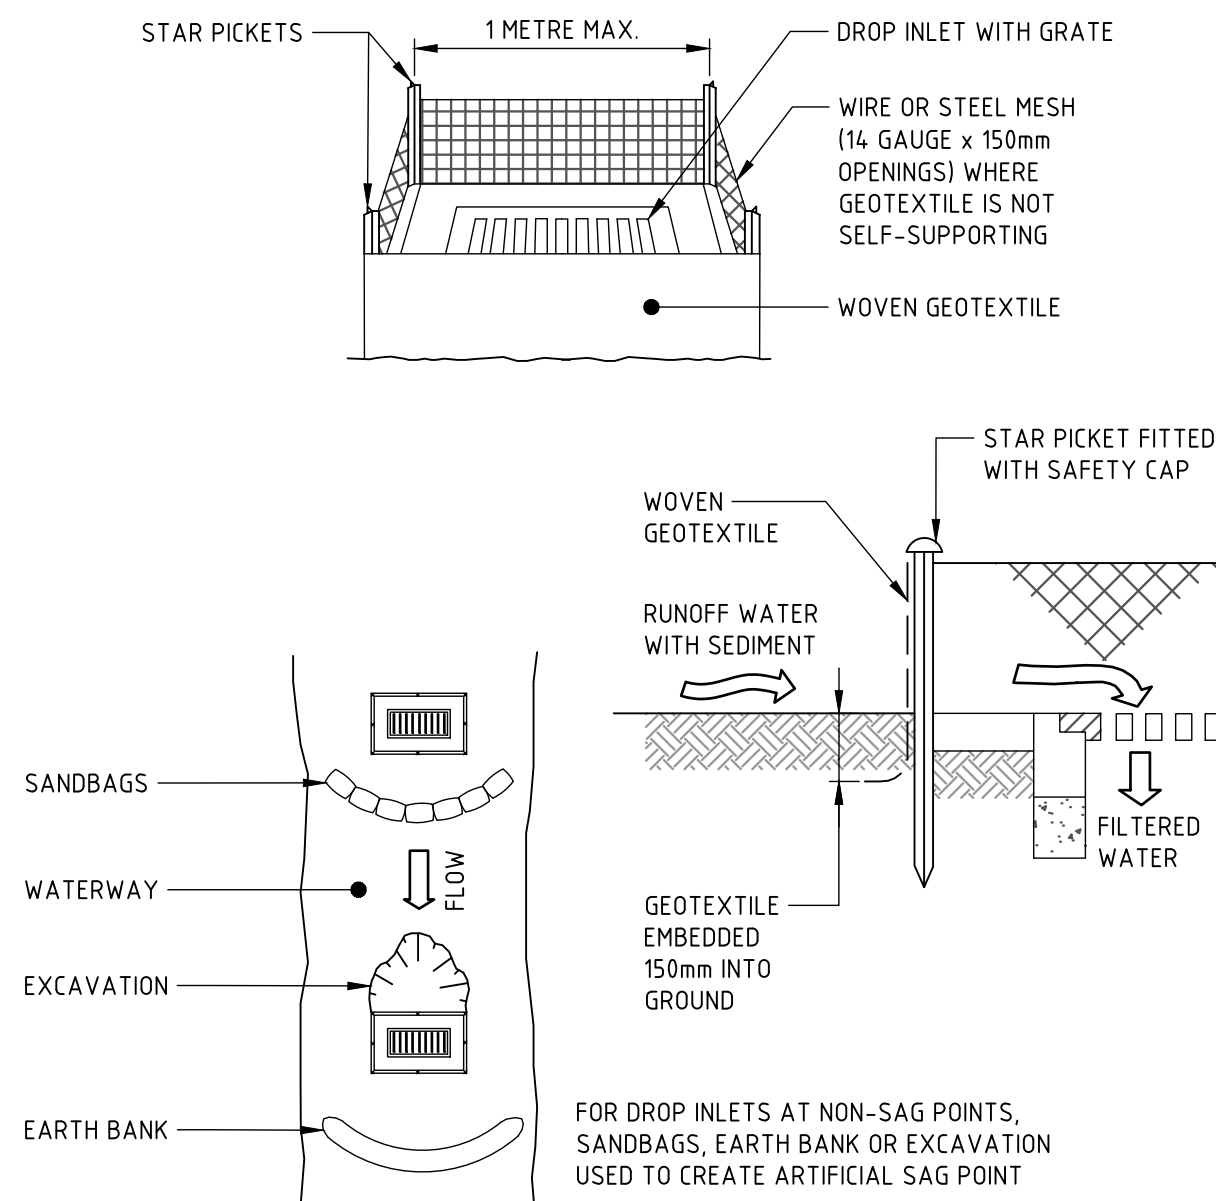

CONSTRUCTION NOTES

1. FABRICATE A SEDIMENT BARRIER MADE FROM GEOTEXTILE OR STRAW BALES.
2. FOLLOW STANDARD DRAWING 6-7 AND STANDARD DRAWING 6-8 FOR INSTALLATION PROCEDURES FOR THE STRAW BALES OR GEOFABRIC. REDUCE THE PICKET SPACING TO 1 METRE CENTRES.
3. IN WATERWAYS, ARTIFICIAL SAG POINTS CAN BE CREATED WITH SANDBAGS OR EARTH BANKS AS SHOWN IN THE DRAWING.
4. DO NOT COVER THE INLET WITH GEOTEXTILE UNLESS THE DESIGN IS ADEQUATE TO ALLOW FOR ALL WATERS TO BYPASS IT.


GEOTEXTILE INLET FILTER TRAPS

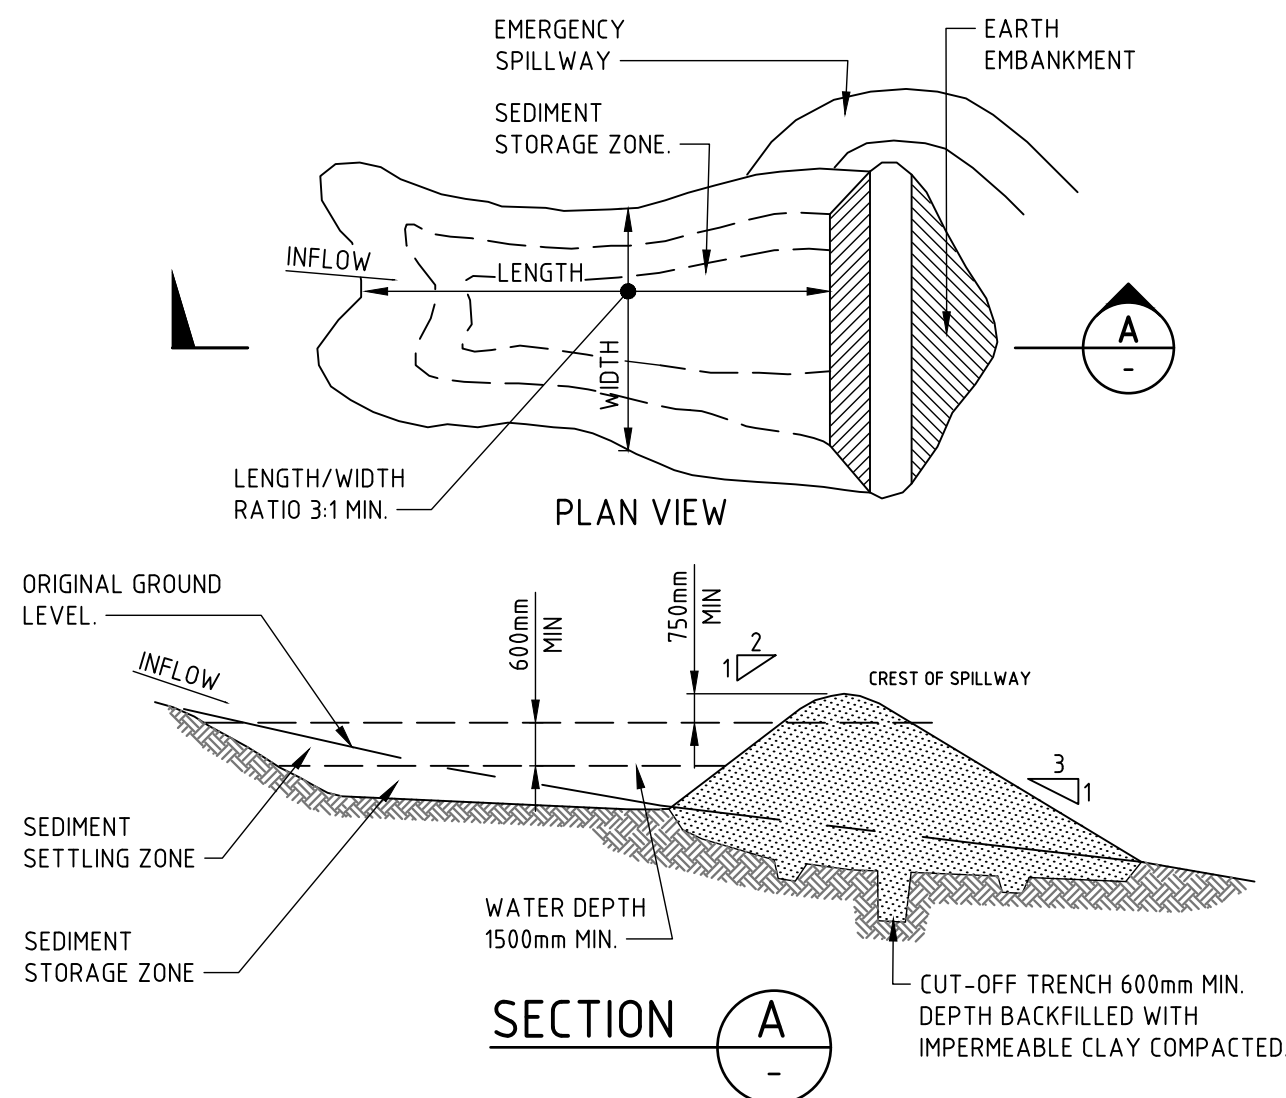

CONSTRUCTION NOTES

1. REMOVE ALL VEGETATION AND TOPSOIL FROM UNDER THE DAM WALL AND FROM WITHIN THE STORAGE AREA.
2. CONSTRUCT A CUT-OFF TRENCH 500mm DEEP AND 1200mm WIDE ALONG THE CENTRELIN OF THE EMBANKMENT EXTENDING TO A POINT ON THE GULLY WALL LEVEL WITH THE RISER CREST.
3. MAINTAIN THE TRENCH FREE OF WATER AND RECOMPACT THE MATERIALS WITH EQUIPMENT AS SPECIFIED IN THE SWMP TO 95 PER CENT STANDARD PROCTOR DENSITY.
4. SELECT FILL FOLLOWING THE SWMP THAT IS FREE OF ROOTS, WOOD, ROCK, LARGE STONE OR FOREIGN MATERIAL.
5. PREPARE THE SITE UNDER THE EMBANKMENT BY RIPPING TO AT LEAST 100mm TO HELP BOND COMPACTED FILL TO THE EXISTING SUBSTRATE.
6. SPREAD THE FILL IN 100mm TO 150mm LAYERS AND COMPACT IT AT OPTIMUM MOISTURE CONTENT FOLLOWING THE SWMP.
7. CONSTRUCT THE EMERGENCY SPILLWAY.
8. REHABILITATE THE STRUCTURE FOLLOWING THE SWMP.


SEDIMENT BASIN - WET

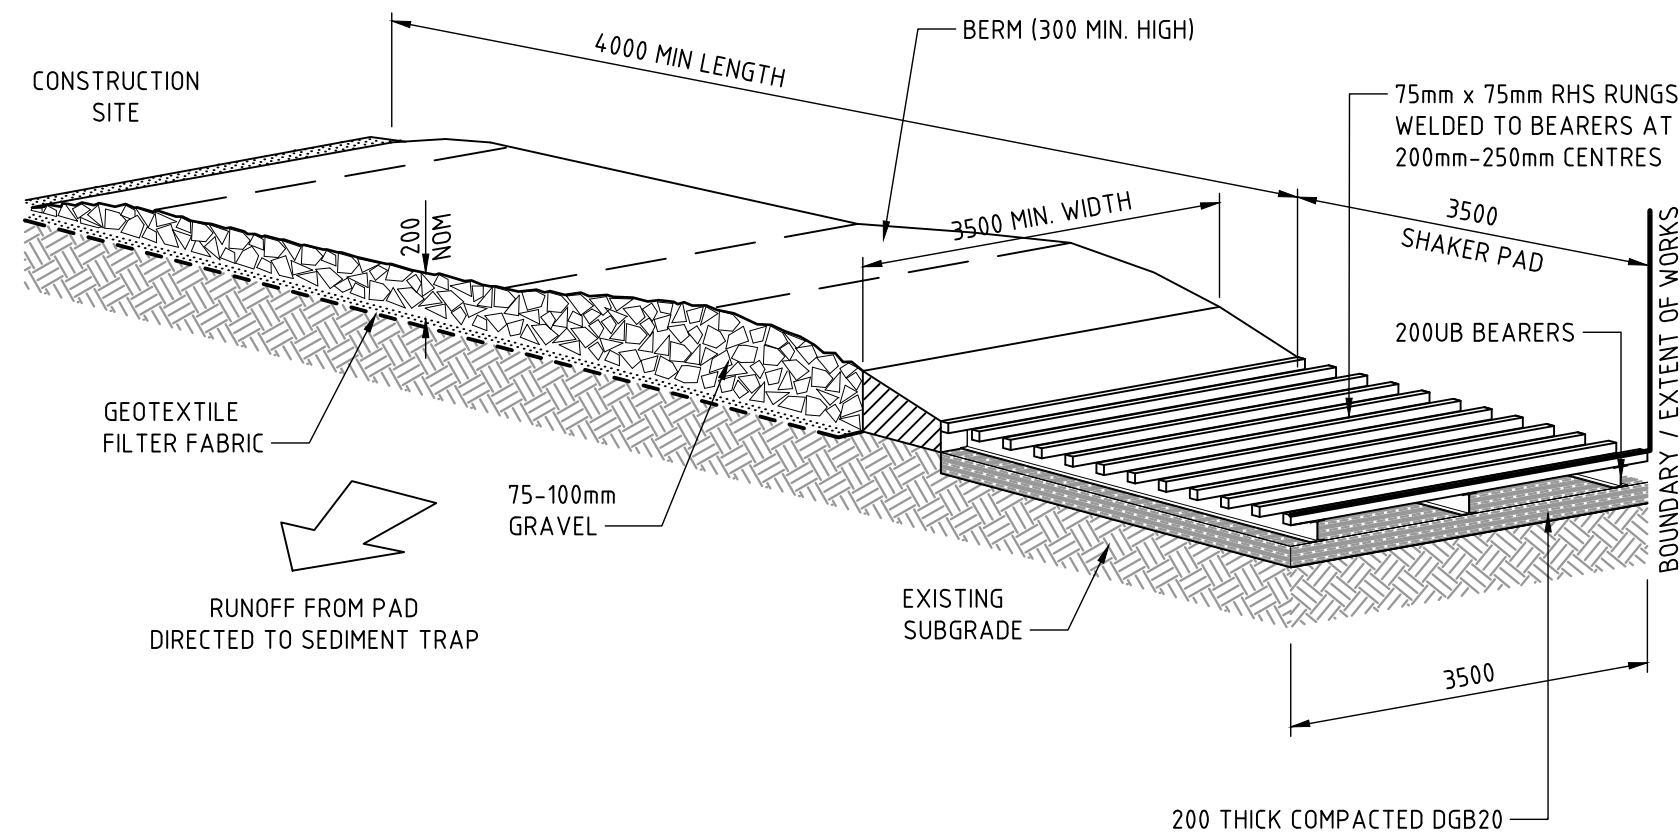

MAINTENANCE

- THE TEMPORARY ACCESS SHALL BE MAINTAINED IN A CONDITION THAT PREVENTS TRACKING OR FLOWING OF SEDIMENT ONTO PUBLIC RIGHTS OF WAY.
- THIS MAY REQUIRE PERIODIC TOP DRESSING WITH ADDITIONAL GRAVEL AS CONDITIONS DEMAND AND REPAIR AND/OR CLEANOUT OF ANY MEASURES USED TO TRAP SEDIMENT.
- ALL SEDIMENT SPILLED, DROPPED, WASHED OR TRACKED ONTO PUBLIC RIGHTS OF WAY MUST BE REMOVED IMMEDIATELY.
- INSTALL BARRIER ON EITHER SIDE OF SHAKER PAD TO ENSURE VEHICLES ARE GUIDED ON TO THE PAD.
- INVERT OF SHAKER PAD TO BE DRAINED VIA AGRICULTURAL PIPE WRAPPED IN GEOTEXTILE FABRIC.

STABILISED SITE ACCESS

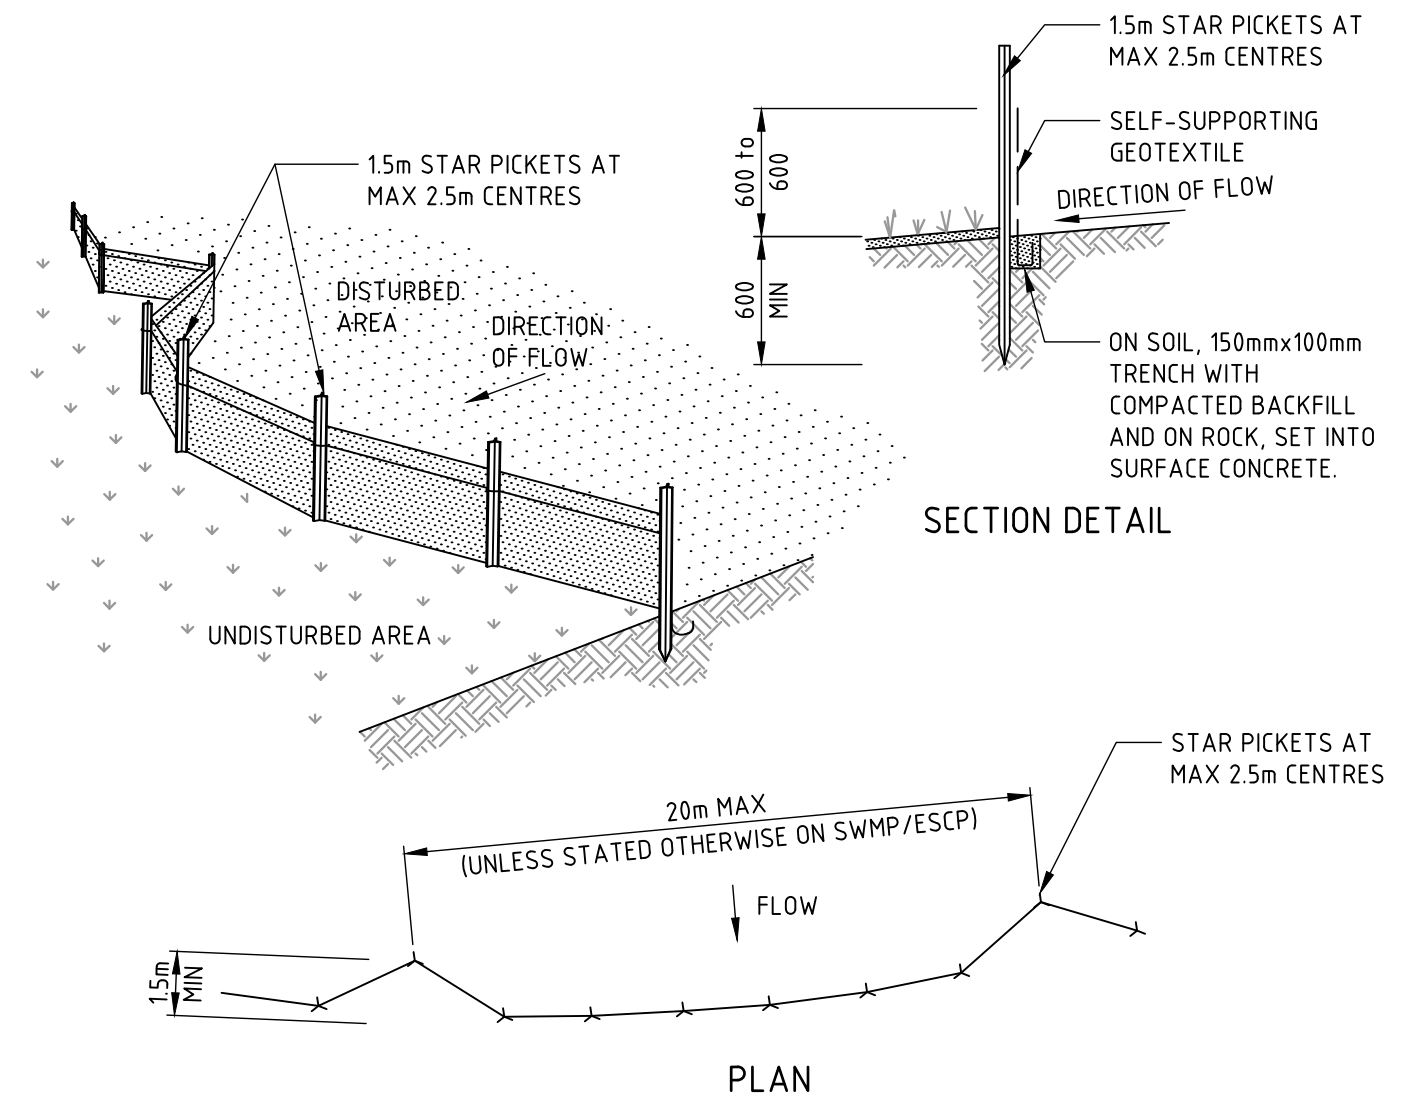

CONSTRUCTION NOTES

1. CONSTRUCT SEDIMENT FENCES AS CLOSE AS POSSIBLE TO BEING PARALLEL TO THE CONTOURS OF THE SITE, BUT WITH SMALL RETURNS AS SHOWN IN THE DRAWING TO LIMIT THE CATCHMENT AREA OF ANY ONE SECTION. THE CATCHMENT AREA SHOULD BE SMALL ENOUGH TO LIMIT WATER FLOW IF CONCENTRATED AT ONE POINT TO 50 LITRES PER SECOND IN THE DESIGN STORM EVENT, USUALLY THE 10-YEAR EVENT.
2. CUT A 150mm DEEP TRENCH ALONG THE UPSLOPE LINE OF THE FENCE FOR THE BOTTOM OF THE FABRIC TO BE ENTRENCHED.
3. DRIVE 15 METRE LONG STAR PICKETS INTO GROUND AT 2.5 METRE INTERVALS (MAX) AT THE DOWNSLOPE EDGE OF THE TRENCH. ENSURE ANY STAR PICKETS ARE FITTED WITH SAFETY CAPS.
4. FIX SELF-SUPPORTING GEOTEXTILE TO THE UPSLOPE SIDE OF THE POSTS ENSURING IT GOES TO THE BASE OF THE TRENCH. FIX THE GEOTEXTILE WITH WIRE TIES OR AS RECOMMENDED BY THE MANUFACTURER. ONLY USE GEOTEXTILE SPECIFICALLY PRODUCED FOR SEDIMENT FENCING. THE USE OF SHADE CLOTH FOR THIS PURPOSE IS NOT SATISFACTORY.
5. JOIN SECTIONS OF FABRIC AT A SUPPORT POST WITH A 150mm OVERLAP.
6. BACKFILL THE TRENCH OVER THE BASE OF THE FABRIC AND COMPACT IT THOROUGHLY OVER THE GEOTEXTILE.

SEDIMENT FENCE

NOT FOR CONSTRUCTION

AMMENDMENTS				ALL DIMENSIONS TO BE VERIFIED ON SITE BEFORE COMMENCING WORK. NORTHROP ACCEPTS NO RESPONSIBILITY FOR THE USABILITY, COMPLETENESS OR SCALE OF DRAWINGS TRANSFERRED ELECTRONICALLY. THIS DRAWING MAY HAVE BEEN PREPARED USING COLOUR, AND MAY BE INCOMPLETE IF COPIED TO BLACK & WHITE.
REV	BY	DATE	DESCRIPTION	
1	JO	20.11.19	ISSUE FOR 75% DESIGN DOCUMENTATION	
2	JO	20.12.19	ISSUED FOR DETAILED DESIGN DOCUMENTATION	

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NEW HIGH QUALITY CLASSROOMS

DRAWING NAME
**SEDIMENT AND SOIL EROSION
CONTROL DETAILS**

PROJECT NORTH

DRAWN	CHECKED	VERIFIED	DATE
JO	JG	JG	20.12.19

DRAWING NUMBER
PROJECT CODE SCH. REF. DISC. TYPE SERIES#

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REVISION
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